DOVE VALLEY DIXILETA DR DIXILETA DR DYNAMITE BLVD PINNACIE PK RD DEER VALLEY DR DEER VALLEY DE BEARDSLEY RD BEARDSLEY RD UNION HILLS DR GREENWAY RD GREENWAY RD ST83140119 THUNDERBIRD RD **CANAL NORTH** CACTUS RD CACTUS RD 7TH ST & MINNEZONA AVE SHEA BLVD PEORIA AVE DOUBLETREE T02N R03E NORTHERN AVE **SECTION 20, 21** INDIAN BEND CAMELBACK RE BUCKEYE RD LOWER BUCKEYE RD SOUTHERN AVE WARNER RD 3 AVE 5 AVE 7 AVE 7 AVE 7 AVE 7 AVE 7 AVE 7 ST 16 ST 16 ST 40 ST 48 ST 56 ST 5 VICINITY MAP

6/4/2024

CITY OF PHOENIX STREET TRANSPORTATION DEPARTMENT **DESIGN & CONSTRUCTION MANAGEMENT DIVISION** AMERICAN RESCUE PLAN ACT LOCAL DRAINAGE MITIGATION PROJECT PACKAGE 1

7TH ST & MINNEZONA ST83140119



2024

CITY BENCHMARKS

SRP ALUMINUM CAP ON SOUTH END OF SOUTHWEST WINGWALL OF BRIDGE OVER GRAND CANAL, AT THE INTERSECTION OF 7TH ST AND CAMPBELL ROAD EL 1127.319 (NGVD-29)

COP FLUSH BRASS CAP, AT THE INTERSECTION OF 12TH ST AND CAMPBELL ROAD EL 1127.304 (NGVD-29)

COP BRASS CAP IN HAND HOLE, AT THE INTERSECTION OF 16TH ST AND CAMPBELL ROAD EL 1135.800 (NGVD-29)



		A7	TEC		SOT N. 44TH ST SUITE 300 PHOCHIE, AZ 83008
9	ARIZ.	ST83140119	1	50	
F.H.W.A. REGION	STATE	PROJ. NO.	NO.	TOTAL	AS BUILT

MAYOR KATE GALLEGO

CITY MANAGER JEFFREY BARTON

CITY COUNCIL

DISTRICT	NO	1.	ANN O'BRIEN
DISTRICT	NO	2.	JIM WARING
DISTRICT	NO	3.	DEBRA STARK
DISTRICT	NO	4.	LAURA PASTOR
DISTRICT	NO	5.	BETTY GUARDADO
DISTRICT	NO	6.	KEVIN ROBINSON
DISTRICT	NO	7.	YASSAMIN ANSARI
DISTRICT	NO	8.	KESHA HODGE WASHINGTON

INDEX OF SHEET

SHEET NO.	DWG. SERIES NO.	SHEET TITLE
1	G-0.01	COVER
2-3	G-1.01 - G-1.02	LEGEND AND NOTES
4	G-2.01	GEOMETRIC CONTROL
5	G-3.01	QUANTITY SUMMARY
6-8	SD-1.01 - SD-1.03	STORM DRAIN PLANS
9-13	SD-2.01 - SD2.05	CONNECTOR PIPE PROFILES
14-15	DT-1.01 - DT-1.02	STAKING DETAILS
16	SDD-1.01	WATERLINE RELOCATION DETAIL PER P-1370

LENGTH OF PROJECT: 7TH STREET = 367 LF 8TH STREET = 336 LF

MEADOWBROOK AVENUE = 715 LF MINNEZONA AVENUE = 319 LF

AREA OF DISTURBANCE = 0.42 ACRES

"PER CITY OF PHOENIX CITY CODE CHAPTER 2, SECTION 2-28, THESE PLANS ARE FOR OFFICIAL USE ONLY & MAY NOT BE SHARED WITH OTHERS EXCEPT AS REQUIRED TO FULFILL THE OBLIGATIONS OF YOUR CONTRACT WITH THE CITY OF PHOENIX."



AMERICAN RESCUE PLAN ACT LOCAL DRAINAGE MITIGATION PROGRAM PHOENIX STREETS - MARICOPA CO. LEGEND BENCHMARK NEW SURVEY MONUMENT - M.A.G. DETAIL 120-1 TYPE "B" NEW SURVEY MONUMENT - M.A.G. DETAIL 120-1 TYPE "A" COMBINED CURB & GUTTER - M.A.G. DETAIL 220 TYPE "A" BACKFILL TYPE & SQ. YD. PVMT. REPLACEMENT - C.O.P. DETAIL P1200 Z/ZZ/Z EXISTING CONCRETE PAVEMENT OR SIDEWALK NEW CONCRETE DRIVEWAY OR ALLEY ENT. PER DETAIL NO. ON PLANS NEW CONCRETE SIDEWALK RAMP PER DETAIL ON PLANS AVERAGE GROUND ELEVATION AT R/W LINE BACKFILL COMPACTION TYPE _____ EXISTING DITCH 24" IRR (SRP) EXISTING IRRIGATION LINE W/SIZE (NOTE PRIVATE, SALT RIVER OR R.I.D.) — → EXISTING IRRIGATION STRUCTURE EXISTING IRRIGATION STANDPIPE NEW IRRIGATION STANDPIPE - M.A.G. DETAIL 503 NEW IRRIGATION VALVE - M.A.G. DETAIL 506 W/ CONC. SCOURING BASIN IRRIGATION BERM NEW IRRIGATION STRUCTURE PER DETAIL ON PLANS ——12" DIP W—— EXISTING WATER LINE W/SIZE & TYPE (12" AND SMALLER) ________ EXISTING WATER LINE W/SIZE & TYPE (GREATER THAN 12") → ADJUST EXIST. WATER VALVE BOX - C.O.P. DETAIL P1391 3/4" W—— WATER SERVICE W/SIZE AND WATER METER BOX EXISTING FIRE HYDRANT NEW OR RELOCATED FIRE HYDRANT BY CONTRACTOR EXISTING WATER VALVE W/TOP OF OPERATING NUT ELEVATION 30" VCP S EXISTING SANITARY SEWER LINE W/SIZE & TYPE (GREATER THAN 12") ———— EXISTING MANHOLE CATCH BASIN, GUTTER INLET (LENGTH TO SCALE) CATCH BASIN, CURB INLET (LENGTH TO SCALE) CATCH BASIN, CURB & GUTTER INLET (LENGTH TO SCALE) — SD — EXISTING STORM DRAIN LINE W/SIZE & TYPE (GREATER THAN 12") NEW PIPE FOR STORM DRAIN OR IRRIGATION LINE — 4"G — EXISTING GAS LINE W/SIZE ----E EXISTING UNDERGROUND ELECTRIC CABLE OR SINGLE CONDUIT ——E-4D— EXISTING UNDERGROUND ELECTRIC DUCT (SPECIFY NUMBER) EXISTING TELEPHONE BURIED CABLE OR SINGLE CONDUIT — T-4D — EXISTING UNDERGROUND TELEPHONE DUCT (SPECIFY NUMBER) ——FO—— EXISTING UNDERGROUND FIBER OPTIC LINE --- EXISTING TRAFFIC SIGNAL POLE W/MAST ARM & SIGNAL INDICATIONS \Diamond \Diamond EXISTING STREET OR TRAFFIC SIGN EXISTING UTILITY POLE W/LINE INDICATING WIRE DIRECTION EXISTING BLOCK FENCE ----- EXISTING WOOD FENCE MAIL BOX EXISTING POWER POLE DOWN GUY ANCHOR EXISTING STREET LIGHT & POLE EXISTING TREE OR STUMP TO BE REMOVED - MORE THAN 12" DIA.

EXISTING TREE TO BE TRANSPLANTED BY CONTRACTOR

EXISTING TREE OR STUMP TO BE REMOVED 12" DIA. OR LESS (NON PAY ITEM)

PAVEMENT CENTER LINE OR MONUMENT LINE

LEGEND AND NOTES

NOTES

1. ALL CONSTRUCTION SHALL BE PERFORMED IN ACCORDANCE WITH

TO MAG STANDARD SPECIFICATIONS AND DETAILS; AND MAG

PRECEDENCE, AT THE TIME OF CONSTRUCTION BID.

SURFACE FLUSH WITH THE ADJACENT SIDEWALK.

TO CENTER.

DETAIL P1576.

PREFABRICATED.

INITIATION OF CONSTRUCTION.

ARE ALONG CENTERLINE OF PIPE.

UNDERGROUND UTILITY.

BLUESTAKE SYSTEM.

NGVD 29.

STANDARD SPECIFICATIONS AND DETAILS, IN THAT ORDER OF

2. ALL STORM SEWER MANHOLES ARE TO BE CONSTRUCTED WITHOUT

3. NEW MANHOLE COVERS LOCATED IN SIDEWALK SHALL BE GROUND

4. PIPE CONNECTIONS TO EXISTING CONCRETE PIPE MAINS SHALL BE

5. PIPE CONNECTIONS TO NEW PRECAST CONCRETE PIPE MAINS

MADE IN ACCORDANCE WITH DETAILS CALLED OUT ON THE PLANS.

CONNECTION TO MAINS SHALL NOT BE CLOSER THAN 5', CENTER

SHALL BE MADE WITH FACTORY MADE WYES OR TEES. THE DETAIL

OF THE FITTINGS MUST BE SUBMITTED TO THE ENGINEER FOR

APPROVAL PRIOR TO MANUFACTURE. PIPE CONNECTIONS TO NEW

CAST IN PLACE CONCRETE PIPE MAINS SHALL BE MADE PER COP

ALIGNMENT AND SLOPE UNLESS OTHERWISE SPECIFIED. IF BREAKS

CONDITIONS. THE MAXIMUM DEFLECTION SHALL BE $22-1/2^{\circ}$. THE

BEND SHALL BE COLLARED ACCORDING TO COP DETAIL P1505.

7. CONNECTOR PIPES SHALL CONNECT TO CATCH BASIN WALLS AT AN

ANGLE NOT TO EXCEED 22-1/2 FROM PERPENDICULAR.

8. FACILITIES WHICH ARE NOT SPECIFICALLY LOCATED WITH ACTUAL

APPROXIMATELY AND TO THE BEST AVAILABLE INFORMATION

PROVIDED BY VARIOUS OWNERS OF THE FACILITIES AND

SUPPLEMENTED BY VISUAL SURFACE INFORMATION WHERE

9. A ONE (1) FOOT MINIMUM VERTICAL SEPARATION FROM DRY

10. AT LEAST TWO WORKING DAYS BEFORE CONSTRUCTION. THE

UTILITIES CROSSINGS SHALL BE PROVIDED FOR SEWER MAINS

CONTRACTOR SHALL CONTACT BLUESTAKE TO FIND AND FLAG

OTHER APPROPRIATE UTILITIES DIRECTLY IF THEY ARE NOT ON

UNDERGROUND UTILITIES. THE CONTRACTOR SHALL CONTACT

11. VERTICAL CONTROL IS BASED ON NATIONAL GEODETIC SURVEY,

12. UNLESS OTHERWISE NOTED, STATIONS SHOWN ON PIPE PROFILES

14. CATCH BASINS ARE STATIONED PERPENDICULAR TO THE CENTERLINE

15. SANITARY SEWER MAINS AND TAPS CROSSING OVER STORM DRAIN

16. ALL EXISTING PRECAST CONCRETE SAFETY CURBS AND ALL

OF THE STREET AT THE CENTERLINE OF THE MAINTENANCE BASIN.

MAINS SHALL BE SUPPORTED PER MAG DETAIL 403-1, 403-2, OR

EXISTING WOODEN PARKING CURBS WHICH ARE INSIDE THE RIGHT

OF WAY AND APPROXIMATELY PARALLEL TO THE NEW CURB LINE

THEIR EXISTING LOCATION, WITH THE BACK EDGE ON THE RIGHT

SHALL BE RESET ON THE RIGHT OF WAY DIRECTLY OPPOSITE

OF WAY LINE. ALL OTHER PRECAST CONCRETE SAFETY CURBS

INSIDE THE STREET RIGHT OF WAY SHALL BE SALVAGED AND

17. EXISTING PRECAST CONCRETE SAFETY CURBS OUTSIDE THE RIGHT

WILL BE NO SEPARATE MEASUREMENT OR PAYMENT FOR THIS

18. ALL EXISTING DRIVEWAYS AND ALL EXISTING ALLEYS SHALL BE

DETAIL P1164, UNLESS OTHERWISE SPECIFIED. EXISTING

WORK, THE COST BEING CONSIDERED INCLUDED.

OF WAY WHICH ARE DISTURBED BY NEW CONSTRUCTION SHALL BE

RESET IN THEIR ORIGINAL POSITION BY THE CONTRACTOR. THERE

GRADED TO MATCH THE NEW WORK IN ACCORDANCE WITH STD

SURFACING SHALL BE REMOVED AND REPLACED AS NECESSARY.

STOCK PILED FOR THE OWNER AT THE RIGHT OF WAY LINE.

13. UNLESS OTHERWISE NOTED. PIPE SHALL BE BEDDED IN

ACCORDANCE WITH CITY OF PHOENIX DETAIL P1200.

SEWER SERVICES, WATER MAIN, OR WATER SERVICE TO OUTSIDE

VERTICAL AND HORIZONTAL CONTROLS, ARE LOCATED ONLY

APPROPRIATE. ACCURACY, LOCATION AND COMPLETENESS OF THIS

INFORMATION SHALL BE VERIFIED BY THE CONTRACTOR PRIOR TO

6. CATCH BASIN CONNECTOR PIPES SHALL BE LAID ON A STRAIGHT

IN ALIGNMENT OR SLOPE ARE NECESSARY TO MEET FIELD


ANY ANGLE BENDS GREATER THAN 22-1/2° SHALL BE

TO OBLITERATE RAISED LETTERING, AND PROVIDE A SMOOTH

CONTRACT SPECIFICATIONS; PLANS; CITY OF PHOENIX SUPPLEMENTS

ABBREVIATIONS

PC = PIPE CONNECTION MH = MANHOLE CB = CATCH BASIN

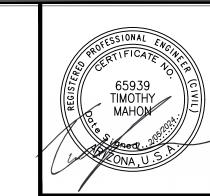

F.H.W.A. REGION	STATE	PROJ. NO.	NO.	TOTAL	AS BUILT
9	ARIZ	ST83140119	2	50	
12/23 DATE:	-	A	ZTE	EC TYPS	501 N. 44TH ST SUITE 300 PHOENIX, AZ 85008 PH: 602-454-0402 www.Aztec.us
DRAWN:	LNB	DESIGN:	CJR	CHECK	ED: TMM
	•	•		•	•

NOTES (CONT)

- 19. CONTACT INSPECTOR IF LESS THAN 6 INCHES OR COVER WILL BE MAINTAINED BELOW SCARIFICATION DEPTH CONTRACTOR TO FIELD VERIFY DEPTH AT LOCATION OF NEW AC AND SIDEWALK
- 20. IN HISTORIC PRESERVATION ZONES, THE CONTRACTOR SHALL DISTURB AS LITTLE OF HISTORIC SIDEWALK AS POSSIBLE. UNLESS OTHERWISE PROVIDED ON THE PLANS:

THE SPACE BETWEEN THE BACK OF NEW DRIVEWAY ENTRANCES AND

THE SPACE BETWEEN THE BACK OF NEW SIDEWALKS AND EXISTING PRIVATE SIDEWALKS, AND THE SPACE BETWEEN THE BACK OF NEW WITH PCC. THE THICKNESS AND CLASS SHALL MATCH THAT OF THE

THE SPACE BETWEEN THE BACK OF THE SIDEWALKS AND EXISTING AC PARKING LOTS, WHICH FALL WITHIN OR ABUT THE R/W SHALL BE

- 21. EXISTING IRRIGATION BERMS DISTURBED BY NEW CONSTRUCTION SHALL
- 22. CATCH BASIN ACCESS FRAME AND COVERS SHALL BE CONSTRUCTED
- 23. DRIVEWAY ACCESS SHALL BE MAINTAINED AT ALL TIMES DURING

- 1. "CLEAR" DIMENSIONS FOR DEPTH OF REINFORCING STEEL ARE FROM FACE
- 2. ALL EXPOSED EDGES OF CONCRETE SHALL BE BEVELED OR ROUNDED.
- 1. COMPACTION SHALL COMPLY WITH MAG SECTION 601.
- INSPECTION GROUP, 602-262-7811 VOICE OR 7-1-1 TTY, SHALL BE NOTIFIED 48 HOURS PRIOR TO ANY CONSTRUCTION WORK WITHIN THE PUBLIC RIGHT-OF-WAY.
- 4. EXISTING OR NEWLY DAMAGED AND/OR DISPLACED CONCRETE CURB, GUTTER, SIDEWALK, OR DRIVEWAY SLAB THAT IS WITHIN THE RIGHT-OF-WAY SHALL BE REPAIRED OR REPLACED. AS NOTED BY CITY INSPECTORS, BEFORE FINAL ACCEPTANCE OF THE WORK.
- 6. THE ACTUAL POINT OF PAVEMENT MATCHING, AND/OR TERMINATION, SHALL BE DETERMINED IN THE FIELD BY THE PLANNING AND DEVELOPMENT DEPARTMENT CIVIL/SITE INSPECTOR.
- TIMES. DEVIATIONS FROM THE PLAN MUST BE PRECEDEDBY AN APPROVED PLAN REVISION.
- RIGHT-OF-WAY SHALL BE REMOVED OR RELOCATED BEFORE BEGINNING CONSTRUCTION OF THE PROPOSED IMPROVEMENTS.
- CONSTRUCTION OF SURFACE IMPROVEMENTS SHALL NOT BEGIN UNTIL CONFLICTING UNDERGROUND UTILITY CONSTRUCTION IS COMPLETED AND SERVICE CONNECTIONS TO ALL PLATTED LOTS HAVE BEEN ADEQUATELY EXTENDED PAST THE RIGHT-OF-WAY.

PAVING NOTES (CONT)

- 10. ALL FRAMES, COVERS, VALVE BOXES, AND MANHOLE COVERS SHALL BE ADJUSTED TO FINISH GRADE PRIOR TO COMPLETION OF PAVING OR RELATED CONSTRUCTION. ADJUSTMENT OF EXISTING "TYPE A" OR "TYPE B" WATERLINE VALVE BOXES IN THE PARKWAY SHALL BE CONSIDERED INCIDENTAL TO PARKWAY GRADING. EXISTING "TYPE B" WATERLINE VALVE BOXES SHALL BE REPLACED WITH "TYPE A" BOXES PER CITY OF PHOENIX STANDARD DETAIL P1391.
- GRADING BETWEEN BACK OF CURB AND PROPERTY LINE SHALL BE LIMITED TO 4:1 SLOPE.
- 12. THE PLANNING AND DEVELOPMENT CIVIL/SITE INSPECTOR MUST CONTACT STREET TRANSPORTATION DEPARTMENT. TRAFFIC SERVICES DIVISION AT 602-495-0205 VOICE OR 7-1-1 TTY TWO (2) WEEKS PRIOR TO COMPLETION OF PAVING WORK FOR SIGNING & STRIPING.
- 13. AUTHORIZATION TO RESTRICT OR CLOSE THE RIGHT-OF-WAY CAN ONLY BE OBTAINED THROUGH THE TRAFFIC SERVICES DIVISION, RIGHT- OF- WAY MANAGEMENT (ROWM) SECTION. TRACS PERMITS MUST BE OBTAINED FOR EACH INDIVIDUAL PROJECT THROUGH ROWM. TRACS PERMITS ARE APPROVED BASED ON THE PHASING OF THE PROJECT AND THE SCOPE OF WORK. PERMISSION TO RESTRICT CITY STREETS, SIDEWALKS AND ALLEYS (STREET CLOSURE PERMITS) SHALL BE REQUESTED AS SPECIFIED IN CHAPTER 2 OF THE TRAFFIC BARRICADE MANUAL CURRENT VERSION AND ADDENDUMS THEREOF - STREETS DEPARTMENT: RIGHT-OF-WAY MANAGEMENT OFFICE
- 14. ASPHALT RESTORATION IS REQUIRED FOR ANY STREET CUT. REFEI TO STREET PAVEMENT CUT POLICY (TRT 00164 AND ORDINANCE G-6308).
- 15. PAVEMENT REPLACEMENT THICKNESS AND TYPE ARE TO BE PER MAG. SECTION 336 AND CITY DETAIL P1200 -TYPE B. CURB AND GUTTER REPLACEMENT SHALL BE A MINIMUM OF ONE (1) FULL SECTION, PER MAG STANDARD DETAIL 220. SIDEWALK REPLACEMENT SHALL BE A MINIMUM OF ONE (1) FULL PANEL PER C.O.P. DETAIL P1230.
- 16. TREES AND SHRUBBERY IN THE R/W THAT CONFLICT WITH PROPOSED IMPROVEMENTS SHALL NOT BE REMOVED WITHOUT A PPROVAL OF THE CITY LANDSCAPE ARCHITECT OR HIS ASSIGNEES. THE PERMITTEE SHALL BE RESPONSIBLE FOR OBTAINING AUTHORIZATION TO REMOVE AND/OR RELOCATE SAID TREES OR SHRUBBERY BY CALLING THE PARKS AND RECREATION DEPARTMENT AT (602)262-6501 AND TRANSPORTATION DEPARTMENT AT (602)534-9898.
- 17. PER THE STREET PAVEMENT CUT POLICY (TRT 00164) AND CITY ORDINANCE G-6308, ALL STREET PAVEMENT CUTS WILL REQUIRE ASPHALT RESURFACING TREATMENTS BASED ON THE AGE OF THE PAVEMENT. FOR STREETS LESS THAN TWO (2) YEARS OLD, THE PERMITTEE MUST APPLY AN ASPHALT MILL AND OVERLAY PAVEMENT TREATMENT. FOR STREETS GREATER THAN TWO (2) YEARS OLD, THE PERMITTEE MUST APPLY A SLURRY SEAL AND/OR MICROSEAL TREATMENT.
- 18. ALL RAMPS MUST MEET 2010 AMERICANS WITH DISABILITIES ACT (ADA) STANDARDS FOR ACCESSIBLE DESIGN AND CITY OF PHOÉNIX SUPPLEMENT TO MAG UNIFORM STANDARD SPECIFICATIONS AND DETAILS; 2% MAX CROSS SLOPES AND 12:1 MAX LONGITUDINAL SLOPES.

"PER CITY OF PHOENIX CITY CODE CHAPTER 2, SECTION 2-28 THESE PLANS ARE FOR OFFICIAL USE ONLY & MAY NOT BE SHARED WITH OTHERS EXCEPT AS REQUIRED TO FULFILL THE OBLIGATIONS OF THE CONTRACTOR'S CONTRACT WITH THE CITY OF PHOENIX."

LEGEND & NOTES

CITY OF PHOENIX, ARIZONA STREET TRANSPORTATION DEPARTMENT

> CANAL NORTH 7TH ST & MINNEZONA ST83140119

PR: LNB DES: CJR CK: TMM DRAWING SERIES NO. SCALE: NONE G-1.01

 $C:\pw_working\pw_prod\tmahon\dms64452\ST83140125LN02_1.dwg$

EASEMENT LINE

EXISTING OR NEW R/W LINE

EXISTING TREE TO REMAIN

Feb 02, 2024 - 1:13pm

TMahon

EXISTING AC DRIVEWAYS SHALL BE FILLED WITH A MINIMUM OF 3" ACSC 11. ON 100% COMPACTED NATIVE SOIL. WHERE EXISTING PAVEMENT AND BASE THICKNESS EXCEED THE MINIMUMS, MATCH THE EXISTING.

DRIVEWAY ENTRANCES AND EXISTING PCC DRIVEWAYS SHALL BE FILLED NEW SIDEWALK OR DRIVEWAY ENTRANCE.

FILLED WITH 2" ACSC ON 100% COMPACTED NATIVE SOIL.

- BE RECONSTRUCTED AS SHOWN ON PLANS.
- PER COP DETAIL P1561.
- CONSTRUCTION. DRIVEWAY ACCESS REMOVAL SHALL BE APPROVED BY THE ENGINEER.

STRUCTURAL NOTES

- OF CONCRETE TO FACE OF BARS.
- 3. ALL EXPOSED CONCRETE SURFACES SHALL BE FINISHED IN ACCORDANCE WITH MARICOPA ASSOCIATION OF GOVERNMENTS (MAG) STANDARD SPECIFICATION 505.9 - FINISHING CONCRETE, UNLÉSS OTHERWISE SPECIFIED.

PAVING NOTES

- 2. CONSTRUCTION WITHIN THE RIGHT-OF-WAY SHALL CONFORM TO THE LATEST APPLICABLE MAG UNIFORM STANDARD SPECIFICATIONS AND DETAILS AND THE LATEST CITY OF PHOENIX SUPPLEMENT TO THE MAG UNIFORM STANDARD SPECIFICATIONS AND DETAILS.
- 3. THE CITY OF PHOENIX PLANNING AND DEVELOPMENT CIVIL/SITE
- 5. ALL NEW OR RELOCATED UTILITIES SHALL BE PLACED UNDERGROUND.
- 7. AN APPROVED PAVING PLAN SHALL BE ON THE JOB SITE AT ALL
- 8. OBSTRUCTIONS TO PROPOSED IMPROVEMENTS IN THE

	AMERICAN RESCUE PLAN ACT LOCAL DRAINAGE MITIGATION PROGRAM
	PHOENIX STREETS — MARICOPA CO. WATER GENERAL NOTES
	1. ALL WATER VALVE BOXES SHALL BE PER CITY OF PHOENIX SUPPLEMENT TO MAG.
	SPECIFICATIONS AND DETAILS P1391, TYPE A ONLY.
BY DATE	2. ALL CONSTRUCTION IN THE CITY OF PHOENIX RIGHT—OF—WAY, OR EASEMENT, IS TO CONFORM TO M.A.G SPECIFICATIONS AND DETAILS AND CITY OF PHOENIX SUPPLEMENT TO M.A.G SPECIFICATIONS AND DETAILS, UNLESS MODIFIED ON THE PLANS.
BY CITY OF PHOENIX PION REV BY CKD	3. ALL DUCTILE IRON PIPE WATER MAIN VALVES, FITTINGS, AND BENDS SHALL BE RESTRAINED. RESTRAINED JOINT REQUIREMENTS AND APPROVED RESTRAINING SYSTEM ARE SHOWN IN CITY OF PHOENIX SUPPLEMENT TO M.A.G. SPECIFICATIONS, SECTION 750.3. THE LENGTH OF THE RESTRAINTS MUST BE PER M.A.G. STANDARD DETAIL 305-1 AND 303-2. THRUST BLOCKS ARE NOT ALLOWED TO BE USED IN LIEU OF APPROVED RESTRAINED JOINT SYSTEMS. THRUST BLOCKS CAN BE USED IN ADDITION TO THE APPROVED RESTRAINED JOINT SYSTEMS WHERE A SPECIFIC CITY OF PHOENIX SUPPLEMENT TO M.A.G. STANDARD DETAIL CALLS OUT FOR THRUST BLOCKING, SUCH AS CURRENT DETAILS, P1343, P1351, AND P1360 OR WHEN OTHERWISE APPROVED BY THE WATER SERVICES DEPARTMENT.
REVISION BY DESCRIPTION	4. THE FOLLOWING M.A.G. DETAILS ARE SPECIFICALLY NOT APPROVED:
REVI	302—1 JOINT RESTRAINT WITH TIE RODS 302—2 JOINT RESTRAINT WITH TIE RODS — ANCHOR BLOCKS
	321 STANDARD WATER METER VAULT
ÖZ	345-1 3", 4", AND 6" WATER METER
	345-2 4" AND 6" WATER METER WITH ON-SITE FIRE HYDRANTS 370 VERTICAL REALIGNMENT OF WATER MAINS 381 ANCHOR BLOCKS FOR VERTICAL BENDS 390 CURB STOP WITH FLUSHING PIPE 391-1 VALVE BOX INSTALLATION
DATE	5. COMPACTION SHALL COMPLY WITH M.A.G. SECTION 601 AND CITY OF PHOENIX SUPPLEMENTS.
B	6. NEW WATER LINES ARE TO BE BUILT IN ACCORDANCE WITH THE CITY OF PHOENIX "STANDARD UTILITY LOCATIONS".
REVISION BY CITY OF PHOENIX DESCRIPTION REV BY CKD	7. THIS SET OF PLANS HAS BEEN INITIALLY REVIEWED BY THE CITY OF PHOENIX. SUCH REVIEW IS PART OF THE PROCESS THAT DEVELOPER(S)/CONTRACTOR(S)MUST GO THROUGH IN ORDER TO OBTAIN A CONSTRUCTION PERMIT. THE RESULTS OF SUCH INITIAL REVIEW SHALL NOT DICTATE THE CITY OF PHOENIX'S FINAL DETERMINATION AS TO THE ACCEPTABILITY OF THE PLANS, NOR SHALL IT PREVENT THE CITY OF PHOENIX FROM REQUIRING ERRORS AND OMISSIONS, AS FOUND ON PLANS, BE ADDRESSED BY DEVELOPER(S)/CONTRACTOR(S), WHERE SUCH ERRORS AND OMISSIONS CAUSE THE PLANS TO BE IN VIOLATION OF OR INADEQUATE UNDER APPLICABLE FEDERAL/STATE/COUNTY/LOCAL CODES, ORDINANCES, REGULATIONS, OR OTHER LAWS. THIS REVIEWED AND STAMPED SET OF PLANS MUST BE KEPT AT THE CONSTRUCTION SITE AT ALL TIMES.
	8. PIPE DEFLECTION SHALL BE PER MANUFACTURERS' RECOMMENDATIONS. 9. ALL WORK MUST COMPLY WITH REQUIREMENTS OF THE CURRENT CITY OF PHOENIX "TRAFFIC
ÖZ	BARRICADE MANUAL". 10. THE CONTRACTOR IS TO NOTIFY THE PUBLIC THAT WILL BE AFFECTED BY ANY SHUTDOWNS A MINIMUM OF 48 HOURS IN ADVANCE.
	11. A SIX (6) FOOT MINIMUM HORIZONTAL SEPARATION FROM ANY UNDERGROUND UTILITY SHALL BE PROVIDED FOR SEWER MAINS, SEWER SERVICES, WATER MAINS, AND WATER SERVICES. THE MINIMUM HORIZONTAL SEPARATION IS MEASURED FROM OUTSIDE OF SEWER MAIN, SEWER SERVICE, WATER MAIN, OR WATER SERVICE TO OUTSIDE OF UNDERGROUND UTILITY.
BY DATE	12. A ONE (1) FOOT MINIMUM VERTICAL SEPARATION FROM ANY DRY UNDERGROUND UTILITY CROSSING SHALL BE PROVIDED FOR SEWER MAINS, SEWER SERVICES, WATER MAINS, AND WATER SERVICES. THE MINIMUM VERTICAL SEPARATION IS MEASURED FROM OUTSIDE OF SEWER MAIN. SEWER SERVICE, WATER MAIN, OR WATER SERVICE TO OUTSIDE OF DRY UNDERGROUND UTILITY.
OF PHOENIX REV BY CKD	13. A TWO (2) FOOT MINIMUM VERTICAL SEPARATION SHALL BE PROVIDED BETWEEN ANY SEWER AND STORM DRAIN CROSSING A WATER MAIN, THE MINIMUM VERTICAL SEPARATION IS MEASURED FROM OUTSIDE OF WATER MAIN TO OUTSIDE OF SEWER MAIN OR STORM DRAIN MAIN. SEE M.A.G. STANDARD DETAIL 404 FOR ADDITIONAL INFORMATION AND/OR PROVISIONS FOR CLEARANCE.
REVISION BY CITY DESCRIPTION	14. EXCEPTIONS OR DEVIATIONS FROM THE ABOVE MINIMUM CLEARANCES MUST BE APPROVED AND SHOWN ON THE APPROVED WATER SEWER PLANS. WHEN UTILITY CONFLICTS ARE FOUND DURING CONSTRUCTION, ALL CHANGES AND REVISIONS MUST BE PRECEDED BY AN APPROVED PLAN REVISION.
EVISIC DESC	15. ANY AND ALL MORE STRINGENT REQUIREMENTS REQUIRED BY FEDERAL, STATE, COUNTY OR LOCAL CODES OR ORDINANCES TAKE PRECEDENCE.
	16. WATER SERVICES SHALL BE INSTALLED PERPENDICULAR TO THE WATER MAIN. WATER SERVICES AT THE END OF CUL-DE-SACS MAY VARY AS NECESSARY, BUT WILL BE APPROVED ON A CASE BY CASE BASIS.
ÖZ	17. ALL SERVICES SHALL RUN IN A STRAIGHT LINE FROM THE WATER MAIN TO THE METER BOX.
	18. NEITHER WATER SERVICE METER BOX NOR ANY PORTION OF A WATER SERVICE SHALL BE INSTALLED UNDER AN EXISTING OR PROPOSED DRIVEWAY OR SIDEWALK RAMP.

WATER NOTES (CONT.)

20. RECORD DRAWING SUBMITTALS MUST COMPLY PER THE WATER SERVICES DEPARTMENT ENGINEERING POLICY P-68 AND P-69. A COPY OF THE POLICY CAN BE OBTAINED IN THE DEPARTMENT'S WEBSITE: WATER VALVE BOXES SHALL BE PER CITY OF PHOENIX SUPPLEMENT TO MAG. HTTP://PHOENIX.GOV/WATERSERVICES/DESIGN/ENGPOLICIES/INDEX.HTML ECIFICATIONS AND DETAILS P1391, TYPE A ONLY.

19. CONCRETE OR ASPHALT DAMAGED DURING THE COURSE OF CONSTRUCTION SHALL BE

REMOVED AND REPLACED IN KIND PRIOR TO FINAL INSPECTION.

- 21. IN ACCORDANCE WITH AAC R-18-4-213, ALL MATERIALS ADDED AFTER JANUARY 1, 1993 WHICH MAY COME INTO CONTACT WITH DRINKING WATER SHALL CONFORM TO NATIONAL SANITATION FOUNDATION STANDARDS 60 AND 61.
- 22. PER CITY OF PHOENIX CITY CODE CHAPTER 2. SECTION 2-28. THESE PLANS ARE FOR OFFICIAL USE ONLY AND MAY NOT BE SHARED WITH OTHERS EXCEPT AS REQUIRED TO FULFILL THE OBLIGATIONS OF THE CONTRACTOR'S CONTRACT WITH THE CITY OF PHOENIX.
- 23. A PAVEMENT CUT SURCHARGE SHALL BE ASSESSED ON THIS PROJECT FOR ANY TRENCHING OR POTHOLING IN NEW ASPHALT PAVEMENT THAT IS LESS THAN 30 MONTHS OLD. SURCHARGE FEES ASSESSED ARE IN ADDITION TO THE REGULAR PERMIT FEES AND ARE OVER AND ABOVE ANY SPECIAL BACKFILL, COMPACTION, AND PAVEMENT REPLACEMENT STIPULATIONS THAT MAY BE IMPOSED AS A CONDITION OF PERMITTING. PAVEMENT CUT SURCHARGE FEES ARE ASSESSED IN ACCORDANCE WITH SECTION 31-38 OF THE PHOENIX CITY CODE.
- 24. PLAN APPROVAL IS VALID FOR 180 DAYS. PRIOR TO PLAN APPROVAL EXPIRATION, ALL ASSOCIATED PERMITS SHALL BE PURCHASED OR THE PLANS SHALL BE RESUBMITTED FOR EXTENSION OF PLAN APPROVAL. THE EXPIRATION, EXTENSION, AND REINSTATEMENT OF CIVIL ENGINEERING PLANS AND PERMITS SHALL FOLLOW THE SAME GUIDELINES AS THOSE INDICATED IN THE PHOENIX BUILDING CONSTRUCTION CODE ADMINISTRATIVE PROVISIONS SECTION 105.3 FOR BUILDING PERMITS.
- 25. FOR SHUTDOWNS NECESSARY TO ACCOMPLISH APPROVED WORK, THE CONTRACTOR SHALL CONTACT THE PROJECT INSPECTOR EARLY IN THE PROJECT TO COORDINATE A SHUTDOWN WITH THE WATER SERVICES DEPARTMENT, FIELD DISTRIBUTION & COLLECTIONS STAFF, THE CONTRACTOR SHALL HAVE ALL MATERIALS AND EQUIPMENT ON THE PROJECT SITE TO COMPLETE THE CONNECTION(S) PRIOR TO THE SHUTDOWN.


ONCE THE EXISTING WATER PIPE IS CUT, IT SHALL BE THE CONTRACTOR'S RESPONSIBILITY TO KEEP THE PIPE CLEAN AND FREE OF DIRT AND DEBRIS BY CAPPING THE ENDS UNTIL THE FINAL CONNECTIONS CAN BE COMPLETED, PRIOR TO THE FINAL CONNECTIONS, THE EXISTING PIPE SHALL BE SWABBED WITH A MINIMUM 50 PPM CHLORINE SOLUTION FOR A DISTANCE OF 10 FEET FROM THE OPENING.

THE CONTRACTOR SHALL BE RESPONSIBLE FOR MAINTAINING ACCESSIBILITY TO THE VALVE OPERATING NUT FOR ALL VALVES, WITHIN THE PROJECT BOUNDARIES. FAILURE TO MAINTAIN ACCESSIBILITY TO VALVES SHALL BE CAUSE FOR CANCELING THE SHUTDOWN AND THE CONTRACTOR MUST PROPERLY REQUEST A SCHEDULE REVISION.

THE WATER SERVICES DEPARTMENT IS INDEMNIFIED FOR ANY AND ALL RESULTANT COSTS INCURRED BY THE CONTRACTOR SUCH AS, BUT NOT LIMITED TO TRAFFIC CONTROL, DELAYS, LOSS OF INCENTIVES, STANDBY AND PENALTIES IF THE CONTRACTOR DID NOT PROPERLY REQUEST A SHUTDOWN; OR FAILED TO MAINTAIN ACCESSIBILITY TO VALVES; OR ON THE SCHEDULED DATE WORK HAD NOT PROGRESSED TO THE POINT AT WHICH THE SHUTDOWN WAS NEEDED.

- 26. VALVE BOX REMOVAL AFTER ACCEPTANCE OF THE NEW WATERLINES, FIRE HYDRANTS AND SERVICE CONNECTIONS THE CONTRACTOR SHALL SHUT THE VALVE, REMOVE THE BOX AND COVER, BACKFILL AND COMPACT THE VOID WITH ABC AS APPLICABLE, COVER WITH 2-INCH AC (C 3/4) PAVEMENT, OR AS REQUIRED TO MATCH EXISTING GROUND.
- 27. CUT AND PLUG -THE CONTRACTOR SHALL CUT AND PLUG EXISTING WATERLINES AS NOTED ON THE APPROVED PLANS AFTER ALL EXISTING WATER SERVICES HAVE BEEN TIED OVER TO THE NEW WATERLINE.
- 28. SWING CONNECTIONS AFTER THE NEW WATERLINE IS ACCEPTED FOR SERVICE, THE CONTRACTOR SHALL MAKE "SWING CONNECTIONS" TO EXISTING WATERLINES AS INDICATED ON THE APPROVED PLANS. "SWING CONNECTIONS" SHALL INCLUDE ALL PIPING AND APPURTENANCES (OFFSETS, BENDS, ETC.) REQUIRED TO AFFECT A CONNECTION.
- 29. WATER SERVICES THE CONTRACTOR SHALL REPLACE EXISTING WATER SERVICES AS INDICATED ON THE APPROVED PLANS WITH NEW SERVICE PIPE AND CURB STOP FOR THE RELOCATED EXISTING WATER METERS. (ALL SERVICE CONNECTIONS MUST BE AT MINIMUM 1-INCH. FOR 3/4-INCH METERS, A 3/4-INCH REDUCER MUST BE INSTALLED TO ACCOMMODATE THE METER).
- 30. METER AND BOX THE CONTRACTOR SHALL RELOCATE THE EXISTING METERS AND METER BOXES, AND CONNECT THEM AS INDICATED ON THE APPROVED PLANS AFTER THE NEW WATERLINE HAS BEEN ACCEPTED FOR SERVICE.
- 31. NEW WATER METERS AND SERVICES WILL BE INSTALLED AFTER THE CONTRACTOR MAKES PROPER APPLICATION AND PAYS THE PREVAILING FEES. APPLICATION AND PAYMENT OF FEES CAN BE MADE AT THE FOLLOWING ADDRESS: CITY OF PHOENIX. WATER SERVICES DEPARTMENT. INFRASTRUCTURE RECORD SERVICES DIVISION. 200 WEST WASHINGTON STREET, 8TH FLOOR, PHOENIX, A2 85003.
- 32. SURPLUS ABANDONED FIRE HYDRANTS (BARREL PORTION ONLY) TO THE CITY OF PHOENIX WATER DEPARTMENT - SUPPORT SERVICES, 4436 N. 35TH AVENUE, PHOENIX. CONTACT THE WATER DEPARTMENT - SUPPORT SERVICES BY CALLING 602-262-5077 FOR ANY ADDITIONAL INFORMATION.
- 33. CITY OF PHOENIX WATER DEPARTMENT PERSONNEL SHALL REMOVE ALL PROPOSED EXISTING WATER METERS THAT ARE TO BE ABANDONED ONCE ALL REQUIRED FEES HAVE BEEN PAIN BY THE APPLICANT AT COUNTER 8 - CIVIL PERMITS, ON THE SECOND FLOOR OF CITY OF PHOENIX CITY HALL, LOCATED AT 200 W. WASHINGTON STREET.
- 34. ALL CONSTRUCTION ACTIVITIES SHALL BE CONTAINED WITHIN THE PUBLIC RIGHT OF WAY OR IN EASEMENTS GRANTED FOR THE WATER AND/OR SEWER MAIN INSTALLATION.
- 35. TRAFFIC CONTROL SHALL CONFORM TO THE RIGHT-OF-WAY MANAGEMENT PROGRAM (RMP), ADOPTED BY THE CITY OF PHOENIX AND SHALL ALSO BE SUBJECT TO CITY REVIEW AND APPROVAL.
- 36. ALL DIMENSIONS SHOWN ARE TO THE MONUMENT LINE OTHERWISE. IN RIGHT OF WAY, UNLESS NOTED OTHERWISE.
- 37. WHEN RELOCATING WATER METERS WHICH UTILIZE EITHER GALVANIZED OR POLYETHYLENE SERVICE PIPE (OR ANY OTHER NON STANDARD SERVICE PIPE) THE ENTIRE SERVICE PIPING SHALL BE REPLACED USING THE APPROVED SERVICE PIPE MATERIAL FOR THAT PARTICULAR METER SIZE. THE EXISTING CORPORATION STOP CAN BE USED PROVIDED AND APPROVED COPPER PIPE ADAPTER IS USED. APPROVED ADAPTERS ARE THE FORD CO4-43 AND CO4-54 CONVERSION ASSEMBLY OR EQUAL.

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AS BUILT

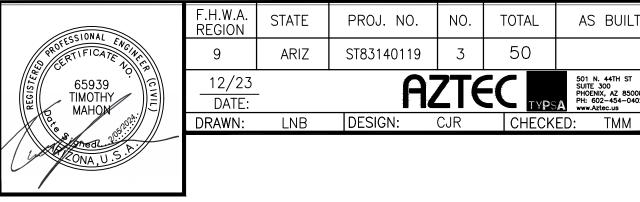WATER NOTES (CONT.)

- 38. BIDDERS ARE ADVISED THAT THE LOCATION, NUMBER, AND TYPE OF UTILITIES SHOWN ON THESE PLANS AND SPECIFICATIONS ARE ONLY AS ACCURATE AS THE BEST INFORMATION AVAILABLE FROM PUBLIC UTILITIES. OWNERS. AND USERS AT THE TIME THESE PLANS AND SPECIFICATIONS WERE PREPARED. UNDERGROUND UTILITIES MAY BE PRESENT ON THIS PROJECT WHICH WERE NOT DISCLOSED TO THE ENGINEER. NO REPRESENTATION IS MADE THAT THE UTILITIES LOCATIONS INDICATED ON THESE PLANS ARE ACCURATE, COMPLETE, OR EXCLUSIVE. BIDDERS ARE ADVISED TO UNDERTAKE THEIR OWN INVESTIGATIONS OF EXISTING CONDITIONS BEFORE SUBMITTING A PROPOSAL ON THIS PROJECT. THE CONTRACTOR IS RESPONSIBLE FOR THE COST OF ALL TEST PITS OR THE PRE-CONSTRUCTION INVESTIGATION OF UNDERGROUND UTILITIES OR STRUCTURE. PURSUANT TO ARIZONA REVISED STATUTE 40-360.21, THE CONTRACTOR MUST CONTACT "BLUE STAKE" AT (602)261-1100 OR THE APPROPRIATE PUBLIC UTILITY FOR ASSISTANCE IN LOCATING UNDERGROUND FACILITIES, LINES, AND APPURTENANCES PRIOR TO CONSTRUCTION.
- 39. BY SUBMITTING A PROPOSAL ON THIS PROJECT, BIDDERS ARE REPRESENTING THAT THEY HAVE CONSIDERED THE POTENTIAL IMPACT OF TEMPORARY OR PERMANENT RELOCATION OF EXISTING UNDERGROUND UTILITIES LOCATED WITHIN THE PROJECT ON THEIR COSTS, AND THAT THEY HAVE INCLUDED IN THEIR PROPOSALS THE COST OF FINDING, PROTECTING, AND RELOCATING ALL EXISTING UTILITIES WITHIN THE PROJECT. NO ADDITIONAL COMPENSATION FOR DAMAGES WILL BE PAID FOR ANY COST, LOSS, DAMAGE, HINDRANCE, OR DELAY INCURRED BY A CONTRACTOR OR SUBCONTRACTOR DUE TO CONFLICTS WITH EXISTING UTILITIES; REGARDLESS OF WHETHER OR NOT THOSE UTILITIES ARE INDICATED ON THE PLANS OR SPECIFICATIONS FOR THIS PROJECT.
- 40. THE SOLE AND EXCLUSIVE REMEDY FOR ANY COST, HINDRANCE, OR DELAY CAUSED BY ANY UTILITIES LOCATED WITHIN THE PROJECT (WHETHER OR NOT INDICATED ON THE PLANS OR SPECIFICATIONS) SHALL BE AN EXTENSION OF THE CONTRACT TIME; THE NEED FOR OR DURATION OF WHICH SHALL BE DETERMINED BY THE ENGINEER IN ITS SOLE DISCRETION.
- 41. PER MAG SECTION 630, THE CONTRACTOR SHALL FURNISH SHOP DRAWINGS AND TECHNICAL DATA REQUIRED FOR EVALUATING AND APPROVAL OF EACH TYPE OF VALVE. TAPPING SLEEVE AND VALVE AND BUTTERFLY VALVE. SHOP DRAWINGS MUST BE SUBMITTED TO WATER SERVICES AFTER THE ENGINEER OF RECORD HAS PROVIDED THEIR RECOMMENDATION OR APPROVAL.
- 42. THE CONTRACTOR SHALL USE EXTREME CAUTION WHILE WORKING IN THE VICINITY OF ALL GAS AND POWER LINES. THE CONTRACTOR SHALL MAINTAIN THE INTEGRITY OF THE GAS AND POWER TRENCHES AND PIPELINES AT ALL TIMES. SPECIAL ATTENTION SHALL BE GIVEN TO BRACING AND SUPPORT FOR UNDERGROUND POWER CROSSINGS. TRENCHING WITHIN A TWO FOOT VICINITY OF GAS LINES SHALL BE BY HAND. ALL POWER LINE CROSSINGS SHALL BE BRACED DURING CONSTRUCTION. BRACING SHALL BE A NON PAY ITEM UNLESS NOTED OTHERWISE. POLE BRACING MAY BE REQUIRED WHEN EXCAVATING NEAR POWER POLES.
- 43. THE CONTRACTOR SHALL SUPPORT AND PROTECT IN PLACE ALL EXISTING UTILITIES WITHIN THE EXCAVATION AS REQUIRED BY THE MAG SPECIFICATIONS.
- 44. THE CONTRACTOR SHALL CONSTRUCT PERMANENT OR TEMPORARY PIPE SUPPORTS AS SHOWN ON MAG STANDARD DETAILS 403-1, 403-2 AND 403-3 FOR ALL UTILITY CROSSINGS ON THIS PROJECT. PIPE SUPPORTS SHALL BE A NON PAY ITEM.
- 45. THE CONTRACTOR MUST PROTECT THE ADJACENT PROPERTY AND IMPROVEMENTS THERETO FROM ANY DAMAGE DURING CONSTRUCTION. ANY DAMAGE TO ADJACENT PROPERTY OR IMPROVEMENTS MUST BE REPAIRED OR REPLACED, TO THE PROPERTY OWNER'S SATISFACTION. AT THE CONTRACTOR'S EXPENSE.
- 46. OPEN CUT SLOPES AND SHORING FOR TRENCH EXCAVATIONS SHALL AS A MINIMUM COMPLY WITH OSHA REQUIREMENTS. WHERE EXCAVATIONS ARE DEEPER THAN 20 FEET, THE CONTRACTOR SHALL HAVE A PROFESSIONAL CIVIL ENGINEER. REGISTERED IN THE STATE OF ARIZONA, DESIGN OPEN CUT SLOPES AND SHORING. THE CONTRACTOR SHALL SUBMIT THE DESIGN TO THE ENGINEER FOR APPROVAL PRIOR TO CONSTRUCTION.

PAVEMENT MARKING NOTES

1. ALL PAVEMENT MARINGS SHALL BE INSTALLED BY CITY OF PHOENIX FORCES. THE CITY OF PHOENIX INSPECTOR SHALL NOTIFY THE CITY OF PHOENIX TRAFFIC SERVICES FIELD INVESTIGATOR UNIT (602) 262-4684 A MINIMUM OF FIFTEEN (15) BUSINESS DAYS PRIOR TO HAVING TRAFFIC SIGN AND PAVEMENT MARKING WORK COMMENCE.

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LEGEND & NOTES


CITY OF PHOENIX, ARIZONA STREET TRANSPORTATION DEPARTMENT

> CANAL NORTH 7TH ST & MINNEZONA ST83140119

R: LNB DES: CJR CK: TMM DRAWING SERIES NO. ATE: 12/23 DATE: 12/23 DATE: 12/23 SCALE: NONE HORIZONTAL G-1.02

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Feb 02, 2024 - 1:20pm



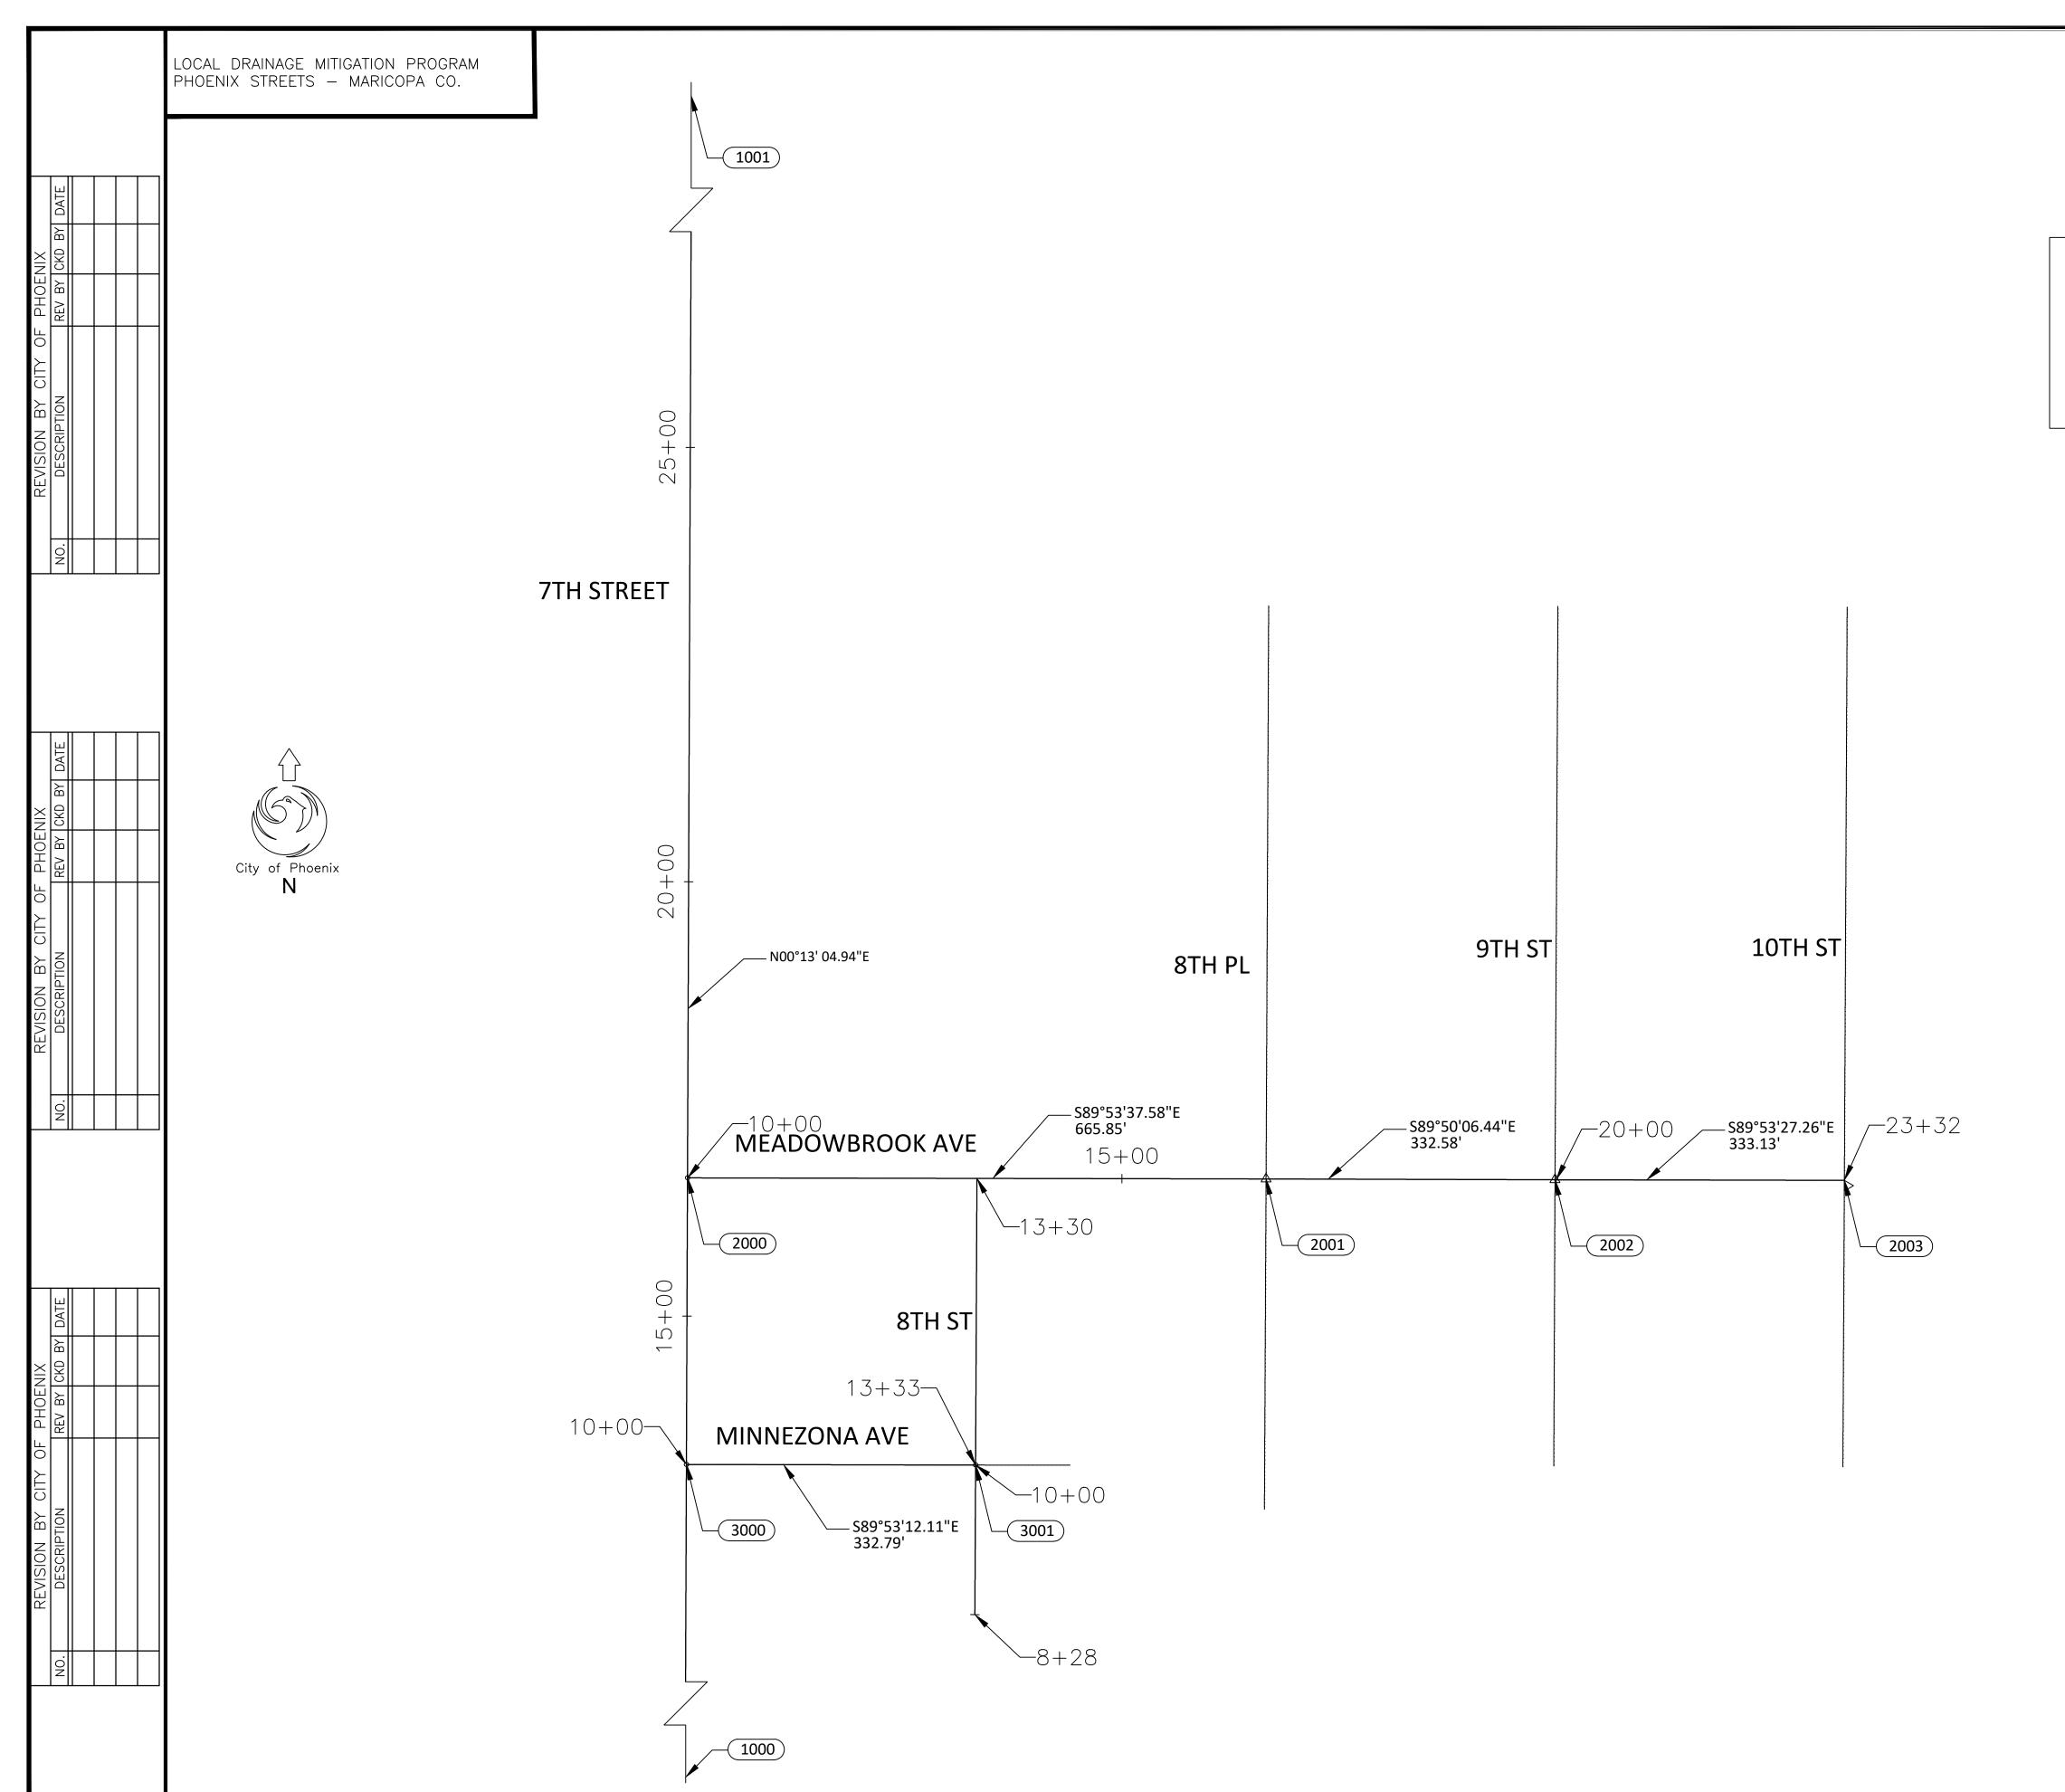

	F.H.W.A. REGION	STATE	PROJ. NO.	NO.	TOTAL	AS BUILT
	9	ARIZ	ST83140119	4	50	
	12/23 DATE:		AZ	ZTE	EC TYPS	501 N. 44TH ST SUITE 300 PHOENIX, AZ 85008 PH: 602-454-0402 www.Aztec.us
/	DRAWN: I	_NB	DESIGN: CJR		CHECK	ED: TMM

CONTROL NOTE:

THE HORIZONTAL DATUM IS NAD83(HARN) STATE PLANE, ARIZONA CENTRAL ZONE, ADJUSTED FROM GRID TO GROUND USING A COMBINED SCALE FACTOR OF 1.00016 WITH A SCALE POINT OF X=0.00, Y=0.00.

THE BASIS OF BEARING IS GRID NORTH NAD 83 STATE PLANE, ARIZONA CENTRAL ZONE ELEVATIONS ARE ON THE NGVD29 VERTICAL DATUM

POINT	STATION	NORTHING	EASTING
1000	10+00.00	910,348.1512	654,879.8767
1001	36+38.79	912,986.9235	654,889.9186
2000	10+00.00	911,007.3026	654,882.5222
2001	16+65.85	911,006.0681	655,548.3727
2002	19+98.43	911,005.1110	655,880.9511
2003	23+31.56	911,004.4767	656,214.0832
3000	10+00.00	910,677.3926	654,881.2283
3001	13+32.79	910,676.7345	655,214.0198



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GEOMETRIC CONTROL

CITY OF PHOENIX, ARIZONA STREET TRANSPORTATION DEPARTMENT

CANAL NORTH 7TH ST & MINNEZONA ST83140119

DR: LNB | DES: CJR | CK: TMM | DRAWING SERIES NO. DATE: 12/23 | DATE: 12/23 | DATE: 12/23 | DRAWING SERIES NO. SCALE: 1"=100" | HORIZONTAL | G-2.01

LOCAL DRAINAGE MITIGATION PROGRAM PHOENIX STREETS — MARICOPA CO.			QUANT	ITY SL	JMMAR	
THOUNA STREETS - MARICOLA CO.	ITEM No. DESCRIPTION	UNIT		NUMBERS		TOTAL QT
	M###### (DESCRIPTION) M3001001 SAWCUT, REMOVE, & REPLACE AC PAVEMENT PER MAG DTL 200-1, TYPE A	(UNIT)	SD-1.01 28	SD-1.02 426	SD-1.03 0	(TOTAL QTY)
	M3001002 SAWCUT & REMOVE EXISTING CURB AND GUTTER	LF	155	510	17	682
	M3010001 SUBGRADE PREPARATION	SY	0	561	0	561
	M3360224 SAWCUT, REMOVE, AND REPLACE AC PAVEMENT, COP STD DET P1200	SY	425	521	163	1109
	M3362100 MICROSEAL COAT M3400240 CONCRETE VALLEY GUTTER & APRON, MAG STD DTL 240	SY SF	1591 0	0 1213	0	1591 1213
	M3400400 CONCRETE SIDEWALK, COP STD DTL P1230	SF	305	800	69	1174
	M3400485 CONCRETE CURB RAMP, STD DETAILS P-1237 , R = 20'	SF	219	925	0	1144
	M3400486 CONCRETE CURB RAMP, STD DETAILS P-1240-1, R = 20'	SF	0	493	0	493
	M3400487 CONCRETE CURB RAMP, STD DETAILS P-1241-1, MIDBLOCK M3400555 CONCRETE DRIVEWAY ENTRANCE, STD. DETAIL P-1255-1	SF SF	0 354	309 434	0	309 788
	M3402201 CONCRETE CURB AND GUTTER, MAG STD DTL 220, TYPE A H=6"	LF	63	173	7	243
	M3402203 CONCRETE ROLL CURB AND GUTTER, MAG STD DETAIL 220, TYPE "C"	LF	0	40	0	40
	M3402243 ROLL CURB AND GUTTER TRANSITION MAG STD DETAIL 221	LF	0	21	0	21
	M3500025 REMOVE CONCRETE SIDEWALK M4004505 PAVEMENT MARKING (YELLOW PAINT) (15 MILS) 4"	SF LF	968 705	2877 0	69 0	3914 705
- 	M4004506 PAVEMENT MARKING (WHITE PAINT) (15 MILS) 4"	LF	940	0	0	940
⅃ ┃	M5051524 CONCRETE CATCH BASIN, TYPE M, COP STD DTL P1569-1	EA	4	5	1	10
	M6012000 WATERLINE RELOCATION PER C.O.P STANDARD P1370	EA	2	5	0	7
	M6012100 WATERLINE REPLACEMENT WITH DUTILE IRON PIPE M6101805 WATERLINE SERVICE CONNECTION (MAIN TO METER)	EA EA	0	3	0	3
	RELOCATE FIRE HYDRANT, DET, P1360 AND P1362 AND P1359					
	P1361, AND MAG SPECIFICATION 610 AND COP SUPPLEMENTAL 756	EA	1	1	0	2
	M6108015 RELOCATE WATER VALVE M6180015 15" CLASS V RGRCP STORM SEWER PIPE	EA LF	2 49	37	8	94
	M6180018 18" CLASS V RGRCP STORM SEWER PIPE	LF	262	56	65	383
	M6180024 24" CLASS V RGRCP STORM SEWER PIPE	LF	0	611	108	719
	M6180119 19"x30" ELLIPTICAL STORM SEWER PIPE, CLASS V RGRCP	LF	76	0	0	76
	M6180520 STORM SEWER LATERAL CONNECTION PER DETAIL P1577 M6250005 STORM SEWER MANHOLE, MAG STD DETAIL 522, COP DTL P1520	EA EA	3	0	1	8
	M6307102 6" x 6" x 6" TEE, FURNISH & INSTALL	EA	0	1	0	1
	KEY MAP City of Phoenix N SD-1.01 SD	-1.02 —				



F.H.W.A. REGION STATE PROJ. NO. NO. TOTAL AS BUILT

9 ARIZ ST83140119 5 50

12/23
DATE: DRAWN: LNB DESIGN: CJR CHECKED: TMM

"PER CITY OF PHOENIX CITY CODE CHAPTER 2, SECTION 2-28 THESE PLANS ARE FOR OFFICIAL USE ONLY & MAY NOT BE SHARED WITH OTHERS EXCEPT AS REQUIRED TO FULFILL THE OBLIGATIONS OF THE CONTRACTOR'S CONTRACT WITH THE CITY OF PHOENIX."

QUANTITY SUMMARY

CITY OF PHOENIX, ARIZONA STREET TRANSPORTATION DEPARTMENT


CANAL NORTH 7TH ST AND MINNEZONA AVE ST83140119


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DATE: 12/23 DATE: 12/23 DATE: 12/23


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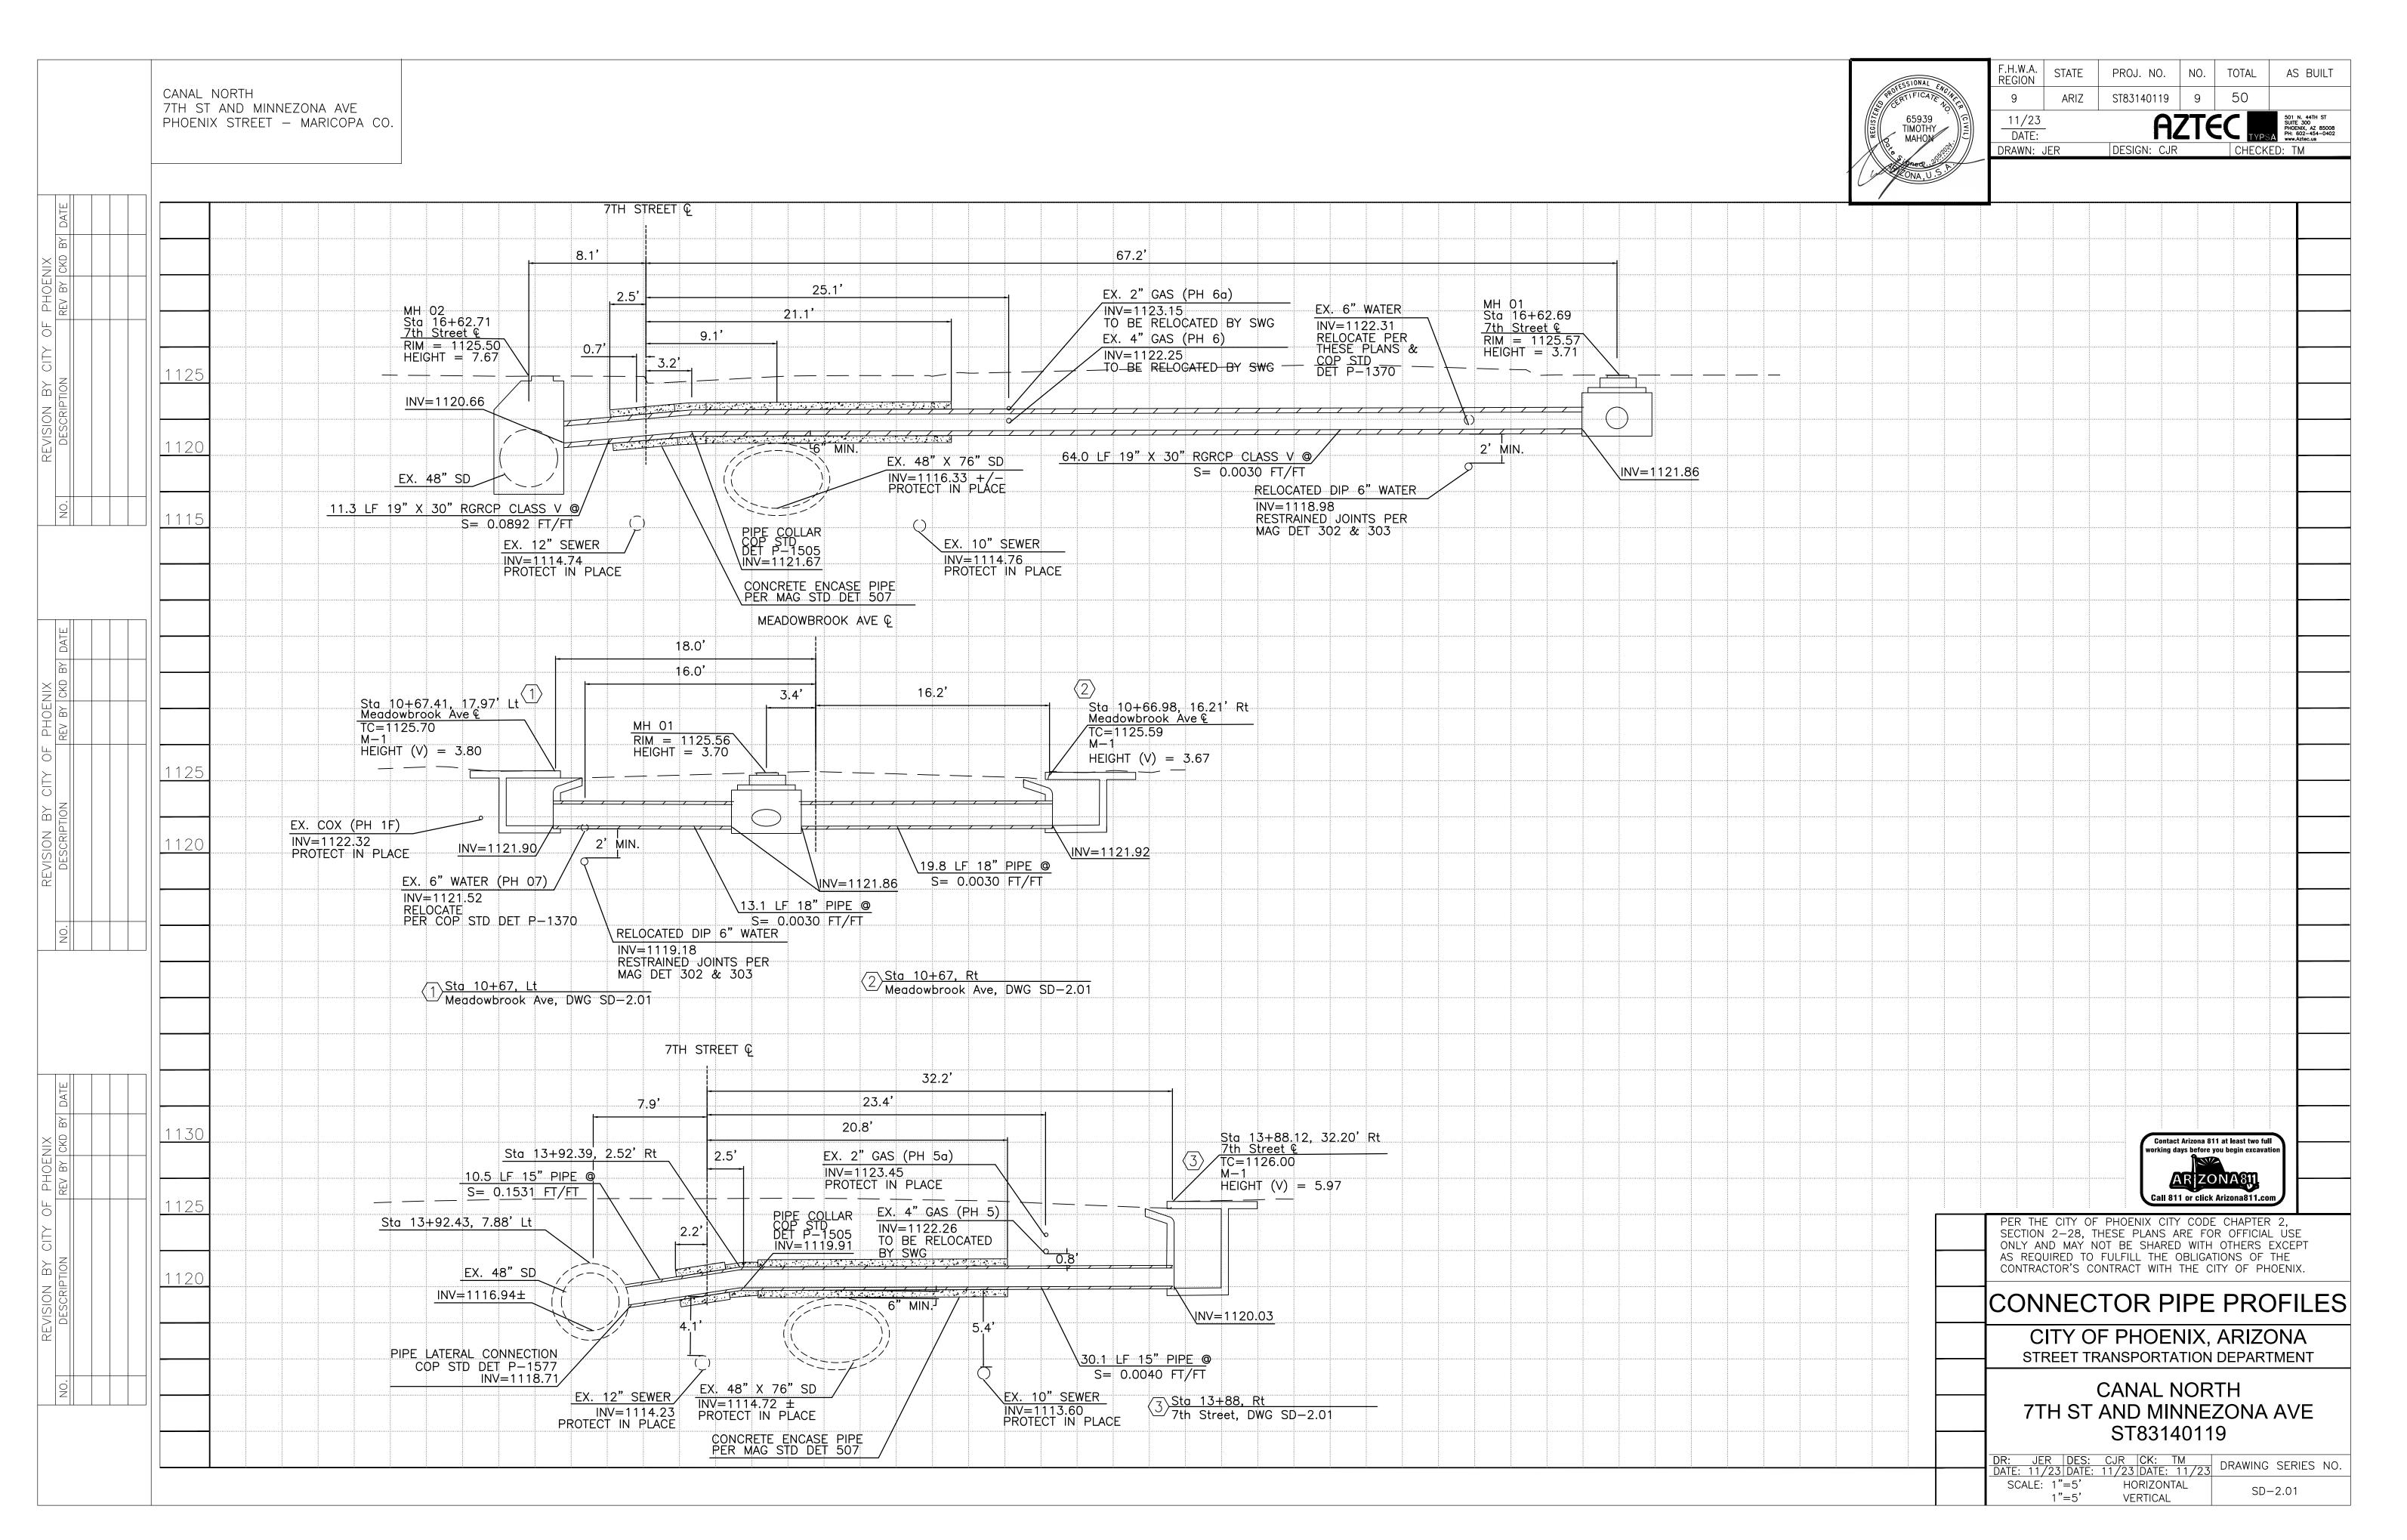
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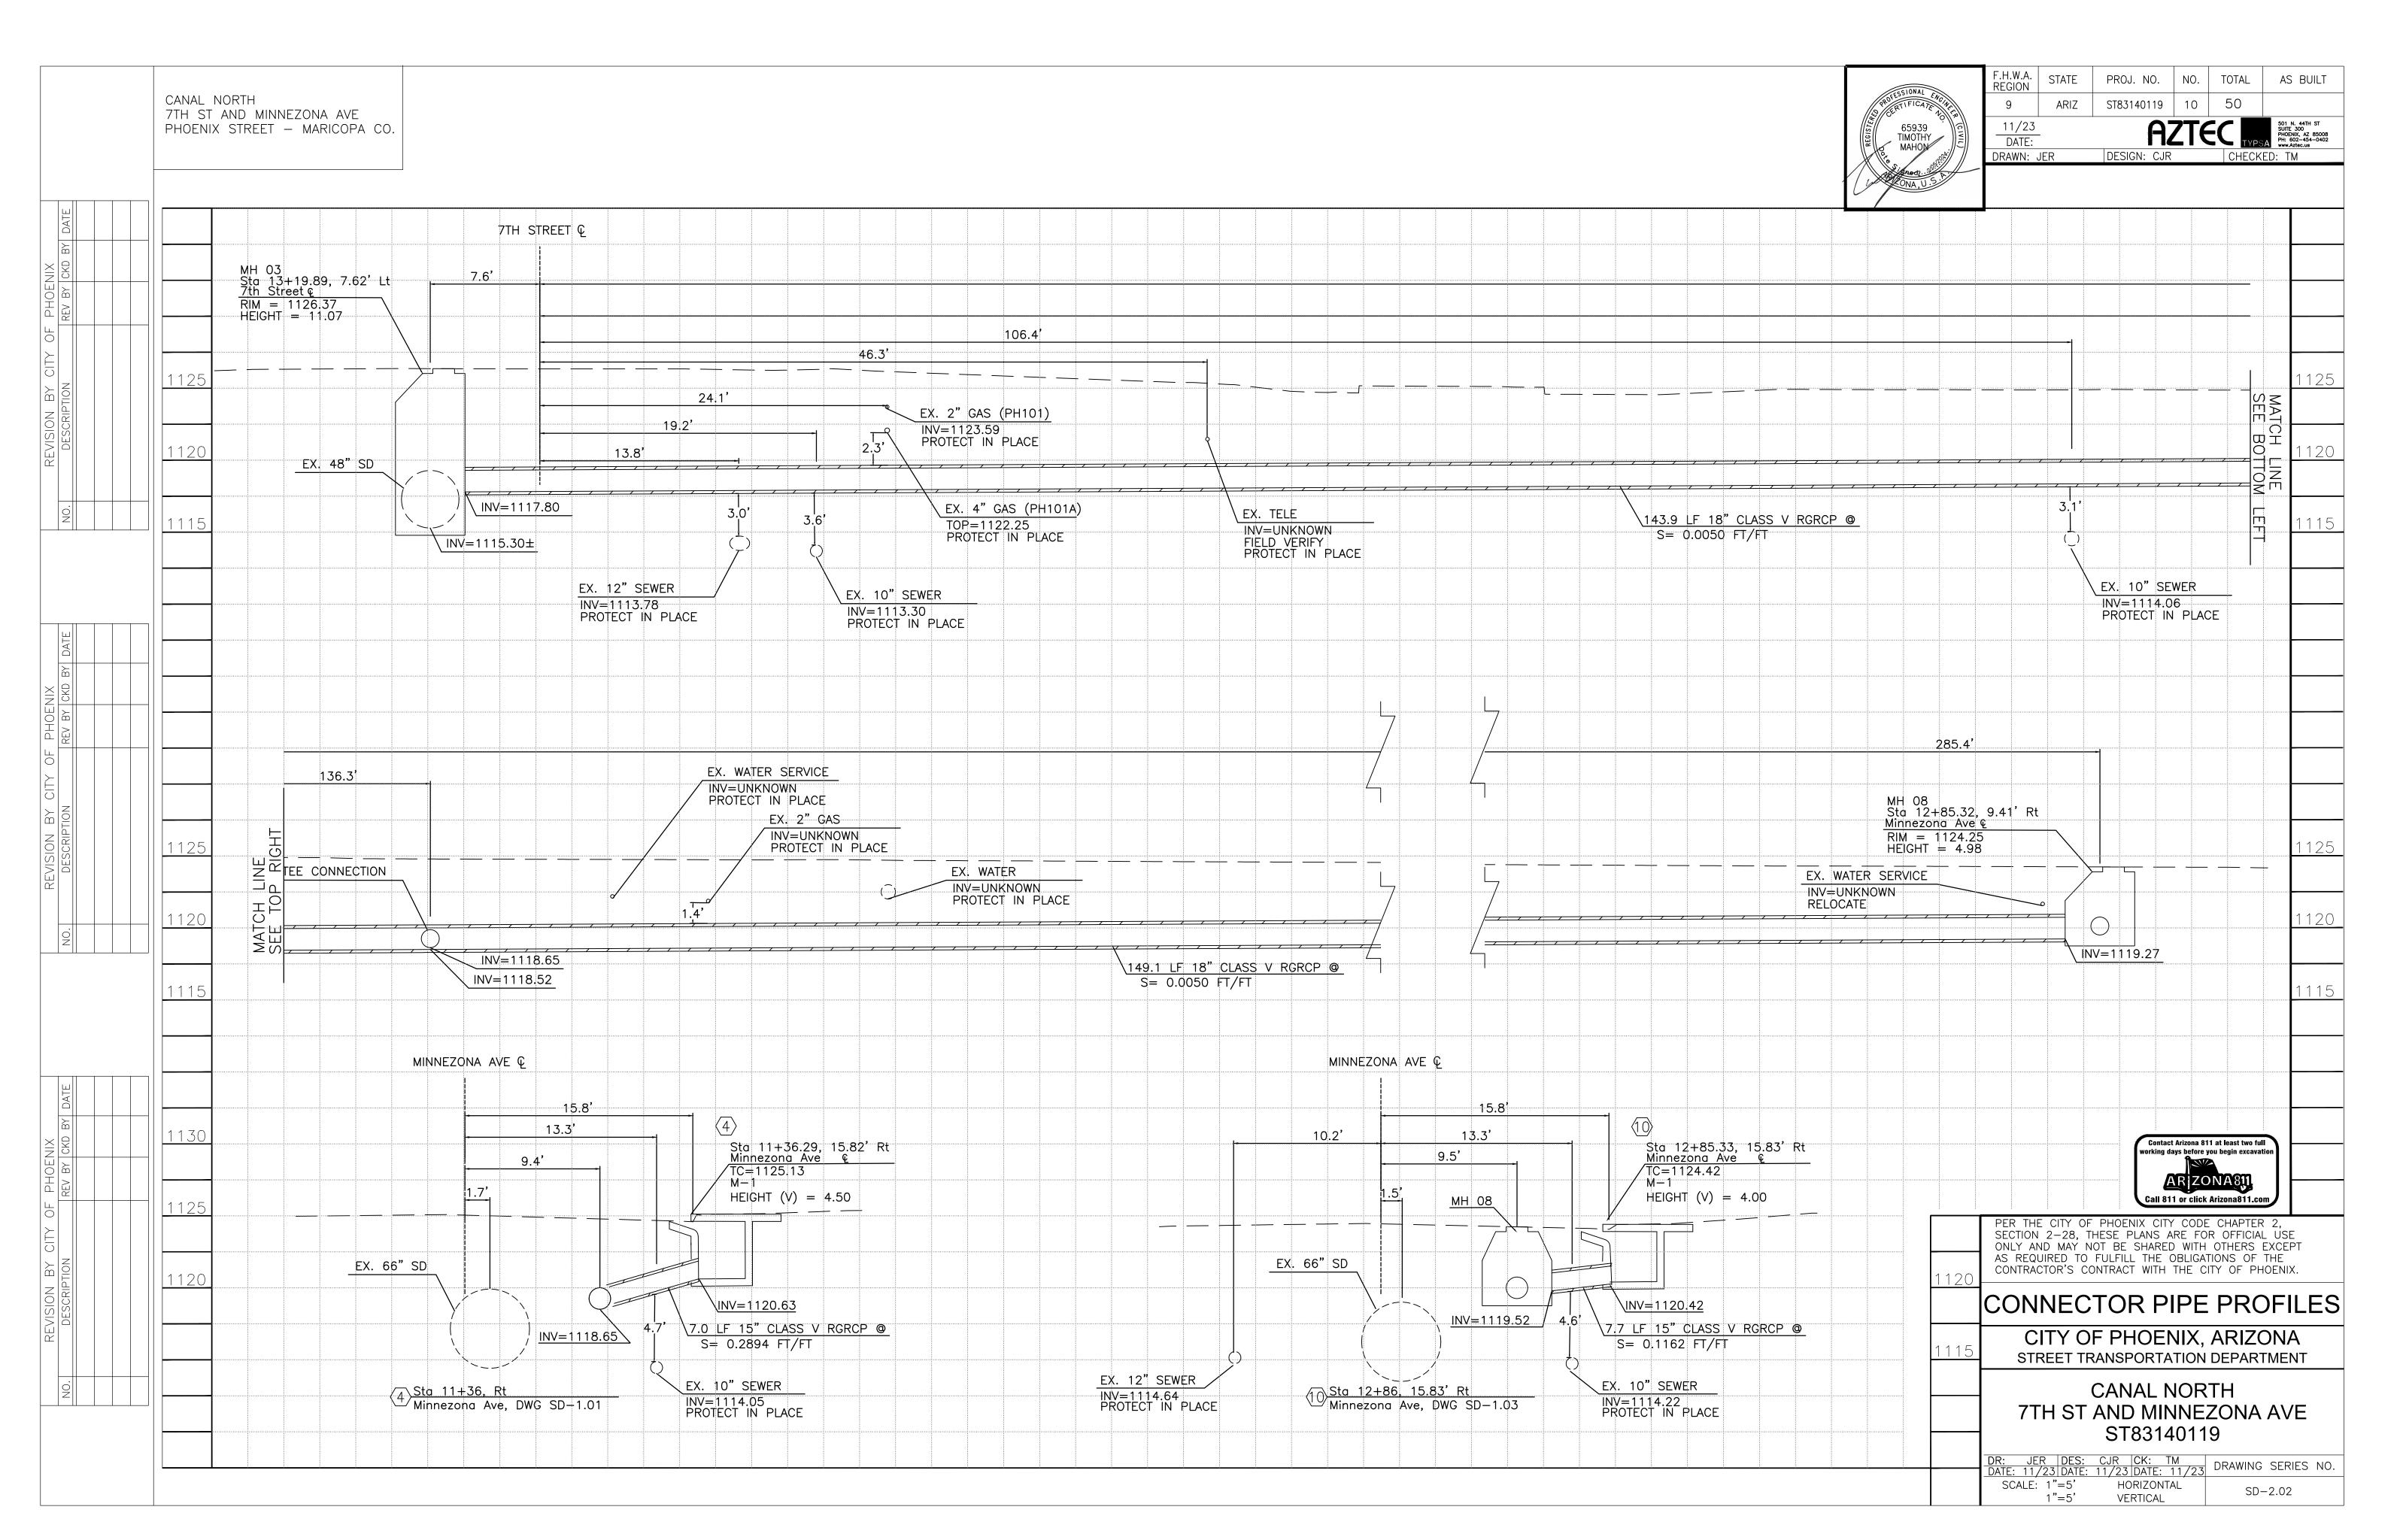
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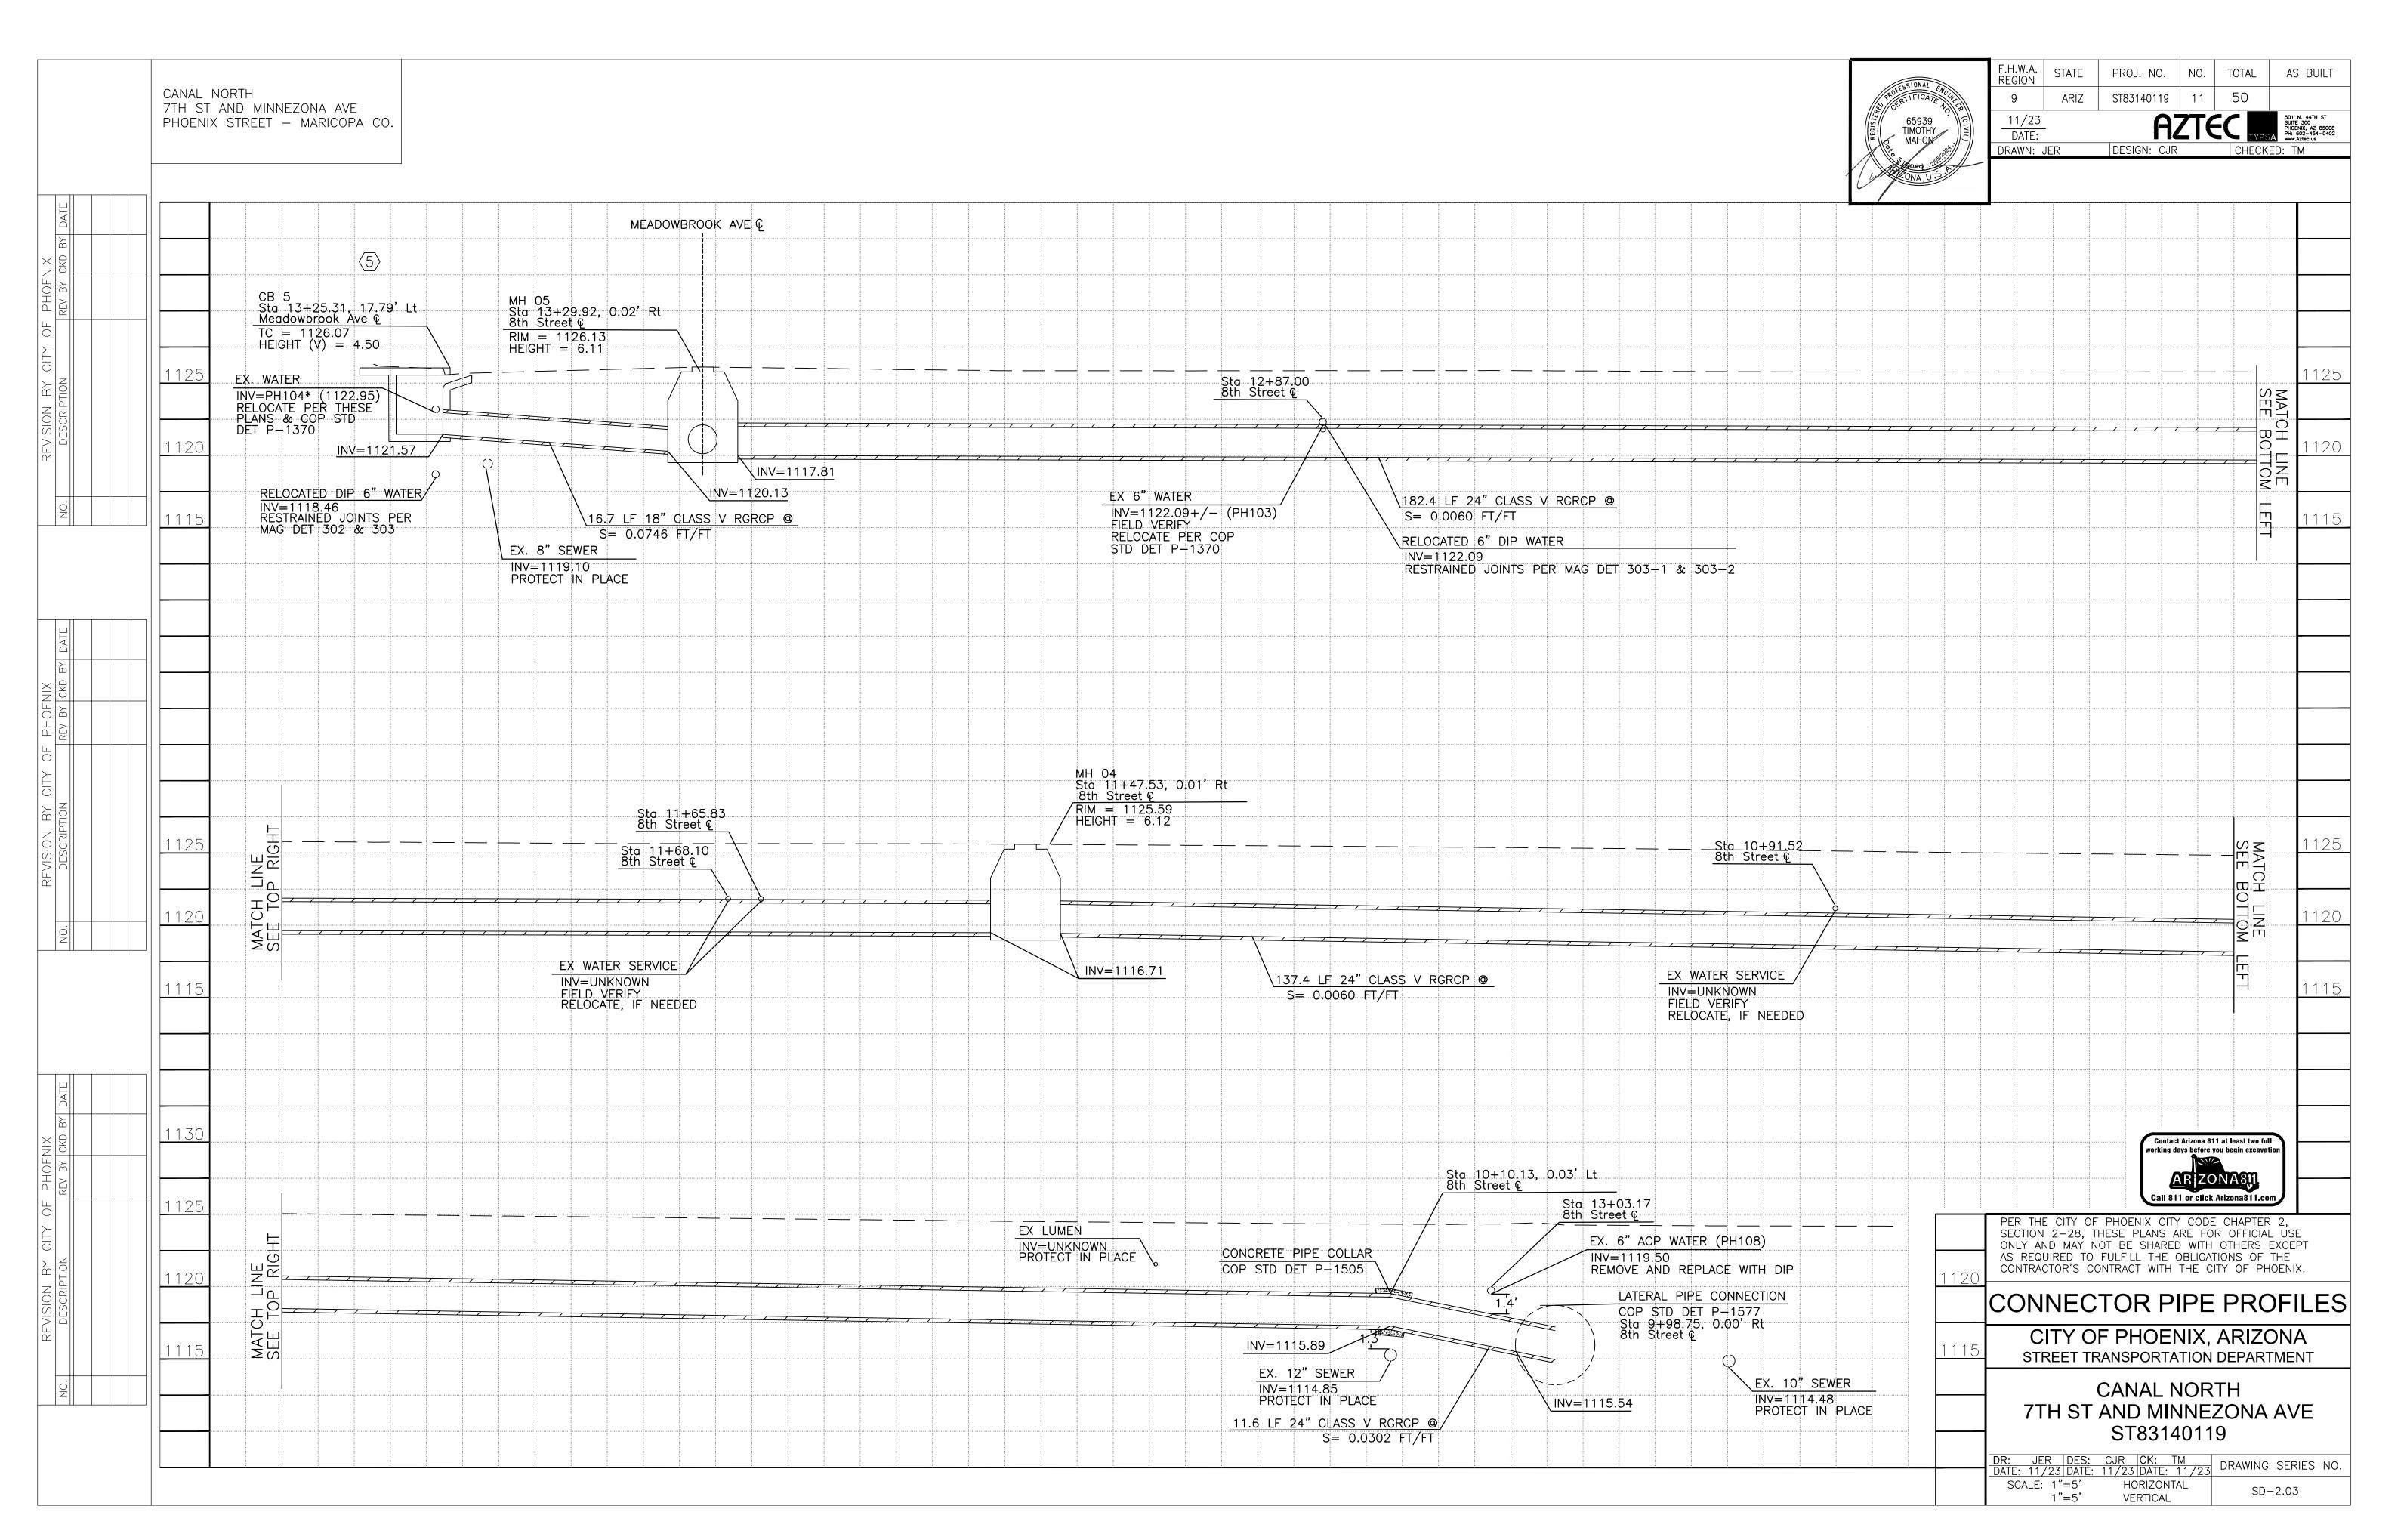







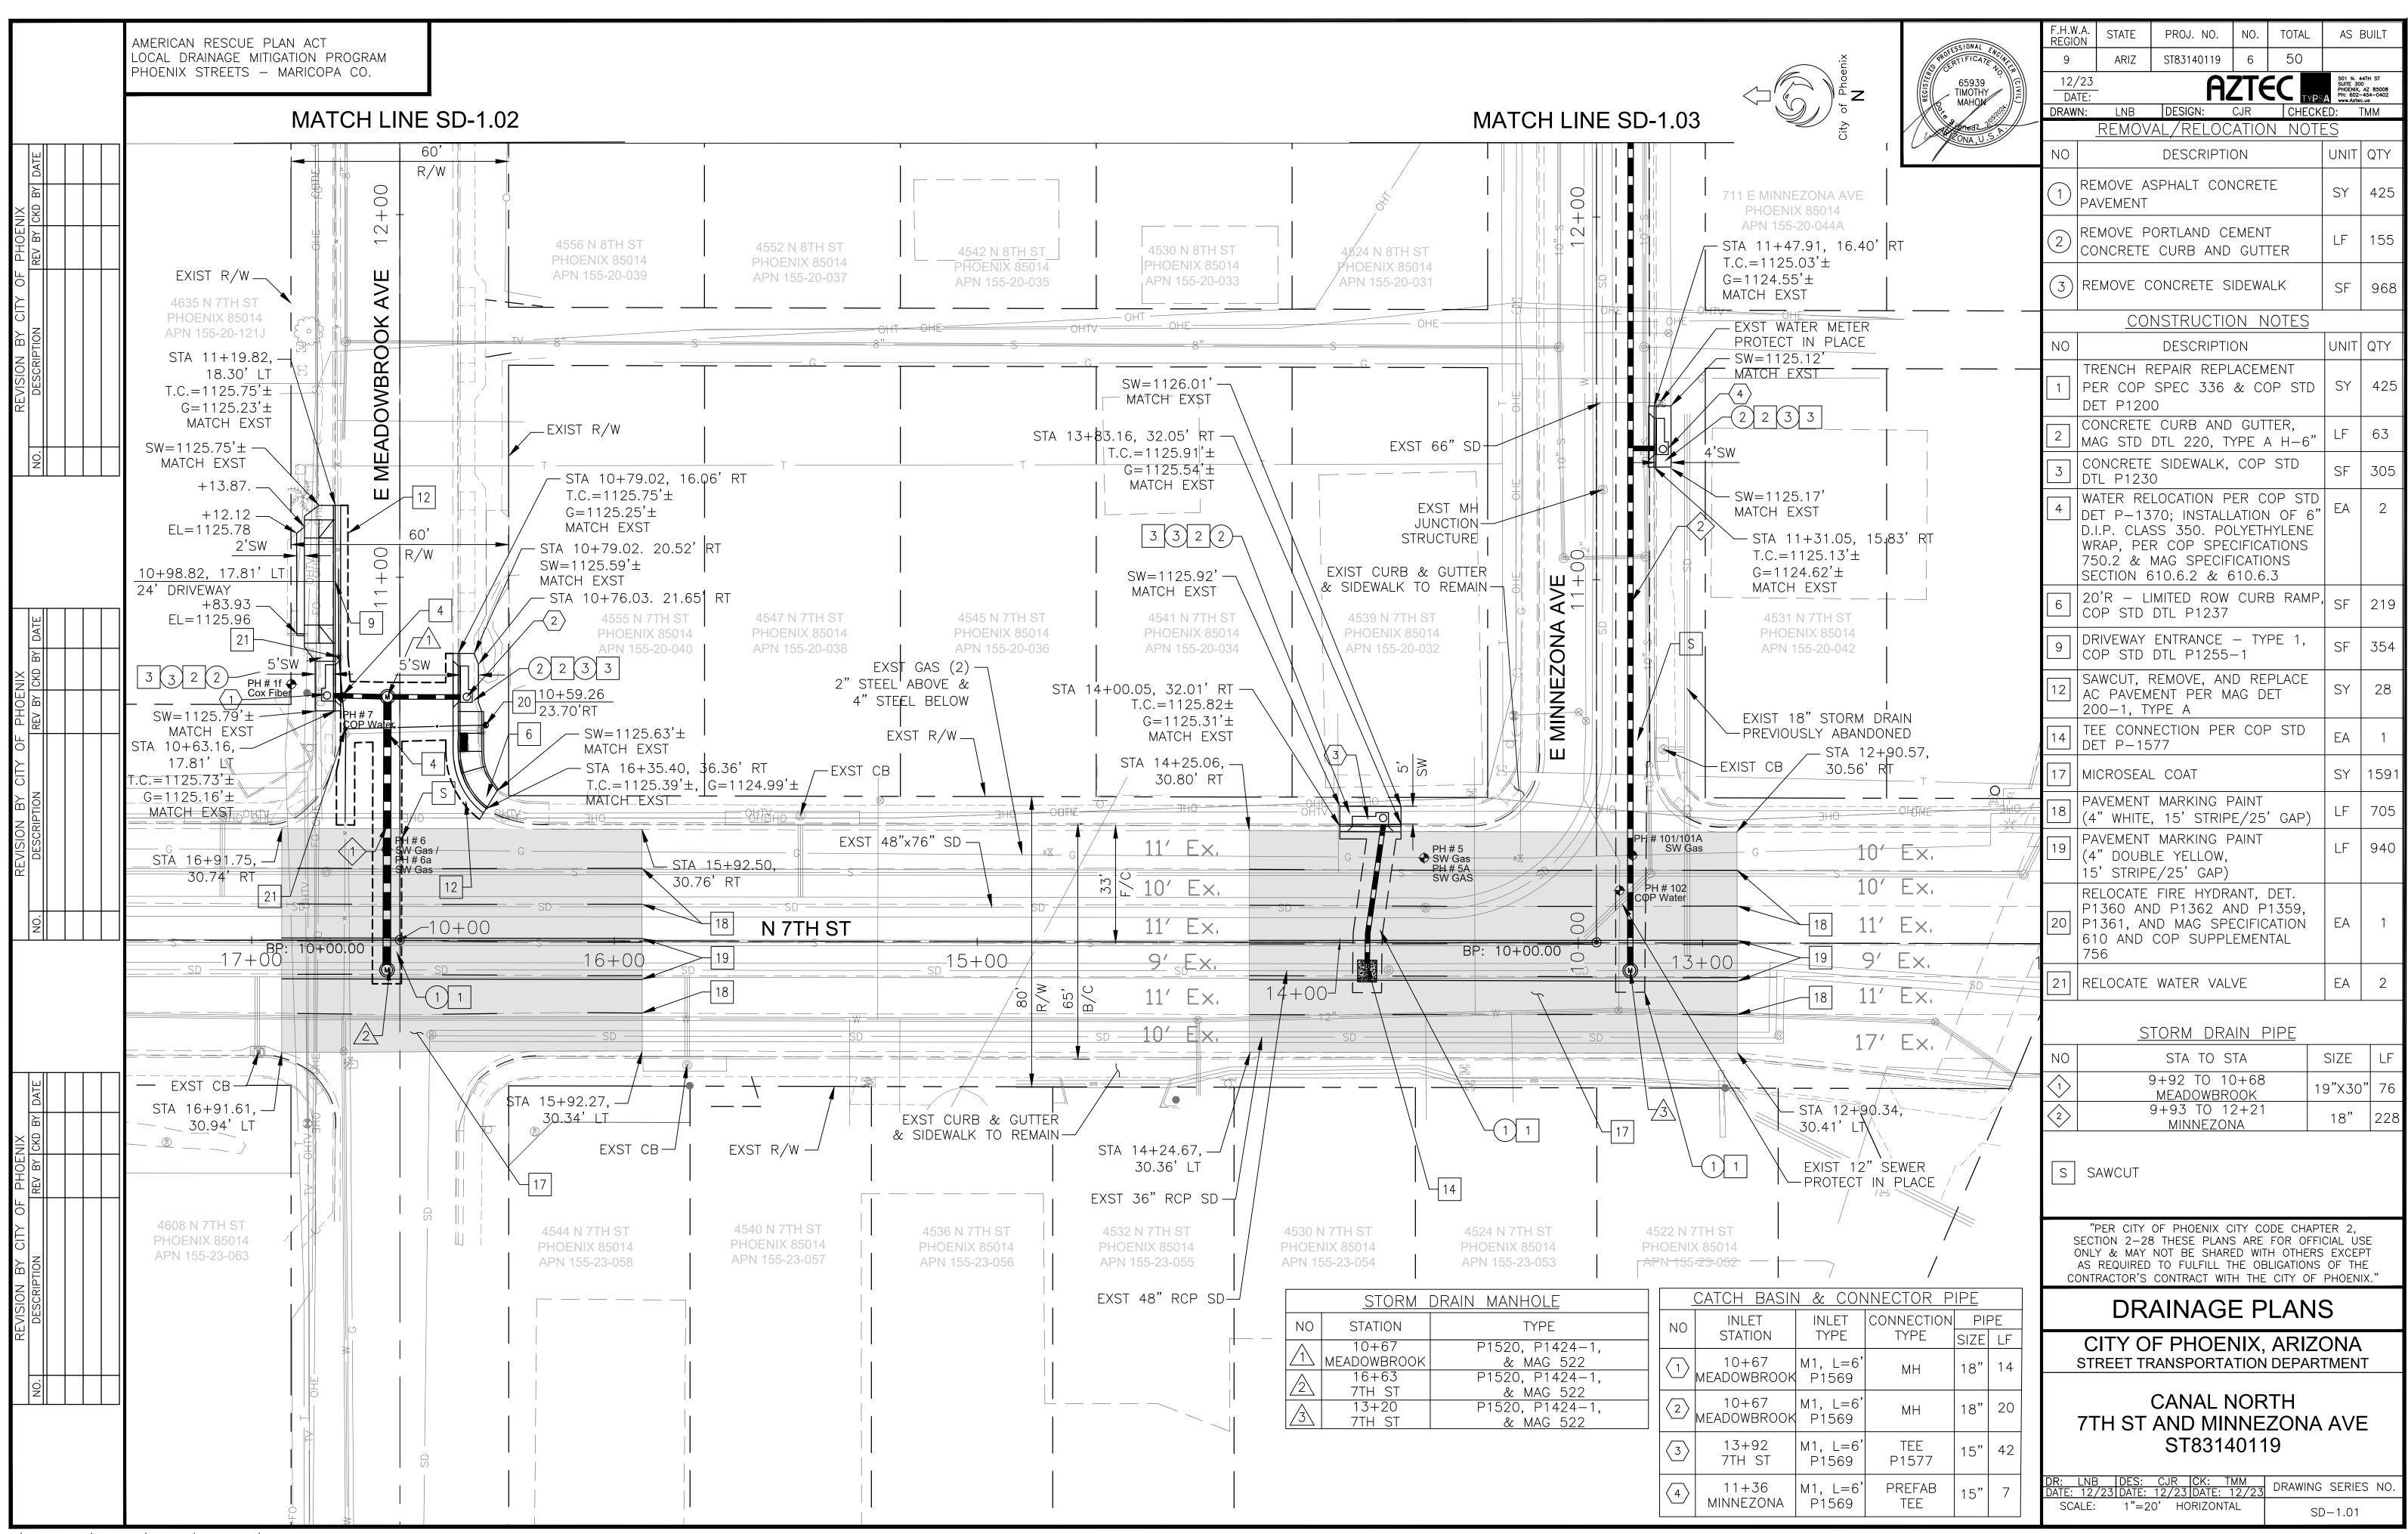

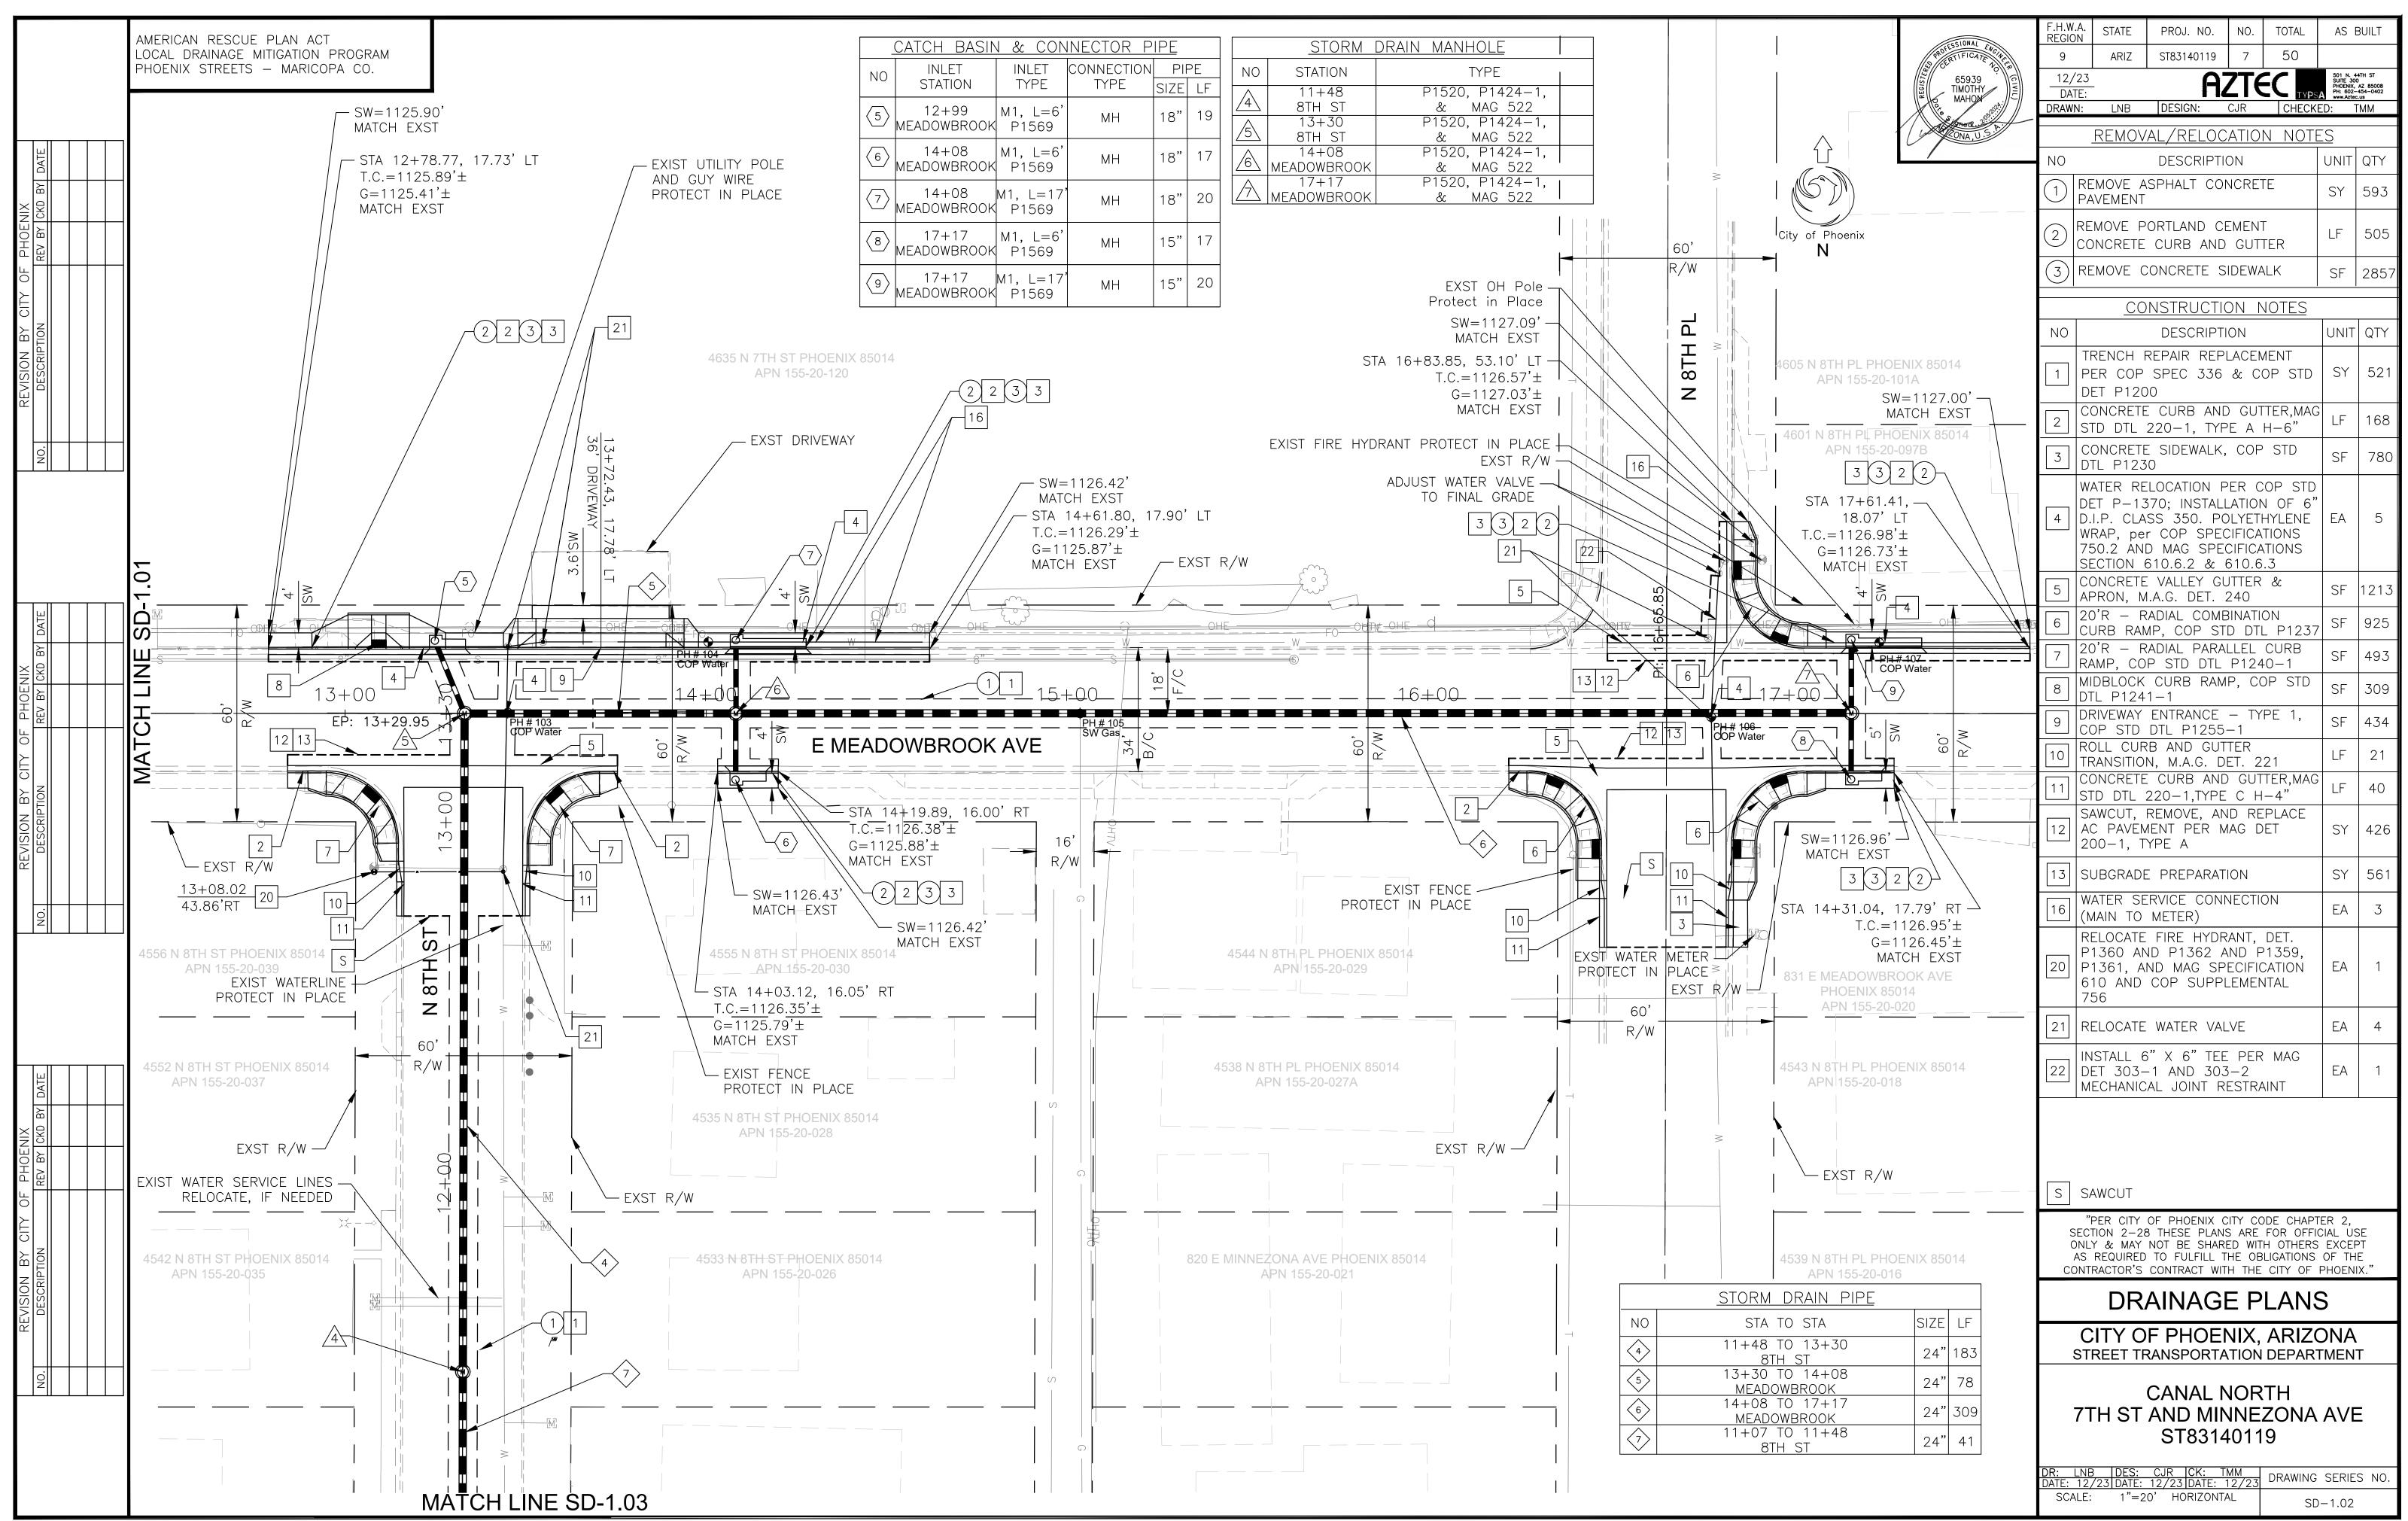

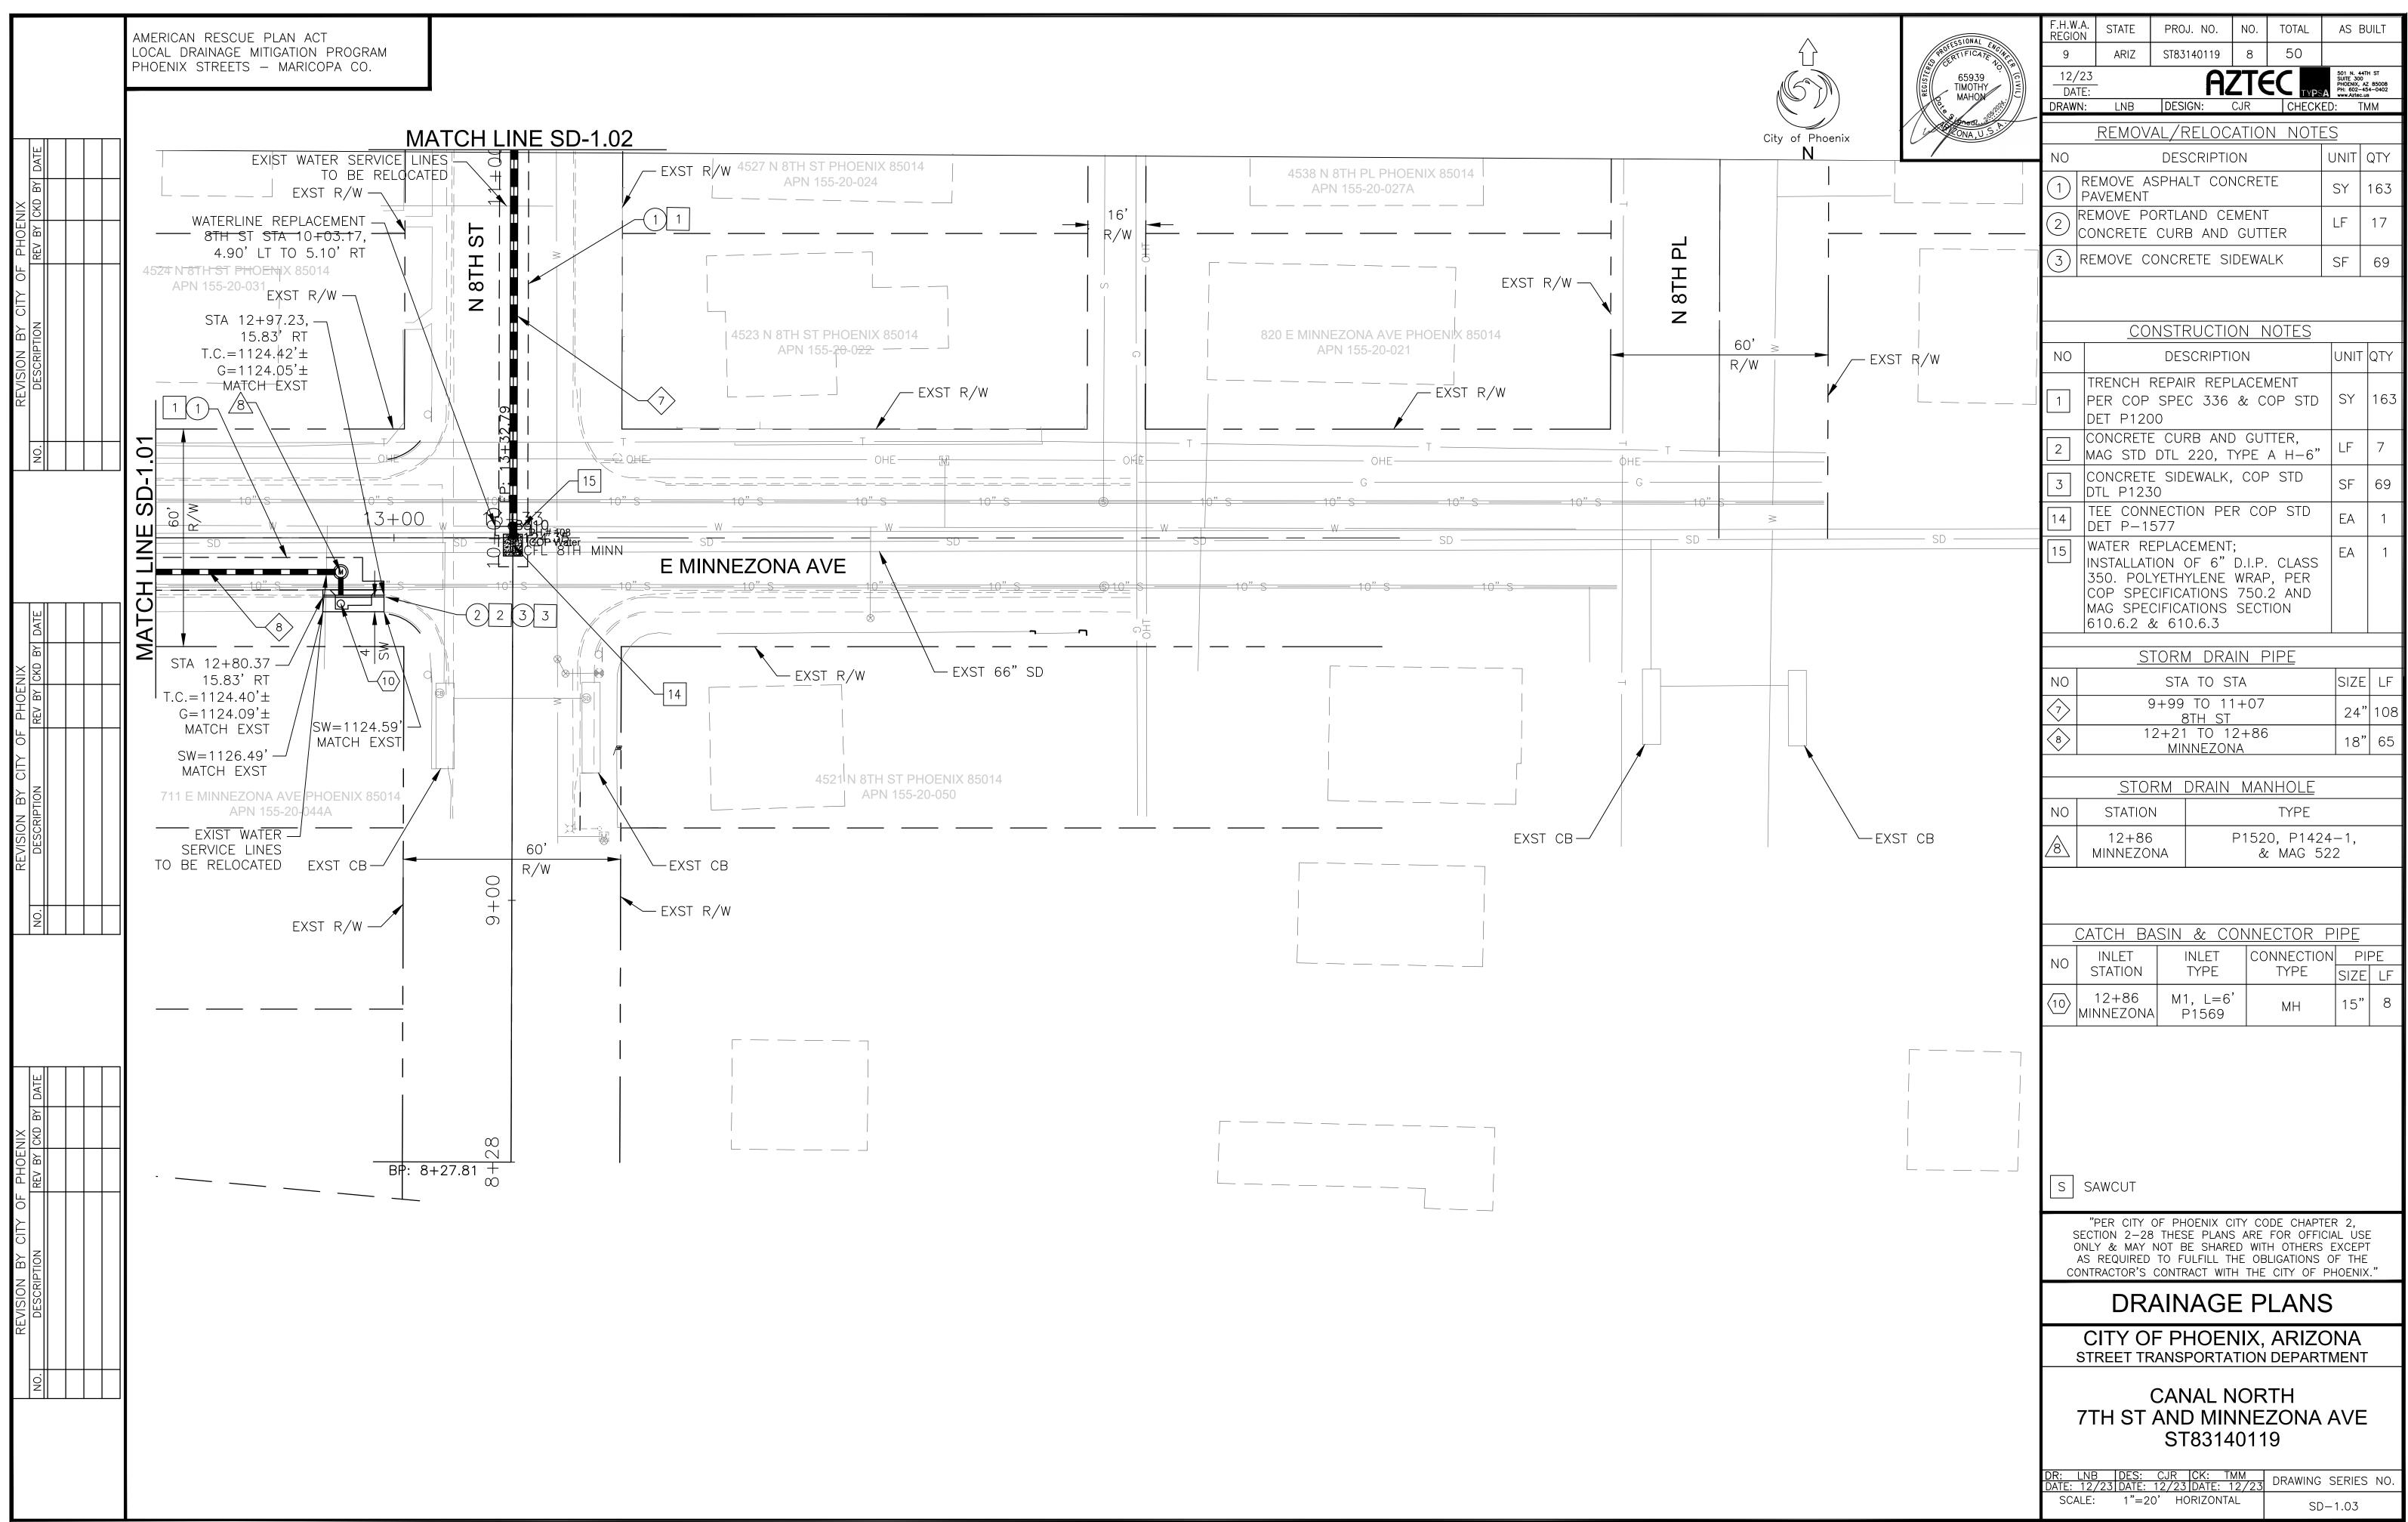


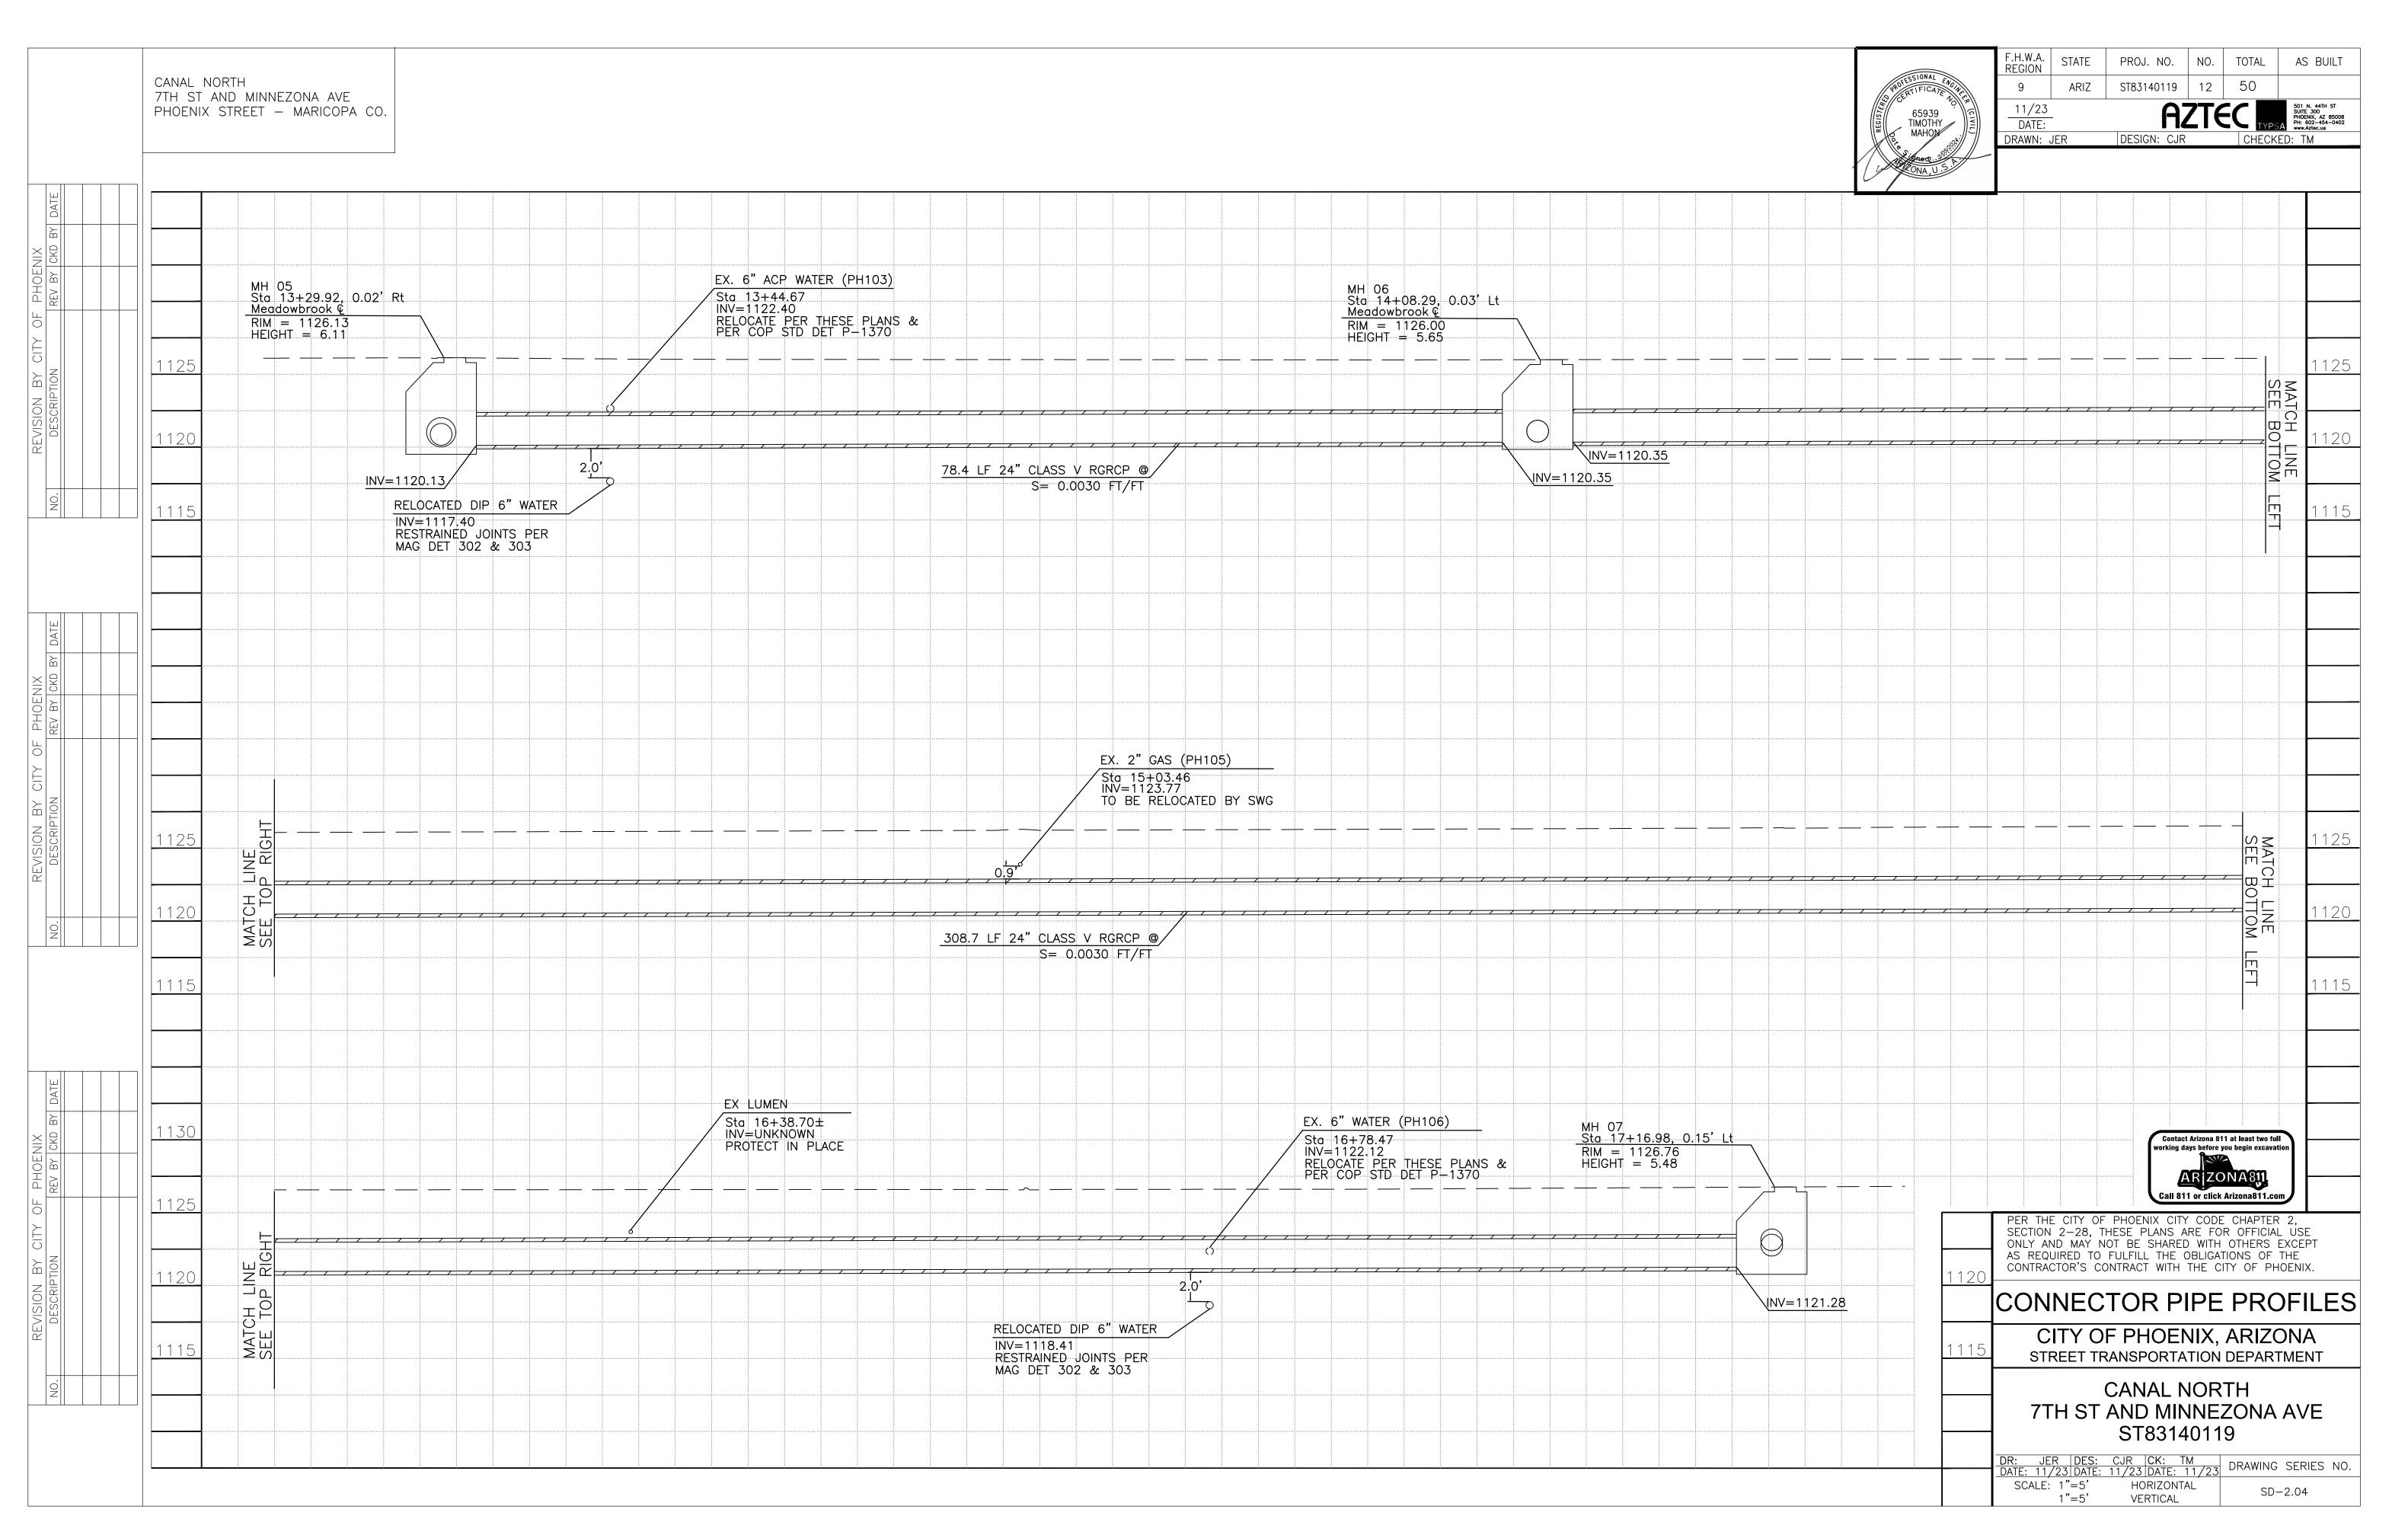


F.H.W.A. REGION STATE PROJ. NO. NO. TOTAL AS BUILT CANAL NORTH ARIZ ST83140119 13 50 7TH ST AND MINNEZONA AVE 11/23 DATE: PHOENIX STREET - MARICOPA CO. DRAWN: JER DESIGN: CJR MEADOWBROOK AVE Q 16.2 19.0' 18.0' 1130 Sta 14+08.13, 16.19' Rt /TC=1126.36 <u>Sta 14+08.24, 17.95' Lt</u> TC=1126.24 M−1 MH 06 RIM = 1126.00 HEIGHT = 5.65 14.9 M-1HEIGHT(V) = 4.86HEIGHT (V) = 4.60EX. 6" ACP WATER (PH104) INV=1123.14
RELOCATE
PER COP STD DET P-1370 1120 INV=1121.64 $\NV = 1121.50$ $\NV = 1120.35$ RELOCATED DIP 6" WATER EX. 8" SEWER \16.6 LF 18" CLASS V RGRCP @ \INV=1120.35 INV=1118.53 RESTRAINED JOINTS PER MAG DET 302 & 303 INV=1119.37
PROTECT IN PLACE 19.8 LF 18" CLASS V RGRCP @ S= 0.0694 FT/FT S= 0.0654 FT/FT 6 Sta 14+08, Rt Minnezona Ave, DWG SD-1.02 6 Sta 14+08, Lt Minnezona Ave, DWG SD-1.02 MEADOWBROOK AVE Q 16.1 19.7 (9) 1130 18.1 Sta 17+16.93, 16.09' Rt /TC=1126.90 M-1 Sta 17+16.97, 18.12' Lt TC=1126.74 M-1 MH 07 RIM = 1126.76 HEIGHT = 5.48 HEIGHT (V) = 4.79EX. 6" ACP WATER (PH107) HEIGHT (V) = 4.26 HNV=1122.75

RELOCATE

PER COP STD DET P=1370/ \INV=1122.11 $\sqrt{INV} = 1122.03$ $\NV = 1122.48$ $\NN = 1122.38$ \16.4 LF 18" CLASS V RGRCP @ RELOCATED DIP 6" WATER S= 0.0050 FT/FT 19.3 LF 18" CLASS V RGRCP @ INV=1119.46 RESTRAINED JOINTS PER MAG DET 302 & 303 S = 0.0050 FT/FTSta 17+17, Rt
Minnezona Ave, DWG SD-1.02 Sta 17+17, Lt Minnezona Ave, DWG SD-1.02 Contact Arizona 811 at least two ful AR ZONA811 Call 811 or click Arizona811.com PER THE CITY OF PHOENIX CITY CODE CHAPTER 2, SECTION 2-28, THESE PLANS ARE FOR OFFICIAL USE ONLY AND MAY NOT BE SHARED WITH OTHERS EXCEPT AS REQUIRED TO FULFILL THE OBLIGATIONS OF THE CONTRACTOR'S CONTRACT WITH THE CITY OF PHOENIX. CONNECTOR PIPE PROFILES CITY OF PHOENIX, ARIZONA STREET TRANSPORTATION DEPARTMENT CANAL NORTH 7TH ST AND MINNEZONA AVE ST83140119 CJR CK: TM 11/23 DATE: 11/23 DRAWING SERIES NO. SCALE: 1"=5' HORIZONTAL SD-2.05 1"=5' VERTICAL

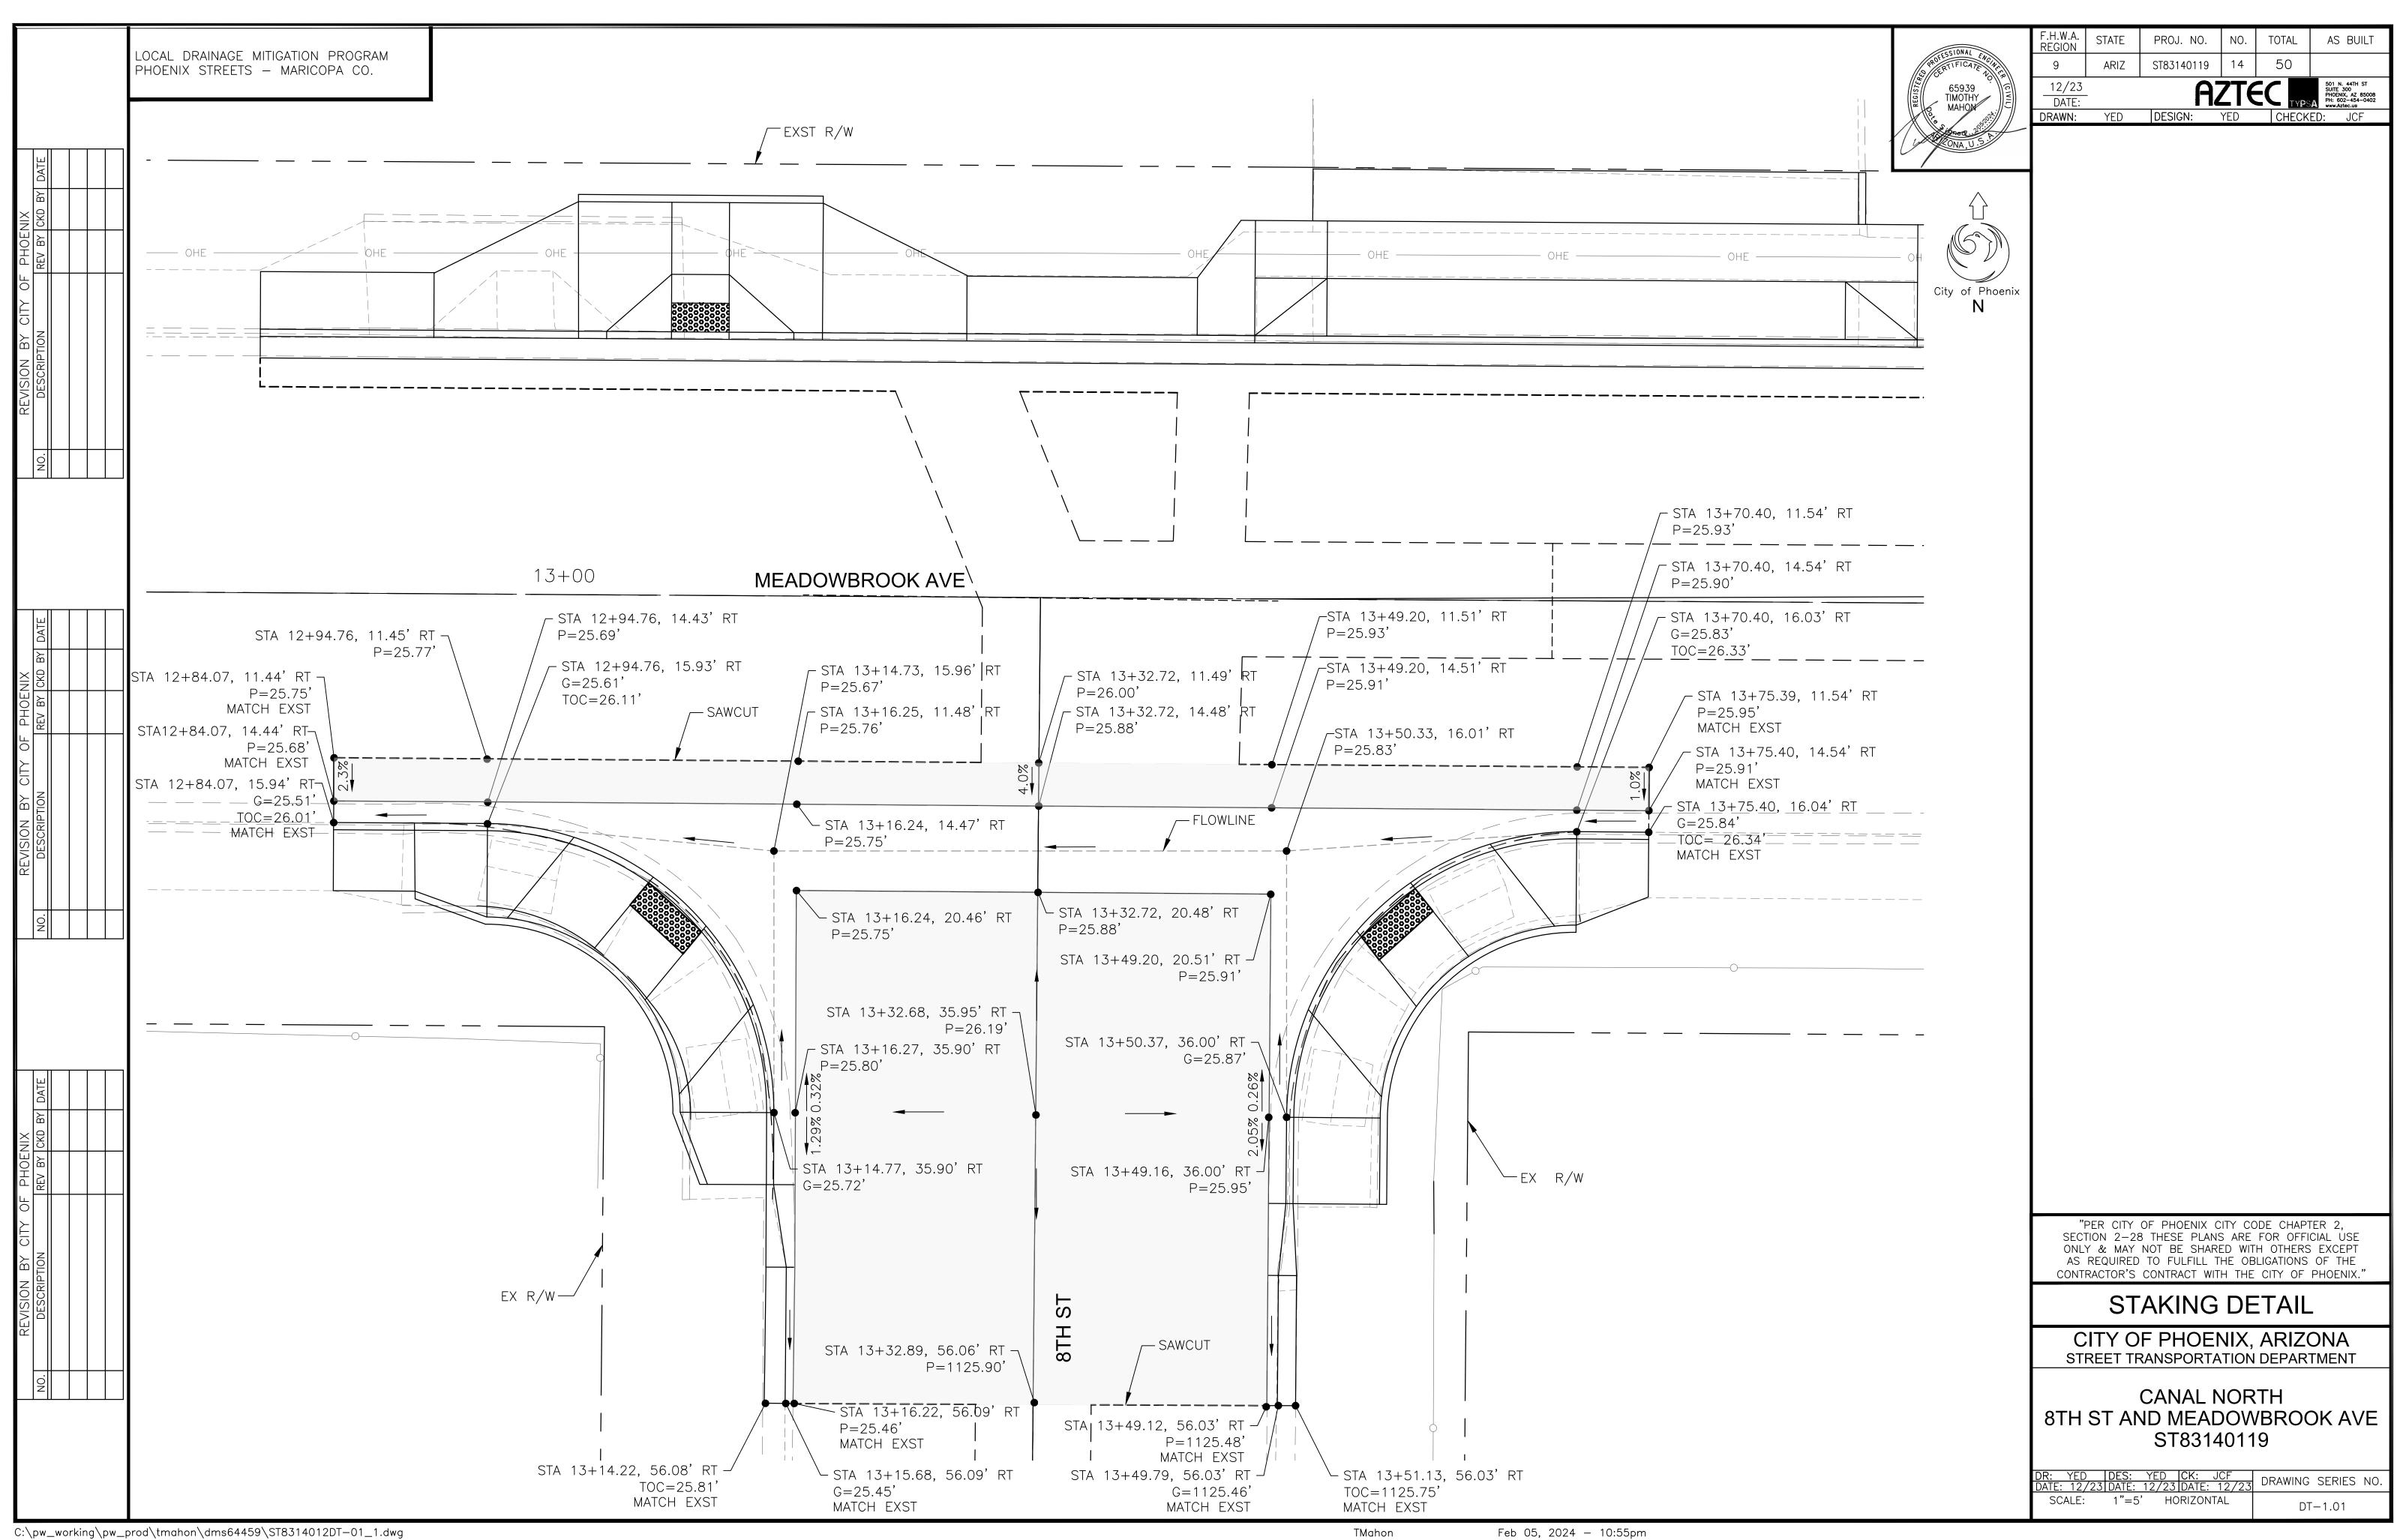


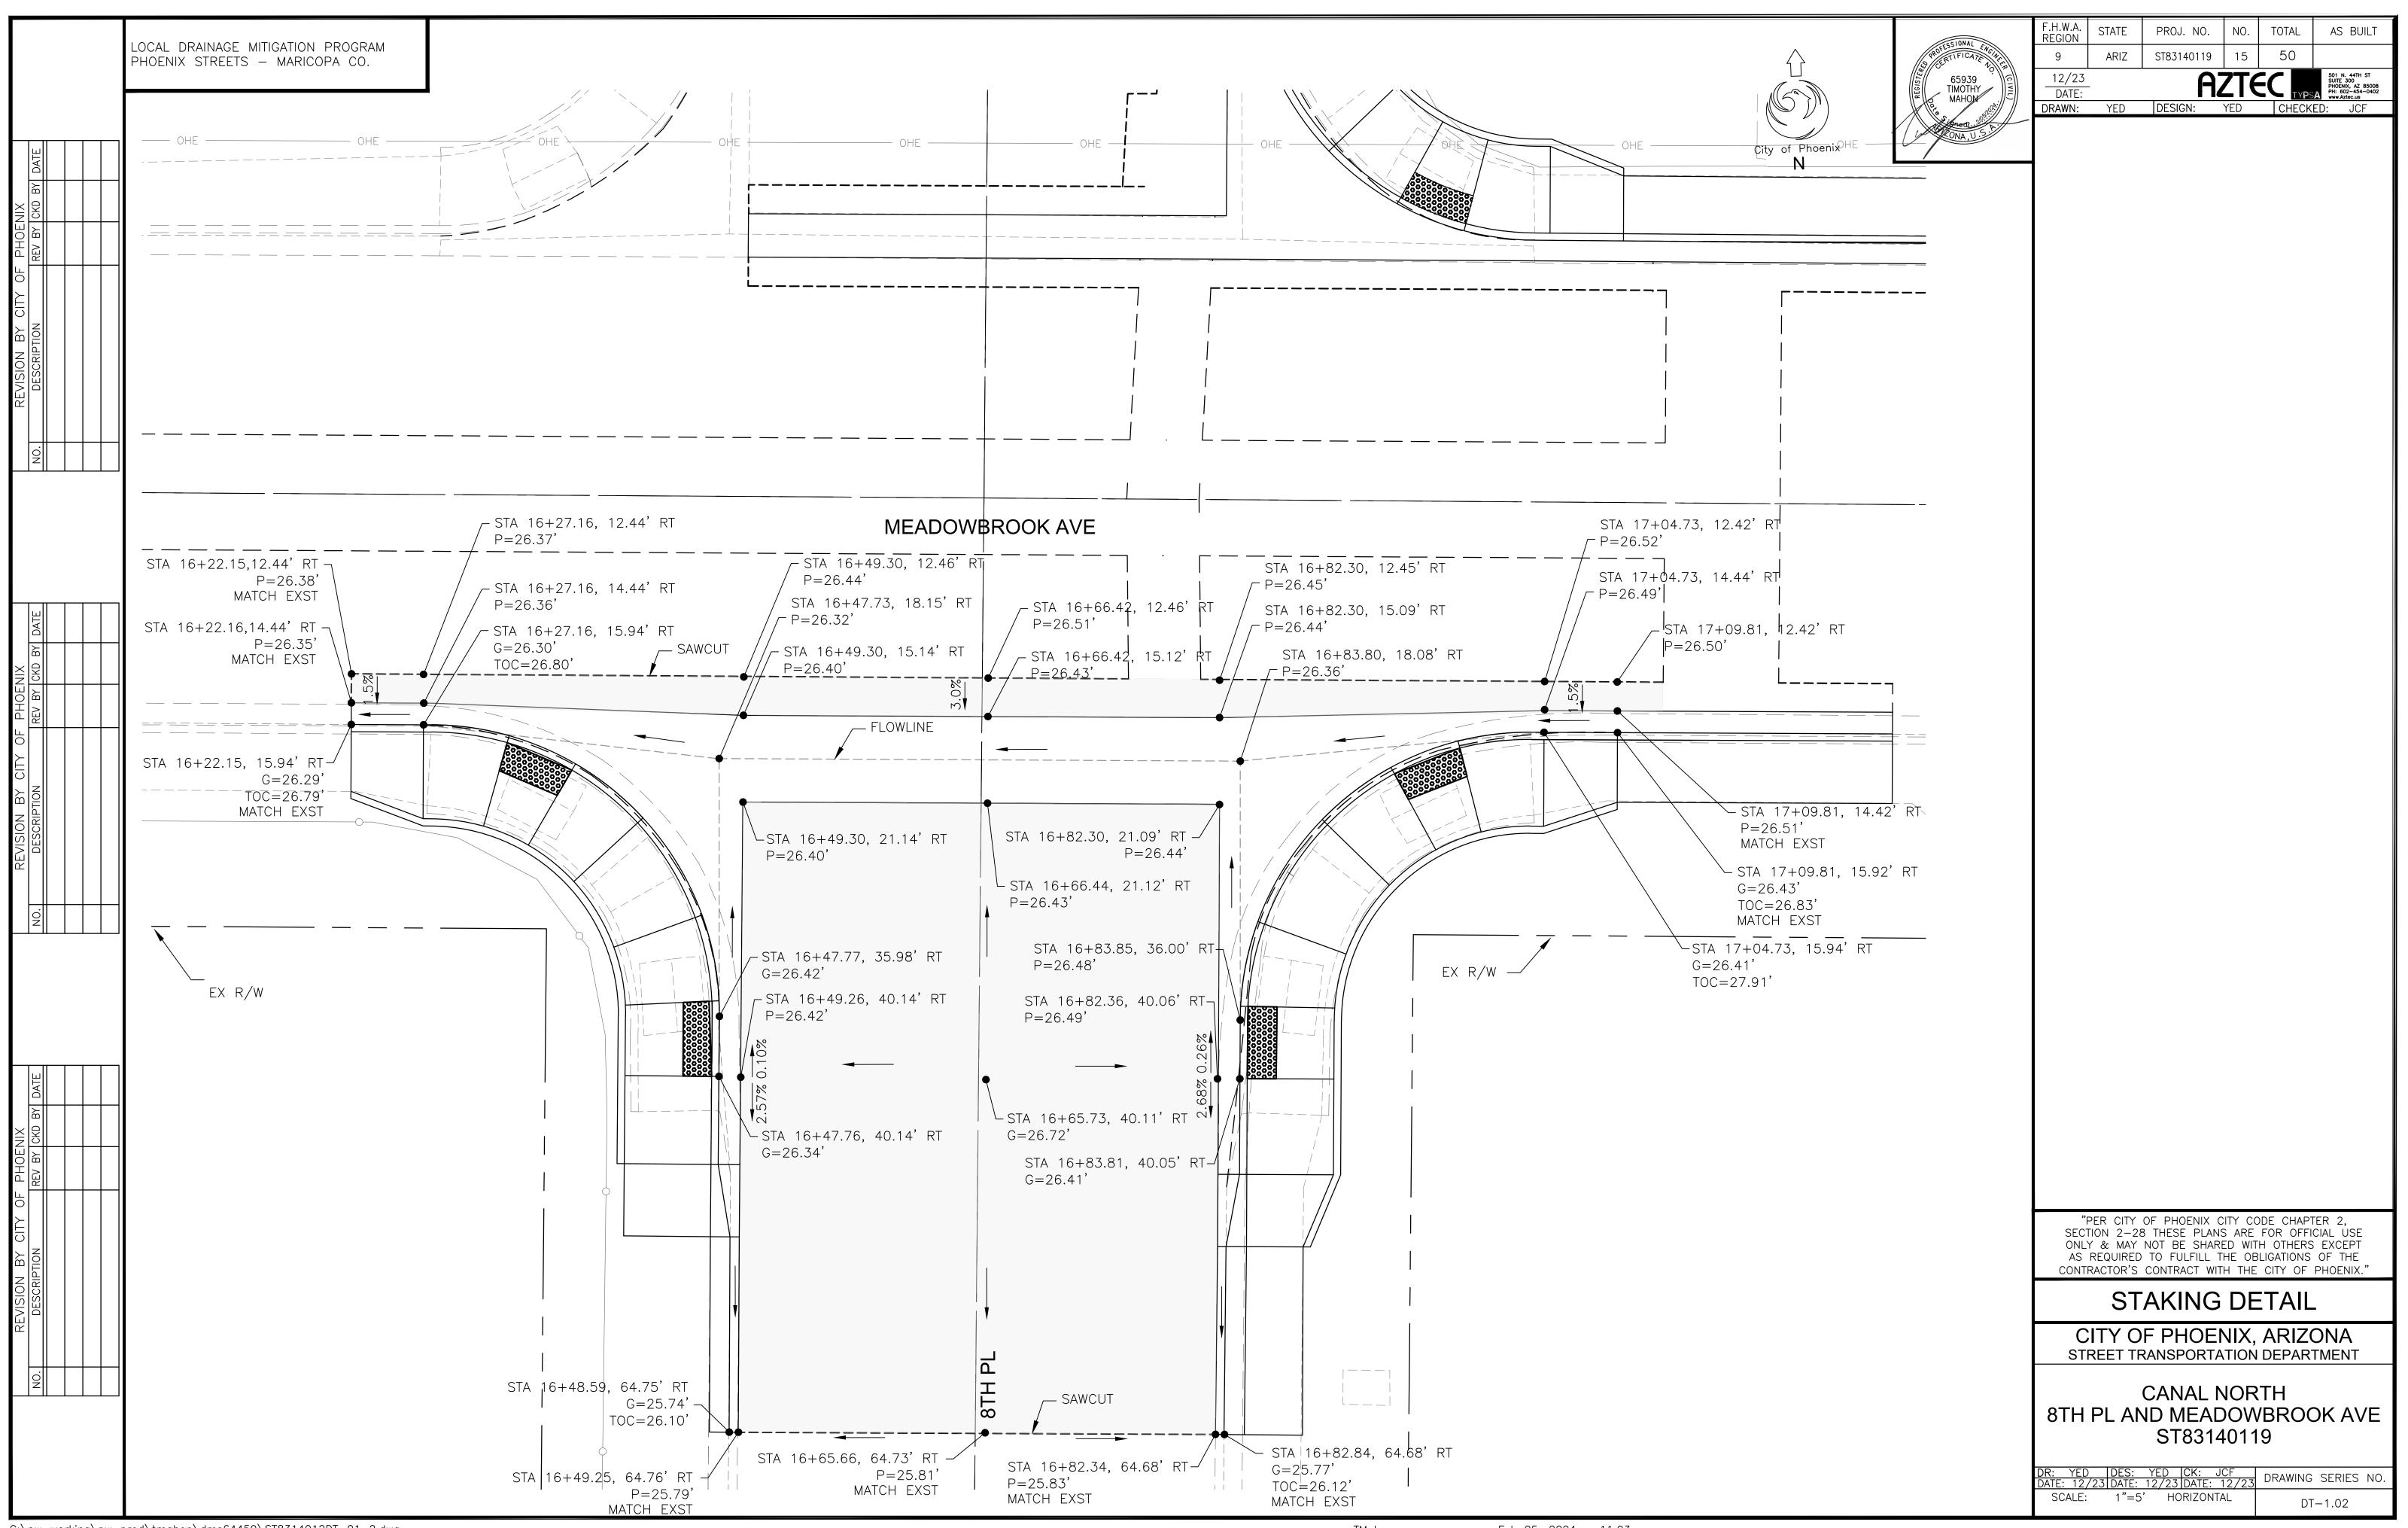

AMERICAN RESCUE PLAN ACT LOCAL DRAINAGE MITIGATION PROGRAM PHOENIX STREETS — MARICOPA CO.




	F.H.W.A. REGION	STATE	PROJ. NO.	NO.	TOTAL	AS BUILT
	9	ARIZ	ST83140119	16	50	
(CIVIL)	12/23 DATE:	-	AZ	ZTE	EC TYPS	501 N. 44TH ST SUITE 300 PHOENIX, AZ 85008 PH: 602-454-0402 www.Aztec.us
//	DRAWN:	LNB	DESIGN:	CJR	CHECK	ED: TMM

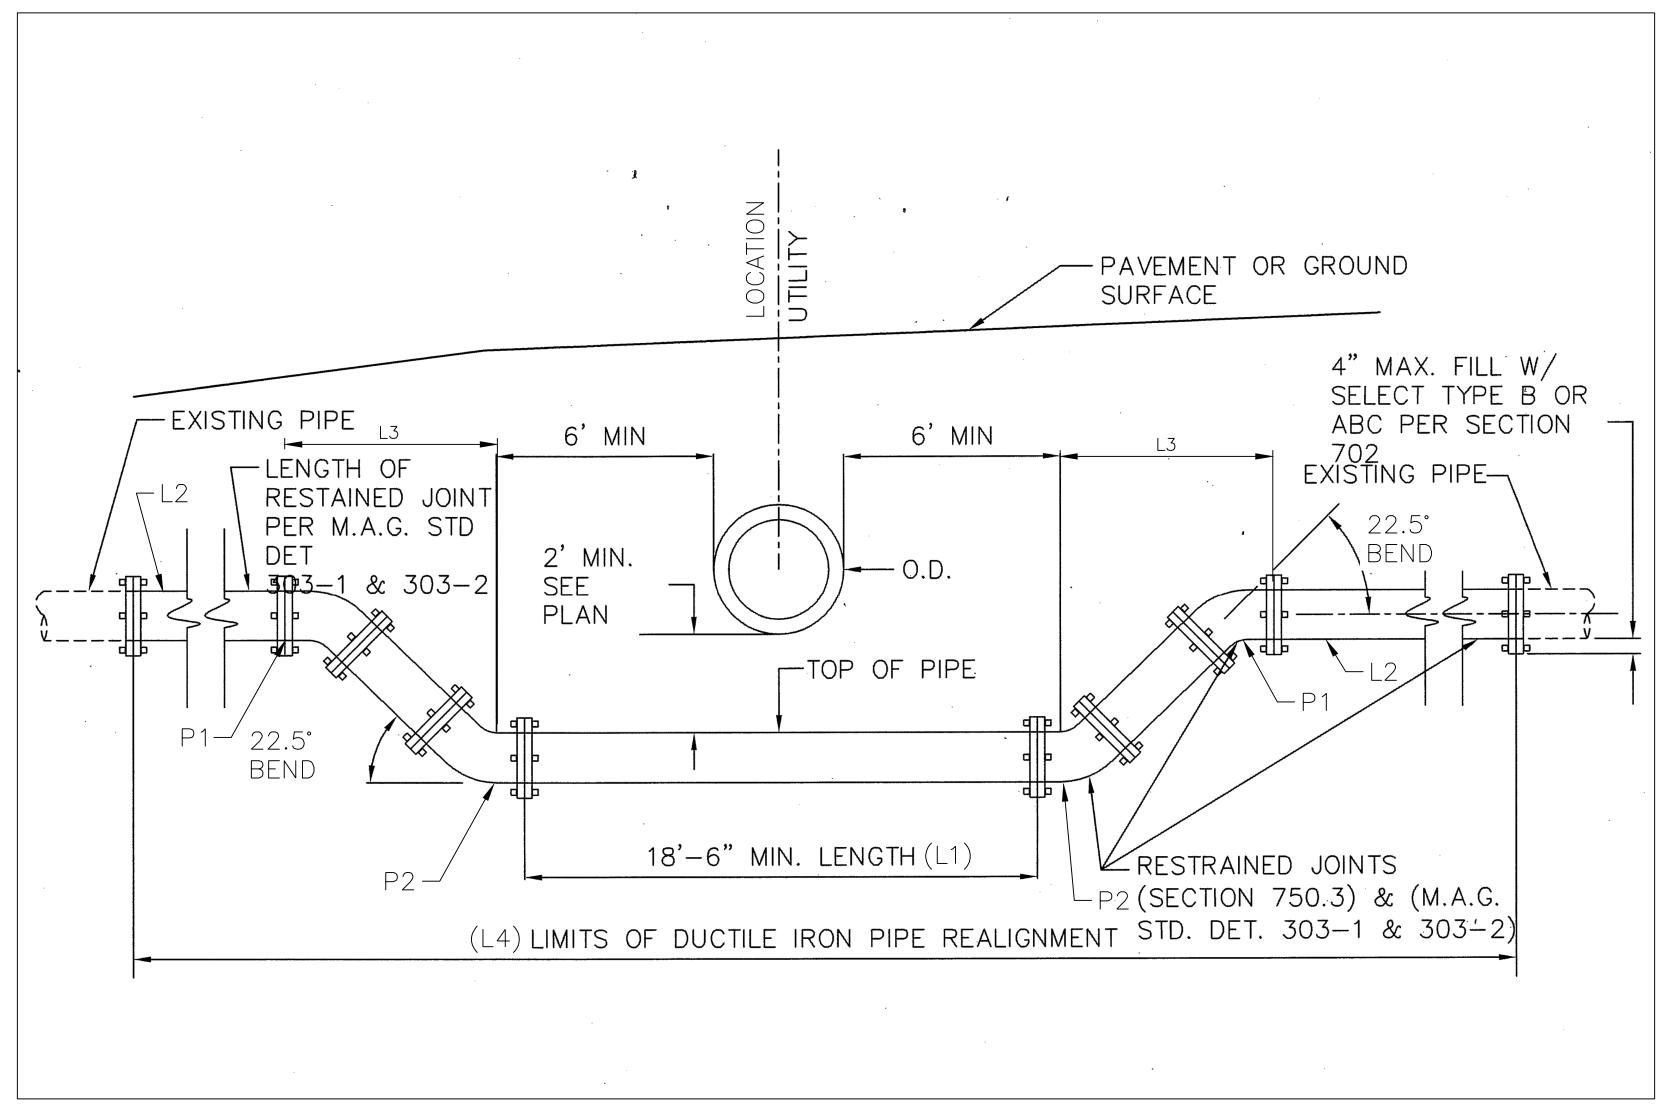

MODIFIED P-1370 WATERLINE REALIGNMENT (22.5 DEGREE ANGLE)

	Waterline Relocation P1370 Table							
Location MEADOWBROOK &	P1 Elevation (ft)	P2 Elevation (ft)	L1 (ft)	L2 (ft)	L3 (ft)	L4 (ft)		
Sta 10+67.33, 15.84' Lt	1121.52±	1119.18±	18.50	20.00	5.65	74.58		
Sta 13+28.33, 18.42' Lt	1122.95±	1118.46±	18.50	20.00	10.84	80.18		
Sta 13+44.67, 0.03' Rt	1122.40±	1117.40±	18.50	20.00	12.07	59.86		
Sta 14+15.07, 19.77' Lt	1123.14±	1118.53±	21.00	20.00	11.13	83.26		
Sta 16+78.23, 0.07' Lt	1122.12±	1118.41±	18.50	20.00	8.96	76.42		
Sta 17+25.97, 19.62' Lt	1122.75±	1119.46±	21.00	20.00	7.94	76.88		

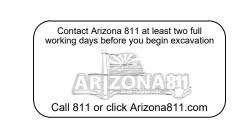

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WATERLINE RELOCATION

CITY OF PHOENIX, ARIZONA STREET TRANSPORTATION DEPARTMENT

CANAL NORTH

TH ST AND MINNEZONA AVE

ST8314011

DR: LNB DES: CJR CK: TMM
DATE: 12/23 DATE: 12/23 DATE: 12/23

SCALE: HORIZONTAL SDD-1.01

VICINITY MAP

CITY OF PHOENIX STREET TRANSPORTATION DEPARTMENT CONSTR CTION MANAGEMENT DIVISION DESIGN AMERICAN RESC E PLAN ACT LOCAL DRAINAGE MITIGATION PRO ECT PACKAGE 1


NORTH LANE 22ND STREET TO 24TH STREET ST83140121



2024

CITY BENCHMARKS

▲ COP BRASS CAP IN HAND HOLE, AT THE INTERSECTION OF 24TH ST AND SHEA BO LEVARD EL 1 86.33 NGVD 2

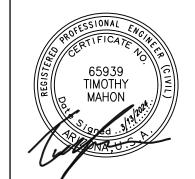

si th :// //	DRAWN:	LNB	DESIGN:	CJR CHEC	KED:	TMM DATE	E: 12/23
(CIVIL)				AZT	TEC	TYPSA	501 N. 44TH ST SUITE 300 PHOENIX, AZ 85008 PH: 602-454-0402 www.Aztec.us
CALE N	9	ARIZ.	ST8	3140121	17	50	
	F.H.W.A. REGION	STATE	PRO	J. NO.	NO.	TOTAL	AS BUILT

MAYOR

KATE GALLEGO

CITY MANAGER

CITY CO NCIL

JEFFREY BARTON

DISTRICT	NO	1.	ANN O'BRIEN
DISTRICT	NO	2.	JIM WARING
DISTRICT	NO	3.	DEBRA STARK
DISTRICT	NO	4.	LAURA PASTOR
DISTRICT	NO	5.	BETTY GUARDADO
DISTRICT	NO	6.	KEVIN ROBINSON
DISTRICT	NO	7.	YASSAMIN ANSARI
DISTRICT	NO	8.	KESHA HODGE WASHINGTO

INDEX OF SHEET

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LENGTH OF PROJECT: MOUNTAIN PRESERVE = 1727 LF AREA OF DISTURBANCE = 1.65 ACRES



"PER CITY OF PHOENIX CITY CODE CHAPTER 2, SECTION 2 28, THESE PLANS ARE FOR OFFICIAL SE ONLY MAY NOT BE SHARED WITH OTHERS EXCEPT AS RE IRED TO F LFILL THE OBLIGATIONS OF YO R CONTRACT WITH THE CITY OF PHOENIX."

6/4/2024

DATE

6/4/2024

AMERICAN RESCUE PLAN ACT LOCAL DRAINAGE MITIGATION PROGRAM PHOENIX STREETS - MARICOPA CO. LEGEND BENCHMARK NEW SURVEY MONUMENT - M.A.G. DETAIL 120-1 TYPE "B" NEW SURVEY MONUMENT - M.A.G. DETAIL 120-1 TYPE "A" COMBINED CURB & GUTTER - M.A.G. DETAIL 220 TYPE "A" BACKFILL TYPE & SQ. YD. PVMT. REPLACEMENT - C.O.P. DETAIL P1200 Z/ZZ/Z EXISTING CONCRETE PAVEMENT OR SIDEWALK NEW CONCRETE DRIVEWAY OR ALLEY ENT. PER DETAIL NO. ON PLANS NEW CONCRETE SIDEWALK RAMP PER DETAIL ON PLANS AVERAGE GROUND ELEVATION AT R/W LINE BACKFILL COMPACTION TYPE _____ EXISTING DITCH 24" IRR (SRP) EXISTING IRRIGATION LINE W/SIZE (NOTE PRIVATE, SALT RIVER OR R.I.D.) - - EXISTING IRRIGATION STRUCTURE EXISTING IRRIGATION STANDPIPE NEW IRRIGATION STANDPIPE - M.A.G. DETAIL 503 NEW IRRIGATION VALVE - M.A.G. DETAIL 506 W/ CONC. SCOURING BASIN IRRIGATION BERM NEW IRRIGATION STRUCTURE PER DETAIL ON PLANS ——12" DIP W—— EXISTING WATER LINE W/SIZE & TYPE (12" AND SMALLER) 36" DIP W EXISTING WATER LINE W/SIZE & TYPE (GREATER THAN 12") ADJUST EXIST. WATER VALVE BOX - C.O.P. DETAIL P1391 - ||REV | 3/4" W—— WATER SERVICE W/SIZE AND WATER METER BOX EXISTING FIRE HYDRANT NEW OR RELOCATED FIRE HYDRANT BY CONTRACTOR EXISTING WATER VALVE W/TOP OF OPERATING NUT ELEVATION 30" VCP S EXISTING SANITARY SEWER LINE W/SIZE & TYPE (GREATER THAN 12") ———— EXISTING MANHOLE CATCH BASIN, GUTTER INLET (LENGTH TO SCALE) CATCH BASIN, CURB INLET (LENGTH TO SCALE) CATCH BASIN, CURB & GUTTER INLET (LENGTH TO SCALE) — SD — EXISTING STORM DRAIN LINE W/SIZE & TYPE (GREATER THAN 12") NEW PIPE FOR STORM DRAIN OR IRRIGATION LINE — 4"G — EXISTING GAS LINE W/SIZE ----E EXISTING UNDERGROUND ELECTRIC CABLE OR SINGLE CONDUIT ——E-4D— EXISTING UNDERGROUND ELECTRIC DUCT (SPECIFY NUMBER) EXISTING TELEPHONE BURIED CABLE OR SINGLE CONDUIT EXISTING UNDERGROUND TELEPHONE DUCT (SPECIFY NUMBER) ——FO—— EXISTING UNDERGROUND FIBER OPTIC LINE --- EXISTING TRAFFIC SIGNAL POLE W/MAST ARM & SIGNAL INDICATIONS \Diamond \Diamond EXISTING STREET OR TRAFFIC SIGN EXISTING UTILITY POLE W/LINE INDICATING WIRE DIRECTION EXISTING BLOCK FENCE ----- EXISTING WOOD FENCE MAIL BOX EXISTING POWER POLE DOWN GUY ANCHOR EXISTING STREET LIGHT & POLE EXISTING TREE OR STUMP TO BE REMOVED - MORE THAN 12" DIA. EXISTING TREE TO BE TRANSPLANTED BY CONTRACTOR EASEMENT LINE EXISTING OR NEW R/W LINE PAVEMENT CENTER LINE OR MONUMENT LINE EXISTING TREE OR STUMP TO BE REMOVED 12" DIA. OR LESS (NON PAY ITEM) EXISTING TREE TO REMAIN

LEGEND AND NOTES

NOTES

- 1. ALL CONSTRUCTION SHALL BE PERFORMED IN ACCORDANCE WITH CONTRACT SPECIFICATIONS; PLANS; CITY OF PHOENIX SUPPLEMENTS TO MAG STANDARD SPECIFICATIONS AND DETAILS; AND MAG STANDARD SPECIFICATIONS AND DETAILS, IN THAT ORDER OF PRECEDENCE, AT THE TIME OF CONSTRUCTION BID.
- 2. FACILITIES WHICH ARE NOT SPECIFICALLY LOCATED WITH ACTUAL VERTICAL AND HORIZONTAL CONTROLS, ARE LOCATED ONLY APPROXIMATELY AND TO THE BEST AVAILABLE INFORMATION PROVIDED BY VARIOUS OWNERS OF THE FACILITIES AND SUPPLEMENTED BY VISUAL SURFACE INFORMATION WHERE APPROPRIATE. ACCURACY, LOCATION AND COMPLETENESS OF THIS INFORMATION SHALL BE VERIFIED BY THE CONTRACTOR PRIOR TO INITIATION OF CONSTRUCTION.
- 3. AT LEAST TWO WORKING DAYS BEFORE CONSTRUCTION, THE CONTRACTOR SHALL CONTACT BLUESTAKE TO FIND AND FLAG UNDERGROUND UTILITIES. THE CONTRACTOR SHALL CONTACT OTHER APPROPRIATE UTILITIES DIRECTLY IF THEY ARE NOT ON BLUESTAKE SYSTEM.
- 4. VERTICAL CONTROL IS BASED ON NATIONAL GEODETIC SURVEY 1929.
- 5. ALL EXISTING DRIVEWAYS AND ALL EXISTING ALLEYS SHALL BE GRADED TO MATCH THE NEW WORK IN ACCORDANCE WITH STD DETAIL P1164, UNLESS OTHERWISE SPECIFIED. EXISTING SURFACING SHALL BE REMOVED AND REPLACED AS NECESSARY.
- 6. NO ENCROACHMENT INTO PRIVATE PROPERTY SHALL OCCUR FOR CONSTRUCTION, CONSTRUCTION ACCESS, OR OTHER CONSTRUCTION ACTIVITIES.
- 7. THE CONTRACTOR SHALL PROTECT IN PLACE EXISTING CACTI AND TREES WITHIN THE PROJECT LIMITS.
- 8. ALL WORK SHALL BE STABILIZED WITH REQUIRED STORMWATER PROTECTION MEASURES AND EROSION PROTECTION MEASURES PER THE CITY OF PHOENIX STANDARD SPECIFICATIONS.
- 9. NO FOREIGN DIRT, BORROW, OR ROCK SHALL BE USED ON THE PROJECT. ALL GRADING SHALL USE NATIVE MATERIALS DEVELOPED FROM GRADING OF DITCHES AND BERMS.
- 10. DRAINAGE BERMS SHALL BE COMPACTED TO 95% DENSITY.
- 11. NO DEBRIS, ORGANICS, OR LARGE ROCK SHALL BE USED IN BERM. ROCK SHALL BE CRUSHED TO 3" MINUS FOR USE IN BERM CONSTRUCTION.
- 12. CONTRACTOR SHALL RESTORE LANDSCAPING TO EXISTING CONDITION TO ALL WORK AREAS ON THE PROJECT.
- 13. A GRADING PERMIT IS REQUIRED UNDER PCC CHAPTER 32A.
- 14. WHEN HAUL PERMITS ARE REQUIRED, THEY MUST BE OBTAINED PRIOR TO OR CONCURRENTLY WITH THE G&D PERMIT.
- 15. EXCAVATING CONTRACTOR MUST GIVE LOCATION FOR WASTING EXCESS EXCAVATION AND A LETTER FROM OWNER GIVING PERMISSION FOR DUMPING PRIOR TO STARTING ON—SITE CONSTRUCTION. IF EXCESS EXCAVATION EXCEEDS 100 CUBIC YARDS, THE DISPOSAL SITE WILL ALSO REQUIRE A G&D PERMIT.
- 16. PLANNING & DEVELOPMENT DEPARTMENT FIELD INSPECTION GROUP SHALL BE NOTIFIED 48 HOURS BEFORE ANY ON-SITE AND/OR OFF-SITE CONSTRUCTION BEGINS, TELEPHONE (602) 262-7811 OR 7-1-1 (TTY).
- 17. STAKING BUILDING PAD ELEVATIONS IS THE RESPONSIBILITY OF THE OWNER AND HIS PROFESSIONAL ENGINEER. THE OWNER'S PROFESSIONAL ENGINEER SHALL SUBMIT THREE SEALED COPIES OF THIS GRADING AND DRAINAGE PLAN DESIGNATED AS "RECORD DRAWING" (BEARING AN ORIGINAL SIGNATURE) PRIOR TO THE REQUEST FOR FINAL INSPECTION.
- 18. STAKING FINISH FLOOR ELEVATIONS IS THE RESPONSIBILITY OF THE OWNER AND HIS PROFESSIONAL ENGINEER. THE OWNER'S PROFESSIONAL ENGINEER SHALL SUBMIT THREE SEALED COPIES OF THIS GRADING AND DRAINAGE PLAN DESIGNATED AS "RECORD DRAWING" (BEARING AN ORIGINAL SIGNATURE) PRIOR TO THE REQUEST FOR FINAL INSPECTION.
- 19. A FEDERAL EMERGENCY MANAGEMENT AGENCY (FEMA) ELEVATION CERTIFICATE BASED ON FINISHED CONSTRUCTION MUST BE REVIEWED AND APPROVED BY FLOODPLAIN MANAGEMENT FOR EACH NEW AND SUBSTANTIAL IMPROVEMENT STRUCTURE CONSTRUCTED IN A SPECIAL FLOOD HAZARD AREA (SFHA) PRIOR TO ISSUING A CERTIFICATE OF OCCUPANCY. A COPY OF THE ELEVATION CERTIFICATE MUST BE SUBMITTED TO THE GENERAL OR STRUCTURAL INSPECTOR.

- 20. BUILDING PAD CERTIFICATIONS WILL BE REQUIRED ON ALL LOTS WITHIN THE SUBDIVISION AND SUBMITTED TO THE CIVIL/SITE INSPECTOR PRIOR TO ANY CONCRETE CONSTRUCTED IN THE R/W. BUILDING PAD CERTIFICATION CAN BE SUBMITTED TO THE CIVIL/SITE INSPECTOR BY EITHER SUBMITTING ONE APPROVED BLACK-LINE AS-BUILT GRADING AND DRAINAGE PLAN OR IN LETTER FORMAT SHOWING THE DESIGN AND AS-BUILT BUILDING PAD ELEVATIONS AS SHOWN ON THE APPROVED GRADING AND DRAINAGE PLAN. IT IS REQUIRED THAT THE AS-BUILT PLAN AND LETTER BE SEALED BY A CIVIL PROFESSIONAL ENGINEER OR LAND SURVEYOR REGISTERED IN THE STATE OF ARIZONA.
- 21. A SEPARATE PERMIT IS NECESSARY FOR ANY OFFSITE CONSTRUCTION. AN APPROVED G&D PLAN SHALL BE ON THE JOB SITE AT ALL TIMES. DEVIATIONS FROM THE PLAN MUST BE PRECEDED BY AN APPROVED PLAN REVISION.
- 22. G&D PLAN APPROVAL INCLUDES THE CONSTRUCTION OF ALL SURFACE IMPROVEMENTS SHOWN ON THE APPROVED PLAN, INCLUDING, BUT NOT LIMITED TO, RETENTION AREAS, SEDIMENTATION BASINS, AND/OR OTHER DRAINAGE FACILITIES, DRAINAGE PATTERNS, WALLS, CURBS, ASPHALT PAVEMENT, AND BUILDING FLOOR ELEVATION.
- 23. GRADES SHOWN IN RETENTION BASINS ARE DESIGN FINISHED GRADES. SHOULD THE CONTRACTOR OR ANY SUB— CONTRACTOR PLAN TO PLACE SPOIL DIRT FROM FOOTINGS, UTILITY TRENCHES, LANDSCAPING, SWIMMING POOLS, ETC. IN THE BASINS, THE BASINS SHOULD BE SUFFICIENTLY OVER—EXCAVATED DURING THE ROUGH GRADING OPERATION TO ALLOW FOR THE PLACEMENT OF THE FILL OR LANDSCAPING MATERIALS.
- 24. CONTRACTOR IS RESPONSIBLE FOR LOCATING AND CONFIRMING DEPTHS OF ALL THE EXISTING UTILITY LINES WITHIN PROPOSED RETENTION BASIN AREAS. IF THE BASIN CANNOT BE CONSTRUCTED PER PLAN BECAUSE OF CONFLICTS, THE CONTRACTOR SHOULD DISCUSS MODIFICATION OF BASIN CONFIGURATION WITH THE CITY INSPECTOR TO DETERMINE IF A PLAN REVISION OR A FIELD CHANGE IS REQUIRED.
- 25. ALL DRAINAGE PROTECTIVE DEVICES SUCH AS SWALES, INTERCEPTOR DITCHES, PIPES, PROTECTIVE BERMS, BARRIER WALLS, CONCRETE CHANNELS, OR OTHER MEASURES DESIGNED TO PROTECT ADJACENT BUILDINGS OR PROPERTY FROM STORM RUNOFF MUST BE COMPLETED PRIOR TO BUILDING CONSTRUCTION.
- 26. PER SECTION 6.8.7 OF THE CITY STORM WATER POLICIES AND STANDARDS, SIDE SLOPES OF STORM WATER STORAGE FACILITIES SHALL BE NO STEEPER THAN 5:1 FOR IRRIGATED GRASS AREAS AND 3:1 FOR LANDSCAPE AREAS. SLOPE STABILIZATION MEASURES ARE REQUIRED FOR ALL SLOPES GREATER THAN 5:1. THE SLOPE STABILIZATION MEASURES MUST BE READILY MAINTAINABLE USING COMMON MAINTENANCE EQUIPMENT AND BE DESIGNED WITH CONSIDERATION TO AESTHETICS. THE SLOPE STABILIZATION MEASURES SHALL BE CONSISTENT WITH COMMONLY USED ENGINEERING PRACTICES. UN—STABILIZED DECOMPOSED GRANITE IS NOT ALLOWED ON SLOPES GREATER THAN 5:1.
- 27. ALL RETAINING WALLS ARE TO BE REVIEWED, PERMITTED, AND INSPECTED BY THE BUILDING SAFETY BRANCH OF THE PLANNING & DEVELOPMENT DEPARTMENT. ALL RETAINING WALLS ARE TO BE IN ACCORDANCE WITH SECTION 703 OF THE ZONING ORDINANCE AND SECTION 32-32 OF THE SUBDIVISION ORDINANCE FOR SPECIFIC WALL HEIGHT REQUIREMENTS. NOTE: USE PERMIT FOR IS REQUIRED FOR ALL OVER-HEIGHT RETAINING WALLS.
- 28. ALL RAMPS MUST MEET 2010 AMERICANS WITH DISABILITIES ACT (ADA) STANDARDS FOR ACCESSIBLE DESIGN AND CITY OF PHOENIX SUPPLEMENT TO MAG UNIFORM STANDARD SPECIFICATIONS AND DETAILS; 2% MAX CROSS SLOPES AND 12:1 MAX LONGITUDINAL SLOPES.
- 29. CERTIFICATE OF OCCUPANCY (C OF O) AND/OR FINAL ELECTRICAL CLEARANCE FOR ANY BUILDING IS DENIED UNTIL ALL G&D IMPROVEMENTS ARE COMPLETED.
- 30. EXISTING OR NEWLY DAMAGED AND/OR DISPLACED CONCRETE CURB, GUTTER, SIDEWALK, OR DRIVEWAY SLAB THAT IS WITHIN THE R/W SHALL BE REPAIRED OR REPLACED, AS NOTED BY CITY INSPECTORS, BEFORE FINAL ACCEPTANCE OF THE WORK.
- 31. THE ENGINEERING DESIGN ON THESE PLANS IS ONLY APPROVED BY THE CITY IN SCOPE AND NOT IN DETAIL. CONSTRUCTION QUANTITIES ON THESE PLANS ARE NOT VERIFIED BY THE CITY. APPROVAL OF THESE PLANS ARE FOR PERMIT PURPOSES ONLY AND SHALL NOT PREVENT THE CITY FROM REQUIRING CORRECTION OF ERRORS IN THE PLANS WHERE SUCH ERRORS ARE SUBSEQUENTLY FOUND TO BE IN VIOLATION OF ANY LAW, ORDINANCE, HEALTH, SAFETY, OR OTHER DESIGN ISSUES.



	F.H.W.A. REGION	STATE	PROJ. NO.	NO.	TOTAL	AS BUILT
AFER TO SEE	9	ARIZ	ST83140121	18	50	
(CIVIL)	12/23 DATE:	-	A	ZTE	EC TYPS	501 N. 44TH ST SUITE 300 PHOENIX, AZ 85008 PH: 602-454-0402 www.Aztec.us
<i> </i>	DRAWN:	LNB	DESIGN:	CJR	CHECK	ED: TMM
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- 32. PLAN APPROVAL IS VALID FOR 12 MONTHS. PRIOR TO PLAN APPROVAL EXPIRATION, ALL ASSOCIATED PERMITS SHALL BE PURCHASED OR THE PLANS SHALL BE RESUBMITTED FOR EXTENSION OF PLAN APPROVAL. THE EXPIRATION, EXTENSION, AND REINSTATEMENT OF CIVIL ENGINEERING PLANS AND PERMITS SHALL FOLLOW THE SAME GUIDELINES AS THOSE INDICATED IN THE PHOENIX BUILDING CONSTRUCTION CODE ADMINISTRATIVE PROVISIONS SECTION 105.3 FOR BUILDING PERMITS.
- 33. CONSTRUCTION WITHIN THE R/W SHALL CONFORM TO THE LATEST APPLICABLE MAG UNIFORM STANDARD SPECIFICATIONS AND DETAILS AND THE LATEST CITY OF PHOENIX SUPPLEMENT TO THE MAG UNIFORM STANDARD SPECIFICATIONS AND DETAILS.
- 34. OBSTRUCTIONS TO PROPOSED IMPROVEMENTS IN THE R/W SHALL BE REMOVED OR RELOCATED BEFORE BEGINNING CONSTRUCTION OF THE PROPOSED IMPROVEMENTS.
- 35. THE ACTUAL POINT OF PAVEMENT MATCHING AND/OR TERMINATION SHALL BE DETERMINED IN THE FIELD BY THE CITY PLANNING & DEVELOPMENT DEPARTMENT FIELD INSPECTOR.
- 36. TREES AND SHRUBBERY IN THE R/W THAT CONFLICT WITH PROPOSED IMPROVEMENTS SHALL NOT BE REMOVED WITHOUT APPROVAL OF THE CITY LANDSCAPE ARCHITECT OR HIS ASSIGNEES. THE PERMITTEE SHALL BE RESPONSIBLE FOR OBTAINING AUTHORIZATION TO REMOVE AND/OR RELOCATE SAID TREES OR SHRUBBERY BY CALLING THE PARKS AND RECREATION DEPARTMENT AT (602) 262-6501 AND TRANSPORTATION DEPARTMENT AT (602) 534-9898.
- 37. PER THE STREET PAVEMENT CUT POLICY (TRT 00164) AND CITY ORDINANCE G-6308, ALL STREET PAVEMENT CUTS WILL REQUIRE ASPHALT RESURFACING TREATMENTS BASED ON THE AGE OF THE PAVEMENT. FOR STREETS LESS THAN TWO (2) YEARS OLD, THE PERMITTEE MUST APPLY AN ASPHALT MILL AND OVERLAY PAVEMENT TREATMENT. FOR STREETS GREATER THAN TWO (2) YEARS OLD, THE PERMITTEE MUST APPLY A SLURRY SEAL AND/OR MICROSEAL TREATMENT.
- 38. CONSTRUCTION MUST BE PHASED SO THE NEWLY ALIGNED CHANNEL IS FULLY OPERATIONAL BEFORE THE EXISTING DRAINAGE CHANNEL IS FILLED. FLOOD WATER CONVEYANCE MUST BE MAINTAINED AT ALL TIMES DURING CONSTRUCTION.
- 39. BEFORE GRADING IN AREAS CONTAINING NATIVE DESERT VEGETATION, THE CONTRACTOR MUST OBTAIN A PERMIT FROM ARIZONA DEPARTMENT OF AGRICULTURE. FOR INFORMATION, PHONE (602) 542-3578.
- 40. IF PROPERTY IS ADJACENT TO THE PHOENIX MOUNTAIN PRESERVE, NO DISTURBANCE OF PRESERVE PROPERTY FOR ACCESS, GRADING, OR OTHER CONSTRUCTION PURPOSES WILL BE ALLOWED. THE CONTRACTOR IS REQUIRED TO DELINEATE THE MOUNTAIN PRESERVE BOUNDARY WITH A TEMPORARY FENCE OR OTHER ACCEPTABLE METHODS.
- 41. IF SITE HAS SPECIAL PRESERVATION OR HILLSIDE ISSUES, THE GRADING PLAN MUST SHOW ALL LANDSCAPE PRESERVATION EASEMENTS, CONSTRUCTION FENCING LOCATIONS, AND APPROPRIATE AREAS LABELED. PRIOR TO ANY CLEARING, GRUBBING, OR GRADING OPERATIONS, CONSTRUCTION FENCING SHALL BE SHOWN ON APPROVED PLANS, PERMITTED AND INSPECTED AND SALVAGE OPERATIONS PERMITTED, INSPECTED, AND COMPLETED.

ABBREVIATIONS

PC = PIPE CONNECTION

MH = MANHOLE

CB = CATCH BASIN

P/L = PRIVATE

PROPERTY LINE

"PER CITY OF PHOENIX CITY CODE CHAPTER 2, SECTION 2-28 THESE PLANS ARE FOR OFFICIAL USE ONLY & MAY NOT BE SHARED WITH OTHERS EXCEPT AS REQUIRED TO FULFILL THE OBLIGATIONS OF THE CONTRACTOR'S CONTRACT WITH THE CITY OF PHOENIX."

LEGEND NOTES

CITY OF PHOENIX, ARIZONA STREET TRANSPORTATION DEPARTMENT

NORTH LANE 22ND ST TO 24TH ST ST83140121


DR: LNB DES: CJR CK: TMM
DATE: 12/23 DATE:

cragan

LOCAL DRAINAGE MITIGATION PROGRAM PHOENIX STREETS — MARICOPA CO.



,	F.H.W.A. REGION	STATE	PROJ. NO.	NO.	TOTAL	AS BUILT		
ALCEN IN	9	ARIZ	ST83140121	19	50			
(C)VIL	12/23 DATE:	-	AZ	ZTE	EC TYPS	501 N. 44TH ST SUITE 300 PHOENIX, AZ 85008 PH: 602-454-0402 www.Aztec.us		
	DRAWN: I	_NB	DESIGN: CJR		CHECK	CHECKED: TMM		

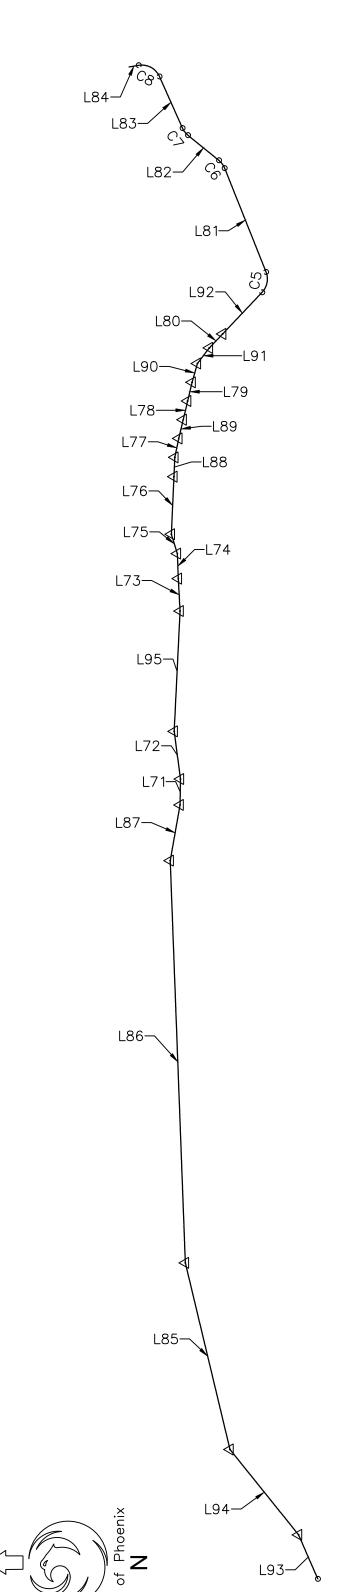

WEST DITCH

NUMBER	RADIUS	LENGTH	LINE/CHORD DIRECTION	START	PI STATION	END
L93		25.064	N66° 26' 14.90"E	N 938775.4748 E 663839.8561 STA 20+00.00		N 938785.4941 E 663862.8304 STA 20+25.06
L94		57.060	N51° 14' 12.12"E	N 938785.4941 E 663862.8304 STA 20+25.06		N 938821.2196 E 663907.3222 STA 20+82.12
L85		99.928	N76° 32' 44.26"E	N 938821.2196 E 663907.3222 STA 20+82.12		N 938844.4699 E 664004.5077 STA 21+82.05
L86		209.636	N87° 50' 55.91"E	N 938844.4699 E 664004.5077 STA 21+82.05		N 938852.3387 E 664213.9964 STA 23+91.69
L87		29.449	S79° 58' 59.69"E	N 938852.3387 E 664213.9964 STA 23+91.69		N 938847.2165 E 664242.9965 STA 24+21.14
L71		13.495	S89°01'52.81"E	N 938847.2165 E 664242.9965 STA 24+21.14		N 938846.9883 E 664256.4899 STA 24+34.63
L72		25.046	N82° 27' 32.51"E	N 938846.9883 E 664256.4899 STA 24+34.63		N 938850.2752 E 664281.3188 STA 24+59.68
L95		62.748	S87°12′32.15″E	N 938850.2752 E 664281.3188 STA 24+59.68		N 938847.2197 E 664343.9921 STA 25+22.43
L73		16.908	N86° 55' 53.86"E	N 938847.2197 E 664343.9921 STA 25+22.43		N 938848.1248 E 664360.8754 STA 25+39.33
L74		13.044	N87° 43' 28.66"E	N 938848.1248 E 664360.8754 STA 25+39.33		N 938848.6426 E 664373.9093 STA 25+52.38
L75		10.545	N72° 55' 23.87"E	N 938848.6426 E 664373.9093 STA 25+52.38		N 938851.7392 E 664383.9895 STA 25+62.92
L76		30.000	S87°26'47.99"E	N 938851.7392 E 664383.9895 STA 25+62.92		N 938850.4027 E 664413.9594 STA 25+92.92
L88		10.074	S87°23'21.09"E	N 938850.4027 E 664413.9594 STA 25+92.92		N 938849.9439 E 664424.0228 STA 26+03.00
L77		10.071	S78° 13' 42.15"E	N 938849.9439 E 664424.0228 STA 26+03.00		N 938847.8893 E 664433.8817 STA 26+13.07
L89		10.032	S76° 38' 54.35"E	N 938847.8893 E 664433.8817 STA 26+13.07		N 938845.5728 E 664443.6422 STA 26+23.10
L78		10.000	S76° 38' 43.80"E	N 938845.5728 E 664443.6422 STA 26+23.10		N 938843.2630 E 664453.3717 STA 26+33.10
L79		9.992	S76° 38' 43.95"E	N 938843.2630 E 664453.3717 STA 26+33.10		N 938840.9552 E 664463.0931 STA 26+43.09
L90		10.208	S74° 12' 32.42"E	N 938840.9552 E 664463.0931 STA 26+43.09		N 938838.1774 E 664472.9156 STA 26+53.30
L91		10.247	S52° 32' 42.03"E	N 938838.1774 E 664472.9156 STA 26+53.30		N 938831.9461 E 664481.0497 STA 26+63.54
L80		10.006	S46° 23' 54.70"E	N 938831.9461 E 664481.0497 STA 26+63.54		N 938825.0457 E 664488.2954 STA 26+73.55

			WEST DITCH AL	IGNMENT DATA		
NUMBER	RADIUS	LENGTH	LINE/CHORD DIRECTION	START	PI STATION	END
L92		29.903	S46° 31' 24.51"E	N 938825.0457 E 664488.2954 STA 26+73.55		N 938804.4705 E 664509.9950 STA 27+03.45
C5	10.000	11.382	S79°07'50.57"E	STA 27+03.45	STA 27+09.85	STA 27+14.84
L81		58.175	N68° 15' 43.36"E	N 938802.4382 E 664520.5792 STA 27+14.84		N 938823.9840 E 664574.6171 STA 27+73.01
C6	10.000	5.103	N53° 38′ 34.63″E	STA 27+73.01	STA 27+75.62	STA 27+78.11
L82		20.799	N39°01'25.90"E	N 938826.9764 E 664578.6823 STA 27+78.11		N 938843.1352 E 664591.7786 STA 27+98.91
C7	10.000	4.712	N52° 31' 18.79"E	STA 27+98.91	STA 28+01.31	STA 28+03.62
L83		29.470	N66° 01' 11.67"E	N 938845.9756 E 664595.4832 STA 28+03.62		N 938857.9526 E 664622.4093 STA 28+33.09
C8	10.000	13.240	N28° 05' 21.51"E	STA 28+33.09	STA 28+40.89	STA 28+46.33
L84		4.999	N09° 50' 28.65"W	N 938868.7987 E 664628.1980 STA 28+46.33		N 938873.7239 E 664627.3436 STA 28+51.33

NOTES ADD:

THE HORIZONTAL DATUM IS NAD83(HARN) STATE PLANE, ARIZONA CENTRAL ZONE ADJUSTED FROM GRID TO GROUND USING A COMBINATION SCALE FACTOR OF 1.000164 WITH A SCALE POINT OF X=0.0, Y=0.0

THE BASIS OF BEARING IS GEODETIC DENSIFICATION AND CADASTRAL SURVEY

ELEVATIONS ARE ON THE NGVD29 VERTICAL DATUM



"PER CITY OF PHOENIX CITY CODE CHAPTER 2, SECTION 2-28 THESE PLANS ARE FOR OFFICIAL USE ONLY & MAY NOT BE SHARED WITH OTHERS EXCEPT AS REQUIRED TO FULFILL THE OBLIGATIONS OF THE CONTRACTOR'S CONTRACT WITH THE CITY OF PHOENIX."

GEOMETRIC CONTROL

CITY OF PHOENIX, ARIZONA STREET TRANSPORTATION DEPARTMENT

> NORTH LANE 22ND ST TO 24TH ST ST83140121

DR: LNB DES: CJR CK: TMM DRAWING SERIES NO. SCALE: 1"=100' HORIZONTAL G-2.01

LOCAL DRAINAGE MITIGATION PROGRAM PHOENIX STREETS — MARICOPA CO.

	ı		EAST DITCH ALI	GNMENI DATA	r	
NUMBER	RADIUS	LENGTH	LINE/CHORD DIRECTION	START	PI STATION	END
L71		49.535	N72° 46' 45.26"E	N 938827.6809 E 664640.7968 STA 30+00.00		N 938842.3 E 664688.1 STA 30+49.
С7	10.000	3.306	N63° 18′ 34.02″E	STA 30+49.53	STA 30+51.20	STA 30+52.
L72		68.314	N53° 50' 22.79"E	N 938843.8239 E 664691.0509 STA 30+52.84		N 938884.1 E 664746.2 STA 31+21.
C8	5.000	1.470	N62° 15' 50.60"E	STA 31+21.15	STA 31+21.89	STA 31+22.
L73		10.805	N70° 41' 18.40"E	N 938884.8141 E 664747.5022 STA 31+22.62		N 938888.3 E 664757.6 STA 31+33.
C9	5.000	0.568	N73° 56' 28.32"E	STA 31+33.43	STA 31+33.71	STA 31+34.
L74		111.947	N77° 11' 38.24"E	N 938888.5445 E 664758.2448 STA 31+34.00		N 938913.3 E 664867.4 STA 32+45.
C10	5.000	0.441	N79° 43' 06.52"E	STA 32+45.95	STA 32+46.17	STA 32+46.
L75		100.533	N82° 14' 34.79"E	N 938913.4364 E 664867.8410 STA 32+46.39		N 938927.0 E 664967.4 STA 33+46.
C11	20.000	4.761	N89° 03′ 46.21″E	STA 33+46.92	STA 33+49.31	STA 33+51.
L76		97.742	S84° 07' 02.38"E	N 938927.0832 E 664972.2030 STA 33+51.68		N 938917.0 E 665069.4 STA 34+49.
L77		90.146	N87° 07' 44.85"E	N 938917.0654 E 665069.4303 STA 34+49.42		N 938921.5 E 665159.4 STA 35+39.
C5	20.000	6.130	S84° 14' 20.79"E	STA 35+39.57	STA 35+42.66	STA 35+45.
L78		60.709	S75° 27' 32.66"E	N 938920.9675 E 665165.5378 STA 35+45.70		N 938905.7 E 665224.3 STA 36+06.
L79		0.382	S73° 16' 03.22"E	N 938905.7252 E 665224.3023 STA 36+06.41		N 938905.6 E 665224.6 STA 36+06.
L80		67.142	S71°04'33.23"E	N 938905.6151 E 665224.6685 STA 36+06.79		N 938883.8 E 665288.1 STA 36+73.
L81		1.419	S67°00'24.97"E	N 938883.8399 E 665288.1816 STA 36+73.93		N 938883.2 E 665289.4 STA 36+75.
L82		37.466	S62° 56' 16.66"E	N 938883.2855 E 665289.4880 STA 36+75.35		N 938866.2 E 665322.8 STA 37+12.
C6	10.000	1.754	S67° 57' 47.66"E	STA 37+12.82	STA 37+13.70	STA 37+14.
L83		30.482	S64° 58' 14.42"E	N 938865.5826 E 665324.4764 STA 37+14.57		N 938852.6 E 665352.0 STA 37+45.
L84		1.512	S72° 10' 21.30"E	N 938852.6861 E 665352.0961 STA 37+45.05		N 938852.2 E 665353.5 STA 37+46.
L85		3.504	S72° 31' 06.83"E	N 938852.2234 E 665353.5351 STA 37+46.56		N 938851.1 E 665356.8 STA 37+50.
L86		3.494	S72° 40' 05.56"E	N 938851.1709 E 665356.8769 STA 37+50.07		N 938850.1 E 665360.2 STA 37+53.
L87		1.489	S73° 01' 13.77"E	N 938850.1300 E 665360.2125 STA 37+53.56		N 938849.6 E 665361.6 STA 37+55.
L88		45.352	S81° 10' 29.74"E	N 938849.6953 E 665361.6361 STA 37+55.05		N 938842.7 E 665406.4 STA 38+00.

NOTES ADD:

THE HORIZONTAL DATUM IS NAD83(HARN) STATE PLANE, ARIZONA CENTRAL ZONE ADJUSTED FROM GRID TO GROUND USING A COMBINATION SCALE FACTOR OF 1.000164 WITH A SCALE POINT OF X=0.0, Y=0.0


THE BASIS OF BEARING IS GEODETIC DENSIFICATION AND CADASTRAL SURVEY

ELEVATIONS ARE ON THE NGVD29 VERTICAL DATUM




9	ARIZ	ST83140121	20	50	
F.H.W.A. REGION	STATE	PROJ. NO.	NO.	TOTAL	AS BUILT

12/23 DATE: PHOENIX AS BS008 PHOENIX AZ BS008 PHOENI DRAWN: LNB

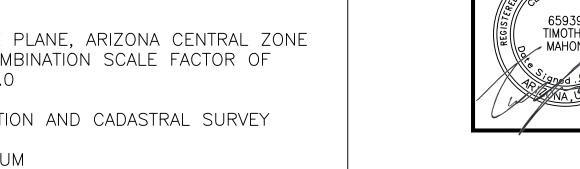



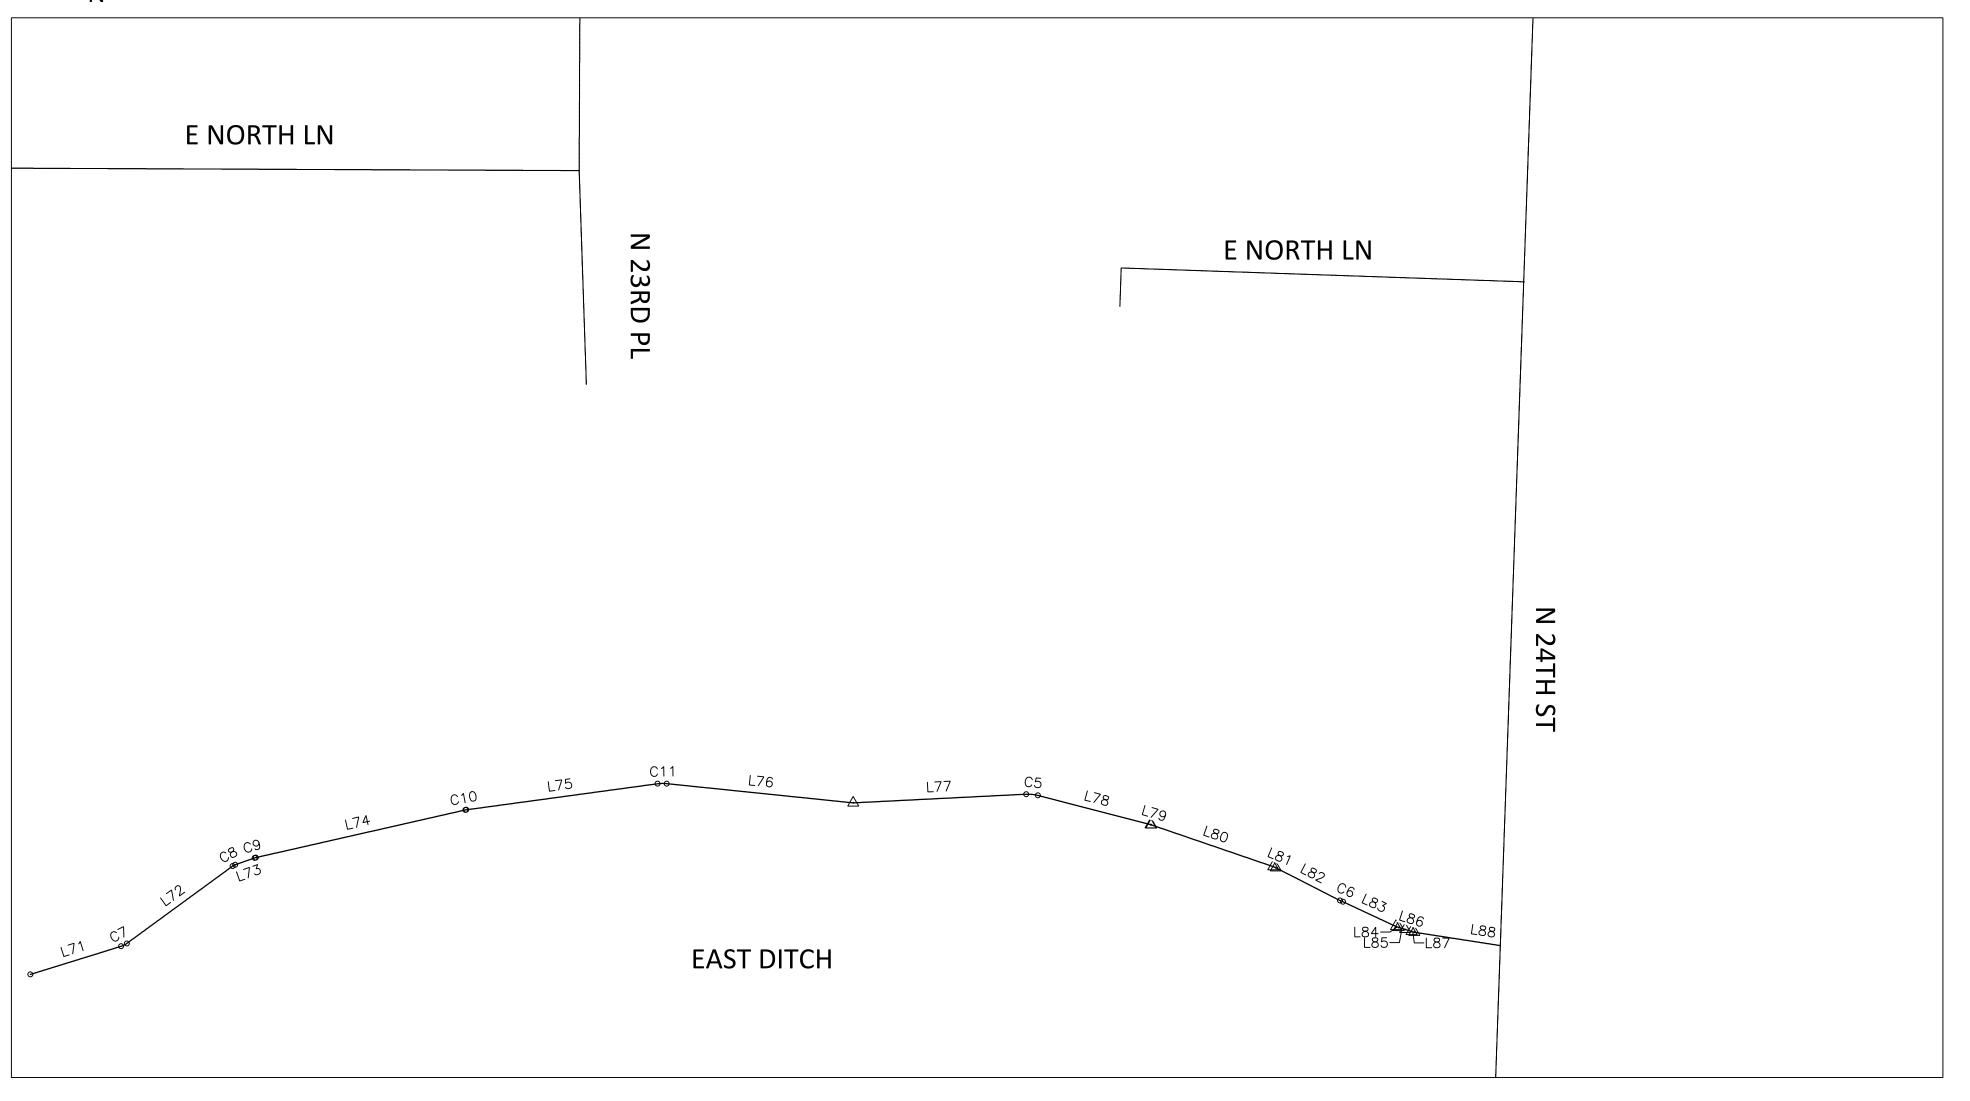



"PER CITY OF PHOENIX CITY CODE CHAPTER 2, SECTION 2-28 THESE PLANS ARE FOR OFFICIAL USE ONLY & MAY NOT BE SHARED WITH OTHERS EXCEPT AS REQUIRED TO FULFILL THE OBLIGATIONS OF THE CONTRACTOR'S CONTRACT WITH THE CITY OF PHOENIX."

GEOMETRIC CONTROL

CITY OF PHOENIX, ARIZONA STREET TRANSPORTATION DEPARTMENT

> NORTH LANE 22ND ST TO 24TH ST

DR: LNB DES: CJR CK: TMM
DATE: 12/23 DATE: 12/23 DATE: 12/23 DRAWING SERIES NO. SCALE: 1"=100' HORIZONTAL G-2.02

 $\hbox{C:} \verb|\pw_working\pw_prod\cragan\dms64452\ST83140125CTL-03_2.dwg | \cragan\dms64452\ST83140125CTL-03_2.dwg | \cragan\dms64452\ST84140125CTL-03_2.dwg | \cragan\dms644452\ST84140125CTL-03_2.dwg | \cragan\dms644452\ST8414012$


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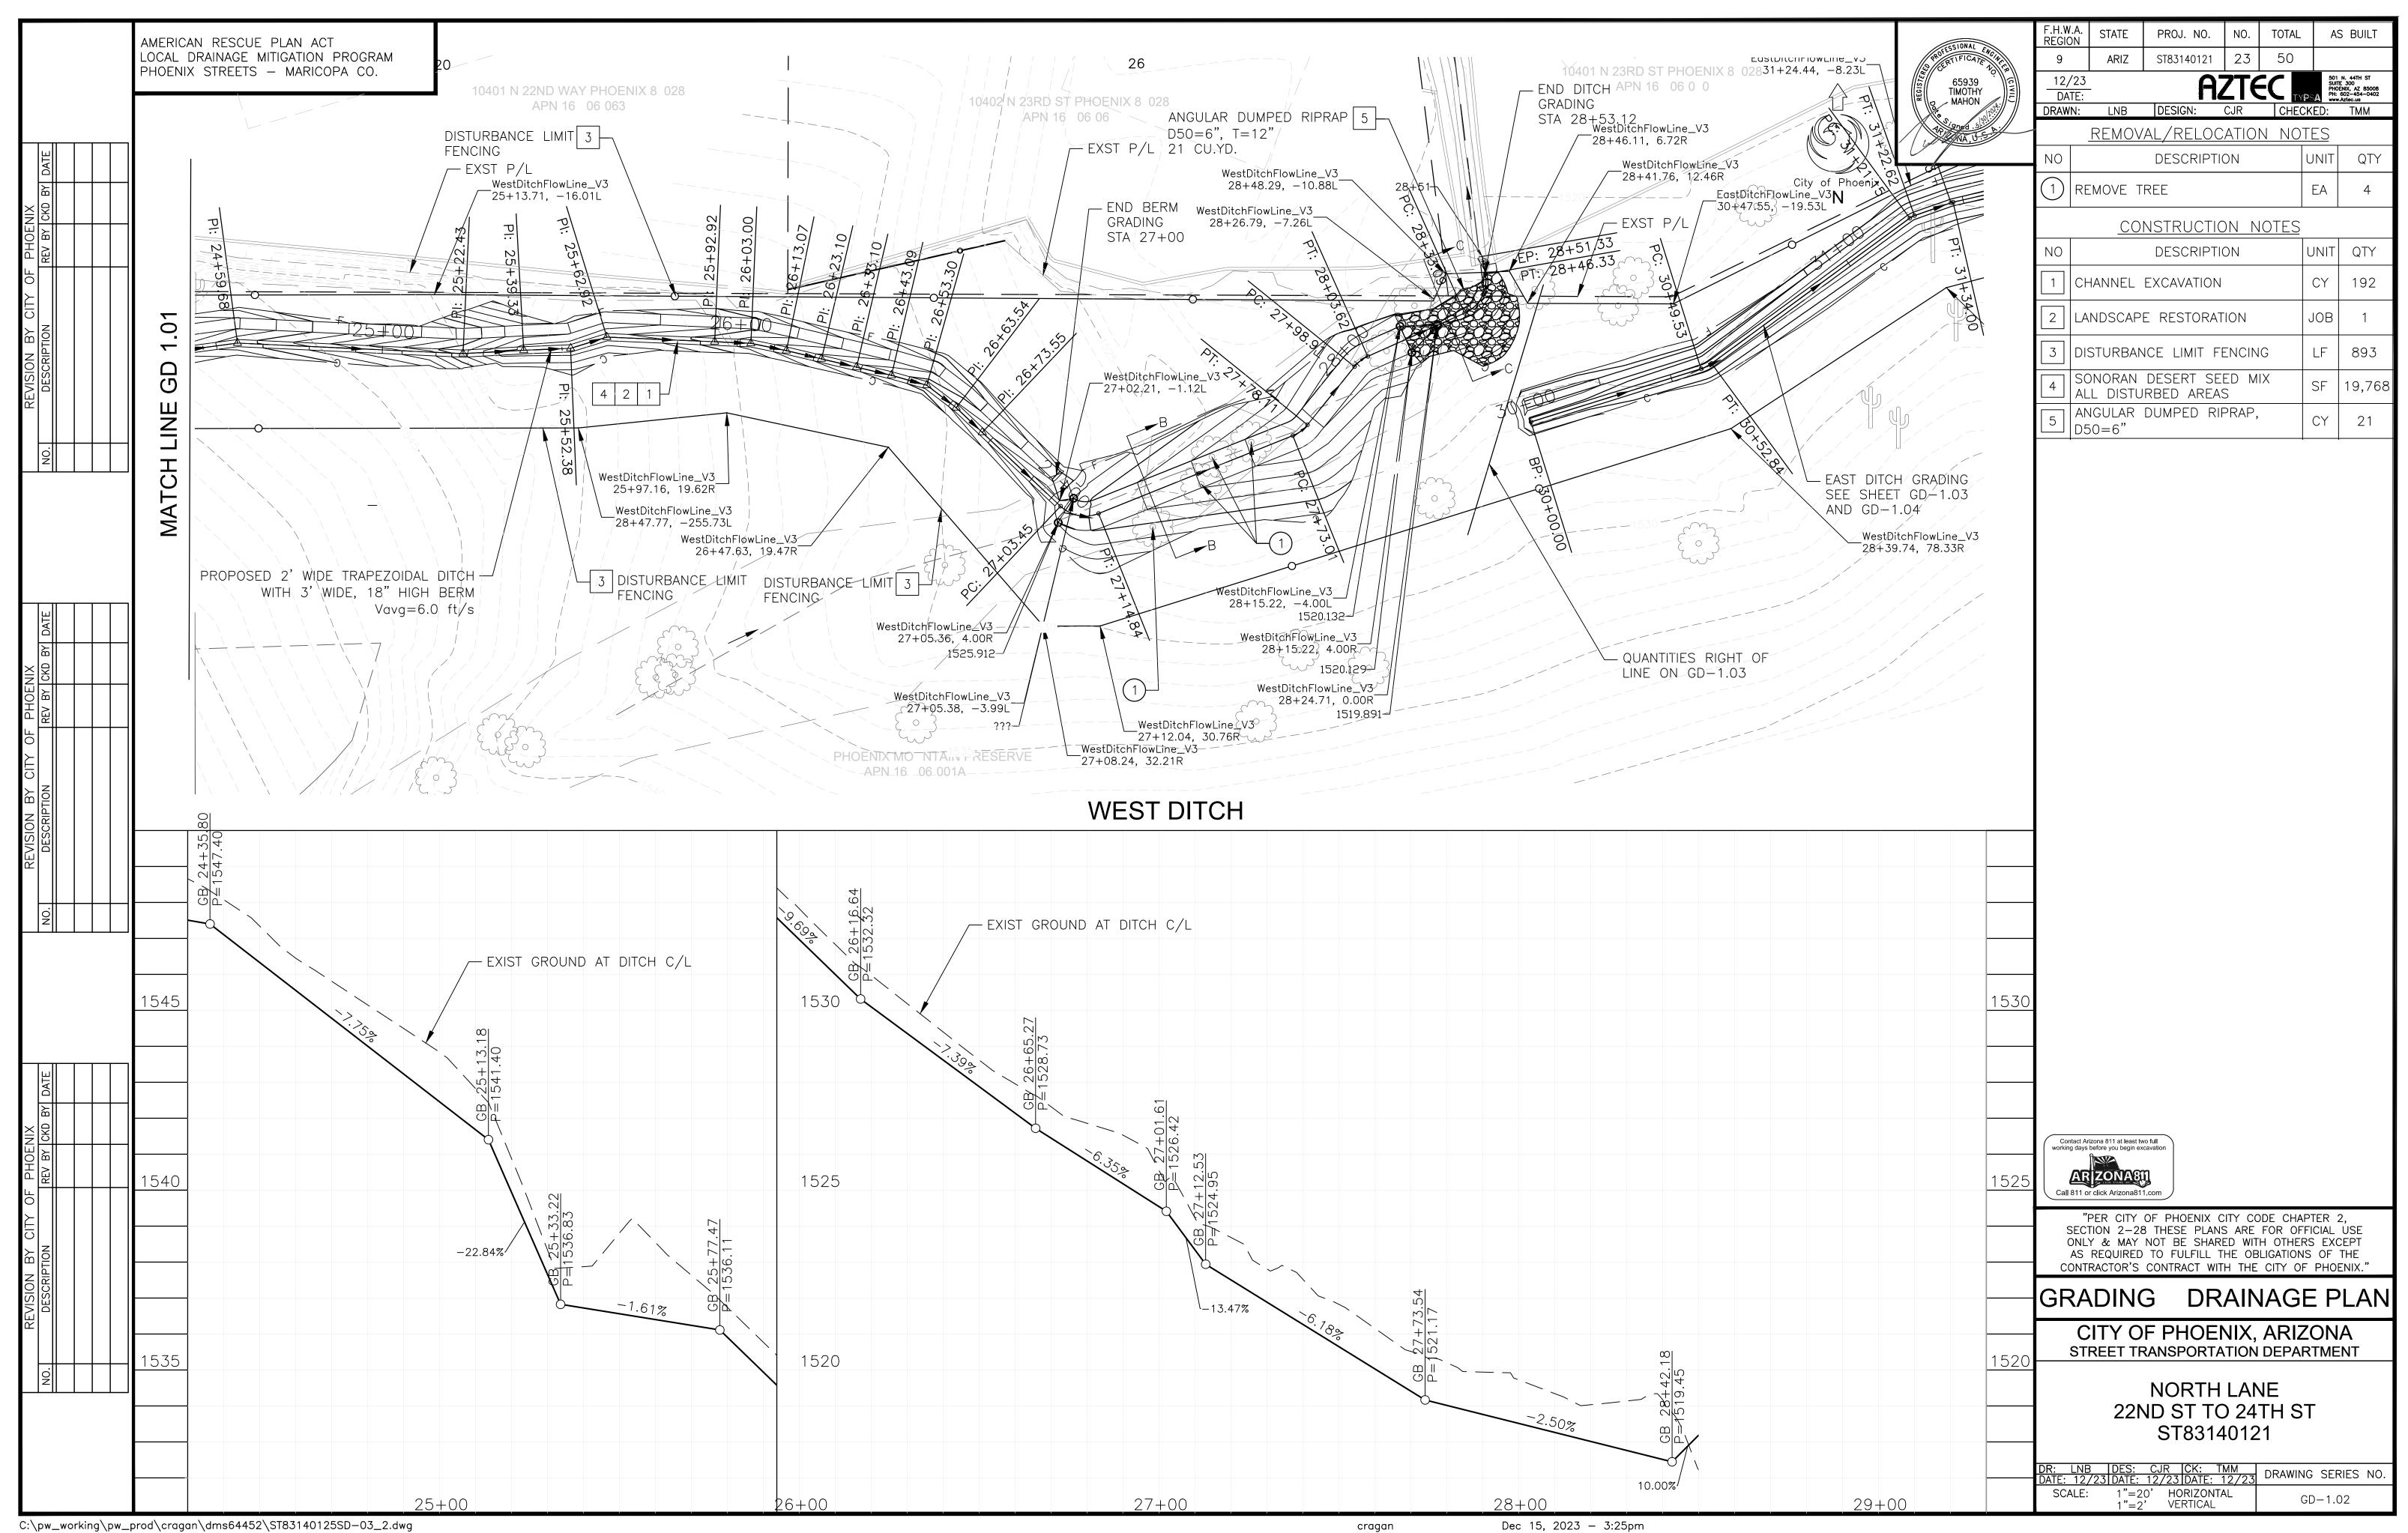
ST83140121


Dec 11, 2023 - 3:45pm


PROJ. NO. NO. TOTAL AS BUILT REGION AMERICAN RESCUE PLAN ACT LOCAL DRAINAGE MITIGATION PROGRAM ARIZ ST83140121 21 PHOENIX STREETS - MARICOPA CO. 12/23 65939 TIMOTHY DATE: S MMARY ANTITY ر MAHON 🖊 ي DRAWN: LNB DESIGN: CJR CHECKED: TMM ITEM No. DESCRIPTION NIT SHEET N MBERS TOTAL TY M###### (DESCRIPTION) NIT TOTAL TY GD 1.01 GD 1.02 GD 1.03 LS 1.03 LS 1.04 GD 1.04 LS 1.01 LS 1.02 M1042007 LANDSCAPE RESTORATION OB 1 0 M2152001 CHANNEL EXCAVATION CY 61 192 110 55 0 0 418 M2200007 | RIP RAP, D 0 6" 30 CY 21 9 0 M3001002 SAWC T REMOVE EXISTING C RB G TTER 9 9 0 0 M300100 SAWC T REMOVE EXISTING SIDEWALK SF 0 54 54 0 0 0 0 0 M3360224 SAWC T, REMOVE AND REPLACE A.C. PAVEMENT, C.O.P. STANDARD DETAIL P 1200 0 2 0 0 0 2 0 M3362002 | SL RRY SEAL COAT 268 SY 0 0 268 0 0 0 0 M3 001 0 REMOVE TREE 6 INCH CALIPER OR LARGER EΑ 10 4 0 0 0 4 0 M41 310 | SAFETY RAIL, MAG DETAIL 14 LF 0 10 0 10 0 0 0 0 M4200008 | TEMPORARY FENCE DIST RBANCE LIMIT FENCE 1,237 4,016 LF 893 1,108 778 0 0 0 19,768 19,944 18,540 13,617 71,869 HYDROSEED, TYPE A SONORAN DESERT MIX M430 00 SF 0 0 0 0 M430 800 | CACTI, TRANSPLANT EΑ 27 0 0 0 2 0 23 2 M430 820 SAG ARO, TRANSPLANTING EΑ 0 0 0 0 0 0 1 M 0 1 02 CONCRETE CATCH BASIN, TYPE "F", MAG DETAIL 3 EΑ 0 1 0 1 M 0 2063 | CONCRETE SC PPER, MAG STANDARD DETAIL 206 EΑ 0 0 0 0 0 0 1 M 0 008 | HEADWALL FOR 1 "PIPE, MAG STANDARD DETAILS 01 1 AND 01 2 EΑ 0 0 0 0 1 0 M621001 1 "C.M.P., 12 GA GE 37 LF 0 37 0 **KEY MAP** SHEA BO LEVARD City of Phoenix NORTH LANE "PER CITY OF PHOENIX CITY CODE CHAPTER 2, SECTION 2-28 THESE PLANS ARE FOR OFFICIAL USE ONLY & MAY NOT BE SHARED WITH OTHERS EXCEPT AS REQUIRED TO FULFILL THE OBLIGATIONS OF THE GD 1.04 GD 1.03 CONTRACTOR'S CONTRACT WITH THE CITY OF PHOENIX." GD 1.01 GD 1.02 ANTITY S MMARY CITY OF PHOENIX, ARIZONA STREET TRANSPORTATION DEPARTMENT NORTH LANE 22ND ST TO 24TH ST ST83140121 DR: LNB DES: CJR CK: TMM
DATE: 12/23 DATE: 12/23 DATE: 12/23 DRAWING SERIES NO. SCALE: NONE G - 3.01


cragan




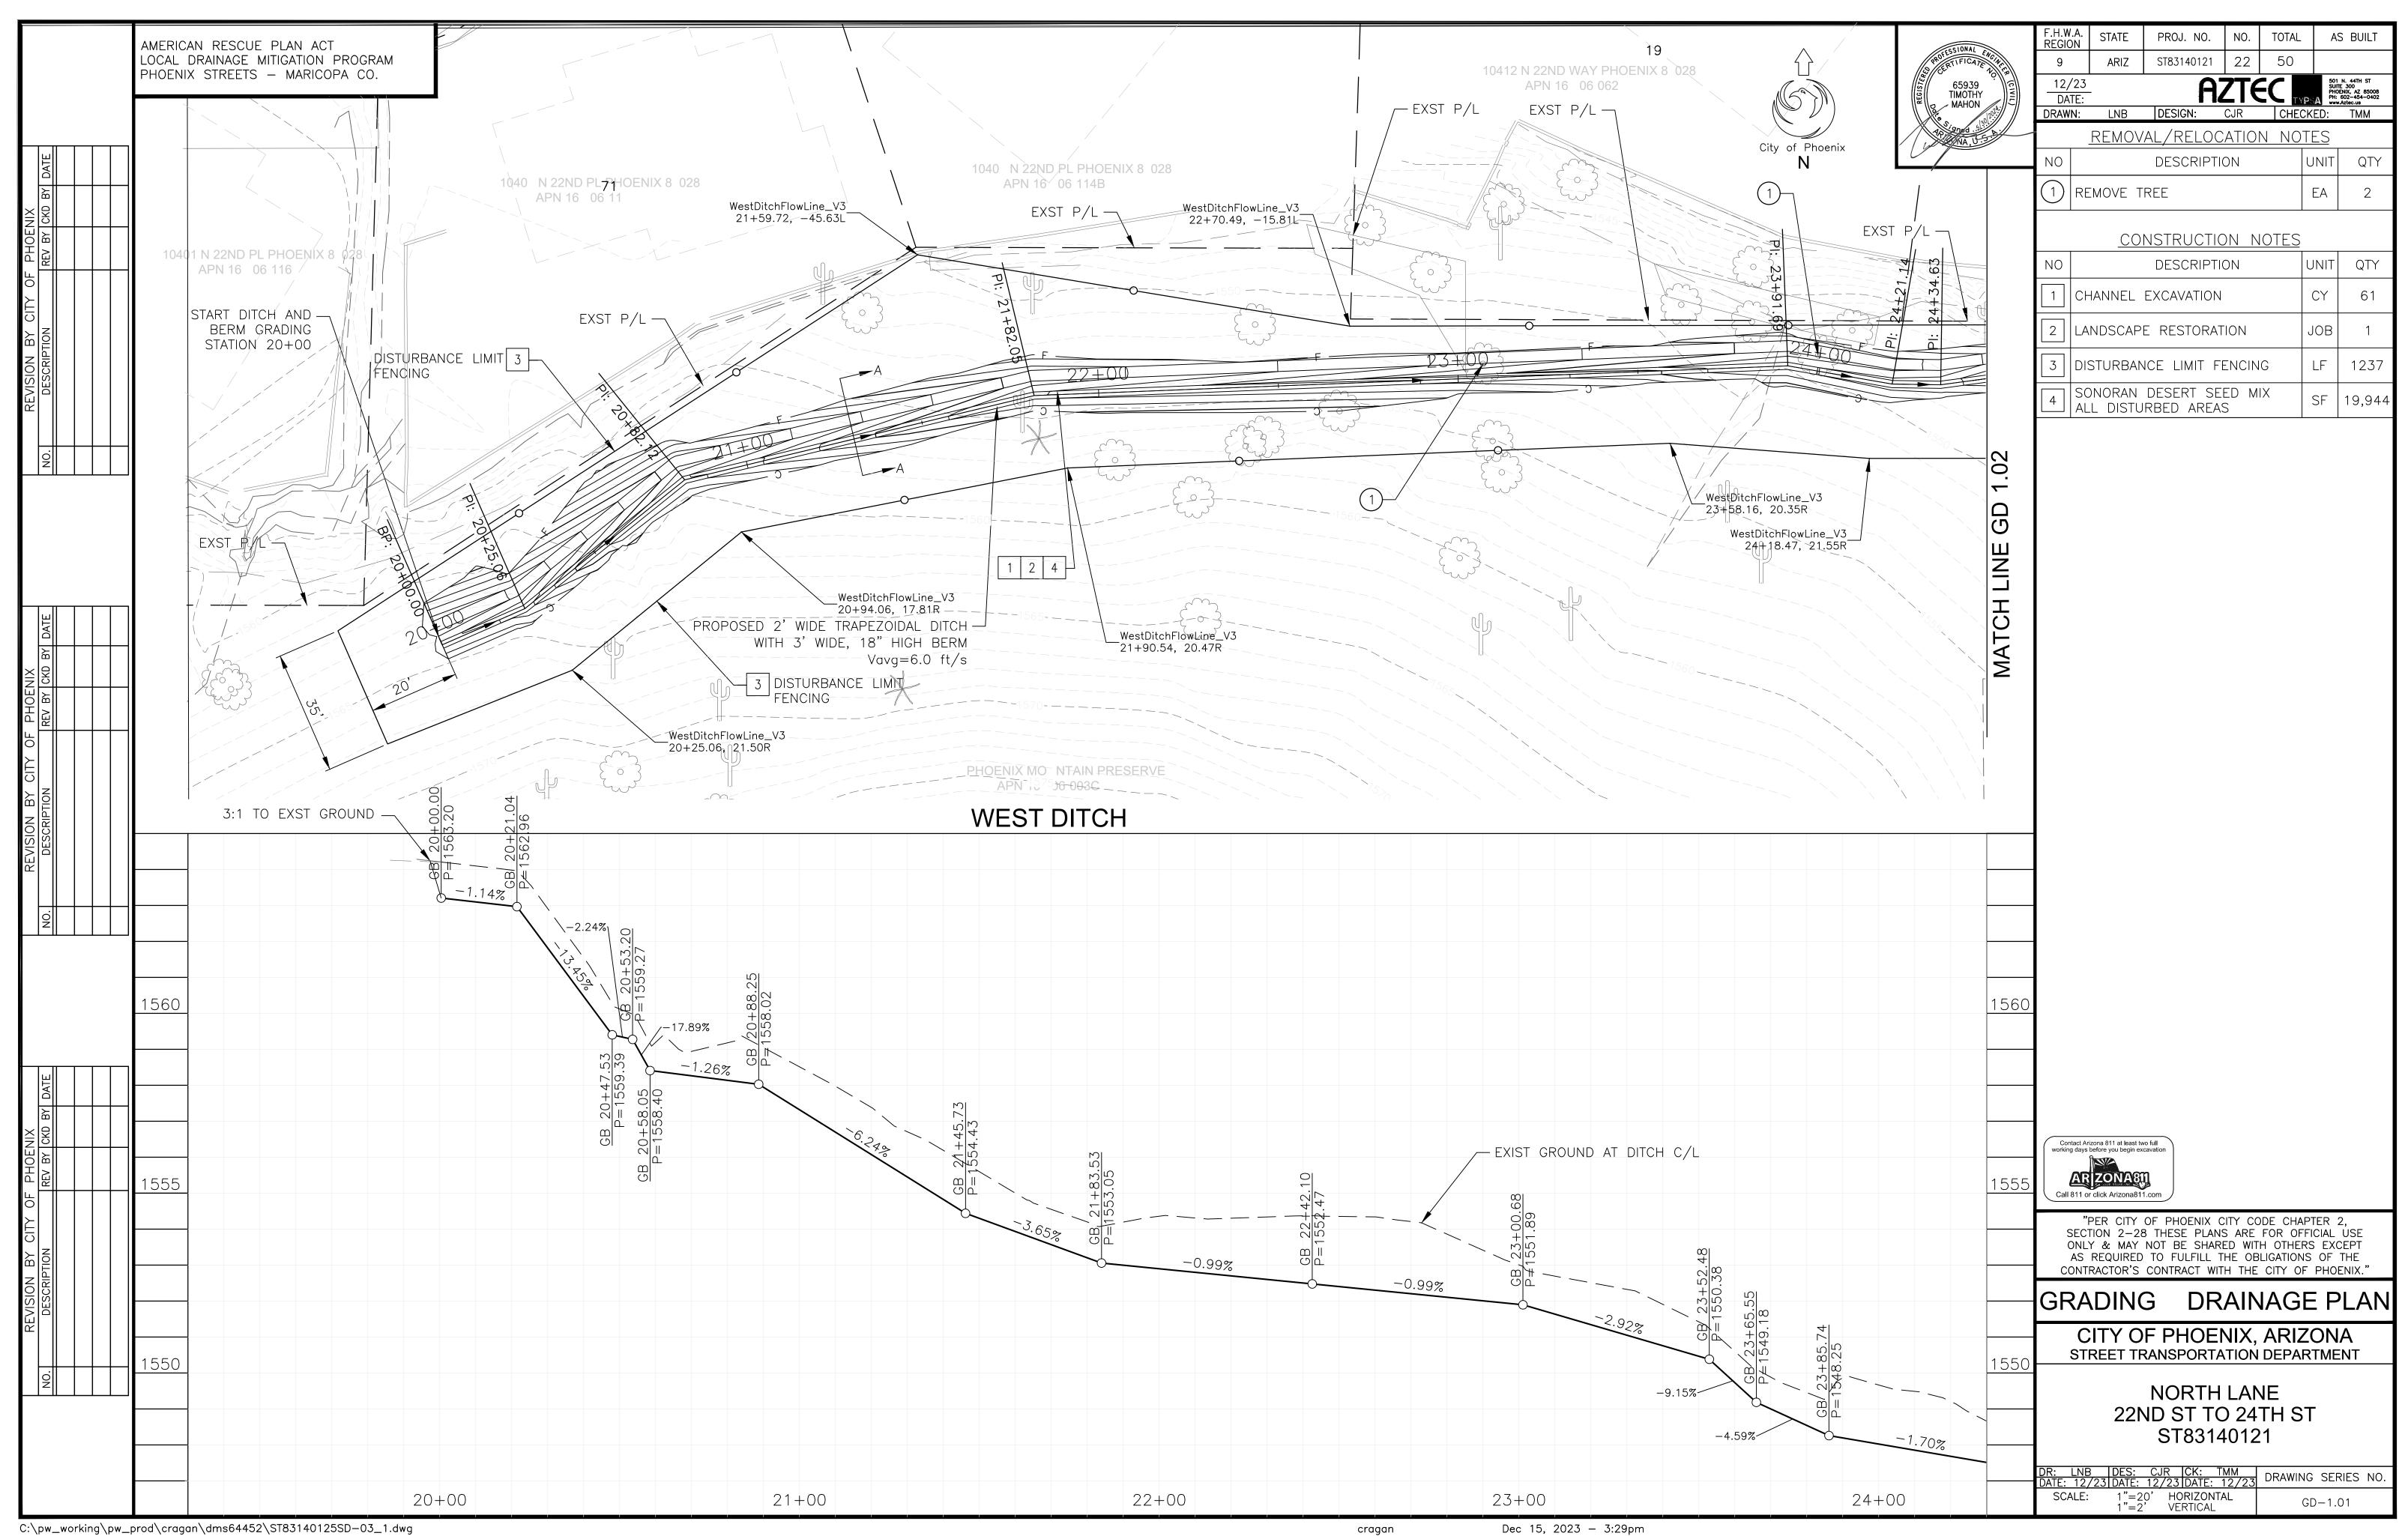

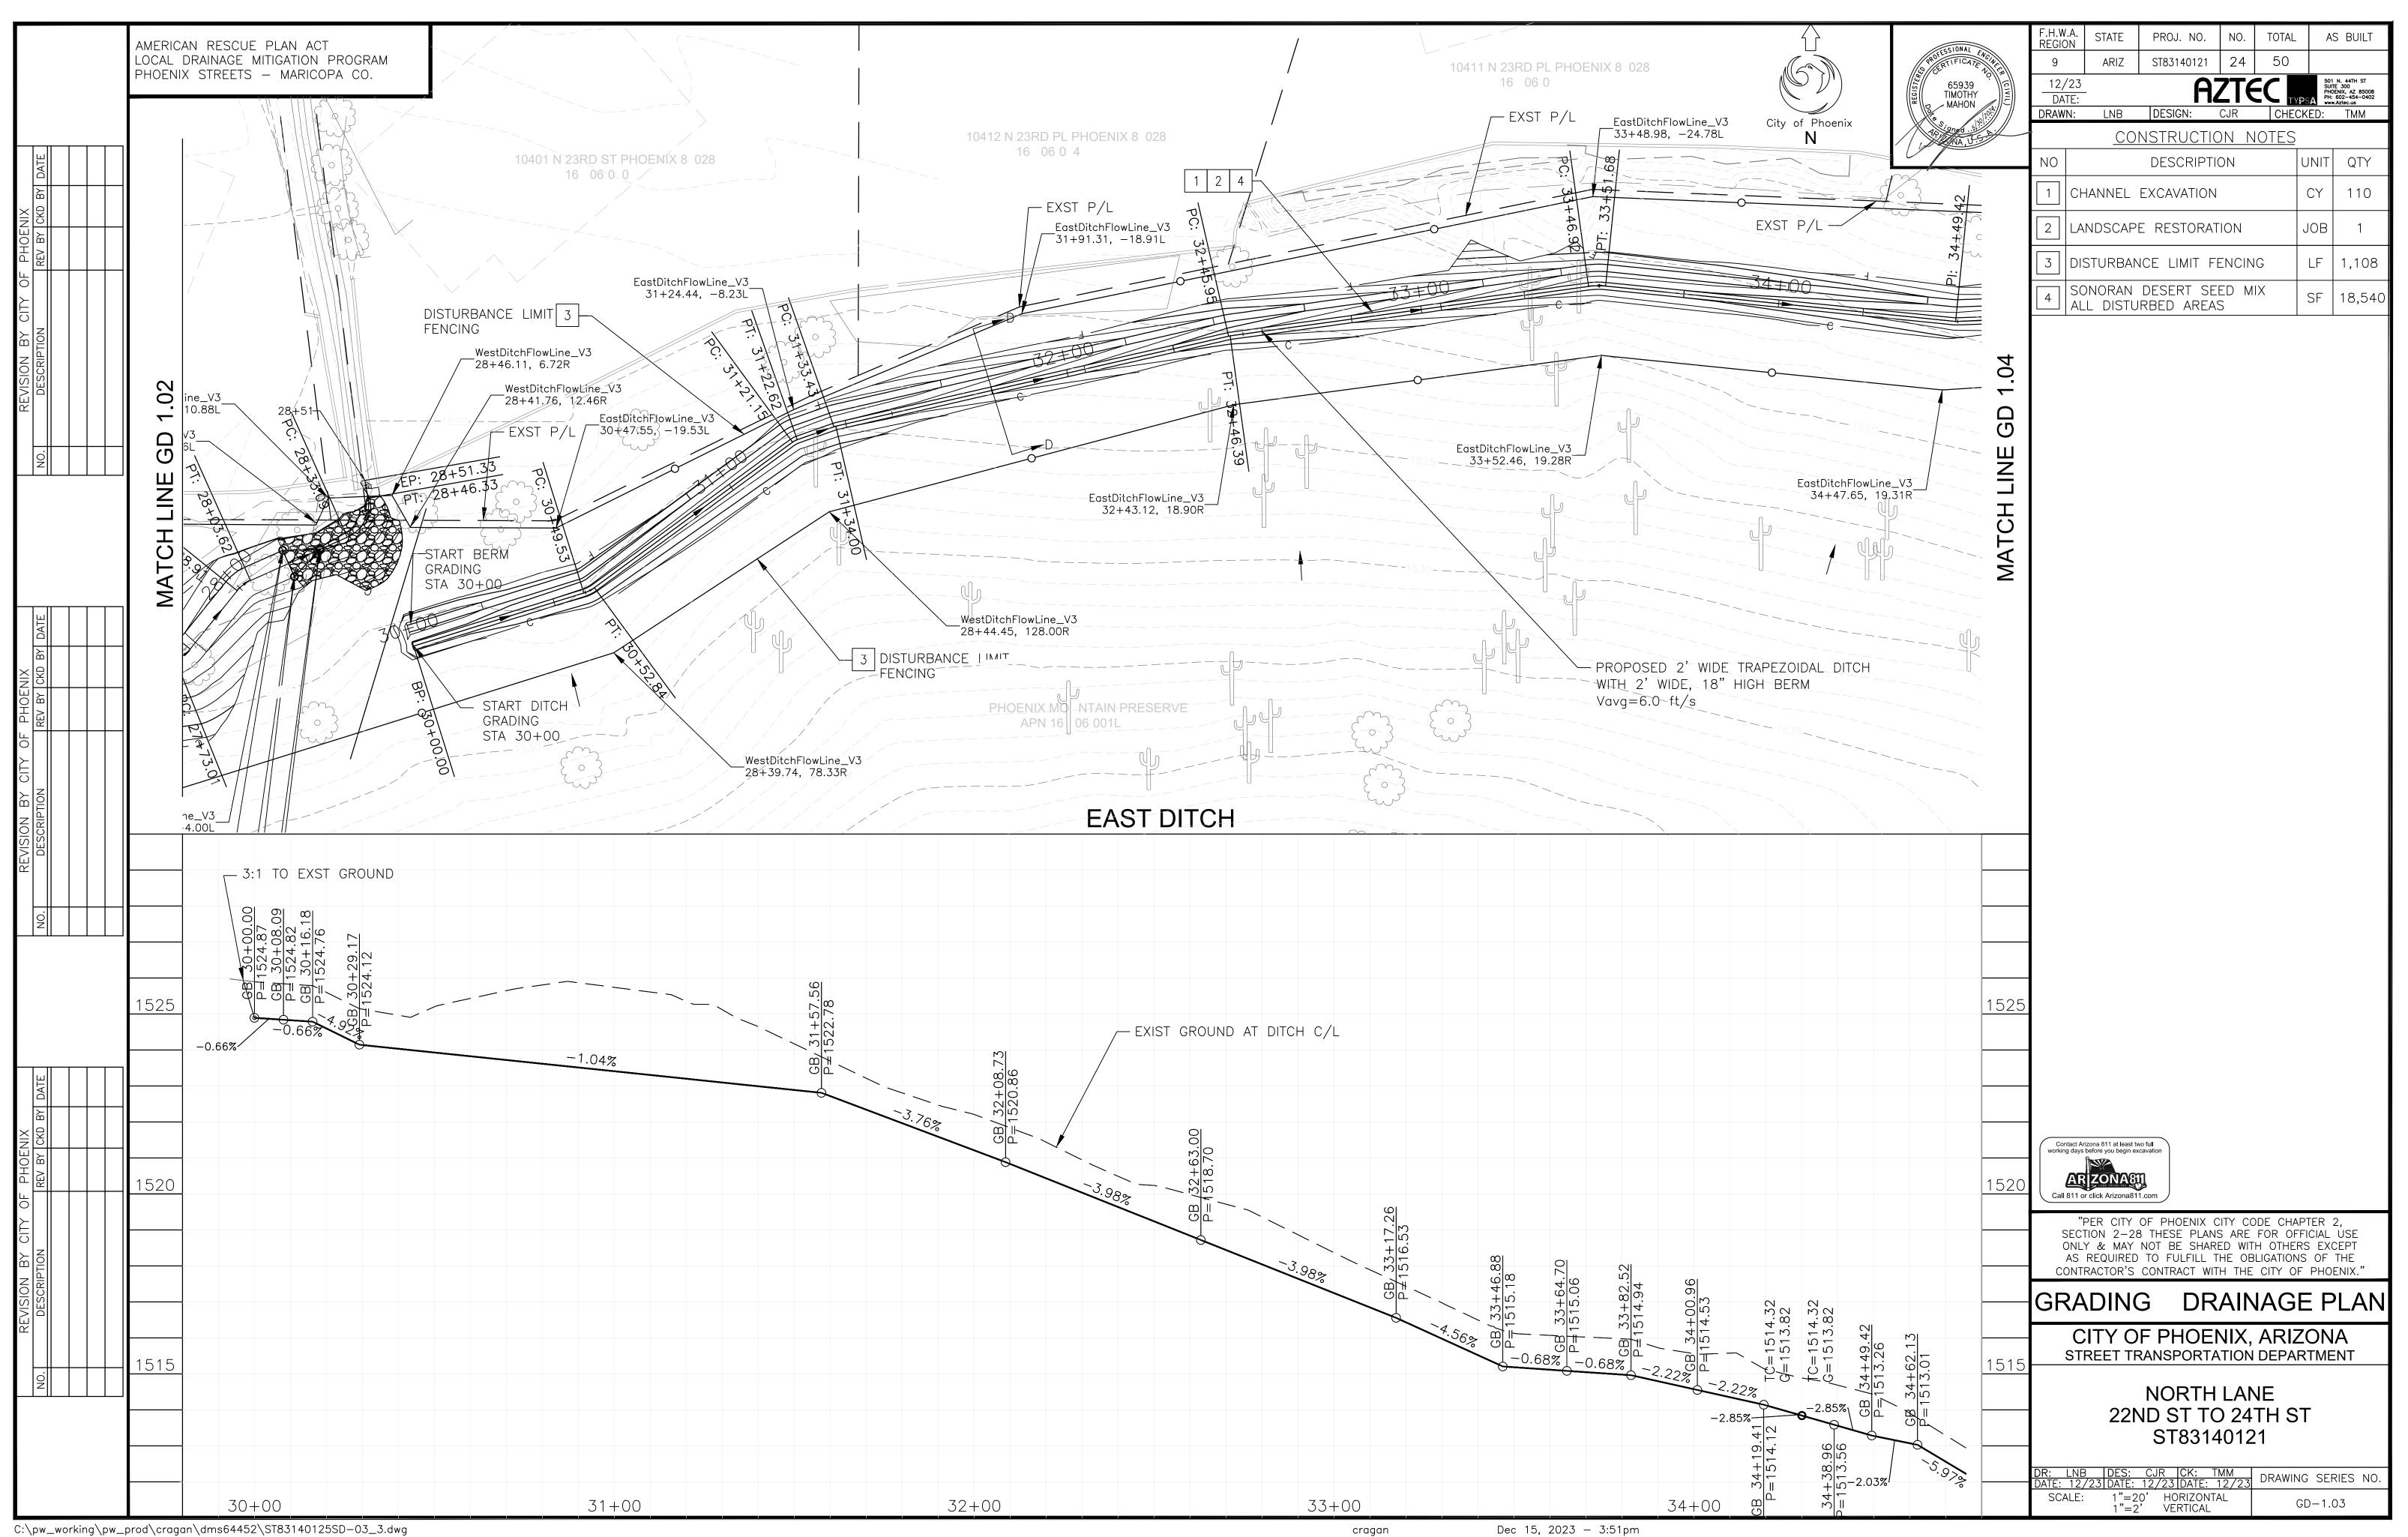

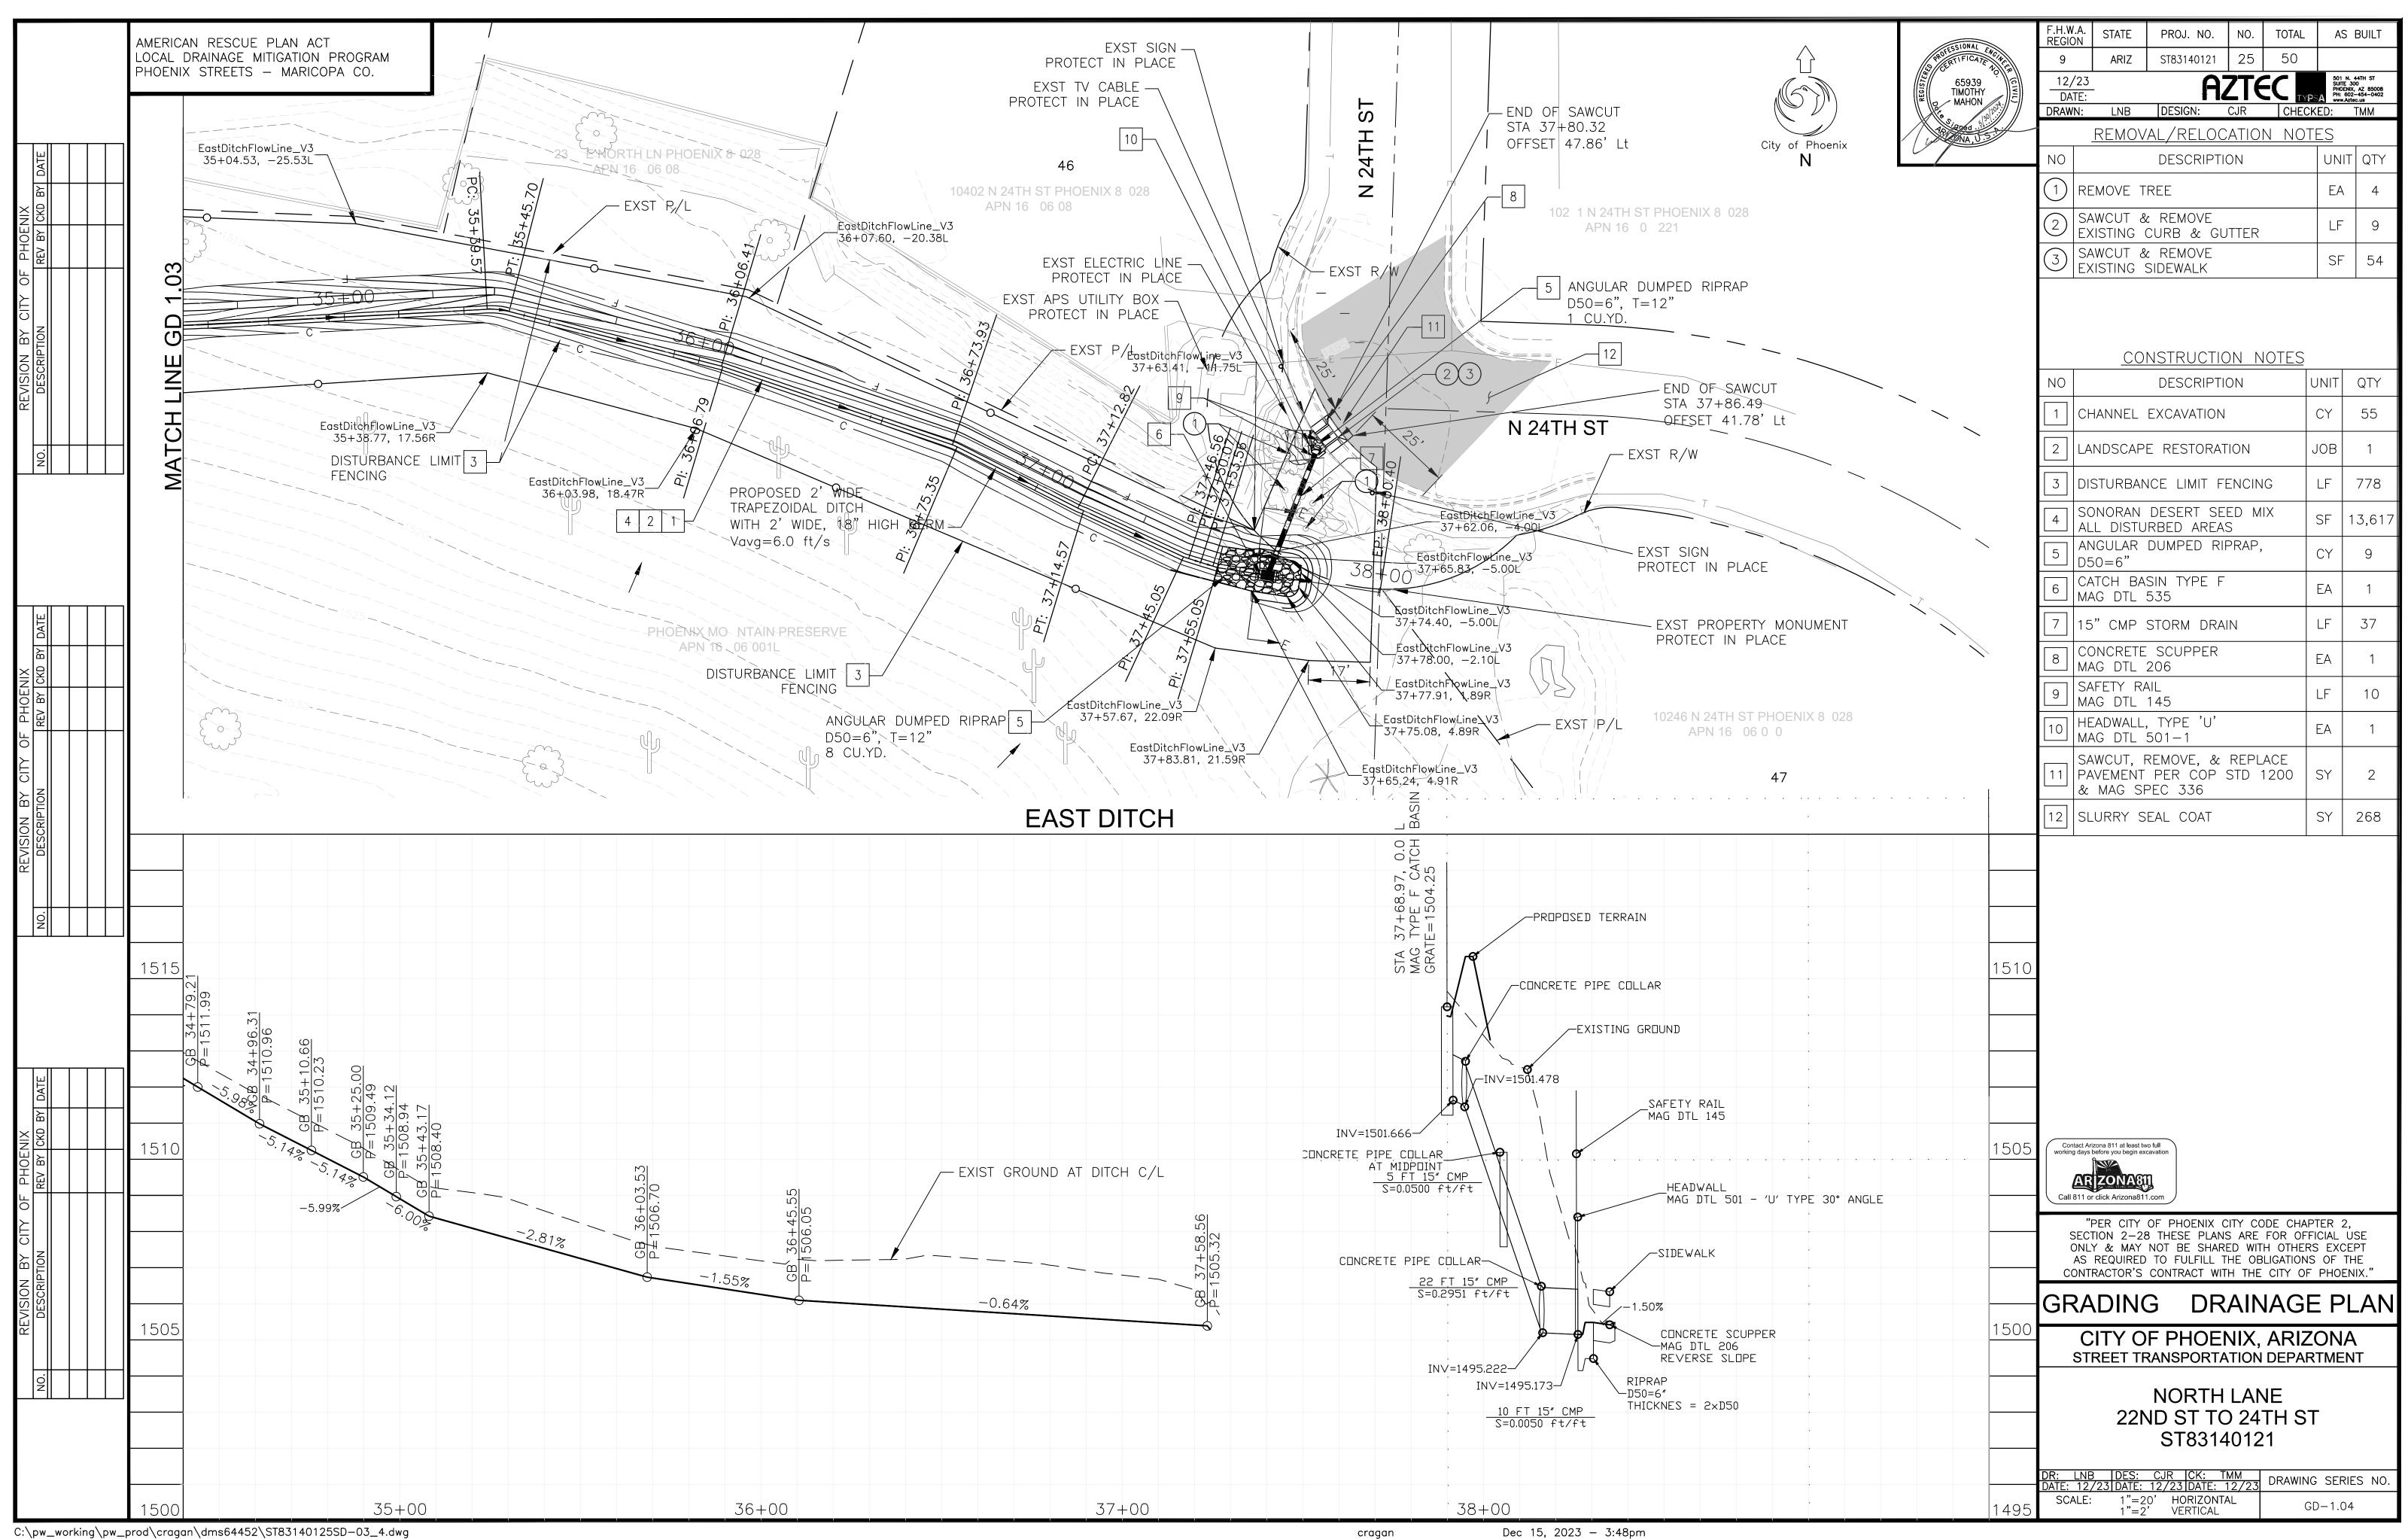

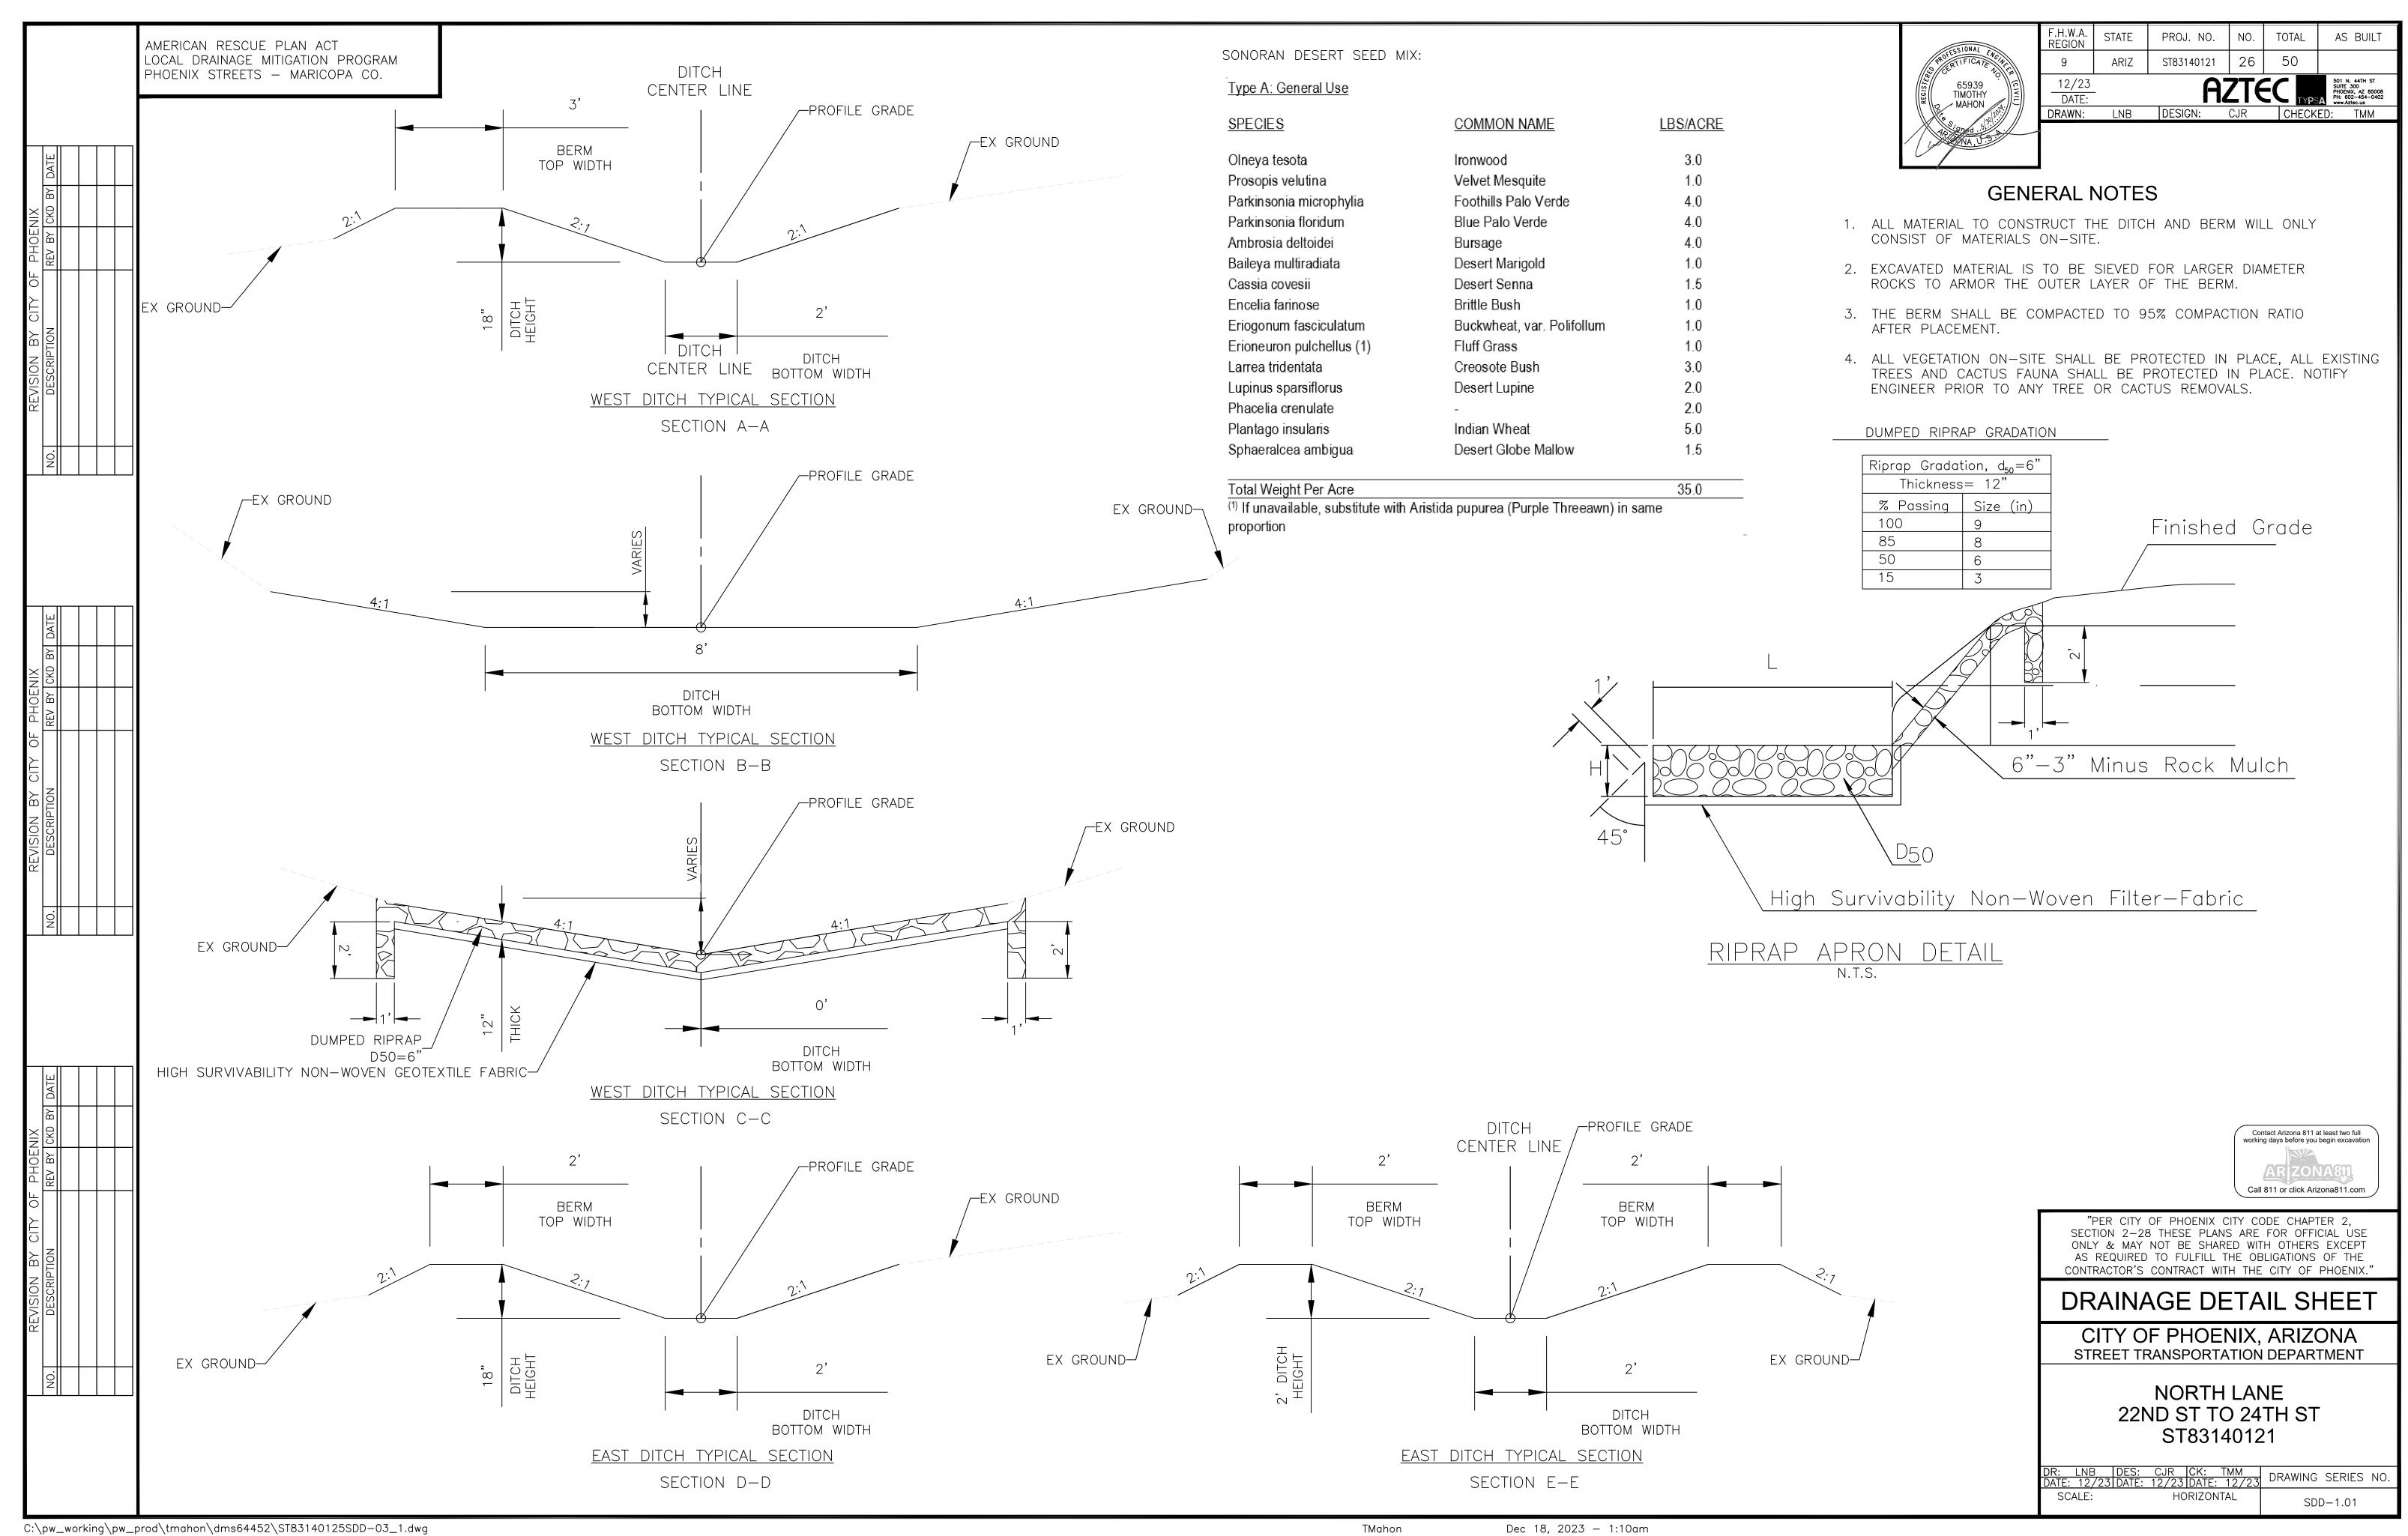

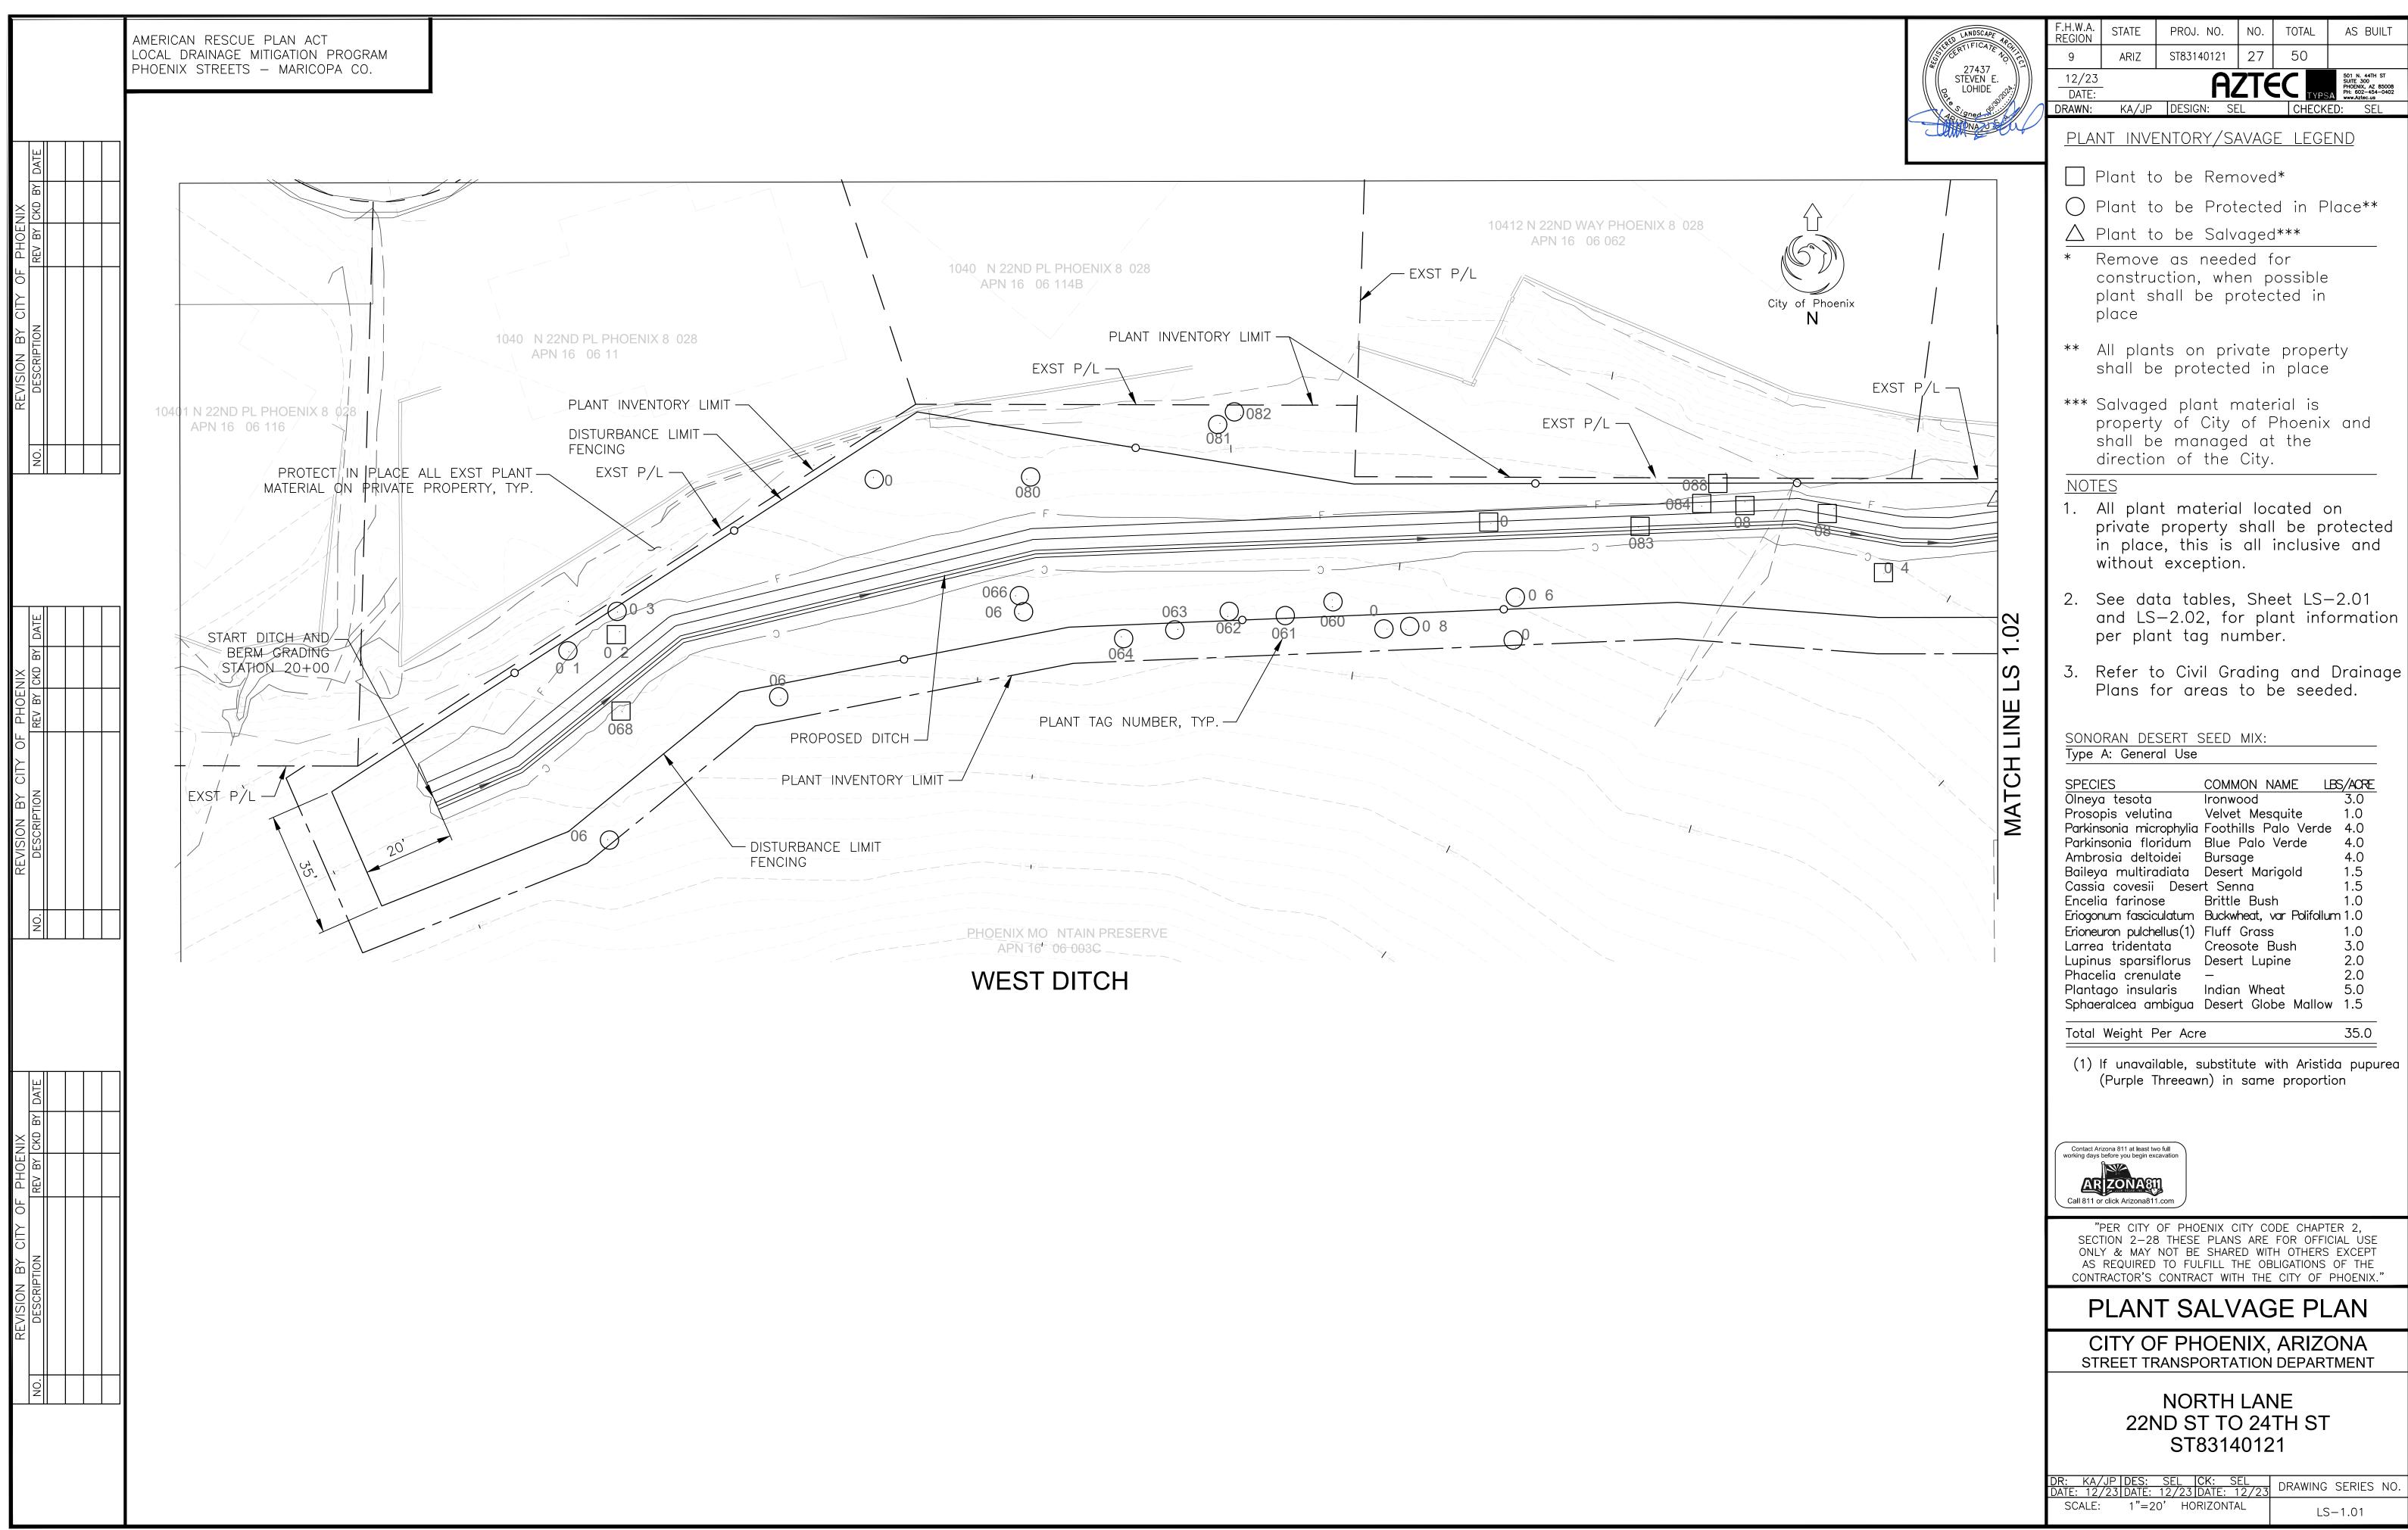

JPerillo

AMERICAN RESCUE PLAN ACT LOCAL DRAINAGE MITIGATION PROGRAM PHOENIX STREETS - MARICOPA CO. 26 EXST P/L 10401 N 22ND WAY PHOENIX 8 028 10402 N 23RD ST PHOENIX 8 028 APN 16 06 063 APN 16 06 06 PROTECT IN PLACE ALL EXST PLANT — MATERIAL ON PRIVATE PROPERTY, TYP. City of Phoenix PLANT INVENTORY LIMIT — EXST P/L-DISTURBANCE LIMIT-EXST P/L-FENCING – END BERM GRADING STA 27+00 MAT PROPOSED DITCH -UDISTURBANCE LIMIT FENCING PLANT TAG NUMBER, TYP. -DISTURBANCE LIMIT FENCING - PLANT INVENTORY LIMIT PHOENIX MO NTAIN PRESERVE APN 16 06 001A WEST DITCH



F.H.W.A. REGION	STATE	PROJ. NO.	NO.	TOTAL	AS BUILT
9	ARIZ	ST83140121	28	50	

12/23 DATE:

AZTEC TYPSA S01 N. 44TH ST SUITE 300 PHOENIX, AZ 85008 PH: 602-454-0402 www.xetec.us DRAWN: KA/JP DESIGN: SEL

PLANT INVENTORY/SAVAGE LEGEND

- Plant to be Removed*
- Plant to be Protected in Place**
- △ Plant to be Salvaged***
- * Remove as needed for construction, when possible plant shall be protected in place
- ** All plants on private property shall be protected in place
- *** Salvaged plant material is property of City of Phoenix and shall be managed at the direction of the City.

NOTES

- 1. All plant material located on private property shall be protected in place, this is all inclusive and without exception.
- 2. See data tables, Sheet LS-2.01 and LS-2.02, for plant information per plant tag number.
- 3. Refer to Civil Grading and Drainage Plans for areas to be seeded.

SONORAN DESERT SEED MIX: Type A: General Use

COMMON NAME LBS/ACRE SPECIES Olneya tesota Prosopis velutina Velvet Mesquite Parkinsonia microphylia Foothills Palo Verde 4.0 Parkinsonia floridum Blue Palo Verde 4.0 Ambrosia deltoidei Bursage Baileya multiradiata Desert Marigold Cassia covesii Desert Senna 1.5 Encelia farinose Brittle Bush 1.0 Eriogonum fasciculatum Buckwheat, var Polifollum 1.0 Erioneuron pulchellus(1) Fluff Grass Larrea tridentata Creosote Bush 1.0 3.0 2.0 Lupinus sparsiflorus Desert Lupine

Sphaeralcea ambigua Desert Globe Mallow 1.5 Total Weight Per Acre

Plantago insularis Indian Wheat

Phacelia crenulate —

(1) If unavailable, substitute with Aristida pupurea (Purple Threeawn) in same proportion

2.0

5.0

35.0



"PER CITY OF PHOENIX CITY CODE CHAPTER 2, SECTION 2-28 THESE PLANS ARE FOR OFFICIAL USE ONLY & MAY NOT BE SHARED WITH OTHERS EXCEPT AS REQUIRED TO FULFILL THE OBLIGATIONS OF THE CONTRACTOR'S CONTRACT WITH THE CITY OF PHOENIX."


PLANT SALVAGE PLAN

CITY OF PHOENIX, ARIZONA STREET TRANSPORTATION DEPARTMENT


> NORTH LANE 22ND ST TO 24TH ST ST83140121

DR: KA/JP DES: SEL CK: SEL DRAWING SERIES NO. SCALE: 1"=20' HORIZONTAL LS-1.02

kantill

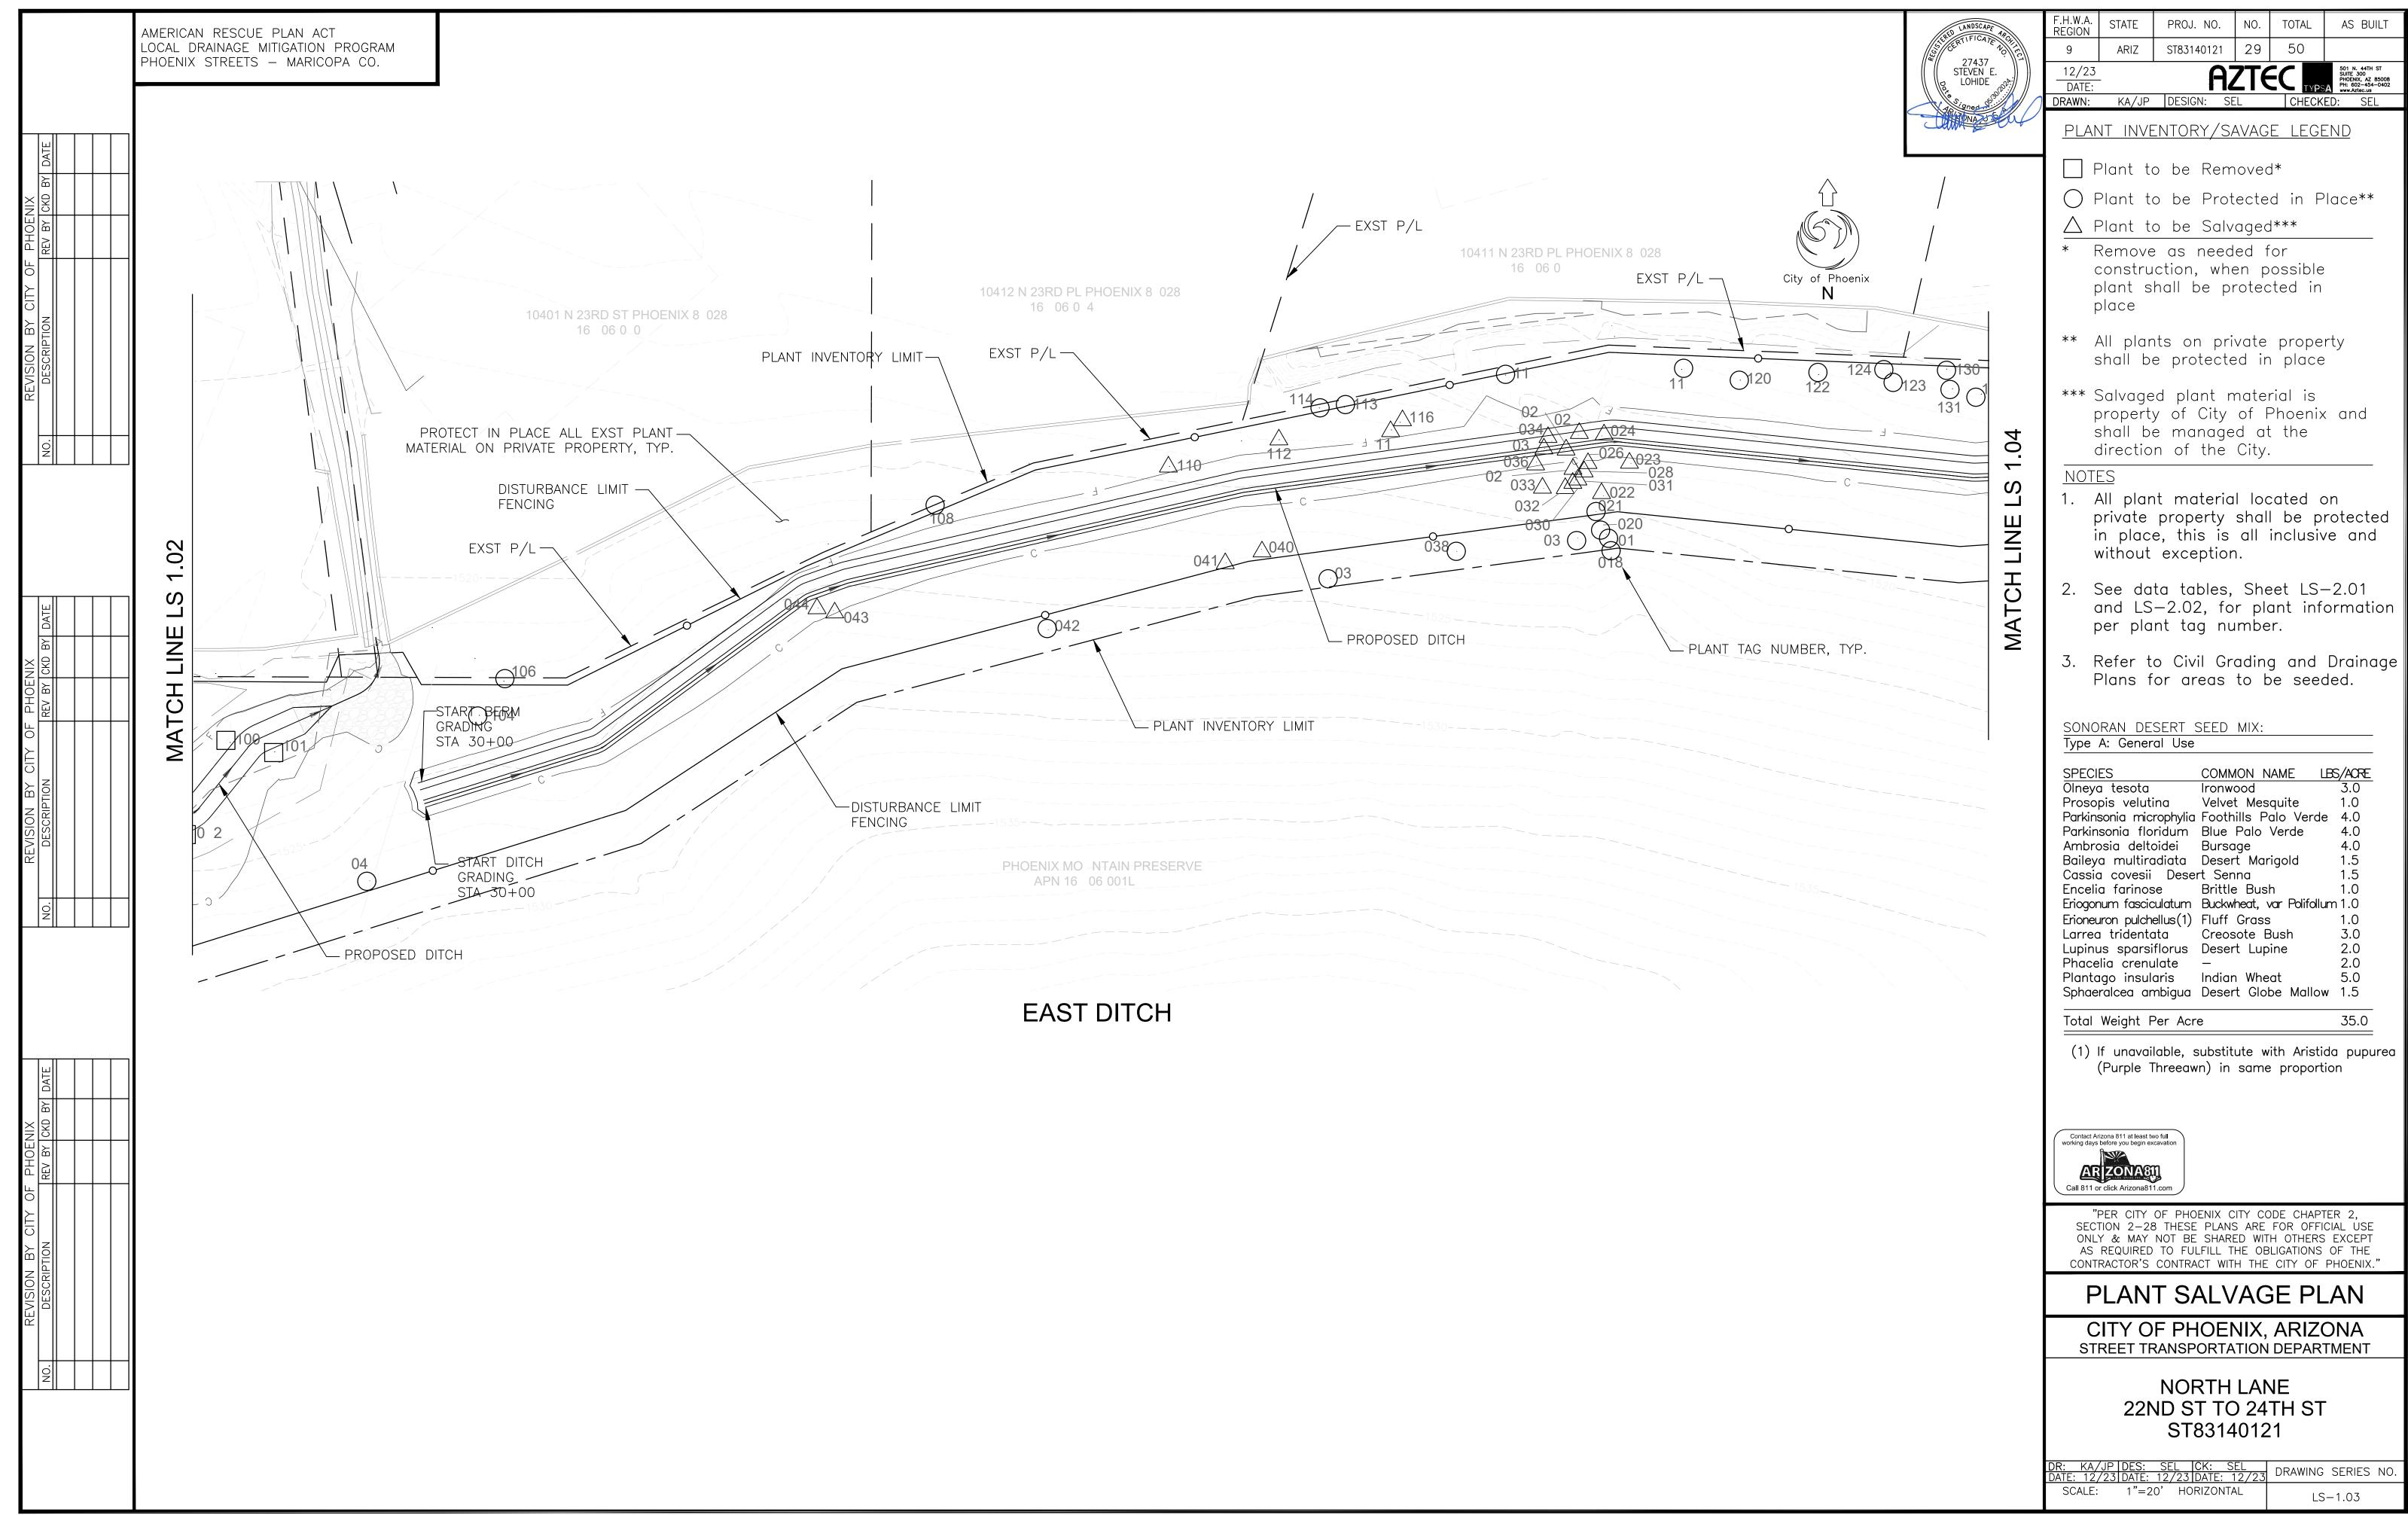

kantill

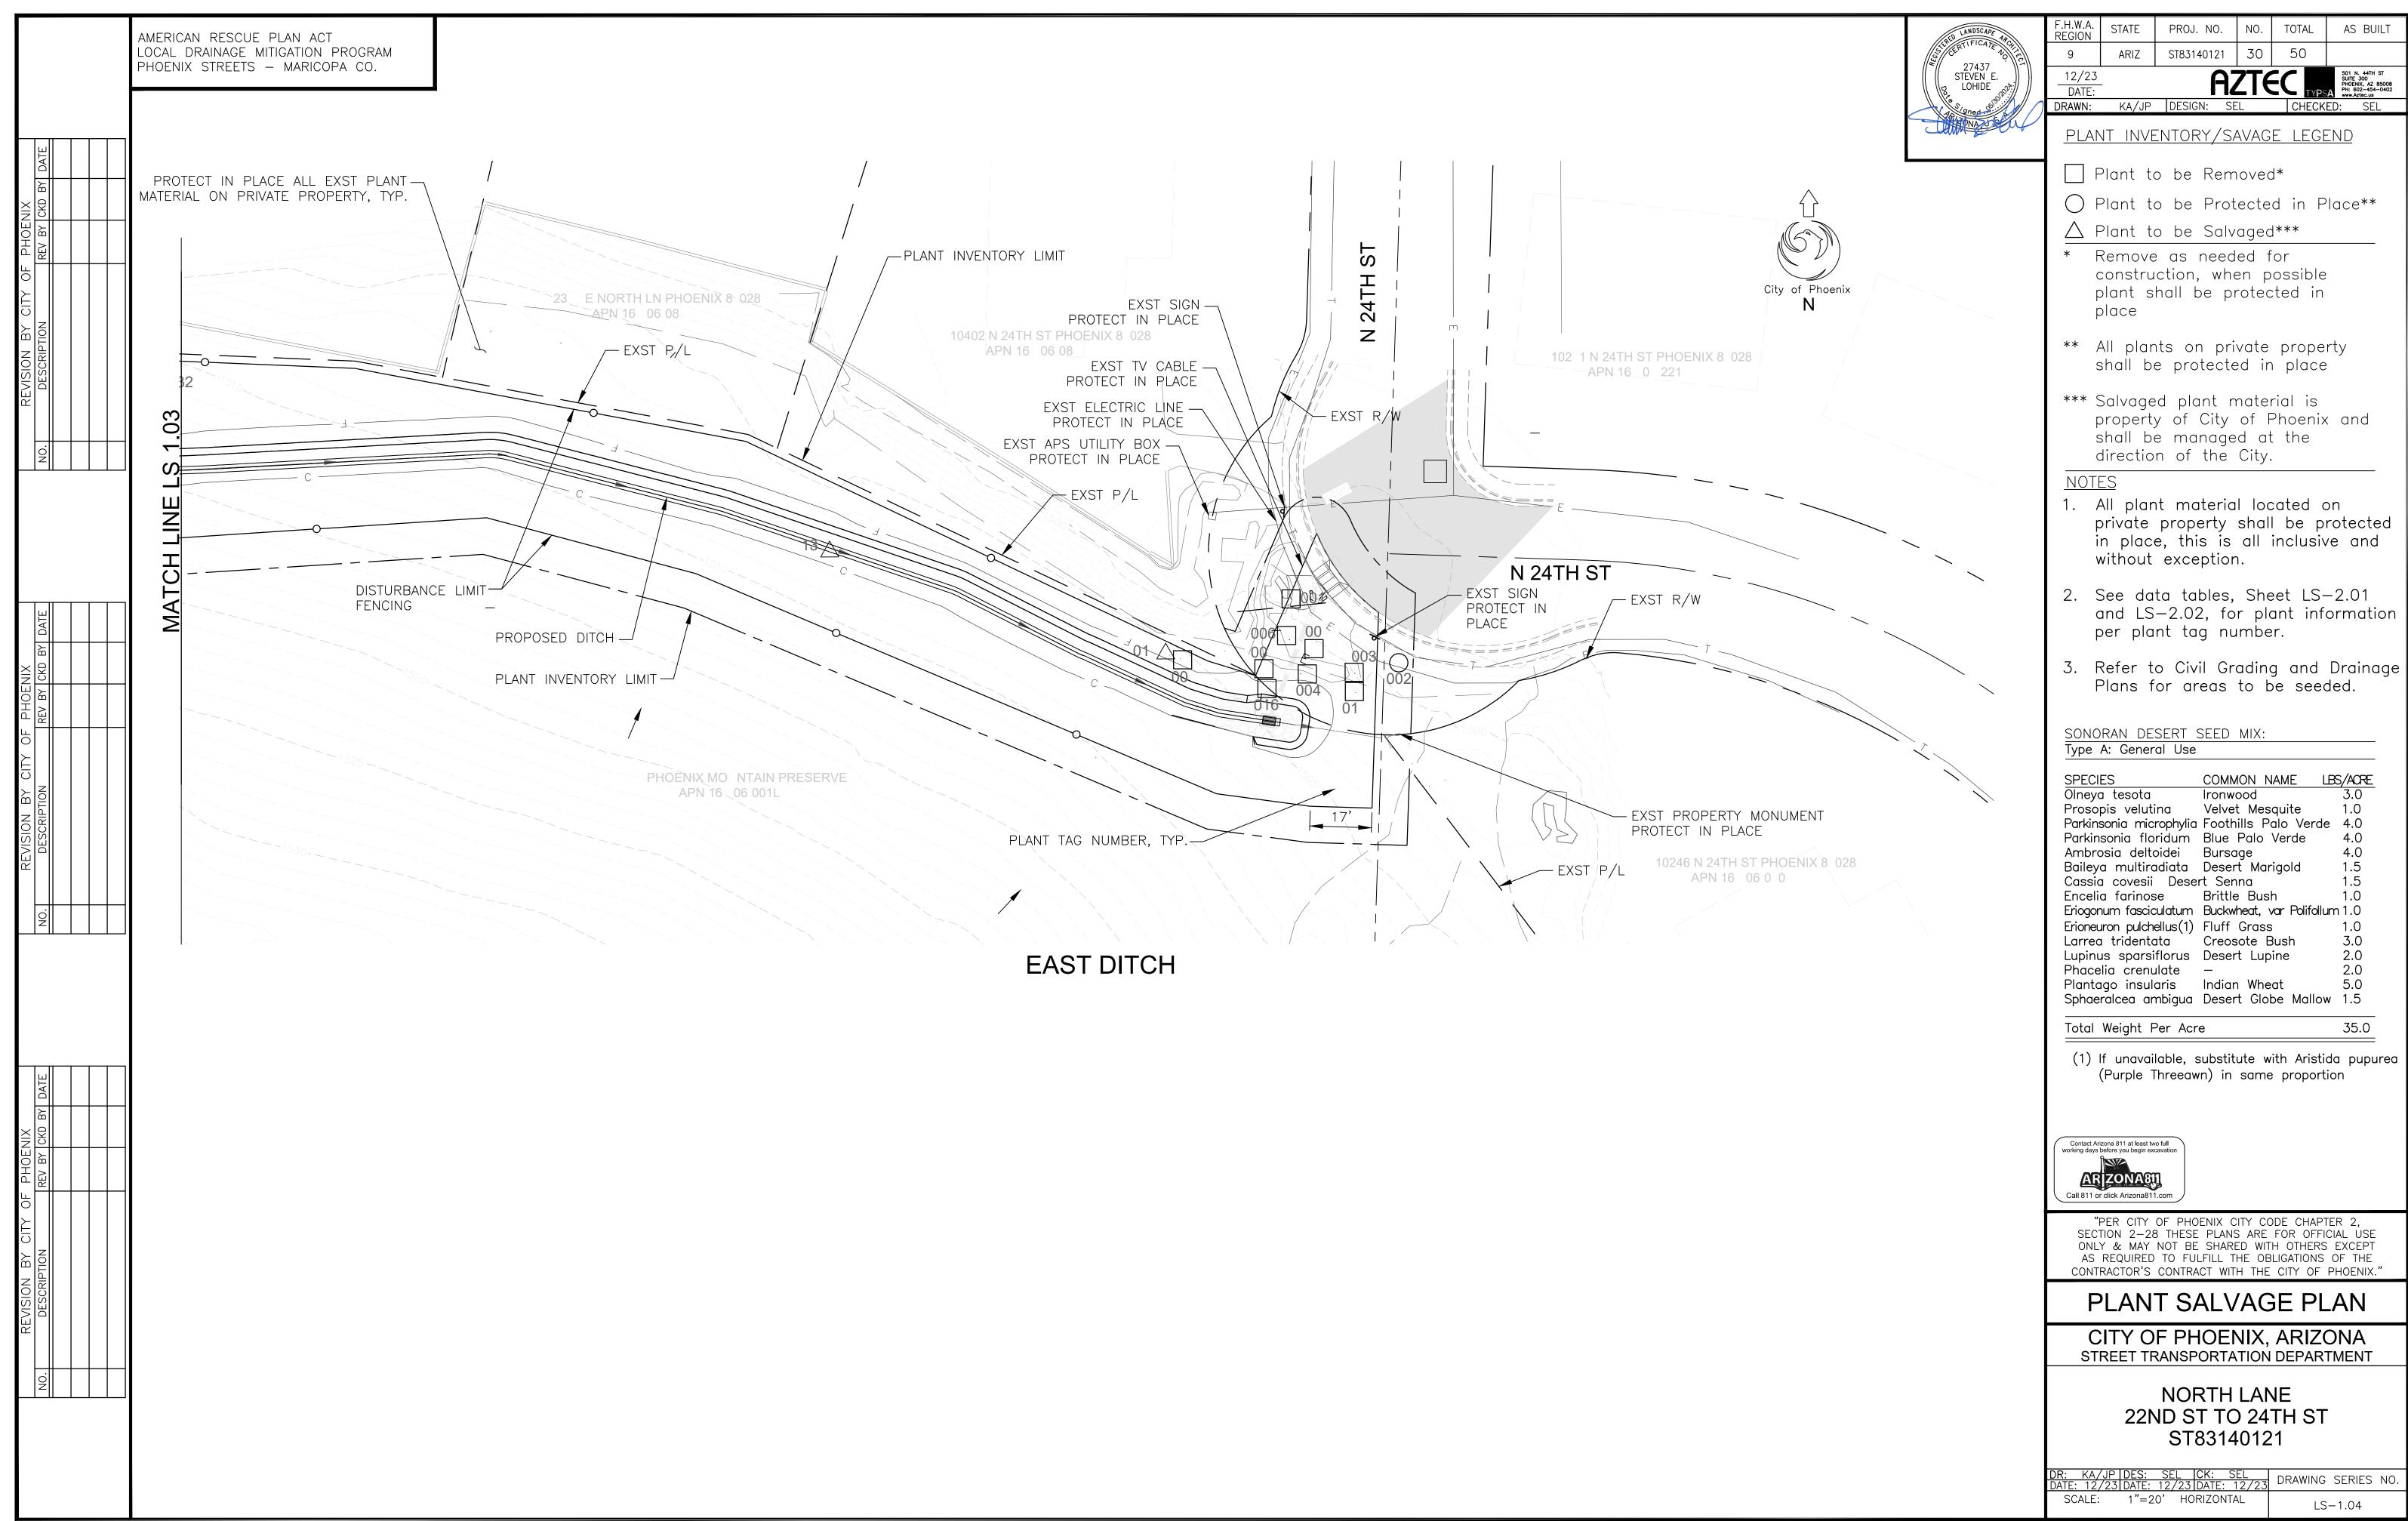

kantill

AMERICAN RESCUE PLAN ACT LOCAL DRAINAGE MITIGATION PROGRAM PHOENIX STREETS — MARICOPA CO.

TagNo PlantType Species


Parkinsonia spp

CommonName

Palo Verde



_						
	F.H.W.A. REGION	STATE	PROJ. NO.	NO.	TOTAL	AS BUILT
	9	ARIZ	ST83140121	31	50	
	12/23 DATE:	-	AZ	ZTE	TYPS	501 N. 44TH ST SUITE 300 PHOENIX, AZ 85008 PH: 602-454-0402 www.Aztec.us
7	DRAWN:	KA/JP	DESIGN: SE	L	CHECK	ED: SEL

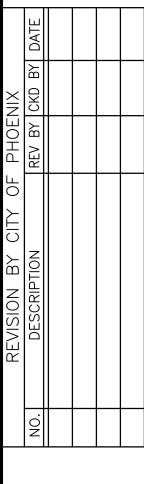

	DATE		
×	REV BY CKD BY DATE		
PHOE	REV BY		
REVISION BY CITY OF PHOENIX	DESCRIPTION		
	NO.		

001	Tree	Parkinsonia spp	Paio verde	ь	20	15	Fair	INS	PKX	
002	Tree	Parkinsonia spp	Palo Verde	5	10	12	Fair	PIP		
003	Tree	Parkinsonia spp	Palo Verde	3	10	10	Good	NS	RS	
004	Tree	Parkinsonia spp	Palo Verde	6	10	12	Good	NS	RS	
005	Tree	Parkinsonia spp	Palo Verde	6	10	12	Good	NS	RS	
006	Tree	Parkinsonia spp	Palo Verde	6	10	12	Good	NS	RS	
007	Tree	Parkinsonia spp	Palo Verde	2	5	6	Fair	NS	RS	
008	NUMBER N	<u> </u>					1. 5.11	1.10	1	
009	Tree	Parkinsonia spp	Palo Verde	3	5	8	Good	NS	RS	
010	NUMBER N		i dio verde				10000	113	11.5	
010	NUMBER N									
012	NUMBER N									
	NUMBER N									
013										
014	NUMBER N		N/accuita	1 1	1 2	٦ .	Tra:::	INC	IDC DE	1
015	Tree	Prosopis spp	Mesquite	1	2	2	Fair	NS	RS PF	1
016	Tree	Parkinsonia spp	Palo Verde	2	3	3	Fair	NS	RS	
017	Cactus	Echinocactus spp	Barrel Cactus	0	0	2.5	Fair	S		
018	Cactus	Cylindropuntia spp	Cholla	0	0	1	Fair	PIP		
019	Cactus	Cylindropuntia spp	Cholla	0	0	1	Fair	PIP		
020	Cactus	Cylindropuntia spp	Cholla	0	0	3.5	Fair	PIP		
021	Cactus	Cylindropuntia spp	Cholla	0	0	1	Fair	PIP		
022	Cactus	Cylindropuntia spp	Cholla	0	0	3	Fair	S		
023	Cactus	Cylindropuntia spp	Cholla	0	0	2	Fair	S		
024	Cactus	Cylindropuntia spp	Cholla	0	0	3.5	Fair	S		
025	Cactus	Cylindropuntia spp	Cholla	0	0	6.5	Fair	S	1	
	-			0	0	5	Fair	S		
026	Cactus	Cylindropuntia spp	Cholla		 				+	
027	Cactus	Cylindropuntia spp	Cholla	0	0	5.5	Fair	S		1
028	Cactus	Cylindropuntia spp	Cholla	0	0	1.5	Fair	S		
029	Cactus	Cylindropuntia spp	Cholla	0	0	2	Fair	S		
030	Cactus	Cylindropuntia spp	Cholla	0	0	2	Fair	S		
031	Cactus	Cylindropuntia spp	Cholla	0	0	1.5	Fair	S		
032	Cactus	Cylindropuntia spp	Cholla	0	0	1.5	Fair	S		
033	Cactus	Cylindropuntia spp	Cholla	0	0	2.5	Fair	S		
034	Cactus	Cylindropuntia spp	Cholla	0	0	2.5	Fair	S		
035	Cactus	Cylindropuntia spp	Cholla	0	0	2	Fair	S		
036	Cactus	Cylindropuntia spp	Cholla	0	0	1.5	Fair	S		
037	Cactus	Cylindropuntia spp	Cholla	0	0	5	Fair	PIP		Multiple pups
038	Cactus		Cholla	0	0	4	Fair	PIP		TVIGITIPIC PUPS
	-	Cylindropuntia spp			<u> </u>					
039	Cactus	Echinocactus spp	Barrel Cactus	0	0	3	Good	PIP	1	1
040	Cactus	Cylindropuntia spp	Cholla	0	0	2	Fair	S		
041	Cactus	Cylindropuntia spp	Cholla	0	0	2	Fair	S		
042	Cactus	Echinocereus spp	Hedgehog Cactus	0	0	1	Fair	PIP		
043	Cactus	Echinocactus spp	Barrel Cactus	0	0	2	Fair	S		
044	Cactus	Echinocereus spp	Hedgehog Cactus	0	0	1	Fair	S		
045	Tree	Parkinsonia spp	Palo Verde	12	20	15	Fair	PIP		
046	Tree	Parkinsonia spp	Palo Verde	6	12	12	Fair	NS	RS PF	
047	Tree	Parkinsonia spp	Palo Verde	8	12	12	Fair	NS	RS PF	
048	Tree	Parkinsonia spp	Palo Verde	8	15	15	Fair	NS	RS ER	
049	Tree	Parkinsonia spp	Palo Verde	4	10	10	Fair	NS	RS PF	
050	Tree	Parkinsonia spp	Palo Verde	10	15	12	Fair	NS	RS	
051	Tree	Acacia spp	Acacia	2	6	8	Poor	NS	RS PH	1
052	Tree	Parkinsonia spp	Palo Verde	4	12	10	Fair	NS	RS ER	1
053	Tree	Parkinsonia spp	Palo Verde	8	14	12	Fair	PIP		†
054	Cactus	Echinocereus spp	Hedgehog Cactus	0	0	2.5	Fair	c	DEAD	+
				6	 		Fair	PIP	DLAD	+
055	Tree	Parkinsonia spp	Palo Verde		12	10	+	_		+
056	Tree	Parkinsonia spp	Palo Verde	6	15	15	Fair	PIP	DC DE	1
057	Tree	Parkinsonia spp	Palo Verde	8	18	12	Fair	NS	RS PF	1
058	Tree	Parkinsonia spp	Palo Verde	6	8	8	Fair	PIP	1	

| Caliper* | Width* | Height | Condition | Status | Reason** | Notes

TagNo	PlantType	Species	CommonName	Caliper*	Width*	Height	Condition	Status	Reason**	Notes		
059	Tree	Parkinsonia spp	Palo Verde	2	3	5	Fair	PIP				
060	Tree	Parkinsonia spp	Palo Verde	6	16	10	Fair	PIP				
061	Tree	Parkinsonia spp	Palo Verde	6	10	10	Fair	PIP				
062	Tree	Parkinsonia spp	Palo Verde	6	8	10	Fair	PIP				
063	Tree	Parkinsonia spp	Palo Verde	7	8	10	Fair	PIP				
064	Tree	Parkinsonia spp	Palo Verde	5	12	10	Poor	PIP				
065	Other	Fouquieria splendens	Ocotillo	0	0	10	Fair	PIP		20+ canes		
066	Cactus	Echinocactus spp	Barrel Cactus	0	0	2.5	Good	PIP				
067	Tree	Parkinsonia spp	Palo Verde	2	3	5	Poor	PIP				
068	Tree	Parkinsonia spp	Palo Verde	1	2	4	Fair	NS	RS			
069	Cactus	Echinocactus spp	Barrel Cactus	0	0	1.5	Fair	PIP				
070	NUMBER NO	T USED	•	•				•				
071	Tree	Parkinsonia spp	Palo Verde	6	12	10	Fair	PIP				
072	Tree	Parkinsonia spp	Palo Verde	1	2	3	Fair	NS	PRX			
073	Tree	Parkinsonia spp	Palo Verde	3	6	6	Fair	PIP				
074	NUMBER NO	UMBER NOT USED										
075	NUMBER NO	NUMBER NOT USED										
076	NUMBER NO	NUMBER NOT USED										
077	NUMBER NO	NUMBER NOT USED										
078	NUMBER NO	T USED			;							
079	Tree	Parkinsonia spp	Palo Verde	3	10	8	Fair	PIP				
080	Cactus	Echinocactus spp	Barrel Cactus	0	0	2	Fair	PIP				
081	Cactus	Echinocactus spp	Barrel Cactus	0	0	1.5	Fair	PIP				
082	Tree	Parkinsonia spp	Palo Verde	12	18	15	Fair	PIP				
083	Tree	Parkinsonia spp	Palo Verde	5	10	10	Fair	NS	RS PRX			
084	Tree	Parkinsonia spp	Palo Verde	2	2	4	Fair	NS	RS CD			
085	Tree	Parkinsonia spp	Palo Verde	5	10	14	Fair	NS	RS			
086	NUMBER NO	<u> </u>	l	L		l	·	<u> </u>	L			
087	NUMBER NO	OT USED										
088	Tree	Parkinsonia spp	Palo Verde	3	4	6	Fair	NS	RS			
089	Tree	Parkinsonia spp	Palo Verde	8	14	12	Fair	NS	RS			
090	Cactus	Carnegiea gigantea	Saguaro	0	0	3	Good	s	1			
091	Tree	Parkinsonia spp	Palo Verde	4	6	8	Fair	PIP				
092	Tree	Prosopis spp	Mesquite	3	8	10	Good	PIP				
093	Tree	Parkinsonia spp	Palo Verde	1	4	3	Fair	NS	RS			
094	Tree	Parkinsonia spp	Palo Verde	1	3	4	Fair	PIP	1			
095	NUMBER NO		<u> </u>			<u> </u>	1	1	1			
096	NUMBER NO				-							
)97	NUMBER NO											
098	NUMBER NO											
099	NUMBER NO											
100	Tree	Parkinsonia spp	Palo Verde	3	8	8	Fair	NS	RS PF			
101	Tree	Parkinsonia spp	Palo Verde	5	10	14	Fair	NS	RS			
	+	T USED	1				1	1	1	<u> </u>		

NOTES:

* Data collected for cactus plant size includes height only

** Reason pertains to no salvage (NS) plant material only

Abbreviation Key:
CD — Cambium Damage
DW — Dead Wood
ER — Exposed Roots
NS — No Salvage
PF — Poor Form

PH — Poor Health

PIP — Protect In Place PRX — Proximity To Plant or Structure RS — Rock Slope S — Salvage

JPerillo



"PER CITY OF PHOENIX CITY CODE CHAPTER 2, SECTION 2-28 THESE PLANS ARE FOR OFFICIAL USE ONLY & MAY NOT BE SHARED WITH OTHERS EXCEPT AS REQUIRED TO FULFILL THE OBLIGATIONS OF THE CONTRACTOR'S CONTRACT WITH THE CITY OF PHOENIX."

PLANT DATA TABLES

CITY OF PHOENIX, ARIZONA STREET TRANSPORTATION DEPARTMENT

> NORTH LANE 22ND ST TO 24TH ST ST83140121

DR: KA/JP DES: SEL CK: SEL DRAWING SERIES NO. SCALE: N/A HORIZONTAL LS-2.01

AMERICAN RESCUE PLAN ACT LOCAL DRAINAGE MITIGATION PROGRAM PHOENIX STREETS - MARICOPA CO.

KEOS (SE)	LANDSCAPE ERTIFICATE	10 CH
	27437 STEVEN E.	6/15/
40	Signed Si	

	F.H.W.A. REGION	STATE	PROJ. NO.	NO.	TOTAL	AS BUILT
	9	ARIZ	ST83140121	32	50	
	12/23	-	A	7T <i>6</i>		501 N. 44TH ST SUITE 300 PHOENIX, AZ 85008
//	DATE:		1 16	<u> </u>	TYPS	A PH: 602-454-0402 www.Aztec.us
$/\!\!/$	DRAWN:	KA/JP	DESIGN: SE	L	CHECK	ED: SEL

	DATE		
XIZ	CKD BY		
PHOEI	REV BY CKD BY DATE		
TY OF			
BY CI	NOI		
REVISION BY CITY OF PHOENIX	DESCRIPTION		
	NO.		

	DATE		
XIN	REV BY CKD BY DATE		
PHOE	REV BY		
REVISION BY CITY OF PHOENIX	DESCRIPTION		
	NO.		

	DATE		
XIN	СКР ВҮ		
PHOE	REV BY CKD BY DATE		
REVISION BY CITY OF PHOENIX	DESCRIPTION		
	ON		

TagNo	PlantType	Species	CommonName	Caliper*	Width*	Height	Condition	Status	Reason**	Notes		
103	NUMBER NO	NUMBER NOT USED										
104	Tree	Parkinsonia spp	Palo Verde	1	4	4	Fair	PIP				
105	NUMBER NOT USED											
106	Tree	Parkinsonia spp	Palo Verde	8	20	25	Fair	PIP		PP		
107	NUMBER NOT USED											
108	Cactus	Opuntia spp	Bunny Ear Cactus	0	0	1	Fair	S		mass Half/Half		
109	Cactus	Opuntia spp	Bunny Ear Cactus	0	0	1	Fair	PIP		mass Half/Half		
110	Cactus	Opuntia spp	Bunny Ear Cactus	0	0	0	Fair	S		mass Half/Half		
111	NUMBER NO	OT USED										
112	Cactus	Opuntia spp	Bunny Ear Cactus	0	0	1	Fair	S				
113	Cactus	Cylindropuntia spp	Cholla	0	0	7	Fair	PIP				
114	Cactus	Cylindropuntia spp	Cholla	0	0	3	Fair	PIP				
115	Cactus	Cylindropuntia spp	Cholla	0	0	2.5	Fair	S				
116	Cactus	Opuntia spp	Bunny Ear Cactus	0	0	1	Fair	S				
117	Cactus	Opuntia spp	Bunny Ear Cactus	0	0	1	Fair	PIP				
118	NUMBER NO	OT USED										
119	Cactus	Opuntia spp	Prickly Pear Cactus	0	0	1	Fair	PIP		mass Half/Half		
120	Cactus	Opuntia spp	Bunny Ear Cactus	0	0	1	Fair	PIP		mass Half/Half		
121	NUMBER NO	OT USED										
122	Cactus	Opuntia spp	Bunny Ear Cactus	0	0	1	Fair	PIP		mass Half/Half		
123	Tree	Parkinsonia spp	Palo Verde	2	2	6	Fair	PIP				
124	Tree	Parkinsonia spp	Palo Verde	3	3	6	Fair	PIP				
125	NUMBER NO	OT USED										
126	NUMBER NO	OT USED										
127	NUMBER NO	OT USED										
128	NUMBER NO	OT USED										
129	NUMBER NO	OT USED										
130	Tree	Parkinsonia spp	Palo Verde	6	15	18	Fair	PIP				
131	Tree	Parkinsonia spp	Palo Verde	5	15	10	Poor	PIP				
132	Tree	Parkinsonia spp	Palo Verde	9	15	10	Poor	PIP				
133	NUMBER NO	OT USED					•		•	•		
134	NUMBER NO	OT USED										
135	Cactus	Cactaceae spp	Mammillaria Cactus	0	0	0	Fair	S				
	•		•	•	•	•	•	•	•	•		

NOTES:

- * Data collected for cactus plant size includes height only
- ** Reason pertains to no salvage (NS) plant material only

Plants 109—110 and 119—122 are plant groupings of cactus, any part of plant located on private property shall be protected in place, any part of plant on City of Phoenix property that will be disturbed by construction activity shall be salvaged. If construction activity will hove no impact, protect in place all parts of plant.

Abbreviation Key: CD — Cambium Damage DW — Dead Wood

ER — Exposed Roots

NS — No Salvage PF — Poor Form

PH — Poor Health

PIP — Protect In Place
PRX — Proximity To Plant or Structure
RS — Rock Slope
S — Salvage



"PER CITY OF PHOENIX CITY CODE CHAPTER 2, SECTION 2-28 THESE PLANS ARE FOR OFFICIAL USE ONLY & MAY NOT BE SHARED WITH OTHERS EXCEPT AS REQUIRED TO FULFILL THE OBLIGATIONS OF THE CONTRACTOR'S CONTRACT WITH THE CITY OF PHOENIX."


PLANT DATA TABLES

CITY OF PHOENIX, ARIZONA STREET TRANSPORTATION DEPARTMENT

> NORTH LANE 22ND ST TO 24TH ST ST83140121

DR: KA/JP DES: SEL CK: SEL DRAWING SERIES NO. SCALE: N/A HORIZONTAL LS-2.02

JPerillo

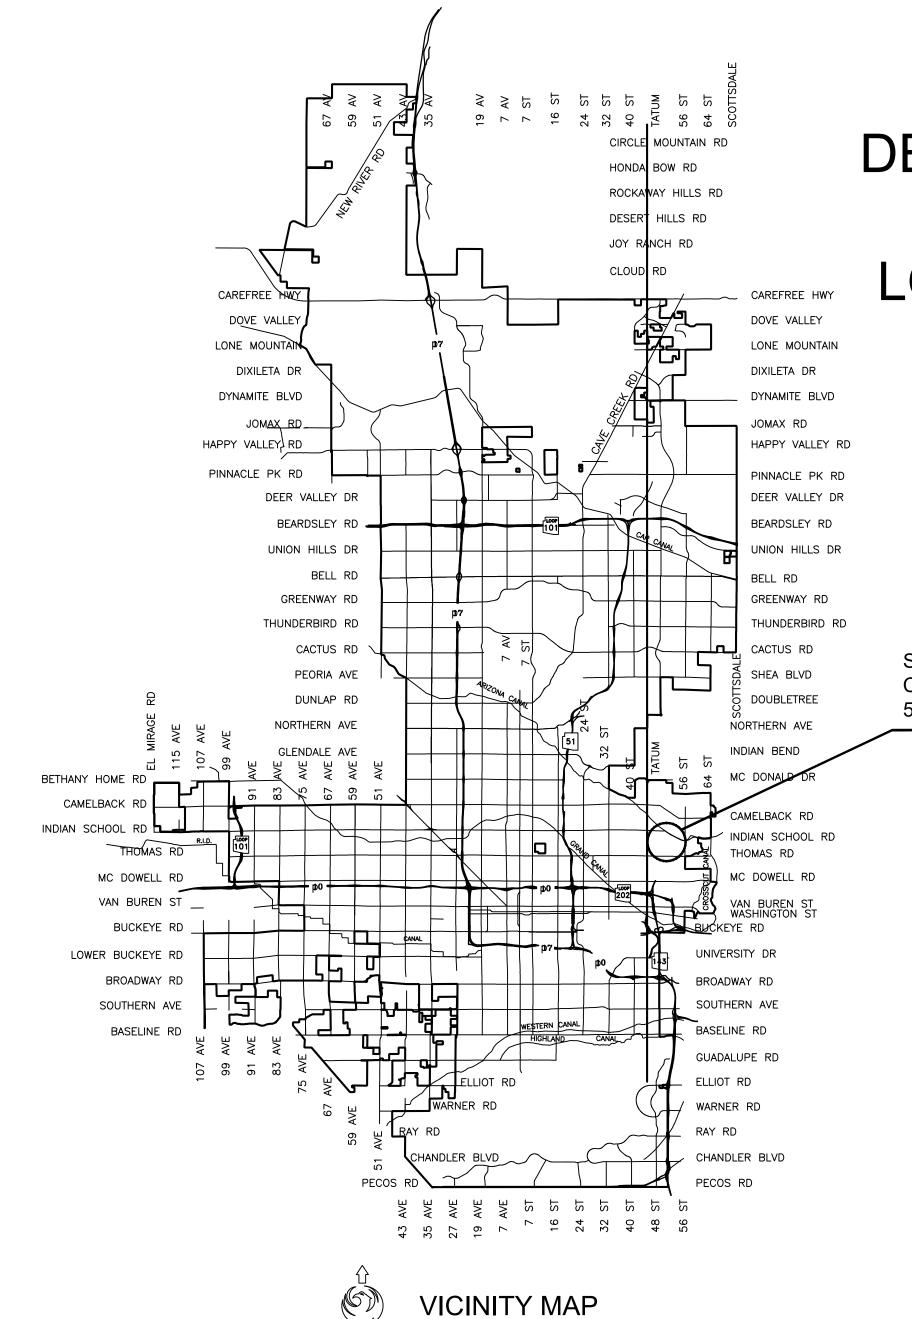

CITY OF PHOENIX STREET TRANSPORTATION DEPARTMENT DESIGN & CONSTRUCTION MANAGEMENT DIVISION AMERICAN RESCUE PLAN ACT LOCAL DRAINAGE MITIGATION PROJECT PACKAGE 1

50TH PLACE & CLARENDON ST83140122

FINAL DESIGN SUBMITTAL


ST83140122 CLARENDON AVENUE **50TH PLACE & CLARENDON AVE**



2024

CITY BENCHMARKS

A COP BRASS CAP IN HAND HOLE, AT THE MIDPOINT OF E CLARENDON AVE BETWEEN 49TH PLACE AND N 50TH EL 1238.92 (NGVD-29)

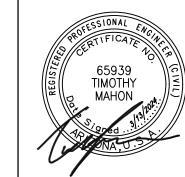

	F.H.W.A. REGION	STATE	PRO	J. NC	•	NO.	TO	ΓAL	AS BUI	LT
	9	ARIZ.	STST8	31401	22	33	5	0		
(C) (C)				F	ZT	EC	- TY	(D C A	501 N. 44TH ST SUITE 300 PHOENIX, AZ 8500 PH: 602-454-04 www.Aztec.us	
k://	DRAWN:	LNB	DESIGN:	CJR	CHECK	ED: 1	ГММ	DATE	: 12/23	3

MAYOR

KATE GALLEGO

CITY MANAGER

JEFFREY BARTON

CITY COUNCIL

DISTRICT NO 1.	ANN O'BRIEN
DISTRICT NO 2.	JIM WARING
DISTRICT NO 3.	DEBRA STARK
DISTRICT NO 4.	LAURA PASTOR
DISTRICT NO 5.	BETTY GUARDADO
DISTRICT NO 6.	KEVIN ROBINSON
DISTRICT NO 7.	YASSAMIN ANSARI
DISTRICT NO 8.	KESHA HODGE WASHINGTO

INDEX OF SHEET

SHEET NO.	DWG. SERIES NO.	SHEET TITLE
1	G-0.01	COVER
2-3	G-1.01-1.02	LEGEND AND NOTES
4	G-2.01	GEOMETRIC CONTROL
5	G-3.01	QUANTITY SUMMARY
6	SD-1.01	DRAINAGE PLAN
7-8	SDD-1.01-1.02	DRAINAGE DETAIL
9	SDD-1.03	STAKING DETAIL
10	SDD-1.04	VALLEY GUTTER DETAIL

LENGTH OF PROJECT: CLARENDON AVENUE = 283 LF AREA OF DISTURBANCE = 2672 SQ.FT. = 0.06 ACRES



"PER CITY OF PHOENIX CITY CODE CHAPTER 2, SECTION 2-28, THESE PLANS ARE FOR OFFICIAL USE ONLY & MAY NOT BE SHARED WITH OTHERS EXCEPT AS REQUIRED TO FULFILL THE OBLIGATIONS OF YOUR CONTRACT WITH THE CITY OF PHOENIX."

6/4/2024 DATE 6/4/2024 DATE

EXISTING POWER POLE DOWN GUY ANCHOR

PAVEMENT CENTER LINE OR MONUMENT LINE

EXISTING TREE OR STUMP TO BE REMOVED - MORE THAN 12" DIA.

EXISTING TREE OR STUMP TO BE REMOVED 12" DIA. OR LESS (NON PAY ITEM)

EXISTING TREE TO BE TRANSPLANTED BY CONTRACTOR


EXISTING STREET LIGHT & POLE

EXISTING OR NEW R/W LINE

EXISTING TREE TO REMAIN

EASEMENT LINE

LEGEND AND NOTES

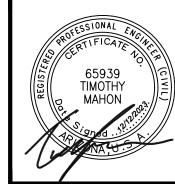

	F.H.W.A. REGION	STATE	PROJ. NO.	NO.	TOTAL	AS BUILT
\	9	ARIZ	ST83140122	34	50	
	12/23 DATE:	-	AZ	ZTE	EC TYPS	501 N. 44TH ST SUITE 300 PHOENIX, AZ 85008 PH: 602-454-0402 www.Aztec.us
]]	DRAWN:	LNB	DESIGN:	CJR	CHECK	ED: TMM

NOTES

- 1. ALL CONSTRUCTION SHALL BE PERFORMED IN ACCORDANCE WITH CONTRACT SPECIFICATIONS; PLANS; CITY OF PHOENIX SUPPLEMENTS TO MAG STANDARD SPECIFICATIONS AND DETAILS; AND MAG STANDARD SPECIFICATIONS AND DETAILS, IN THAT ORDER OF PRECEDENCE, AT THE TIME OF CONSTRUCTION BID.
- 2. ALL STORM SEWER MANHOLES ARE TO BE CONSTRUCTED WITHOUT STEPS
- 3. NEW MANHOLE COVERS LOCATED IN SIDEWALK SHALL BE GROUND TO OBLITERATE RAISED LETTERING, AND PROVIDE A SMOOTH SURFACE FLUSH WITH THE ADJACENT SIDEWALK.
- 4. PIPE CONNECTIONS TO EXISTING CONCRETE PIPE MAINS SHALL BE MADE IN ACCORDANCE WITH DETAILS CALLED OUT ON THE PLANS. CONNECTION TO MAINS SHALL NOT BE CLOSER THAN 5', CENTER TO CENTER.
- 5. PIPE CONNECTIONS TO NEW PRECAST CONCRETE PIPE MAINS SHALL BE MADE WITH FACTORY MADE WYES OR TEES. THE DETAIL OF THE FITTINGS MUST BE SUBMITTED TO THE ENGINEER FOR APPROVAL PRIOR TO MANUFACTURE. PIPE CONNECTIONS TO NEW CAST IN PLACE CONCRETE PIPE MAINS SHALL BE MADE PER COPDETAIL P1576.
- 6. CATCH BASIN CONNECTOR PIPES SHALL BE LAID ON A STRAIGHT ALIGNMENT AND SLOPE UNLESS OTHERWISE SPECIFIED. IF BREAKS IN ALIGNMENT OR SLOPE ARE NECESSARY TO MEET FIELD CONDITIONS. THE MAXIMUM DEFLECTION SHALL BE 22-1/2°. THE BEND SHALL BE COLLARED ACCORDING TO COP DETAIL P1505. ANY ANGLE BENDS GREATER THAN 22-1/2° SHALL BE PREFABRICATED.
- 7. CONNECTOR PIPES SHALL CONNECT TO CATCH BASIN WALLS AT AN ANGLE NOT TO EXCEED 22-1/2 FROM PERPENDICULAR.
- 8. FACILITIES WHICH ARE NOT SPECIFICALLY LOCATED WITH ACTUAL VERTICAL AND HORIZONTAL CONTROLS, ARE LOCATED ONLY APPROXIMATELY AND TO THE BEST AVAILABLE INFORMATION PROVIDED BY VARIOUS OWNERS OF THE FACILITIES AND SUPPLEMENTED BY VISUAL SURFACE INFORMATION WHERE APPROPRIATE. ACCURACY, LOCATION AND COMPLETENESS OF THIS INFORMATION SHALL BE VERIFIED BY THE CONTRACTOR PRIOR TO INITIATION OF CONSTRUCTION.
- 9. A ONE (1) FOOT MINIMUM VERTICAL SEPARATION FROM DRY UTILITIES CROSSINGS SHALL BE PROVIDED FOR SEWER MAINS, SEWER SERVICES, WATER MAIN, OR WATER SERVICE TO OUTSIDE UNDERGROUND UTILITY.
- 10. AT LEAST TWO WORKING DAYS BEFORE CONSTRUCTION, THE CONTRACTOR SHALL CONTACT BLUESTAKE TO FIND AND FLAG UNDERGROUND UTILITIES. THE CONTRACTOR SHALL CONTACT OTHER APPROPRIATE UTILITIES DIRECTLY IF THEY ARE NOT ON BLUESTAKE SYSTEM.
- 11. VERTICAL CONTROL IS BASED ON NATIONAL GEODETIC SURVEY.
- 12. UNLESS OTHERWISE NOTED, STATIONS SHOWN ON PIPE PROFILES ARE ALONG CENTERLINE OF PIPE.
- 13. UNLESS OTHERWISE NOTED, PIPE SHALL BE BEDDED IN ACCORDANCE WITH CITY OF PHOENIX DETAIL P1200.
- 14. CATCH BASINS ARE STATIONED PERPENDICULAR TO THE CENTERLINE OF THE STREET AT THE CENTERLINE OF THE MAINTENANCE BASIN.
- 15. SANITARY SEWER MAINS AND TAPS CROSSING OVER STORM DRAIN MAINS SHALL BE SUPPORTED PER MAG DETAIL 403-1, 403-2, OR 403-3.
- 16. ALL EXISTING PRECAST CONCRETE SAFETY CURBS AND ALL EXISTING WOODEN PARKING CURBS WHICH ARE INSIDE THE RIGHT OF WAY AND APPROXIMATELY PARALLEL TO THE NEW CURB LINE SHALL BE RESET ON THE RIGHT OF WAY DIRECTLY OPPOSITE THEIR EXISTING LOCATION, WITH THE BACK EDGE ON THE RIGHT OF WAY LINE. ALL OTHER PRECAST CONCRETE SAFETY CURBS INSIDE THE STREET RIGHT OF WAY SHALL BE SALVAGED AND STOCK PILED FOR THE OWNER AT THE RIGHT OF WAY LINE.
- 17. EXISTING PRECAST CONCRETE SAFETY CURBS OUTSIDE THE RIGHT OF WAY WHICH ARE DISTURBED BY NEW CONSTRUCTION SHALL BE RESET IN THEIR ORIGINAL POSITION BY THE CONTRACTOR. THERE WILL BE NO SEPARATE MEASUREMENT OR PAYMENT FOR THIS WORK, THE COST BEING CONSIDERED INCLUDED.
- 18. ALL EXISTING DRIVEWAYS AND ALL EXISTING ALLEYS SHALL BE GRADED TO MATCH THE NEW WORK IN ACCORDANCE WITH STD DETAIL P1164, UNLESS OTHERWISE SPECIFIED. EXISTING SURFACING SHALL BE REMOVED AND REPLACED AS NECESSARY.

NOTES CONT

- 19. CONTACT INSPECTOR IF LESS THAN 6 INCHES OR COVER WILL BE MAINTAINED BELOW SCARIFICATION DEPTH CONTRACTOR TO FIELD VERIFY DEPTH AT LOCATION OF NEW AC AND SIDEWALK.
- 20. IN HISTORIC PRESERVATION ZONES, THE CONTRACTOR SHALL DISTURB AS LITTLE OF HISTORIC SIDEWALK AS POSSIBLE. UNLESS OTHERWISE PROVIDED ON THE PLANS:
- THE SPACE BETWEEN THE BACK OF NEW DRIVEWAY ENTRANCES AND EXISTING AC DRIVEWAYS SHALL BE FILLED WITH A MINIMUM OF 3" ACSC ON 100% COMPACTED NATIVE SOIL. WHERE EXISTING PAVEMENT AND BASE THICKNESS EXCEED THE MINIMUMS, MATCH THE EXISTING.
- THE SPACE BETWEEN THE BACK OF NEW SIDEWALKS AND EXISTING PRIVATE SIDEWALKS, AND THE SPACE BETWEEN THE BACK OF NEW DRIVEWAY ENTRANCES AND EXISTING PCC DRIVEWAYS SHALL BE FILLED WITH PCC. THE THICKNESS AND CLASS SHALL MATCH THAT OF THE NEW SIDEWALK OR DRIVEWAY ENTRANCE.
- THE SPACE BETWEEN THE BACK OF THE SIDEWALKS AND EXISTING AC PARKING LOTS, WHICH FALL WITHIN OR ABUT THE R/W SHALL BE FILLED WITH 2" ACSC ON 100% COMPACTED NATIVE SOIL.
- 21. EXISTING IRRIGATION BERMS DISTURBED BY NEW CONSTRUCTION SHALL BE RECONSTRUCTED AS SHOWN ON PLANS.
- 22. CATCH BASIN ACCESS FRAME AND COVERS SHALL BE CONSTRUCTED PER COP STANDARD DETAIL.

STR CT RAL NOTES

- 1. "CLEAR" DIMENSIONS FOR DEPTH OF REINFORCING STEEL ARE FROM FACE OF CONCRETE TO FACE OF BARS.
- 2. ALL EXPOSED EDGES OF CONCRETE SHALL BE BEVELED OR ROUNDED.
- 3. ALL EXPOSED CONCRETE SURFACES SHALL BE FINISHED IN ACCORDANCE WITH MARICOPA ASSOCIATION OF GOVERNMENTS (MAG) STANDARD SPECIFICATION 505.9 FINISHING CONCRETE, UNLESS OTHERWISE SPECIFIED.

ABBREVIATIONS

PC = PIPE CONNECTION
MH = MANHOLE
CB = CATCH BASIN

"PER CITY OF PHOENIX CITY CODE CHAPTER 2, SECTION 2-28 THESE PLANS ARE FOR OFFICIAL USE ONLY & MAY NOT BE SHARED WITH OTHERS EXCEPT AS REQUIRED TO FULFILL THE OBLIGATIONS OF THE CONTRACTOR'S CONTRACT WITH THE CITY OF PHOENIX."

LEGEND NOTES

CITY OF PHOENIX, ARIZONA STREET TRANSPORTATION DEPARTMENT

0TH PLACE AND CLARENDON AVE ST83140122

DR: LNB | DES: CJR | CK: TMM | DRAWING SERIES NO. DATE: 12/23 | DATE: 12/23 | DRAWING SERIES NO. SCALE:NONE | HORIZONTAL | G-1.01

cragan

	AMERICAN RESCUE PLAN ACT LOCAL DRAINAGE MITIGATION PROGRAM PHOENIX STREETS — MARICOPA CO.
NO. DESCRIPTION REV BY CKD BY DATE	 ALL WATER VALVE BOXES SHALL SPECIFICATIONS AND DETAILS FROM FORM TO M.A.G SPECIFICATION IN THE CITY CONFORM TO M.A.G SPECIFICATIONS AND DETAILS M.A.G SPECIFICATIONS AND DETAILS OF PHOENIX SUPPLEMENT TO RESTRAINTS MUST BE PER M.A ARE NOT ALLOWED TO BE USED WHERE A SPECIFIC CITY OF PHOENIX BLOCKS CAN BE USED WHERE A SPECIFIC CITY OF PHOENISE APPROVED BY THE ALLOWING M.A.G. DETAILS 302-1 JOINT RESTRAIN 302-2 JOINT RESTRAIN 321 STANDARD WATER 345-1 3", 4", AND 6" 345-2 4" AND 6" WATER 345-2 4" AND 6" WATER 345-1 3", 4", AND 6" WATER 345-1 3", 4",
NO. DESCRIPTION REV BY CKD BY DATE	 COMPACTION SHALL COMPLY WE SUPPLEMENTS. NEW WATER LINES ARE TO BE "STANDARD UTILITY LOCATIONS" THIS SET OF PLANS HAS BEEN IS PART OF THE PROCESS THAT ORDER TO OBTAIN A CONSTRUENT NOT DICTATE THE CITY OF PHOTHE PLANS, NOR SHALL IT PROMISSIONS, AS FOUND ON PLAY WHERE SUCH ERRORS AND OMINADEQUATE UNDER APPLICABLISM REGULATIONS, OR OTHER LAWS KEPT AT THE CONSTRUCTION SET OF THE PROPERTY OF TH
CITY OF PHOENIX REV BY CKD BY DATE	BE PROVIDED FOR SEWER MAIN THE MINIMUM HORIZONTAL SEP SEWER SERVICE, WATER MAIN, 12. A ONE (1) FOOT MINIMUM VER CROSSING SHALL BE PROVIDED WATER SERVICES. THE MINIMUM SEWER MAIN. SEWER SERVICE, UNDERGROUND UTILITY. 13. A TWO (2) FOOT MINIMUM VER AND STORM DRAIN CROSSING MEASURED FROM OUTSIDE OF MAIN. SEE M.A.G. STANDARD D FOR CLEARANCE. 14. EXCEPTIONS OR DEVIATIONS FROM
NO. DESCRIPTION	AND SHOWN ON THE APPROVED DURING CONSTRUCTION, ALL CAPPROVED PLAN REVISION. 15. ANY AND ALL MORE STRINGENT LOCAL CODES OR ORDINANCES 16. WATER SERVICES SHALL BE INSTALLED ON A CASE BY CASE

WATER GENERAL NOTES

- LL WATER VALVE BOXES SHALL BE PER CITY OF PHOENIX SUPPLEMENT TO MAG. PECIFICATIONS AND DETAILS P1391, TYPE A ONLY.
- LL CONSTRUCTION IN THE CITY OF PHOENIX RIGHT—OF—WAY, OR EASEMENT, IS TO ONFORM TO M.A.G SPECIFICATIONS AND DETAILS AND CITY OF PHOENIX SUPPLEMENT TO .A.G SPECIFICATIONS AND DETAILS. UNLESS MODIFIED ON THE PLANS.
- LL DUCTILE IRON PIPE WATER MAIN VALVES, FITTINGS, AND BENDS SHALL BE RESTRAINED. ESTRAINED JOINT REQUIREMENTS AND APPROVED RESTRAINING SYSTEM ARE SHOWN IN CITY PHOENIX SUPPLEMENT TO M.A.G. SPECIFICATIONS, SECTION 750.3. THE LENGTH OF THE ESTRAINTS MUST BE PER M.A.G. STANDARD DETAIL 305-1 AND 303-2. THRUST BLOCKS RE NOT ALLOWED TO BE USED IN LIEU OF APPROVED RESTRAINED JOINT SYSTEMS. HRUST BLOCKS CAN BE USED IN ADDITION TO THE APPROVED RESTRAINED JOINT SYSTEMS HERE A SPECIFIC CITY OF PHOENIX SUPPLEMENT TO M.A.G. STANDARD DETAIL CALLS OUT OR THRUST BLOCKING. SUCH AS CURRENT DETAILS, P1343, P1351, AND P1360 OR WHEN THERWISE APPROVED BY THE WATER SERVICES DEPARTMENT.
- HE FOLLOWING M.A.G. DETAILS ARE SPECIFICALLY NOT APPROVED:

302-1 JOINT RESTRAINT WITH TIE RODS

302-2 JOINT RESTRAINT WITH TIE RODS - ANCHOR BLOCKS

321 STANDARD WATER METER VAULT

345-1 3". 4". AND 6" WATER METER

345-2 4" AND 6" WATER METER WITH ON-SITE FIRE HYDRANTS

370 VERTICAL REALIGNMENT OF WATER MAINS

381 ANCHOR BLOCKS FOR VERTICAL BENDS

390 CURB STOP WITH FLUSHING PIPE

391-1 VALVE BOX INSTALLATION

- OMPACTION SHALL COMPLY WITH M.A.G. SECTION 601 AND CITY OF PHOENIX JPPLEMENTS.
- EW WATER LINES ARE TO BE BUILT IN ACCORDANCE WITH THE CITY OF PHOENIX STANDARD UTILITY LOCATIONS".
- HIS SET OF PLANS HAS BEEN INITIALLY REVIEWED BY THE CITY OF PHOENIX. SUCH REVIEW PART OF THE PROCESS THAT DEVELOPER(S)/CONTRACTOR(S)MUST GO THROUGH IN RDER TO OBTAIN A CONSTRUCTION PERMIT. THE RESULTS OF SUCH INITIAL REVIEW SHALL OT DICTATE THE CITY OF PHOENIX'S FINAL DETERMINATION AS TO THE ACCEPTABILITY OF HE PLANS, NOR SHALL IT PREVENT THE CITY OF PHOENIX FROM REQUIRING ERRORS AND MISSIONS, AS FOUND ON PLANS, BE ADDRESSED BY DEVELOPER(S)/CONTRACTOR(S), HERE SUCH ERRORS AND OMISSIONS CAUSE THE PLANS TO BE IN VIOLATION OF OR ADEQUATE UNDER APPLICABLE FEDERAL/STATE/COUNTY/LOCAL CODES. ORDINANCES. EGULATIONS, OR OTHER LAWS. THIS REVIEWED AND STAMPED SET OF PLANS MUST BE EPT AT THE CONSTRUCTION SITE AT ALL TIMES.
- IPE DEFLECTION SHALL BE PER MANUFACTURERS' RECOMMENDATIONS.
- L WORK MUST COMPLY WITH REQUIREMENTS OF THE CURRENT CITY OF PHOENIX "TRAFFIC ARRICADE MANUAL".
- HE CONTRACTOR IS TO NOTIFY THE PUBLIC THAT WILL BE AFFECTED BY ANY SHUTDOWNS MINIMUM OF 48 HOURS IN ADVANCE.
- SIX (6) FOOT MINIMUM HORIZONTAL SEPARATION FROM ANY UNDERGROUND UTILITY SHALL PROVIDED FOR SEWER MAINS, SEWER SERVICES, WATER MAINS, AND WATER SERVICES. HE MINIMUM HORIZONTAL SEPARATION IS MEASURED FROM OUTSIDE OF SEWER MAIN. EWER SERVICE, WATER MAIN, OR WATER SERVICE TO OUTSIDE OF UNDERGROUND UTILITY.
- ONE (1) FOOT MINIMUM VERTICAL SEPARATION FROM ANY DRY UNDERGROUND UTILITY ROSSING SHALL BE PROVIDED FOR SEWER MAINS, SEWER SERVICES, WATER MAINS, AND ATER SERVICES. THE MINIMUM VERTICAL SEPARATION IS MEASURED FROM OUTSIDE OF EWER MAIN. SEWER SERVICE, WATER MAIN, OR WATER SERVICE TO OUTSIDE OF DRY NDERGROUND UTILITY.
- TWO (2) FOOT MINIMUM VERTICAL SEPARATION SHALL BE PROVIDED BETWEEN ANY SEWER ND STORM DRAIN CROSSING A WATER MAIN, THE MINIMUM VERTICAL SEPARATION IS EASURED FROM OUTSIDE OF WATER MAIN TO OUTSIDE OF SEWER MAIN OR STORM DRAIN AIN. SEE M.A.G. STANDARD DETAIL 404 FOR ADDITIONAL INFORMATION ANO/OR PROVISIONS OR CLEARANCE.
- KCEPTIONS OR DEVIATIONS FROM THE ABOVE MINIMUM CLEARANCES MUST BE APPROVED ND SHOWN ON THE APPROVED WATER SEWER PLANS. WHEN UTILITY CONFLICTS ARE FOUND JRING CONSTRUCTION, ALL CHANGES AND REVISIONS MUST BE PRECEDED BY AN PPROVED PLAN REVISION.
- NY AND ALL MORE STRINGENT REQUIREMENTS REQUIRED BY FEDERAL, STATE, COUNTY OR OCAL CODES OR ORDINANCES TAKE PRECEDENCE.
- ATER SERVICES SHALL BE INSTALLED PERPENDICULAR TO THE WATER MAIN. WATER ERVICES AT THE END OF CUL-DE-SACS MAY VARY AS NECESSARY, BUT WILL BE PPROVED ON A CASE BY CASE BASIS.
- $_{\sf L}$ SERVICES SHALL RUN IN A STRAIGHT LINE FROM THE WATER MAIN TO THE METER BOX.
- EITHER WATER SERVICE METER BOX NOR ANY PORTION OF A WATER SERVICE SHALL BE STALLED UNDER AN EXISTING OR PROPOSED DRIVEWAY OR SIDEWALK RAMP.
- ONCRETE OR ASPHALT DAMAGED DURING THE COURSE OF CONSTRUCTION SHALL BE EMOVED AND REPLACED IN KIND PRIOR TO FINAL INSPECTION AT NO COST TO THE CITY.

20. RECORD DRAWING SUBMITTALS MUST COMPLY PER THE WATER SERVICES DEPARTMENT ENGINEERING POLICY P-68 AND P-69. A COPY OF THE POLICY CAN BE OBTAINED IN THE DEPARTMENT'S WEBSITE: HTTP://PHOENIX.GOV/WATERSERVICES/DESIGN/ENGPOLICIES/INDEX.HTML

WATER NOTES CONT.

- 21. IN ACCORDANCE WITH AAC R-18-4-213, ALL MATERIALS ADDED AFTER JANUARY 1, 1993 WHICH MAY COME INTO CONTACT WITH DRINKING WATER SHALL CONFORM TO NATIONAL SANITATION FOUNDATION STANDARDS 60 AND 61.
- 22. PER CITY OF PHOENIX CITY CODE CHAPTER 2, SECTION 2-28. THESE PLANS ARE FOR OFFICIAL USE ONLY AND MAY NOT BE SHARED WITH OTHERS EXCEPT AS REQUIRED TO FULFILL THE OBLIGATIONS OF THE CONTRACTOR'S CONTRACT WITH THE CITY OF PHOENIX.
- 23. A PAVEMENT CUT SURCHARGE SHALL BE ASSESSED ON THIS PROJECT FOR ANY TRENCHING OR POTHOLING IN NEW ASPHALT PAVEMENT THAT IS LESS THAN 30 MONTHS OLD. SURCHARGE FEES ASSESSED ARE IN ADDITION TO THE REGULAR PERMIT FEES AND ARE OVER AND ABOVE ANY SPECIAL BACKFILL, COMPACTION, AND PAVEMENT REPLACEMENT STIPULATIONS THAT MAY BE IMPOSED AS A CONDITION OF PERMITTING. PAVEMENT CUT SURCHARGE FEES ARE ASSESSED IN ACCORDANCE WITH SECTION 31-38 OF THE PHOENIX CITY CODE
- 24. PLAN APPROVAL IS VALID FOR 180 DAYS. PRIOR TO PLAN APPROVAL EXPIRATION, ALL ASSOCIATED PERMITS SHALL BE PURCHASED OR THE PLANS SHALL BE RESUBMITTED FOR EXTENSION OF PLAN APPROVAL. THE EXPIRATION, EXTENSION, AND REINSTATEMENT OF CIVIL ENGINEERING PLANS AND PERMITS SHALL FOLLOW THE SAME GUIDELINES AS THOSE INDICATED IN THE PHOENIX BUILDING CONSTRUCTION CODE ADMINISTRATIVE PROVISIONS SECTION 105.3 FOR BUILDING PERMITS.
- 25. FOR SHUTDOWNS NECESSARY TO ACCOMPLISH APPROVED WORK, THE CONTRACTOR SHALL CONTACT THE PROJECT INSPECTOR EARLY IN THE PROJECT TO COORDINATE A SHUTDOWN WITH THE WATER SERVICES DEPARTMENT, FIELD DISTRIBUTION & COLLECTIONS STAFF. THE CONTRACTOR SHALL HAVE ALL MATERIALS AND EQUIPMENT ON THE PROJECT SITE TO COMPLETE THE CONNECTION(S) PRIOR TO THE SHUTDOWN.

ONCE THE EXISTING WATER PIPE IS CUT, IT SHALL BE THE CONTRACTOR'S RESPONSIBILITY TO KEEP THE PIPE CLEAN AND FREE OF DIRT AND DEBRIS BY CAPPING THE ENDS UNTIL THE FINAL CONNECTIONS CAN BE COMPLETED, PRIOR TO THE FINAL CONNECTIONS, THE EXISTING PIPE SHALL BE SWABBED WITH A MINIMUM 50 PPM CHLORINE SOLUTION FOR A DISTANCE OF 10 FEET FROM THE OPENING.

THE CONTRACTOR SHALL BE RESPONSIBLE FOR MAINTAINING ACCESSIBILITY TO THE VALVE OPERATING NUT FOR ALL VALVES, WITHIN THE PROJECT BOUNDARIES. FAILURE TO MAINTAIN ACCESSIBILITY TO VALVES SHALL BE CAUSE FOR CANCELING THE SHUTDOWN AND THE CONTRACTOR MUST PROPERLY REQUEST A SCHEDULE REVISION.

THE WATER SERVICES DEPARTMENT IS INDEMNIFIED FOR ANY AND ALL RESULTANT COSTS INCURRED BY THE CONTRACTOR SUCH AS, BUT NOT LIMITED TO TRAFFIC CONTROL, DELAYS, LOSS OF INCENTIVES, STANDBY AND PENALTIES IF THE CONTRACTOR DID NOT PROPERLY REQUEST A SHUTDOWN; OR FAILED TO MAINTAIN ACCESSIBILITY TO VALVES; OR ON THE SCHEDULED DATE WORK HAD NOT PROGRESSED TO THE POINT AT WHICH THE SHUTDOWN WAS NEEDED.

- 26. VALVE BOX REMOVAL AFTER ACCEPTANCE OF THE NEW WATERLINES, FIRE HYDRANTS AND SERVICE CONNECTIONS THE CONTRACTOR SHALL SHUT THE VALVE, REMOVE THE BOX AND COVER, BACKFILL AND COMPACT THE VOID WITH ABC AS APPLICABLE, COVER WITH 2-INCH AC (C) PAVEMENT, OR AS REQUIRED TO MATCH EXISTING GROUND.
- 27. CUT AND PLUG -THE CONTRACTOR SHALL CUT AND PLUG EXISTING WATERLINES AS NOTED ON THE APPROVED PLANS AFTER ALL EXISTING WATER SERVICES HAVE BEEN TIED OVER TO THE NEW WATERLINE.
- 28. SWING CONNECTIONS AFTER THE NEW WATERLINE IS ACCEPTED FOR SERVICE, THE CONTRACTOR SHALL MAKE "SWING CONNECTIONS" TO EXISTING WATERLINES AS INDICATED ON THE APPROVED PLANS. "SWING CONNECTIONS" SHALL INCLUDE ALL PIPING AND APPURTENANCES (OFFSETS, BENDS, ETC.) REQUIRED TO AFFECT A CONNECTION
- 29. WATER SERVICES THE CONTRACTOR SHALL REPLACE EXISTING WATER SERVICES AS INDICATED ON THE APPROVED PLANS WITH NEW SERVICE PIPE AND CURB STOP FOR THE RELOCATED EXISTING WATER METERS. (ALL SERVICE CONNECTIONS MUST BE AT MINIMUM 1-INCH. FOR 3/4-INCH METERS, A 3/4-INCH REDUCER MUST BE INSTALLED TO ACCOMMODATE THE METER).
- 30. METER AND BOX THE CONTRACTOR SHALL RELOCATE THE EXISTING METERS AND METER BOXES, AND CONNECT THEM AS INDICATED ON THE APPROVED PLANS AFTER THE NEW WATERLINE HAS BEEN ACCEPTED FOR SERVICE.
- 31. NEW WATER METERS AND SERVICES WILL BE INSTALLED AFTER THE CONTRACTOR MAKES PROPER APPLICATION AND PAYS THE PREVAILING FEES. APPLICATION AND PAYMENT OF FEES CAN BE MADE AT THE FOLLOWING ADDRESS: CITY OF PHOENIX. WATER SERVICES DEPARTMENT. INFRASTRUCTURE RECORD SERVICES DIVISION. 200 WEST WASHINGTON STREET, 8TH FLOOR, PHOENIX, A2 85003.
- 32. SURPLUS ABANDONED FIRE HYDRANTS (BARREL PORTION ONLY) TO THE CITY OF PHOENIX WATER DEPARTMENT - SUPPORT SERVICES, 4436 N. 35TH AVENUE, PHOENIX. CONTACT THE WATER DEPARTMENT - SUPPORT SERVICES BY CALLING 602-262-5077 FOR ANY ADDITIONAL INFORMATION.
- 33. CITY OF PHOENIX WATER DEPARTMENT PERSONNEL SHALL REMOVE ALL PROPOSED EXISTING WATER METERS THAT ARE TO BE ABANDONED ONCE ALL REQUIRED FEES HAVE BEEN PAIN BY THE APPLICANT AT COUNTER 8 - CIVIL PERMITS, ON THE SECOND FLOOR OF CITY OF PHOENIX CITY HALL, LOCATED AT 200 W. WASHINGTON STREET.
- 34. ALL CONSTRUCTION ACTIVITIES SHALL BE CONTAINED WITHIN THE PUBLIC RIGHT OF WAY OR IN EASEMENTS GRANTED FOR THE WATER AND/OR SEWER MAIN INSTALLATION.
- 35. TRAFFIC CONTROL SHALL CONFORM TO THE RIGHT-OF-WAY MANAGEMENT PROGRAM (RMP), ADOPTED BY THE CITY OF PHOENIX AND SHALL ALSO BE SUBJECT TO CITY REVIEW AND APPROVAL.
- 36. ALL DIMENSIONS SHOWN ARE TO THE MONUMENT LINE OTHERWISE. IN RIGHT OF WAY, UNLESS NOTED



	F.H.W.A. REGION	STATE	PROJ. NO.	NO.	TOTAL	AS BUILT
VCIALES	9	ARIZ	ST83140122	35	50	
0. (81811)	12/23 DATE:	-	AZ	ZTE	EC TYPS	501 N. 44TH ST SUITE 300 PHOENIX, AZ 85008 PH: 602-454-0402 www.Aztec.us
12023	DRAWN:	LNB	DESIGN:	CJR	CHECK	ED: TMM

WATER NOTES CONT.

- 37. BIDDERS ARE ADVISED THAT THE LOCATION, NUMBER, AND TYPE OF UTILITIES SHOWN ON THESE PLANS AND SPECIFICATIONS ARE ONLY AS ACCURATE AS THE BEST INFORMATION AVAILABLE FROM PUBLIC UTILITIES, OWNERS, AND USERS AT THE TIME THESE PLANS AND SPECIFICATIONS WERE PREPARED. UNDERGROUND UTILITIES MAY BE PRESENT ON THIS PROJECT WHICH WERE NOT DISCLOSED TO THE ENGINEER. NO REPRESENTATION IS MADE THAT THE UTILITIES LOCATIONS INDICATED ON THESE PLANS ARE ACCURATE, COMPLETE, OR EXCLUSIVE. BIDDERS ARE ADVISED TO UNDERTAKE THEIR OWN INVESTIGATIONS OF EXISTING CONDITIONS BEFORE SUBMITTING A PROPOSAL ON THIS PROJECT. THE CONTRACTOR IS RESPONSIBLE FOR THE COST OF ALL TEST PITS OR THE PRE-CONSTRUCTION INVESTIGATION OF UNDERGROUND UTILITIES OR STRUCTURE. PURSUANT TO ARIZONA REVISED STATUTE 40-360.21, THE CONTRACTOR MUST CONTACT "BLUE STAKE" AT (602)261-1100 OR THE APPROPRIATE PUBLIC UTILITY FOR ASSISTANCE IN LOCATING UNDERGROUND FACILITIES, LINES, AND APPURTENANCES PRIOR TO CONSTRUCTION.
- 38. BY SUBMITTING A PROPOSAL ON THIS PROJECT, BIDDERS ARE REPRESENTING THAT THEY HAVE CONSIDERED THE POTENTIAL IMPACT OF TEMPORARY OR PERMANENT RELOCATION OF EXISTING UNDERGROUND UTILITIES LOCATED WITHIN THE PROJECT ON THEIR COSTS, AND THAT THEY HAVE INCLUDED IN THEIR PROPOSALS THE COST OF FINDING, PROTECTING, AND RELOCATING ALL EXISTING UTILITIES WITHIN THE PROJECT. NO ADDITIONAL COMPENSATION FOR DAMAGES WILL BE PAID FOR ANY COST, LOSS, DAMAGE, HINDRANCE, OR DELAY INCURRED BY A CONTRACTOR OR SUBCONTRACTOR DUE TO CONFLICTS WITH EXISTING UTILITIES; REGARDLESS OF WHETHER OR NOT THOSE UTILITIES ARE INDICATED ON THE PLANS OR SPECIFICATIONS FOR THIS PROJECT.
- 39. THE SOLE AND EXCLUSIVE REMEDY FOR ANY COST, HINDRANCE, OR DELAY CAUSED BY ANY UTILITIES LOCATED WITHIN THE PROJECT (WHETHER OR NOT INDICATED ON THE PLANS OR SPECIFICATIONS) SHALL BE AN EXTENSION OF THE CONTRACT TIME; THE NEED FOR OR DURATION OF WHICH SHALL BE DETERMINED BY THE ENGINEER IN ITS SOLE DISCRETION.
- 40. PER MAG SECTION 630, THE CONTRACTOR SHALL FURNISH SHOP DRAWINGS AND TECHNICAL DATA REQUIRED FOR EVALUATING AND APPROVAL OF EACH TYPE OF VALVE. TAPPING SLEEVE AND VALVE AND BUTTERFLY VALVE. SHOP DRAWINGS MUST BE SUBMITTED TO WATER SERVICES AFTER THE ENGINEER OF RECORD HAS PROVIDED THEIR RECOMMENDATION OR APPROVAL
- 41. THE CONTRACTOR SHALL USE EXTREME CAUTION WHILE WORKING IN THE VICINITY OF ALL GAS AND POWER LINES. THE CONTRACTOR SHALL MAINTAIN THE INTEGRITY OF THE GAS AND POWER TRENCHES AND PIPELINES AT ALL TIMES. SPECIAL ATTENTION SHALL BE GIVEN TO BRACING AND SUPPORT FOR UNDERGROUND POWER CROSSINGS. TRENCHING WITHIN A TWO FOOT VICINITY OF GAS LINES SHALL BE BY HAND. ALL POWER LINE CROSSINGS SHALL BE BRACED DURING CONSTRUCTION. BRACING SHALL BE A NON PAY ITEM UNLESS NOTED OTHERWISE. POLE BRACING MAY BE REQUIRED WHEN EXCAVATING NEAR POWER POLES.
- 42. THE CONTRACTOR SHALL SUPPORT AND PROTECT IN PLACE ALL EXISTING UTILITIES WITHIN THE EXCAVATION AS REQUIRED BY THE MAG SPECIFICATIONS.
- 43. THE CONTRACTOR SHALL CONSTRUCT PERMANENT OR TEMPORARY PIPE SUPPORTS AS SHOWN ON MAG STANDARD DETAILS 403-1, 403-2 AND 403-3 FOR ALL UTILITY CROSSINGS ON THIS PROJECT. PIPE SUPPORTS SHALL BE A NON PAY ITEM.
- 44. THE CONTRACTOR MUST PROTECT THE ADJACENT PROPERTY AND IMPROVEMENTS THERETO FROM ANY DAMAGE DURING CONSTRUCTION. ANY DAMAGE TO ADJACENT PROPERTY OR IMPROVEMENTS MUST BE REPAIRED OR REPLACED, TO THE PROPERTY OWNER'S SATISFACTION, AT THE CONTRACTOR'S EXPENSE.
- 45. OPEN CUT SLOPES AND SHORING FOR TRENCH EXCAVATIONS SHALL AS A MINIMUM COMPLY WITH OSHA REQUIREMENTS. WHERE EXCAVATIONS ARE DEEPER THAN 20 FEET, THE CONTRACTOR SHALL HAVE A PROFESSIONAL CIVIL ENGINEER, REGISTERED IN THE STATE OF ARIZONA, DESIGN OPEN CUT SLOPES AND SHORING. THE CONTRACTOR SHALL SUBMIT THE DESIGN TO THE ENGINEER FOR APPROVAL PRIOR TO CONSTRUCTION.

"PER CITY OF PHOENIX CITY CODE CHAPTER 2, SECTION 2-28 THESE PLANS ARE FOR OFFICIAL USE ONLY & MAY NOT BE SHARED WITH OTHERS EXCEPT AS REQUIRED TO FULFILL THE OBLIGATIONS OF THE CONTRACTOR'S CONTRACT WITH THE CITY OF PHOENIX."

LEGEND NOTES


CITY OF PHOENIX, ARIZONA STREET TRANSPORTATION DEPARTMENT

OTH PLACE AND CLARENDON AVE ST83140122

R: LNB DES: CJR CK: TMM DRAWING SERIES NO. ATE: 12/23 DATE: 12/23 DATE: 12/23 SCALE: NONE HORIZONTAL G-1.02

LOCAL DRAINAGE MITIGATION PROGRAM PHOENIX STREETS – MARICOPA CO.

CONTROL NOTE:

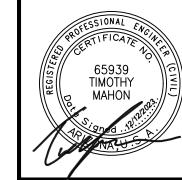


	F.H.W.A. REGION	STATE	PROJ. NO.	NO.	TOTAL	AS BUILT	
ER (CIVIL)	9	ARIZ	STST83140122	36	50		
	12/23 DATE:	-	AZ	ZTE	EC TYPS	501 N. 44TH ST SUITE 300 PHOENIX, AZ 85008 PH: 602-454-0402 www.Aztec.us	
′ //	DRAWN: LNB		DESIGN: CJR		CHECK	CHECKED: TMM	

THE HORIZONTAL DATUM IS NAD83(HARN) STATE PLANE, ARIZONA CENTRAL ZONE, ADJUSTED FROM GRID TO GROUND USING A COMBINED SCALE FACTOR OF 1.00016 WITH A SCALE POINT OF X=0.00, Y=0.00.

THE BASIS OF BEARING IS GRID NORTH NAD 83 STATE PLANE, ARIZONA CENTRAL ZONE

ELEVATIONS ARE ON THE NGVD29 VERTICAL DATUM

POINT	STATION	NORTHING	EASTING	DESCRIPTION
101	12+97.10	906466.9239	682826.3373	N 50TH ST
102	10+00.00	906169.8235	682825.2082	N 50TH ST/ E CLARENDON AVE
103	12+82.99	906170.3519	683108.2013	E CLARENDON AVE & N 50TH PL
104	14+00.00	906170.5644	683225.2113	E CLARENDON AVE
105	11+13.80	906283.6227	682825.6379	N 50TH ST/ E CLARENDON AVE
502	11+83.40	906283.3636	682687.2395	COP BENCHMARK

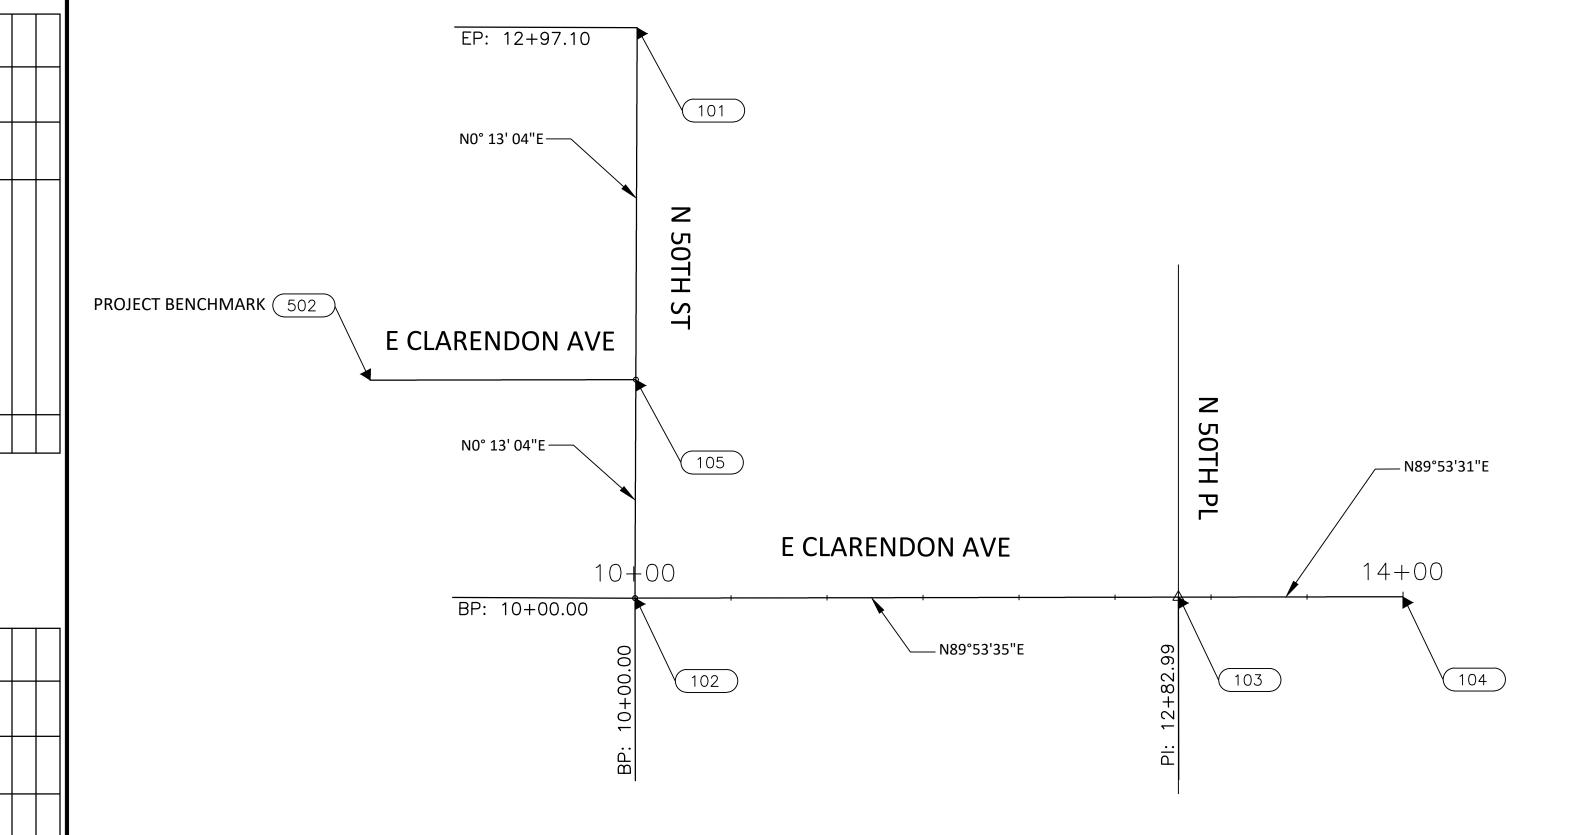



"PER CITY OF PHOENIX CITY CODE CHAPTER 2, SECTION 2-28 THESE PLANS ARE FOR OFFICIAL USE ONLY & MAY NOT BE SHARED WITH OTHERS EXCEPT AS REQUIRED TO FULFILL THE OBLIGATIONS OF THE CONTRACTOR'S CONTRACT WITH THE CITY OF PHOENIX."

GEOMETRIC CONTROL

CITY OF PHOENIX, ARIZONA STREET TRANSPORTATION DEPARTMENT

0TH PLACE AND CLARENDON AVE ST83140122

DR: LNB DES: CJR CK: TMM
DATE: 12/23 DATE: 12/23 DATE: 12/23

SCALE: 1"=50' HORIZONTAL G-2.01

City of Phoenix

cragan


F.H.W.A. REGION PROJ. NO. NO. TOTAL AMERICAN RESCUE PLAN ACT LOCAL DRAINAGE MITIGATION PROGRAM ST83140122 37 ARIZ PHOENIX STREETS - MARICOPA CO. 12/23 DATE: DRAWN: LNB DESIGN: CJR CHECKED: TMM ANTITY S MMARY DESCRIPTION TOTAL TY ITEM No. NIT SHEET N MBERS M###### (DESCRIPTION) NIT TOTAL TY SD 1.01 138 138 M3001002 | SAWCUT & REMOVE PORTLAND CEMENT CONCRETE CURB AND GUTTER LF SY M3010001 | SUBGRADE PREPARATION 282 282 M3360224 SAWCUT & REMOVE A.C. PAVEMENT, COP STD DTL P-1200 & MAG Spec 336 SY 2 2 SY 18 18 M3360224 PAVEMENT REPLACEMENT, COP STD DTL P-1200 & MAG Spec 336 SY M3362002 | SLURRY SEAL COAT 10 10 SF 120 120 M3400240 | CONSTRUCT VALLEY GUTTER AND APRON STD DET 240 M3402203 | CONCRETE ROLL CURB AND GUTTER, MAG STD DETAIL 220, TYPE "C" LF 138 138 SF M3402240 | CONCRETE VALLEY GUTTER & APRON, PER SDD-1.04 643 643 ADJUST EXISTING TYPE "A" WATER VALVE, STANDARD DETAIL P-1391 EA M34 3001 AND P-1391-1 M3 00020 REMOVE EXISTING VALLEY GUTTER SF 13 13 M 0 11 TRENCH DRAIN, PER SDD 1.01 SDD 1.02 EΑ 1 **KEY MAP** City of Phoenix \Box *_*11+38 10+00-87 11+00 CLARENDON AVE. 88 \mathcal{O} H O 67 13+00 11+00 12+00 14+00 CLARENDON AVE. 29 66 65 63 64 "PER CITY OF PHOENIX CITY CODE CHAPTER 2, SECTION 2-28 THESE PLANS ARE FOR OFFICIAL USE ONLY & MAY NOT BE SHARED WITH OTHERS EXCEPT AS REQUIRED TO FULFILL THE OBLIGATIONS OF THE CONTRACTOR'S CONTRACT WITH THE CITY OF PHOENIX." ANTITY S MMARY CITY OF PHOENIX, ARIZONA STREET TRANSPORTATION DEPARTMENT SD 1.01 0TH PLACE AND CLARENDON AVE ST83140122 DR: LNB DES: CJR CK: TMM
DATE: 12/23 DATE: 12/23 DATE: 12/23 DRAWING SERIES NO.


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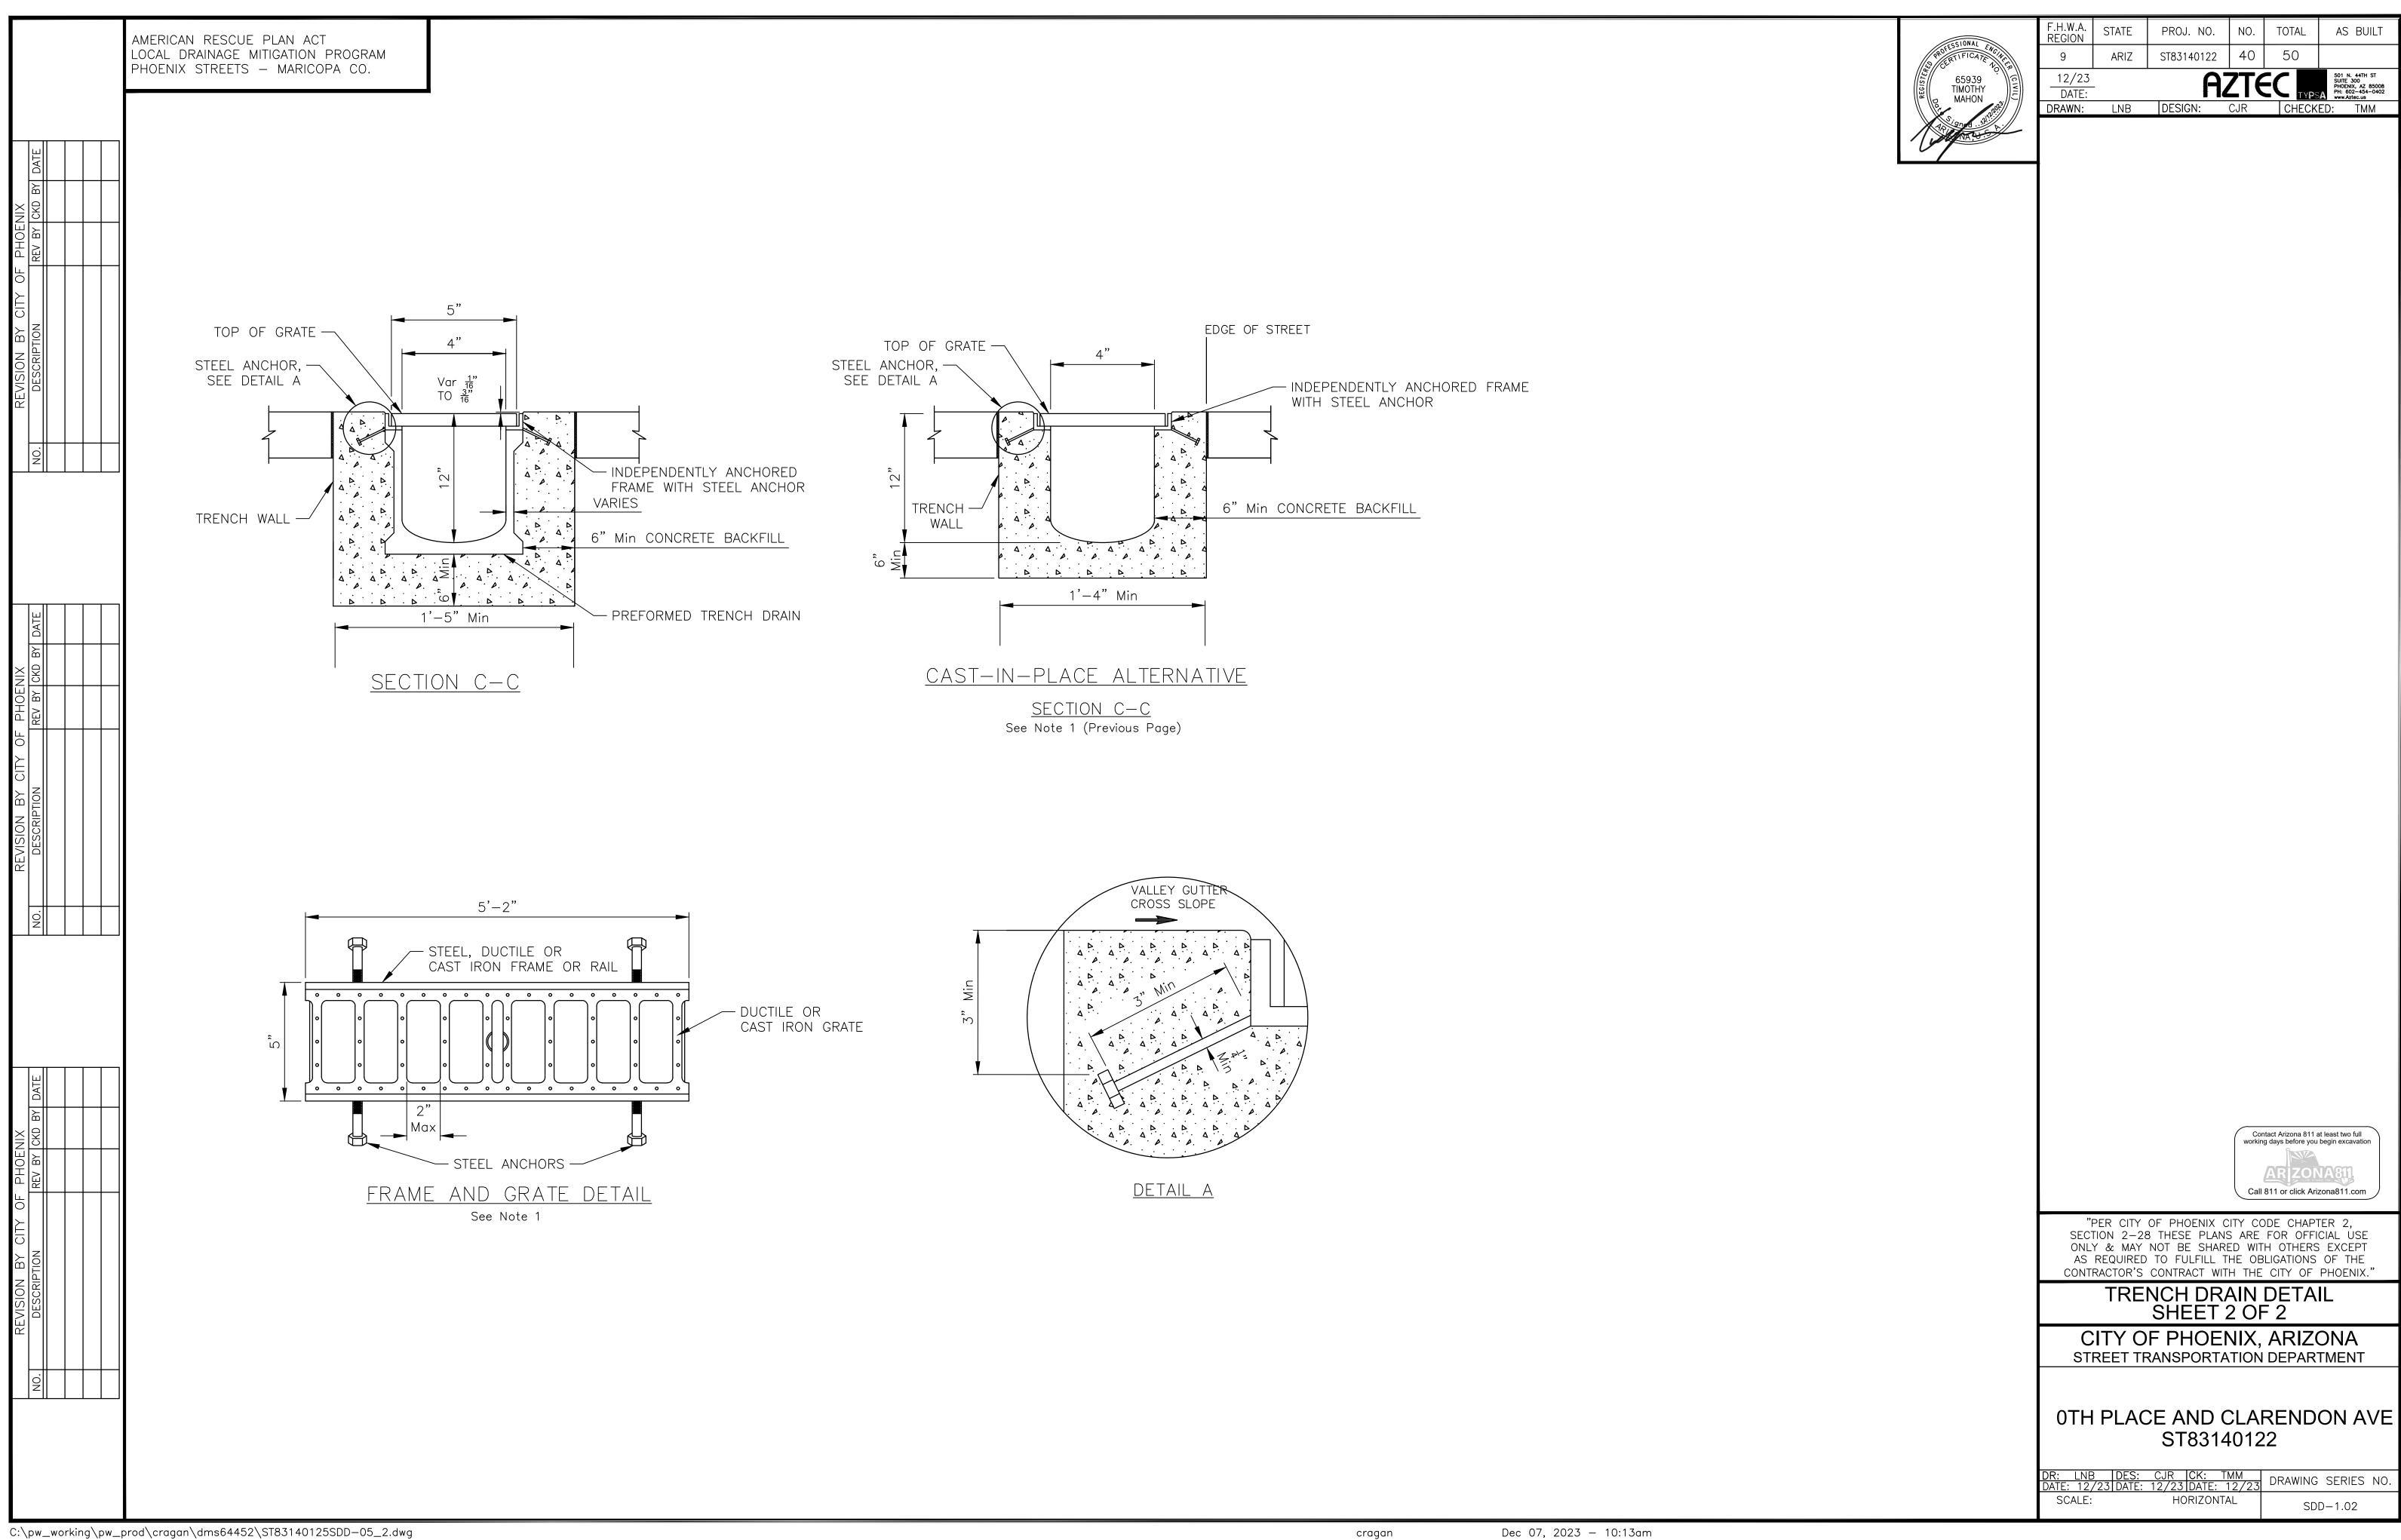
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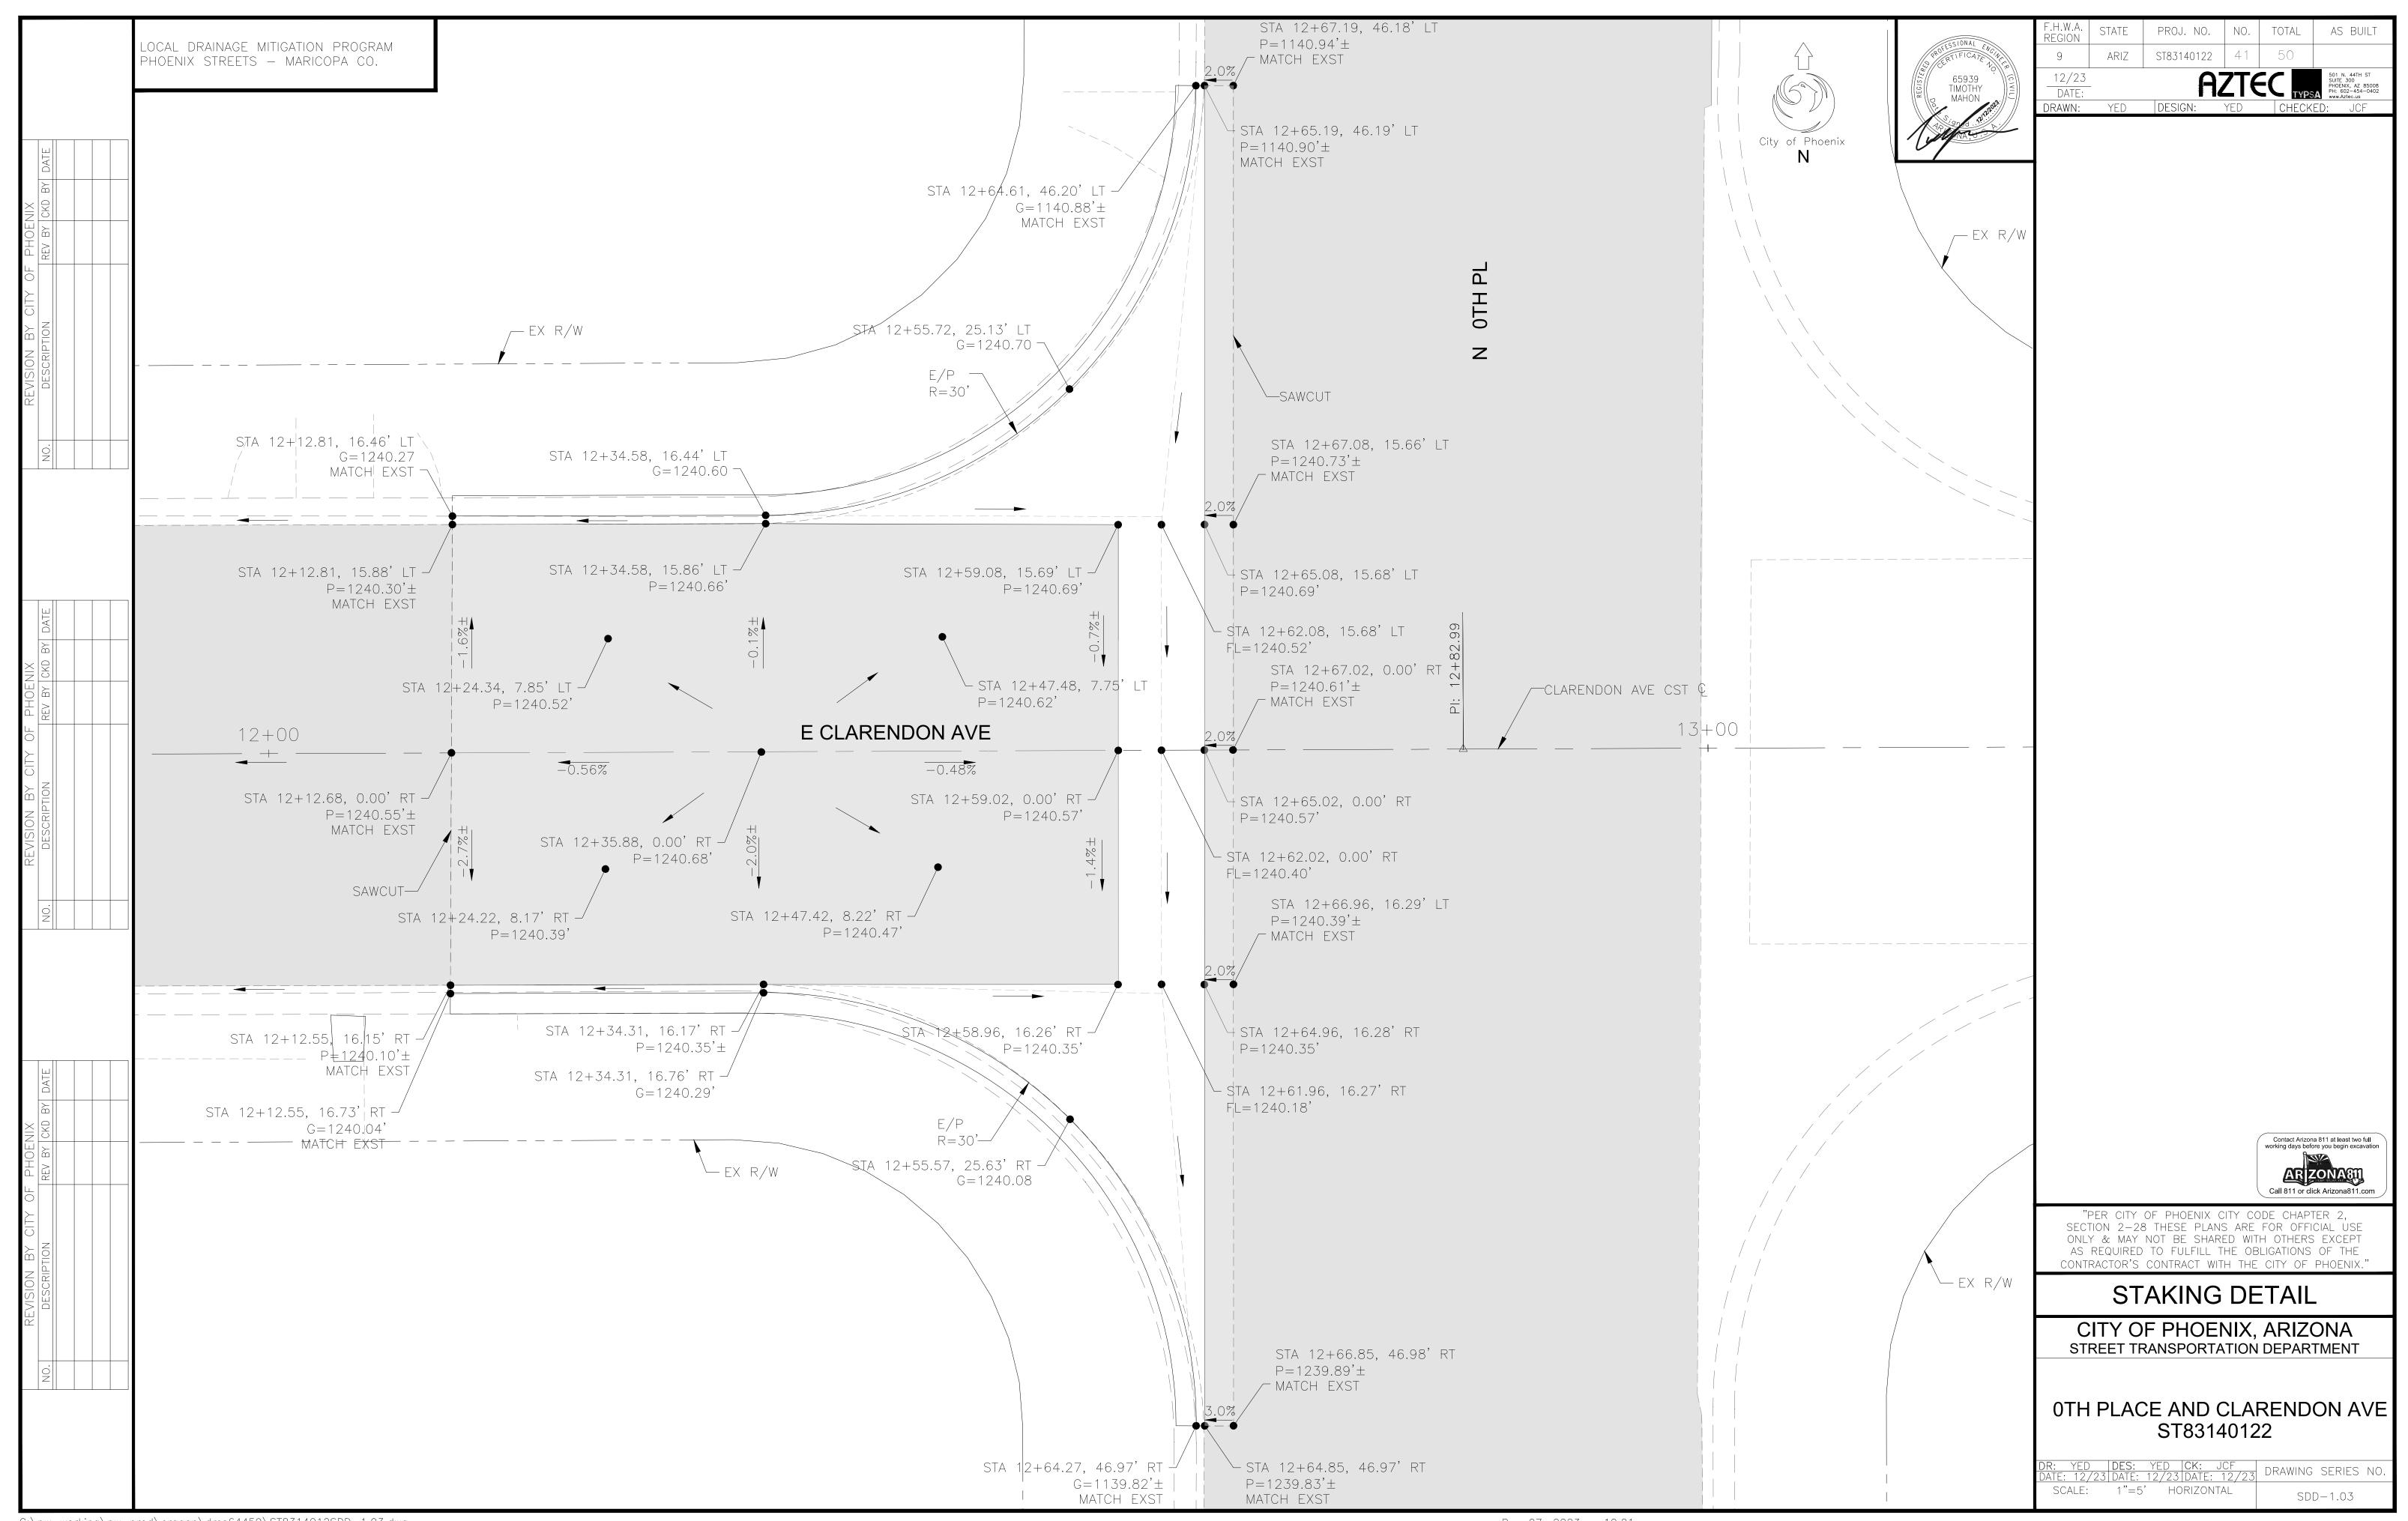
HORIZONTAL

G - 3.01






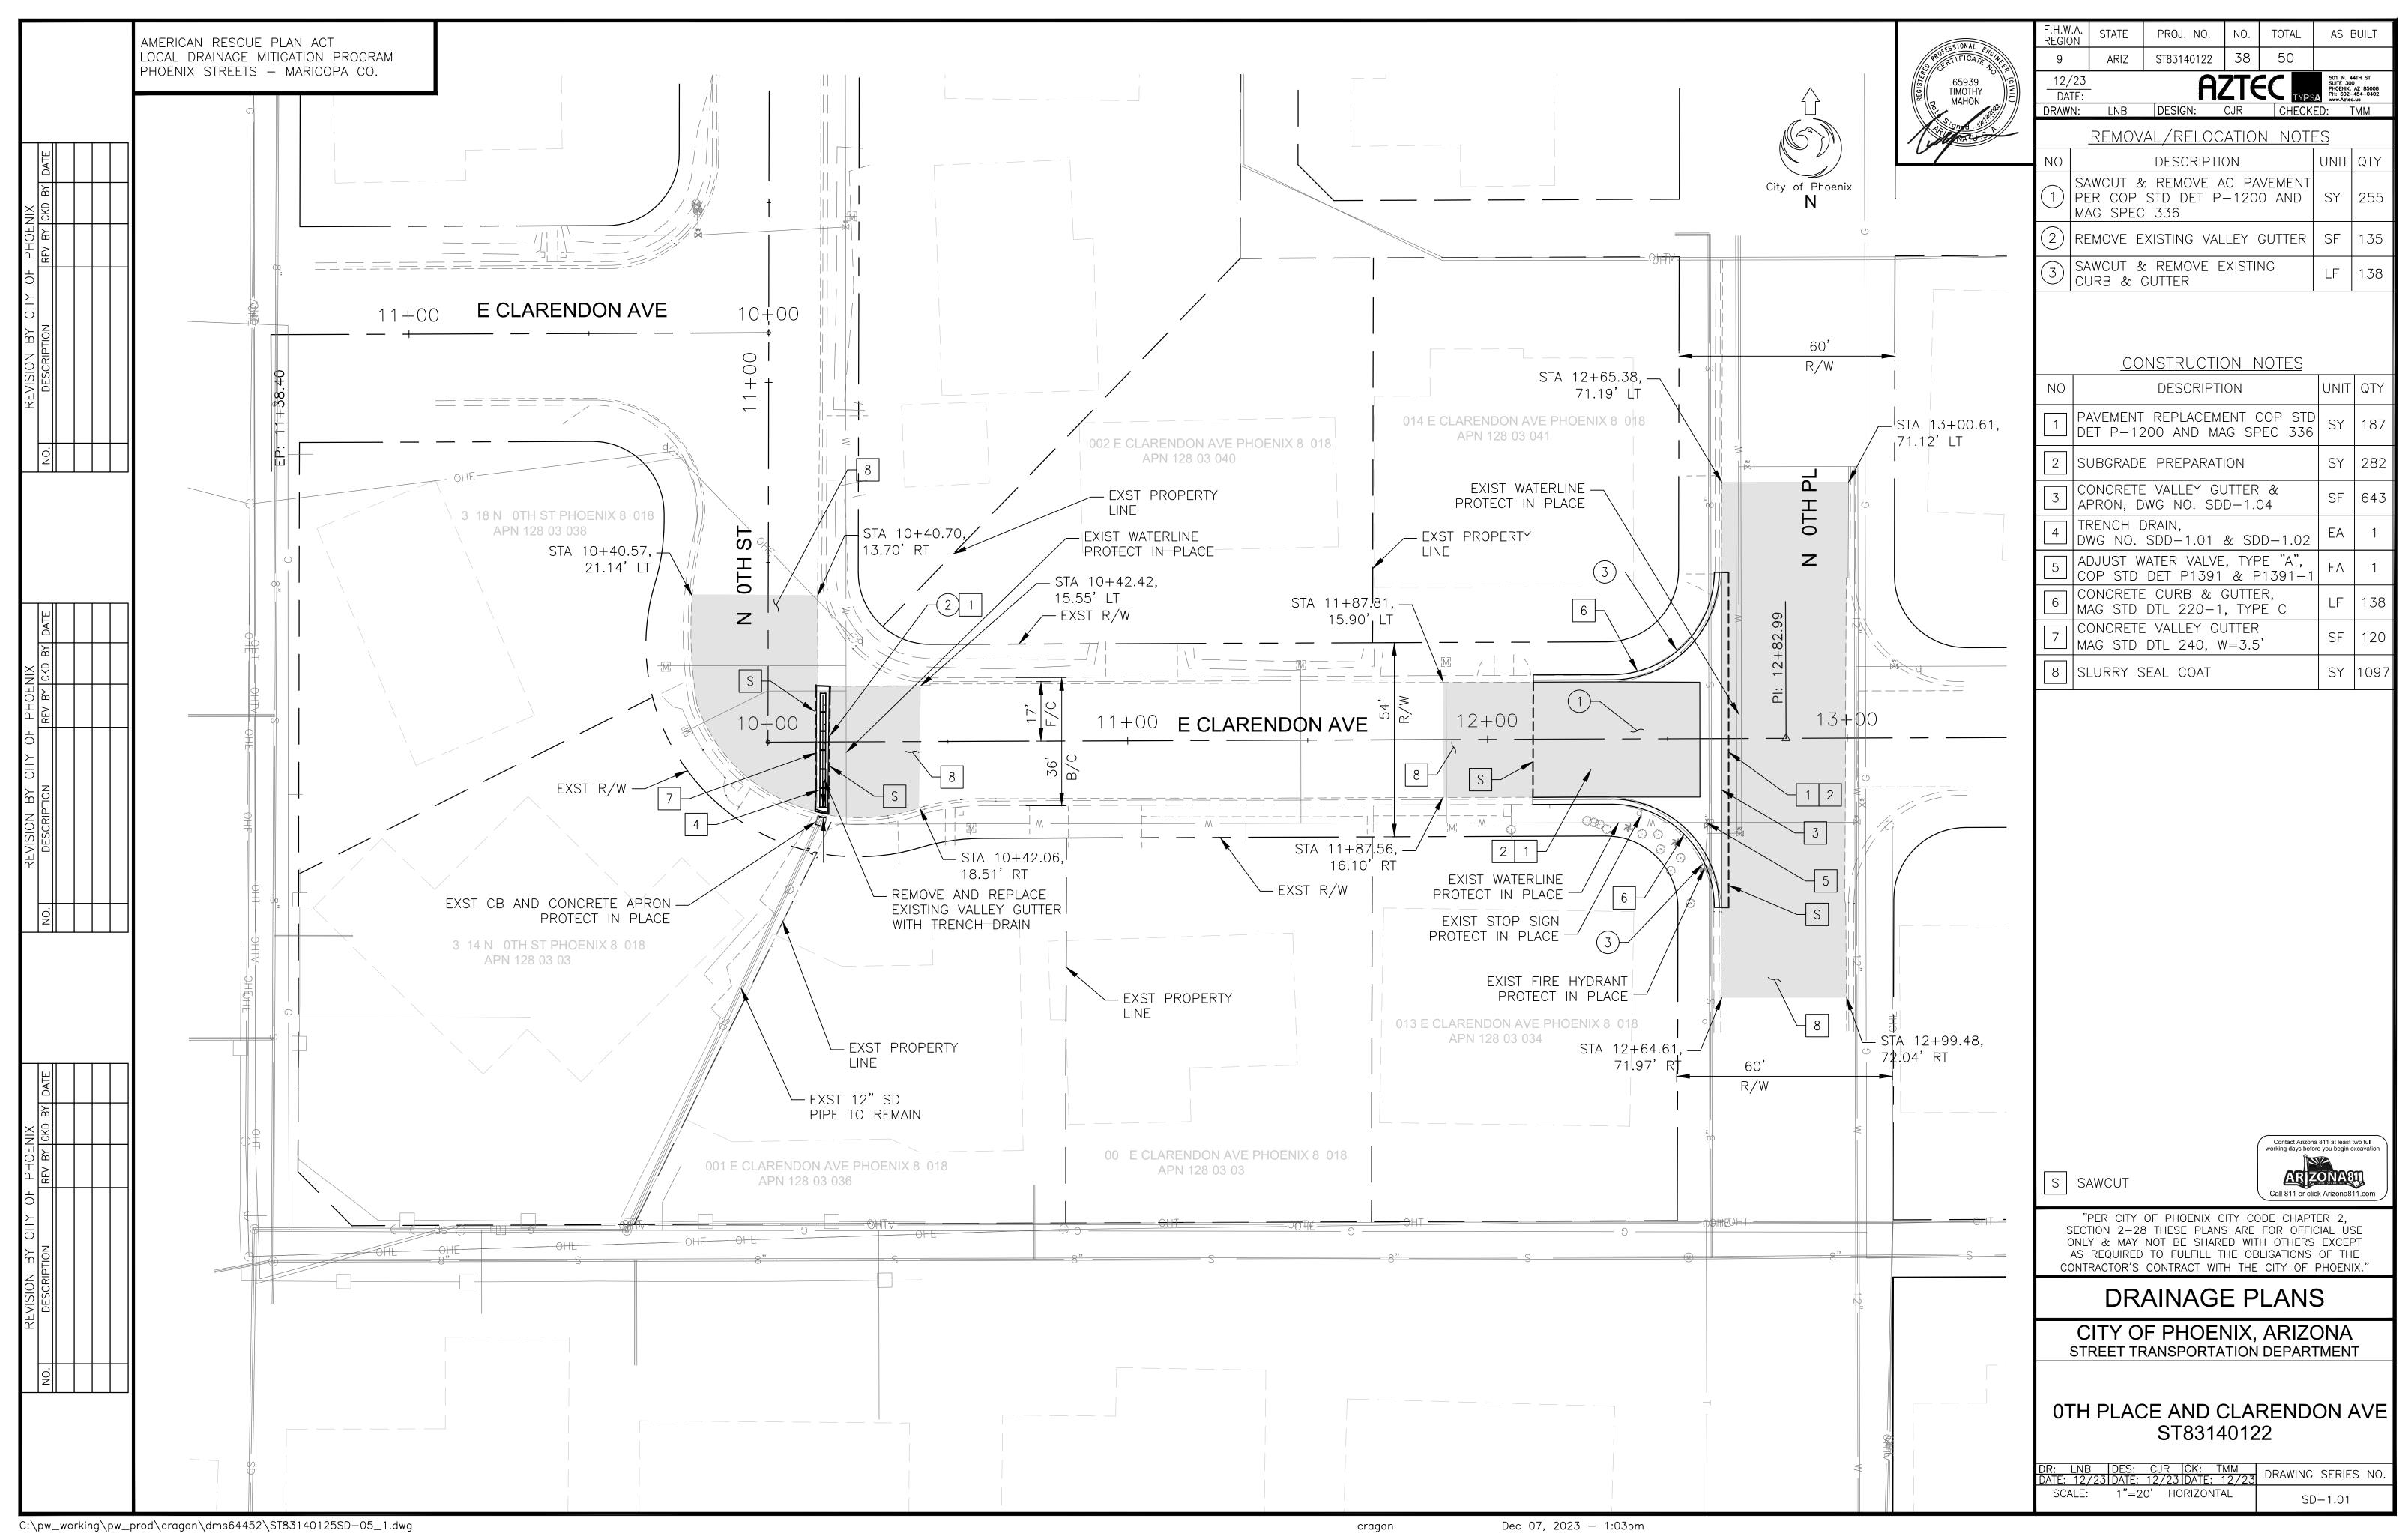

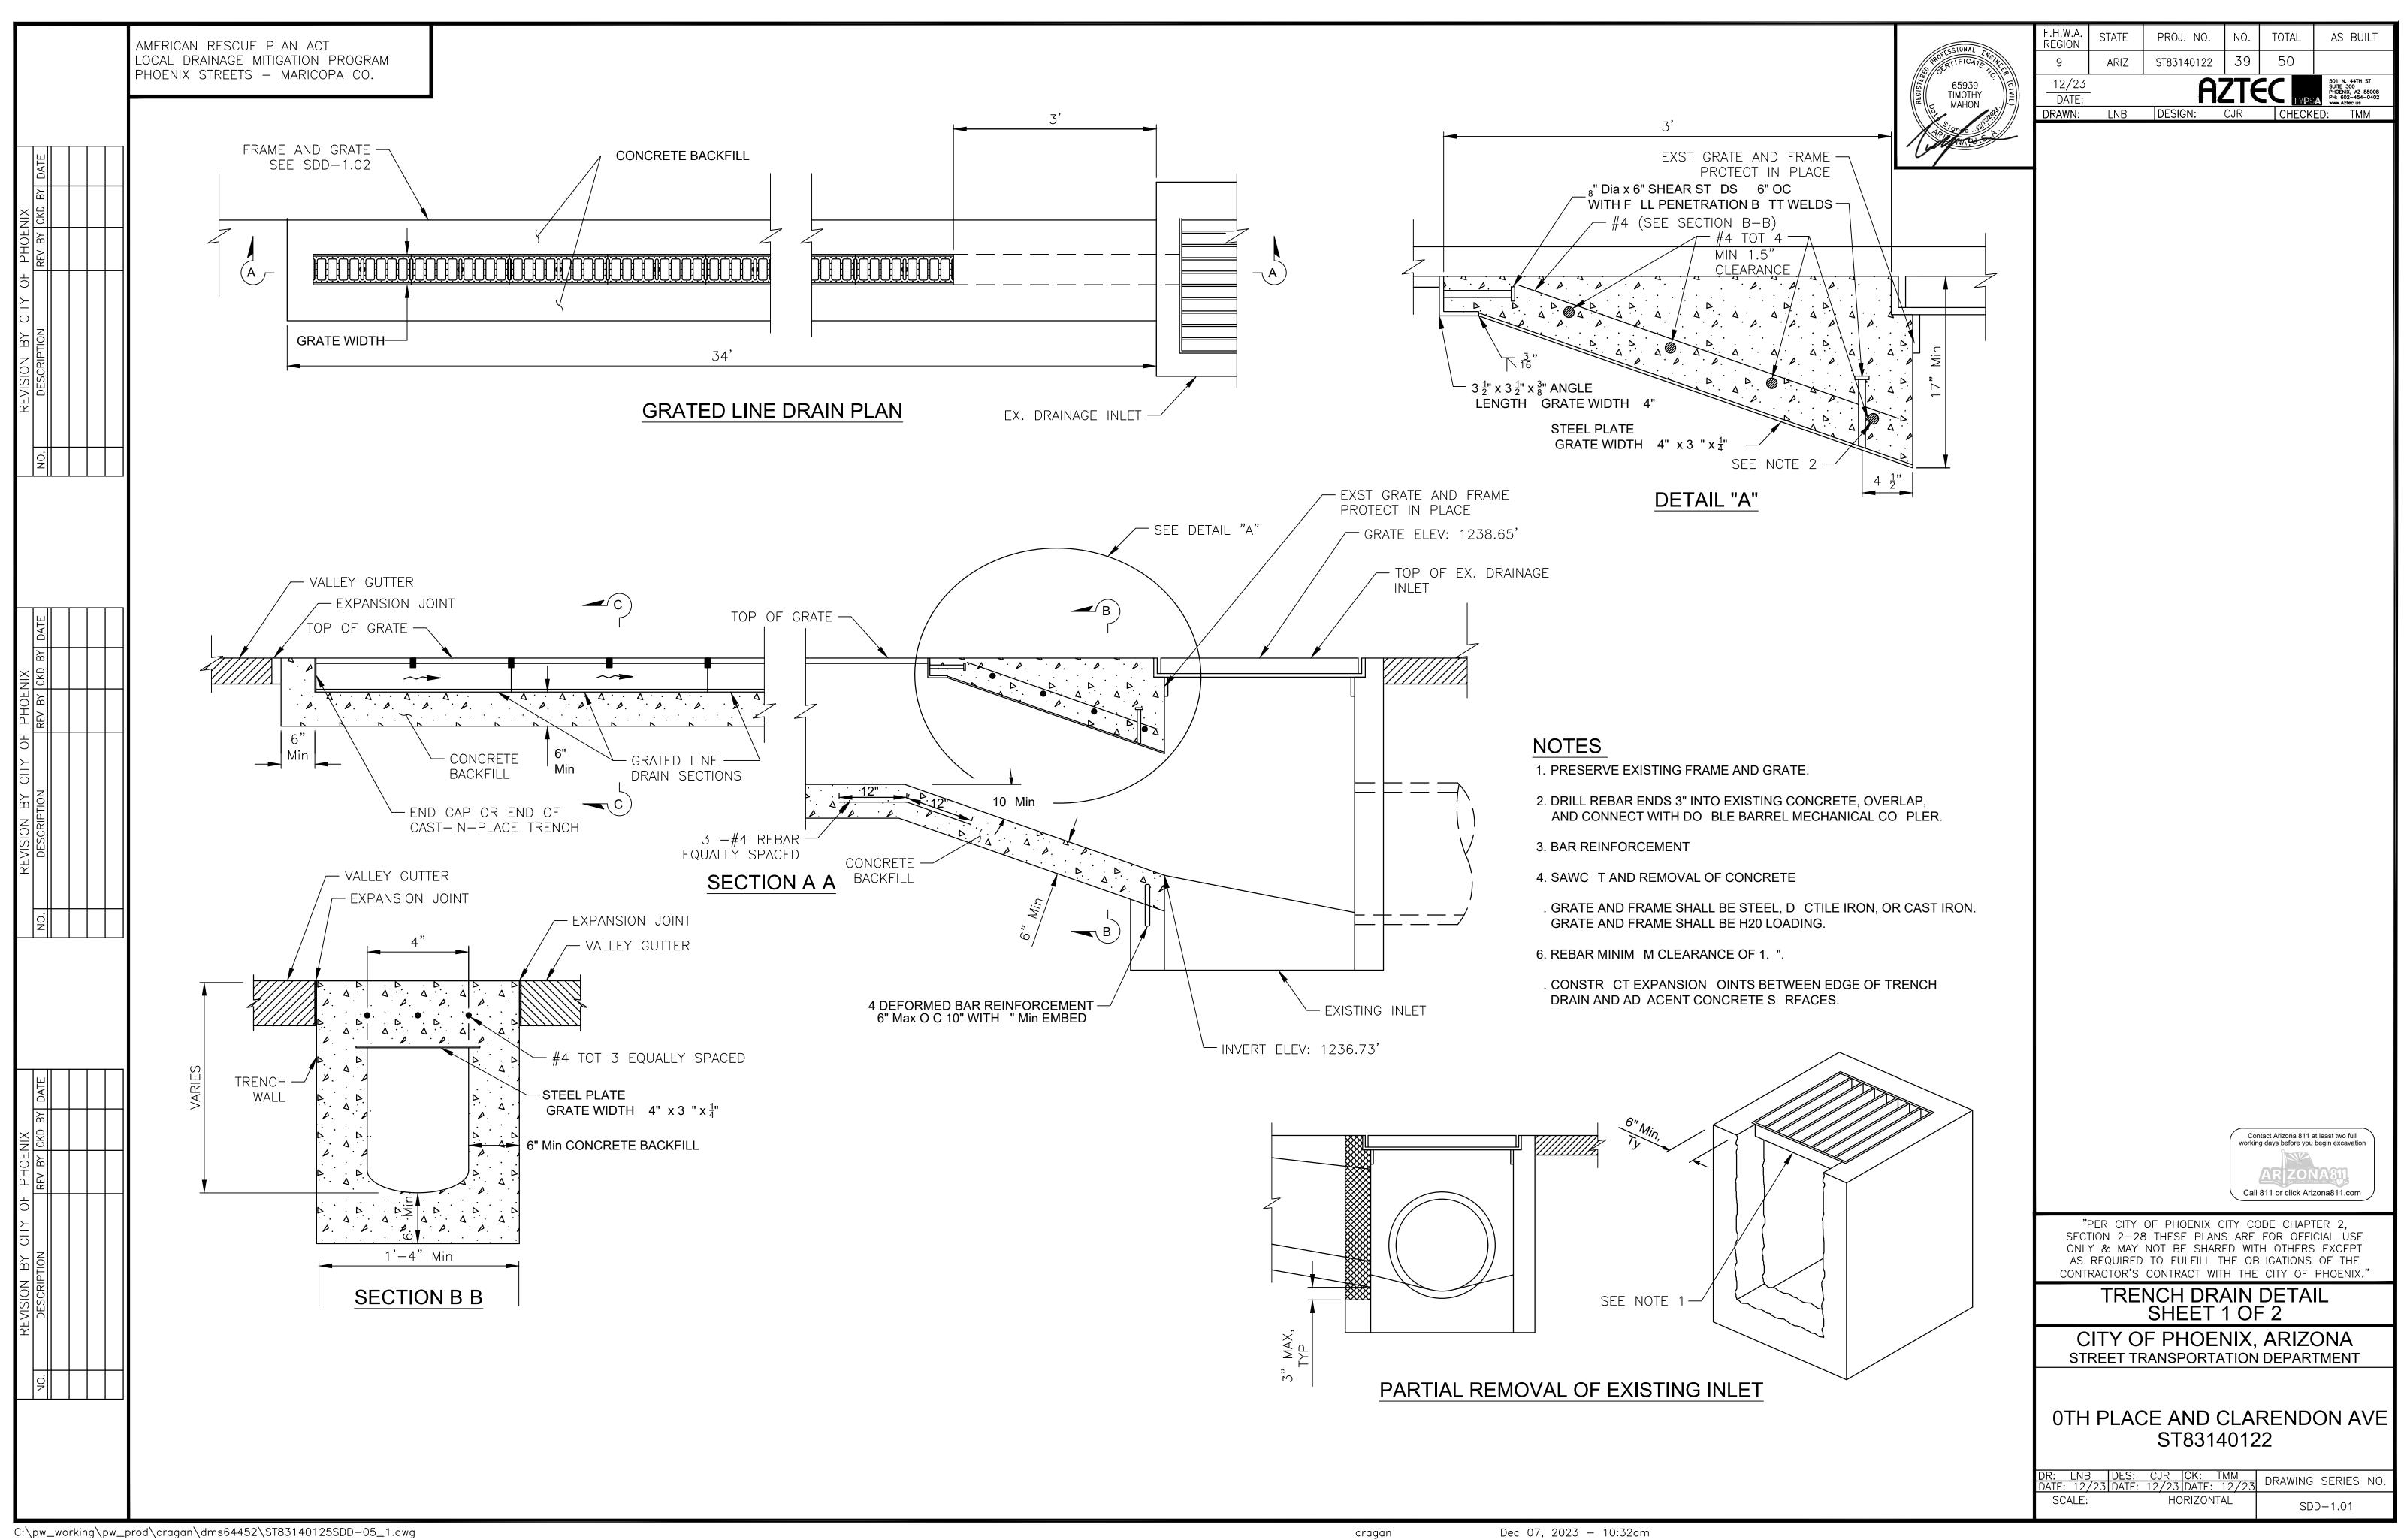

PROJ. NO. NO. TOTAL LOCAL DRAINAGE MITIGATION PROGRAM ARIZ ST83140122 PHOENIX STREETS - MARICOPA CO. DRAWN: YED DESIGN: YED _ EXPANSION JOINT FLOW LINE THIS AREA INDICATES LIMITS OF — VALLEY GUTTER MEASUREMENT — CONTRACTION JOINT AT APPROXIMATELY 1/3 DISTANCE FROM EXPANSION JOINT. (MATCH TO CURB RAMP JOINT OR SIDEWALK JOINT). EXPANSION JOINT — SEE NOTE 2 — - ELEVATION PER PLAN _ EXPANSION JOINT CONCRETE PAD REQUIRED — TOP OF CURB AT CONSTRUCTION JOINTS — SEE NOTE 2 _ EXPANSION JOINT Contact Arizona 811 at least two full working days before you begin excavation SUBGRADE PREPARATION - CONCRETE PAD AS PER SECT. 301 "PER CITY OF PHOENIX CITY CODE CHAPTER 2, SECTION 2-28 THESE PLANS ARE FOR OFFICIAL USE ONLY & MAY NOT BE SHARED WITH OTHERS EXCEPT AS REQUIRED TO FULFILL THE OBLIGATIONS OF THE CONTRACTOR'S CONTRACT WITH THE CITY OF PHOENIX." **SECTION A-A** 1. ALL CONCRETE TO BE CLASS 'A' UNLESS OTHERWISE APPROVED (SECTION 725) 2. EITHER A CONSTRUCTION JOINT OR CONTRACTION JOINT IS REQUIRED AT THE STREET VALLEY GUTTER VALLEY G TTER DETAIL 3. A SEPARATE CONCRETE PAD IS REQUIRED AT ALL EXPANSION JOINTS AND ALL CONSTRUCTION JOINTS. CITY OF PHOENIX, ARIZONA 4. EXPANSION JOINTS SHALL CONFORM TO SECTION 340. 5. CONTRACTION JOINTS SHALL SEPARATE LARGE AGGREGATE BY MOVING THE AGGREGATE STREET TRANSPORTATION DEPARTMENT TO EITHER SIDE OF THE JOINT FOR A MINIMUM DEPTH OF 2 $\frac{1}{2}$ INCHES. THE FINISHED JOINT SHALL HAVE $\frac{1}{4}$ INCH MAXIMUM RADII AT THE TOP SURFACE AND BE A MINIMUM 0TH PLACE AND CLARENDON AVE OF $\frac{3}{4}$ INCHES OF DEPTH. ST83140122 R: YED DES: YED CK: JCF DRAWING SERIES NO. SCALE: N.T.S. HORIZONTAL SDD-1.04

cragan

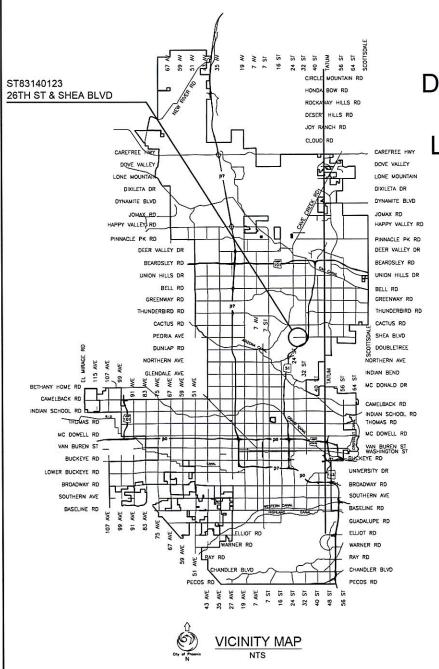

CITY OF PHOENIX STREET TRANSPORTATION DEPARTMENT **DESIGN & CONSTRUCTION MANAGEMENT DIVISION** AMERICAN RESCUE PLAN ACT LOCAL DRAINAGE MITIGATION PROJECT PACKAGE 1

26TH ST & SHEA BLVD ST83140123

FINAL DESIGN SUBMITTAL



2024

CITY BENCHMARKS

▲ COP BRASS CAP IN HAND HOLE, AT THE INTERSECTION OF 24TH ST AND SHEA BOULEVARD EL 1486.33 (NGVD-29)



		A7.	TEC		301 N. 44TH ST SUITE 300 PHOCHEK, AZ 85008 PH: 602-454-0402
9	ARIZ.	STST83140123	43	50	
F.H.W.A. REGION	STATE	PROJ. NO.	NO.	TOTAL	AS BUILT

DRAWN: LNB DESIGN: CJR CHECKED: TMM DATE: 12/23

MAYOR KATE GALLEGO

CITY MANAGER JEFFREY BARTON

CITY COUNCIL

DISTRICT	NO	1.	ANN O'BRIEN
DISTRICT	NO	2.	JIM WARING
DISTRICT	NO	3.	DEBRA STARK
DISTRICT	NO	4.	LAURA PASTOR
DISTRICT	NO	5.	BETTY GUARDADO
DISTRICT	NO	6.	KEVIN ROBINSON
DISTRICT	NO	7.	YASSAMIN ANSARI
DISTRICT	NO	8.	KESHA HODGE WASHINGTON

INDEX OF SHEET

SHEET NO.	DWG. SERIES NO.	SHEET TITLE
1	G-0.01	COVER
2-3	G-1.01-1.02	LEGEND AND NOTES
4	G-2.01	GEOMETRIC CONTROL
5	G-3.01	QUANTITY SUMMARY
6	SD-1.01	DRAINAGE PLANS
7-8	SD-2.01-2.02	CONNECTOR PIPE PROFILES

LENGTH OF PROJECT: SHEA BOULEVARD = 212 LF 26TH STREET = 180 LF

AREA OF DISTURBANCE = 5714 SQ.FT. = 0.13 ACRES



"PER CITY OF PHOENIX CITY CODE CHAPTER 2, SECTION 2-28, THESE PLANS ARE FOR OFFICIAL USE ONLY & MAY NOT BE SHARED WITH OTHERS EXCEPT AS REQUIRED TO FULFILL THE OBLIGATIONS OF YOUR CONTRACT WITH

& SHEA BLVD

6/4/2024

AMERICAN RESCUE PLAN ACT LOCAL DRAINAGE MITIGATION PROGRAM PHOENIX STREETS - MARICOPA CO. LEGEND BENCHMARK NEW SURVEY MONUMENT - M.A.G. DETAIL 120-1 TYPE "B" NEW SURVEY MONUMENT - M.A.G. DETAIL 120-1 TYPE "A" COMBINED CURB & GUTTER - M.A.G. DETAIL 220 TYPE "A" BACKFILL TYPE & SQ. YD. PVMT. REPLACEMENT — C.O.P. DETAIL P1200 Z/ZZ/ZZ EXISTING CONCRETE PAVEMENT OR SIDEWALK NEW CONCRETE DRIVEWAY OR ALLEY ENT. PER DETAIL NO. ON PLANS NEW CONCRETE SIDEWALK RAMP PER DETAIL ON PLANS AVERAGE GROUND ELEVATION AT R/W LINE BACKFILL COMPACTION TYPE _____ EXISTING DITCH 24" IRR (SRP) EXISTING IRRIGATION LINE W/SIZE (NOTE PRIVATE, SALT RIVER OR R.I.D.) - - EXISTING IRRIGATION STRUCTURE EXISTING IRRIGATION STANDPIPE NEW IRRIGATION STANDPIPE - M.A.G. DETAIL 503 NEW IRRIGATION VALVE - M.A.G. DETAIL 506 W/ CONC. SCOURING BASIN IRRIGATION BERM NEW IRRIGATION STRUCTURE PER DETAIL ON PLANS ——12" DIP W—— EXISTING WATER LINE W/SIZE & TYPE (12" AND SMALLER) ________ EXISTING WATER LINE W/SIZE & TYPE (GREATER THAN 12") → ADJUST EXIST. WATER VALVE BOX - C.O.P. DETAIL P1391 3/4" W—— WATER SERVICE W/SIZE AND WATER METER BOX EXISTING FIRE HYDRANT NEW OR RELOCATED FIRE HYDRANT BY CONTRACTOR EXISTING WATER VALVE W/TOP OF OPERATING NUT ELEVATION ----8" VCP S--- EXISTING SANITARY SEWER LINE W/SIZE & TYPE (12" AND SMALLER) 30" VCP S EXISTING SANITARY SEWER LINE W/SIZE & TYPE (GREATER THAN 12") ———— EXISTING MANHOLE CATCH BASIN, GUTTER INLET (LENGTH TO SCALE) CATCH BASIN, CURB INLET (LENGTH TO SCALE) CATCH BASIN, CURB & GUTTER INLET (LENGTH TO SCALE) — SD — EXISTING STORM DRAIN LINE W/SIZE & TYPE (GREATER THAN 12") NEW PIPE FOR STORM DRAIN OR IRRIGATION LINE

— 4"G—— EXISTING GAS LINE W/SIZE

----E EXISTING UNDERGROUND ELECTRIC CABLE OR SINGLE CONDUIT

——E-4D— EXISTING UNDERGROUND ELECTRIC DUCT (SPECIFY NUMBER)

EXISTING TELEPHONE BURIED CABLE OR SINGLE CONDUIT

— T-4D — EXISTING UNDERGROUND TELEPHONE DUCT (SPECIFY NUMBER)

——FO—— EXISTING UNDERGROUND FIBER OPTIC LINE

--- EXISTING TRAFFIC SIGNAL POLE W/MAST ARM & SIGNAL INDICATIONS

EXISTING STREET OR TRAFFIC SIGN

EXISTING UTILITY POLE W/LINE INDICATING WIRE DIRECTION

EXISTING BLOCK FENCE ----- EXISTING WOOD FENCE

MAIL BOX

EXISTING POWER POLE DOWN GUY ANCHOR

EXISTING STREET LIGHT & POLE

 \Diamond \Diamond

EXISTING TREE OR STUMP TO BE REMOVED - MORE THAN 12" DIA.

EXISTING TREE TO BE TRANSPLANTED BY CONTRACTOR

EASEMENT LINE

EXISTING OR NEW R/W LINE PAVEMENT CENTER LINE OR MONUMENT LINE

EXISTING TREE OR STUMP TO BE REMOVED 12" DIA. OR LESS (NON PAY ITEM)

EXISTING TREE TO REMAIN

LEGEND AND NOTES

NOTES

- 1. ALL CONSTRUCTION SHALL BE PERFORMED IN ACCORDANCE WITH CONTRACT SPECIFICATIONS; PLANS; CITY OF PHOENIX SUPPLEMENTS TO MAG STANDARD SPECIFICATIONS AND DETAILS; AND MAG STANDARD SPECIFICATIONS AND DETAILS, IN THAT ORDER OF PRECEDENCE, AT THE TIME OF CONSTRUCTION BID.
- 2. ALL STORM SEWER MANHOLES ARE TO BE CONSTRUCTED WITHOUT
- 3. NEW MANHOLE COVERS LOCATED IN SIDEWALK SHALL BE GROUND TO OBLITERATE RAISED LETTERING, AND PROVIDE A SMOOTH SURFACE FLUSH WITH THE ADJACENT SIDEWALK.
- 4. PIPE CONNECTIONS TO EXISTING CONCRETE PIPE MAINS SHALL BE MADE IN ACCORDANCE WITH DETAILS CALLED OUT ON THE PLANS. CONNECTION TO MAINS SHALL NOT BE CLOSER THAN 5', CENTER TO CENTER.
- 5. PIPE CONNECTIONS TO NEW PRECAST CONCRETE PIPE MAINS SHALL BE MADE WITH FACTORY MADE WYES OR TEES. THE DETAIL OF THE FITTINGS MUST BE SUBMITTED TO THE ENGINEER FOR APPROVAL PRIOR TO MANUFACTURE. PIPE CONNECTIONS TO NEW CAST IN PLACE CONCRETE PIPE MAINS SHALL BE MADE PER COP DETAIL P1576.
- 6. CATCH BASIN CONNECTOR PIPES SHALL BE LAID ON A STRAIGHT ALIGNMENT AND SLOPE UNLESS OTHERWISE SPECIFIED. IF BREAKS IN ALIGNMENT OR SLOPE ARE NECESSARY TO MEET FIELD CONDITIONS. THE MAXIMUM DEFLECTION SHALL BE $22-1/2^{\circ}$. THE BEND SHALL BE COLLARED ACCORDING TO COP DETAIL P1505. ANY ANGLE BENDS GREATER THAN 22-1/2° SHALL BE PREFABRICATED.
- 7. CONNECTOR PIPES SHALL CONNECT TO CATCH BASIN WALLS AT AN ANGLE NOT TO EXCEED 22-1/2 FROM PERPENDICULAR.
- 8. FACILITIES WHICH ARE NOT SPECIFICALLY LOCATED WITH ACTUAL VERTICAL AND HORIZONTAL CONTROLS, ARE LOCATED ONLY APPROXIMATELY AND TO THE BEST AVAILABLE INFORMATION PROVIDED BY VARIOUS OWNERS OF THE FACILITIES AND SUPPLEMENTED BY VISUAL SURFACE INFORMATION WHERE APPROPRIATE. ACCURACY, LOCATION AND COMPLETENESS OF THIS INFORMATION SHALL BE VERIFIED BY THE CONTRACTOR PRIOR TO INITIATION OF CONSTRUCTION.
- 9. A ONE (1) FOOT MINIMUM VERTICAL SEPARATION FROM DRY UTILITIES CROSSINGS SHALL BE PROVIDED FOR SEWER MAINS SEWER SERVICES, WATER MAIN, OR WATER SERVICE TO OUTSIDE UNDERGROUND UTILITY.
- 10. AT LEAST TWO WORKING DAYS BEFORE CONSTRUCTION, THE CONTRACTOR SHALL CONTACT BLUESTAKE TO FIND AND FLAG UNDERGROUND UTILITIES. THE CONTRACTOR SHALL CONTACT OTHER APPROPRIATE UTILITIES DIRECTLY IF THEY ARE NOT ON BLUESTAKE SYSTEM.
- 11. VERTICAL CONTROL IS BASED ON NATIONAL GEODETIC SURVEY.
- 12. UNLESS OTHERWISE NOTED, STATIONS SHOWN ON PIPE PROFILES ARE ALONG CENTERLINE OF PIPE.
- 13. UNLESS OTHERWISE NOTED, PIPE SHALL BE BEDDED IN ACCORDANCE WITH CITY OF PHOENIX DETAIL P1200.
- 14. CATCH BASINS ARE STATIONED PERPENDICULAR TO THE CENTERLINE OF THE STREET AT THE CENTERLINE OF THE MAINTENANCE BASIN.
- 15. SANITARY SEWER MAINS AND TAPS CROSSING OVER STORM DRAIN MAINS SHALL BE SUPPORTED PER MAG DETAIL 403-1, 403-2, OR 403-3.
- 16. ALL EXISTING PRECAST CONCRETE SAFETY CURBS AND ALL EXISTING WOODEN PARKING CURBS WHICH ARE INSIDE THE RIGHT OF WAY AND APPROXIMATELY PARALLEL TO THE NEW CURB LINE SHALL BE RESET ON THE RIGHT OF WAY DIRECTLY OPPOSITE THEIR EXISTING LOCATION, WITH THE BACK EDGE ON THE RIGHT OF WAY LINE. ALL OTHER PRECAST CONCRETE SAFETY CURBS INSIDE THE STREET RIGHT OF WAY SHALL BE SALVAGED AND STOCK PILED FOR THE OWNER AT THE RIGHT OF WAY LINE.
- 17. EXISTING PRECAST CONCRETE SAFETY CURBS OUTSIDE THE RIGHT OF WAY WHICH ARE DISTURBED BY NEW CONSTRUCTION SHALL BE RESET IN THEIR ORIGINAL POSITION BY THE CONTRACTOR. THERE WILL BE NO SEPARATE MEASUREMENT OR PAYMENT FOR THIS WORK, THE COST BEING CONSIDERED INCLUDED.
- 18. ALL EXISTING DRIVEWAYS AND ALL EXISTING ALLEYS SHALL BE GRADED TO MATCH THE NEW WORK IN ACCORDANCE WITH STD DETAIL P1164, UNLESS OTHERWISE SPECIFIED. EXISTING SURFACING SHALL BE REMOVED AND REPLACED AS NECESSARY.

NOTES CONT

- 19. CONTACT INSPECTOR IF LESS THAN 6 INCHES OR COVER WILL BE MAINTAINED BELOW SCARIFICATION DEPTH CONTRACTOR TO FIELD VERIFY DEPTH AT LOCATION OF NEW AC AND SIDEWALK.
- 20. IN HISTORIC PRESERVATION ZONES, THE CONTRACTOR SHALL DISTURB AS LITTLE OF HISTORIC SIDEWALK AS POSSIBLE. UNLESS OTHERWISE PROVIDED ON THE PLANS:
- THE SPACE BETWEEN THE BACK OF NEW DRIVEWAY ENTRANCES AND EXISTING AC DRIVEWAYS SHALL BE FILLED WITH A MINIMUM OF 3" COMPACTED NATIVE SOIL. WHERE EXISTING PAVEMENT AND BASE THICKNESS EXCEED THE MINIMUMS, MATCH THE EXISTING.
- THE SPACE BETWEEN THE BACK OF NEW SIDEWALKS AND EXISTING PRIVATE SIDEWALKS. AND THE SPACE BETWEEN THE BACK OF NEW DRIVEWAY ENTRANCES AND EXISTING PCC DRIVEWAYS SHALL BE FILLED WITH PCC. THE THICKNESS AND CLASS SHALL MATCH THAT OF THE NEW SIDEWALK OR DRIVEWAY ENTRANCE.
- THE SPACE BETWEEN THE BACK OF THE SIDEWALKS AND EXISTING AC PARKING LOTS, WHICH FALL WITHIN OR ABUT THE R/W SHALL BE FILLED WITH 2" ACSC ON 100% COMPACTED NATIVE SOIL.
- 21. EXISTING IRRIGATION BERMS DISTURBED BY NEW CONSTRUCTION SHALL BE RECONSTRUCTED AS SHOWN ON PLANS.
- 22. CATCH BASIN ACCESS FRAME AND COVERS SHALL BE CONSTRUCTED PER COP DETAIL P1561.
- 23. ANY PERSON PERFORMING ACTIVITY OR OPERATING ANY MECHANICAL EQUIPMENT WITHIN 25 FT OF ANY OVERHEAD POWERLINES SHALL CONTACT SAFETY SERVICES AS 602-236-8117 OR EMAIL PUBLICSAFETY@SRPNET.COM TO SCHEDULE AN ONSITE POWERLINE PRECONSTRUCTION CONSULTATION.

STR CT RAL NOTES

- 1. "CLEAR" DIMENSIONS FOR DEPTH OF REINFORCING STEEL ARE FROM FACE OF CONCRETE TO FACE OF BARS.
- 2. ALL EXPOSED EDGES OF CONCRETE SHALL BE BEVELED OR ROUNDED.
- 3. ALL EXPOSED CONCRETE SURFACES SHALL BE FINISHED IN ACCORDANCE WITH MARICOPA ASSOCIATION OF GOVERNMENTS (MAG) STANDARD SPECIFICATION 505.9 - FINISHING CONCRETE, UNLESS OTHERWISE SPECIFIED.

PAVING NOTES

- 1. COMPACTION SHALL COMPLY WITH MAG SECTION 601.
- 2. CONSTRUCTION WITHIN THE RIGHT-OF-WAY SHALL CONFORM TO THE LATEST APPLICABLE MAG UNIFORM STANDARD SPECIFICATIONS AND DETAILS AND THE LATEST CITY OF PHOENIX SUPPLEMENT TO THE MAG UNIFORM STANDARD SPECIFICATIONS AND DETAILS.
- 3. THE CITY OF PHOENIX PLANNING AND DEVELOPMENT CIVIL/SITE INSPECTION GROUP, 602-262-7811 VOICE OR 7-1-1 TTY, SHALL BE NOTIFIED 48 HOURS PRIOR TO ANY CONSTRUCTION WORK WITHIN THE PUBLIC RIGHT-OF-WAY.
- 4. EXISTING OR NEWLY DAMAGED AND/OR DISPLACED CONCRETE CURB, GUTTER, SIDEWALK, OR DRIVEWAY SLAB THAT IS WITHIN THE RIGHT-OF-WAY SHALL BE REPAIRED OR REPLACED, AS NOTED BY CITY INSPECTORS, BEFORE FINAL ACCEPTANCE OF THE WORK.
- 5. ALL NEW OR RELOCATED UTILITIES SHALL BE PLACED UNDERGROUND.
- 6. THE ACTUAL POINT OF PAVEMENT MATCHING, AND/OR TERMINATION, SHALL BE DETERMINED IN THE FIELD BY THE PLANNING AND DEVELOPMENT DEPARTMENT CIVIL/SITE INSPECTOR.
- 7. AN APPROVED PAVING PLAN SHALL BE ON THE JOB SITE AT ALL TIMES. DEVIATIONS FROM THE PLAN MUST BE PRECEDEDBY AN APPROVED PLAN REVISION.
- OBSTRUCTIONS TO PROPOSED IMPROVEMENTS IN THE RIGHT-OF-WAY SHALL BE REMOVED OR RELOCATED BEFORE BEGINNING CONSTRUCTION OF THE PROPOSED IMPROVEMENTS.
- 9. CONSTRUCTION OF SURFACE IMPROVEMENTS SHALL NOT BEGIN UNTIL CONFLICTING UNDERGROUND UTILITY CONSTRUCTION IS COMPLETED AND SERVICE CONNECTIONS TO ALL PLATTED LOTS HAVE BEEN ADEQUATELY EXTENDED PAST THE RIGHT-OF-WAY.



PROJ. NO. NO. TOTAL AS BUILT REGION | 44 | ARIZ ST83140123 12/23 DATE: DRAWN: LNB DESIGN: CJR CHECKED: TMM

PAVING NOTES CONT

- 10. ALL FRAMES, COVERS, VALVE BOXES, AND MANHOLE COVERS SHALL BE ADJUSTED TO FINISH GRADE PRIOR TO COMPLETION OF PAVING OR RELATED CONSTRUCTION. ADJUSTMENT OF EXISTING "TYPE A" OR "TYPE B" WATERLINE VALVE BOXES IN THE PARKWAY SHALL BE CONSIDERED INCIDENTAL TO PARKWAY GRADING. EXISTING "TYPE B" WATERLINE VALVE BOXES SHALL BE REPLACED WITH "TYPE A BOXES PER CITY OF PHOENIX STANDARD DETAIL P1391.
- 11. GRADING BETWEEN BACK OF CURB AND PROPERTY LINE SHALL BE LIMITED TO 4:1 SLOPE.
- 12. THE PLANNING AND DEVELOPMENT CIVIL/SITE INSPECTOR MUST CONTACT STREET TRANSPORTATION DEPARTMENT, TRAFFIC SERVICES DIVISION AT 602-495-0205 VOICE OR 7-1-1 TTY TWO (2) WEEKS PRIOR TO COMPLETION OF PAVING WORK FOR SIGNING & STRIPING.
- 13. AUTHORIZATION TO RESTRICT OR CLOSE THE RIGHT-OF-WAY CAN ONLY BE OBTAINED THROUGH THE TRAFFIC SERVICES DIVISION, RIGHT- OF- WAY MANAGEMENT (ROWM) SECTION. TRACS PERMITS MUST BE OBTAINED FOR EACH INDIVIDUAL PROJECT THROUGH ROWM. TRACS PERMITS ARE APPROVED BASED ON THE PHASING OF THE PROJECT AND THE SCOPE OF WORK. PERMISSION TO RESTRICT CITY STREETS, SIDEWALKS AND ALLEYS (STREET CLOSURE PERMITS) SHALL BE REQUESTED AS SPECIFIED IN CHAPTER 2 OF THE TRAFFIC BARRICADE MANUAL CURRENT VERSION AND ADDENDUMS THEREOF STREETS DEPARTMENT: RIGHT-OF-WAY MANAGEMENT OFFICE
- 14. ASPHALT RESTORATION IS REQUIRED FOR ANY STREET CUT. REFEI TO STREET PAVEMENT CUT POLICY (TRT 00164 AND ORDINANCE G-6308).
- 15. PAVEMENT REPLACEMENT THICKNESS AND TYPE ARE TO BE PER MAG. SECTION 336 AND CITY DETAIL P1200 -TYPE B. CURB AND GUTTER REPLACEMENT SHALL BE A MINIMUM OF ONE (1) FULL SECTION, PER MAG STANDARD DETAIL 220. SIDEWALK REPLACEMENT SHALL BE A MINIMUM OF ONE (1) FULL PANEL PER C.O.P. DETAIL P1230.
- 16. TREES AND SHRUBBERY IN THE R/W THAT CONFLICT WITH PROPOSED IMPROVEMENTS SHALL NOT BE REMOVED WITHOUT A PPROVAL OF THE CITY LANDSCAPE ARCHITECT OR HIS ASSIGNEES. THE PERMITTEE SHALL BE RESPONSIBLE FOR OBTAINING AUTHORIZATION TO REMOVE AND/OR RELOCATE SAID TREES OR SHRUBBERY BY CALLING THE PARKS AND RECREATION DEPARTMENT AT (602)262-6501 AND TRANSPORTATION DEPARTMENT AT (602)534-9898.
- 17. PER THE STREET PAVEMENT CUT POLICY (TRT 00164) AND CITY ORDINANCE G-6308, ALL STREET PAVEMENT CUTS WILL REQUIRE ASPHALT RESURFACING TREATMENTS BASED ON THE AGE OF TH PAVEMENT. FOR STREETS LESS THAN TWO (2) YEARS OLD, THE PERMITTEE MUST APPLY AN ASPHALT MILL AND OVERLAY PAVEMENT TREATMENT. FOR STREETS GREATER THAN TWO (2) YEARS OLD, THE PERMITTEE MUST APPLY A SLURRY SEAL AND/OR MICROSEAL TREATMENT.
- 18. ALL RAMPS MUST MEET 2010 AMERICANS WITH DISABILITIES ACT (ADA) STANDARDS FOR ACCESSIBLE DESIGN AND CITY OF PHOÉNIX SUPPLEMENT TO MAG UNIFORM STANDARD SPECIFICATIONS AND DETAILS; 2% MAX CROSS SLOPES AND 12:1 MAX LONGITUDINAL SLOPES.

ABBREVIATIONS

PC = PIPE CONNECTION MH = MANHOLE

CB = CATCH BASIN

"PER CITY OF PHOENIX CITY CODE CHAPTER 2,

SECTION 2-28 THESE PLANS ARE FOR OFFICIAL USE ONLY & MAY NOT BE SHARED WITH OTHERS EXCEPT AS REQUIRED TO FULFILL THE OBLIGATIONS OF THE CONTRACTOR'S CONTRACT WITH THE CITY OF PHOENIX."

LEGEND NOTES

CITY OF PHOENIX, ARIZONA STREET TRANSPORTATION DEPARTMENT

SHEA BLVD 24TH ST TO 26TH ST ST83140123

R: LNB DES: CJR CK: TMM ATE: 12/23 DATE: 12/23 DATE: 12/23 DRAWING SERIES NO. SCALE: NONE HORIZONTAL G - 1.01

	AMERICAN RESCUE PLAN ACT LOCAL DRAINAGE MITIGATION PROGRAM PHOENIX STREETS — MARICOPA CO.
NO. DESCRIPTION REV BY CKD BY DATE NO. DESCRIPTION REV BY CKD BY DATE Column	1. ALL WATER VALVE BOXES SHAL SPECIFICATIONS AND DETAILS F 2. ALL CONSTRUCTION IN THE CIT CONFORM TO M.A.G SPECIFICAT M.A.G SPECIFICAT M.A.G SPECIFICAT M.A.G SPECIFICATIONS AND DET 3. ALL DUCTILE IRON PIPE WATER RESTRAINED JOINT REQUIREMEN OF PHOENIX SUPPLEMENT TO RESTRAINTS MUST BE PER M.A ARE NOT ALLOWED TO BE USE WHERE A SPECIFIC CITY OF PHEOR THRUST BLOCKS CAN BE USED WHERE A SPECIFIC CITY OF PHEOR THRUST BLOCKING, SUCH OTHERWISE APPROVED BY THE 4. THE FOLLOWING M.A.G. DETAILS 302-1 JOINT RESTRAIN 321 STANDARD WATER 345-1 3", 4", AND 6" 345-2 4" AND 6" WAT 370 VERTICAL REALIGNING 381 ANCHOR BLOCKS 390 CURB STOP WITH
NO. DESCRIPTION REV BY CKD BY DATE	5. COMPACTION SHALL COMPLY W SUPPLEMENTS. 6. NEW WATER LINES ARE TO BE "STANDARD UTILITY LOCATIONS" 7. THIS SET OF PLANS HAS BEEN IS PART OF THE PROCESS THAT ORDER TO OBTAIN A CONSTRUMOT DICTATE THE CITY OF PHOTHE PLANS, NOR SHALL IT PROMISSIONS, AS FOUND ON PLATE WHERE SUCH ERRORS AND OMINADEQUATE UNDER APPLICABLING REGULATIONS, OR OTHER LAWS KEPT AT THE CONSTRUCTION SET OF THE PLANS WHERE SUCH ERRORS AND OMINADEQUATE UNDER APPLICABLING REGULATIONS, OR OTHER LAWS KEPT AT THE CONSTRUCTION SET OF THE PROPERTY OF THE PRO
DESCRIPTION REV BY CKD BY DATE The state of	BE PROVIDED FOR SEWER MAIN THE MINIMUM HORIZONTAL SEP SEWER SERVICE, WATER MAIN, 12. A ONE (1) FOOT MINIMUM VER CROSSING SHALL BE PROVIDED WATER SERVICES. THE MINIMUM SEWER MAIN. SEWER SERVICE, UNDERGROUND UTILITY. 13. A TWO (2) FOOT MINIMUM VER AND STORM DRAIN CROSSING MEASURED FROM OUTSIDE OF MAIN. SEE M.A.G. STANDARD DEFOR CLEARANCE. 14. EXCEPTIONS OR DEVIATIONS FRAND SHOWN ON THE APPROVED DURING CONSTRUCTION, ALL CAPPROVED PLAN REVISION. 15. ANY AND ALL MORE STRINGENT LOCAL CODES OR ORDINANCES 16. WATER SERVICES SHALL BE INSTRUCTED OF CULT APPROVED ON A CASE BY CASE
ÖZ	17. ALL SERVICES SHALL RUN IN 7 18. NEITHER WATER SERVICE METER
	INSTALLED UNDER AN EXISTING 19. CONCRETE OR ASPHALT DAMAG REMOVED AND REPLACED IN K

WATER NOTES CONT.

. WATER VALVE BOXES SHALL BE PER CITY OF PHOENIX SUPPLEMENT TO MAG. ECIFICATIONS AND DETAILS P1391, TYPE A ONLY.

CONSTRUCTION IN THE CITY OF PHOENIX RIGHT-OF-WAY, OR EASEMENT, IS TO NFORM TO M.A.G SPECIFICATIONS AND DETAILS AND CITY OF PHOENIX SUPPLEMENT TO A.G SPECIFICATIONS AND DETAILS. UNLESS MODIFIED ON THE PLANS.

WATER GENERAL NOTES

- _ DUCTILE IRON PIPE WATER MAIN VALVES, FITTINGS, AND BENDS SHALL BE RESTRAINED. STRAINED JOINT REQUIREMENTS AND APPROVED RESTRAINING SYSTEM ARE SHOWN IN CITY PHOENIX SUPPLEMENT TO M.A.G. SPECIFICATIONS, SECTION 750.3. THE LENGTH OF THE STRAINTS MUST BE PER M.A.G. STANDARD DETAIL 305-1 AND 303-2. THRUST BLOCKS E NOT ALLOWED TO BE USED IN LIEU OF APPROVED RESTRAINED JOINT SYSTEMS. RUST BLOCKS CAN BE USED IN ADDITION TO THE APPROVED RESTRAINED JOINT SYSTEMS HERE A SPECIFIC CITY OF PHOENIX SUPPLEMENT TO M.A.G. STANDARD DETAIL CALLS OUT DR THRUST BLOCKING, SUCH AS CURRENT DETAILS, P1343, P1351, AND P1360 OR WHEN HERWISE APPROVED BY THE WATER SERVICES DEPARTMENT.
- HE FOLLOWING M.A.G. DETAILS ARE SPECIFICALLY NOT APPROVED:

302-1 JOINT RESTRAINT WITH TIE RODS

302-2 JOINT RESTRAINT WITH TIE RODS - ANCHOR BLOCKS

321 STANDARD WATER METER VAULT

345-1 3". 4". AND 6" WATER METER

345-2 4" AND 6" WATER METER WITH ON-SITE FIRE HYDRANTS

370 VERTICAL REALIGNMENT OF WATER MAINS

381 ANCHOR BLOCKS FOR VERTICAL BENDS

390 CURB STOP WITH FLUSHING PIPE

391-1 VALVE BOX INSTALLATION

- MPACTION SHALL COMPLY WITH M.A.G. SECTION 601 AND CITY OF PHOENIX JPPLEMENTS.
- EW WATER LINES ARE TO BE BUILT IN ACCORDANCE WITH THE CITY OF PHOENIX TANDARD UTILITY LOCATIONS".
- IIS SET OF PLANS HAS BEEN INITIALLY REVIEWED BY THE CITY OF PHOENIX. SUCH REVIEW PART OF THE PROCESS THAT DEVELOPER(S)/CONTRACTOR(S)MUST GO THROUGH IN RDER TO OBTAIN A CONSTRUCTION PERMIT. THE RESULTS OF SUCH INITIAL REVIEW SHALL OT DICTATE THE CITY OF PHOENIX'S FINAL DETERMINATION AS TO THE ACCEPTABILITY OF HE PLANS, NOR SHALL IT PREVENT THE CITY OF PHOENIX FROM REQUIRING ERRORS AND /ISSIONS, AS FOUND ON PLANS, BE ADDRESSED BY DEVELOPER(S)/CONTRACTOR(S), HERE SUCH ERRORS AND OMISSIONS CAUSE THE PLANS TO BE IN VIOLATION OF OR ADEQUATE UNDER APPLICABLE FEDERAL/STATE/COUNTY/LOCAL CODES, ORDINANCES, GULATIONS, OR OTHER LAWS. THIS REVIEWED AND STAMPED SET OF PLANS MUST BE PT AT THE CONSTRUCTION SITE AT ALL TIMES.
- PE DEFLECTION SHALL BE PER MANUFACTURERS' RECOMMENDATIONS.
- . WORK MUST COMPLY WITH REQUIREMENTS OF THE CURRENT CITY OF PHOENIX "TRAFFIC RRICADE MANUAL".
- IE CONTRACTOR IS TO NOTIFY THE PUBLIC THAT WILL BE AFFECTED BY ANY SHUTDOWNS MINIMUM OF 48 HOURS IN ADVANCE.
- SIX (6) FOOT MINIMUM HORIZONTAL SEPARATION FROM ANY UNDERGROUND UTILITY SHALL PROVIDED FOR SEWER MAINS, SEWER SERVICES, WATER MAINS, AND WATER SERVICES. E MINIMUM HORIZONTAL SEPARATION IS MEASURED FROM OUTSIDE OF SEWER MAIN, WER SERVICE, WATER MAIN, OR WATER SERVICE TO OUTSIDE OF UNDERGROUND UTILITY.
- ONE (1) FOOT MINIMUM VERTICAL SEPARATION FROM ANY DRY UNDERGROUND UTILITY OSSING SHALL BE PROVIDED FOR SEWER MAINS, SEWER SERVICES, WATER MAINS, AND TER SERVICES. THE MINIMUM VERTICAL SEPARATION IS MEASURED FROM OUTSIDE OF WER MAIN. SEWER SERVICE, WATER MAIN, OR WATER SERVICE TO OUTSIDE OF DRY IDERGROUND UTILITY.
- TWO (2) FOOT MINIMUM VERTICAL SEPARATION SHALL BE PROVIDED BETWEEN ANY SEWER ND STORM DRAIN CROSSING A WATER MAIN, THE MINIMUM VERTICAL SEPARATION IS ASURED FROM OUTSIDE OF WATER MAIN TO OUTSIDE OF SEWER MAIN OR STORM DRAIN IN. SEE M.A.G. STANDARD DETAIL 404 FOR ADDITIONAL INFORMATION AND/OR PROVISIONS R CLEARANCE.
- CEPTIONS OR DEVIATIONS FROM THE ABOVE MINIMUM CLEARANCES MUST BE APPROVED ND SHOWN ON THE APPROVED WATER SEWER PLANS. WHEN UTILITY CONFLICTS ARE FOUND RING CONSTRUCTION, ALL CHANGES AND REVISIONS MUST BE PRECEDED BY AN PROVED PLAN REVISION.
- IY AND ALL MORE STRINGENT REQUIREMENTS REQUIRED BY FEDERAL, STATE, COUNTY OR CAL CODES OR ORDINANCES TAKE PRECEDENCE.
- ATER SERVICES SHALL BE INSTALLED PERPENDICULAR TO THE WATER MAIN. WATER RVICES AT THE END OF CUL-DE-SACS MAY VARY AS NECESSARY, BUT WILL BE PROVED ON A CASE BY CASE BASIS.
- $_{ extsf{L}}$ SERVICES SHALL RUN IN A STRAIGHT LINE FROM THE WATER MAIN TO THE METER BOX.
- ITHER WATER SERVICE METER BOX NOR ANY PORTION OF A WATER SERVICE SHALL BE STALLED UNDER AN EXISTING OR PROPOSED DRIVEWAY OR SIDEWALK RAMP.
- NCRETE OR ASPHALT DAMAGED DURING THE COURSE OF CONSTRUCTION SHALL BE MOVED AND REPLACED IN KIND PRIOR TO FINAL INSPECTION.


- 20. RECORD DRAWING SUBMITTALS MUST COMPLY PER THE WATER SERVICES DEPARTMENT ENGINEERING POLICY P-68 AND P-69. A COPY OF THE POLICY CAN BE OBTAINED IN THE DEPARTMENT'S WEBSITE: HTTP://PHOENIX.GOV/WATERSERVICES/DESIGN/ENGPOLICIES/INDEX.HTML
- 21. IN ACCORDANCE WITH AAC R-18-4-213, ALL MATERIALS ADDED AFTER JANUARY 1, 1993 WHICH MAY COME INTO CONTACT WITH DRINKING WATER SHALL CONFORM TO NATIONAL SANITATION FOUNDATION STANDARDS 60 AND 61.
- 22. PER CITY OF PHOENIX CITY CODE CHAPTER 2. SECTION 2-28. THESE PLANS ARE FOR OFFICIAL USE ONLY AND MAY NOT BE SHARED WITH OTHERS EXCEPT AS REQUIRED TO FULFILL THE OBLIGATIONS OF THE CONTRACTOR'S CONTRACT WITH THE CITY OF PHOENIX.
- 23. A PAVEMENT CUT SURCHARGE SHALL BE ASSESSED ON THIS PROJECT FOR ANY TRENCHING OR POTHOLING IN NEW ASPHALT PAVEMENT THAT IS LESS THAN 30 MONTHS OLD. SURCHARGE FEES ASSESSED ARE IN ADDITION TO THE REGULAR PERMIT FEES AND ARE OVER AND ABOVE ANY SPECIAL BACKFILL, COMPACTION, AND PAVEMENT REPLACEMENT STIPULATIONS THAT MAY BE IMPOSED AS A CONDITION OF PERMITTING. PAVEMENT CUT SURCHARGE FEES ARE ASSESSED IN ACCORDANCE WITH SECTION 31-38 OF THE PHOENIX CITY CODE
- 24. PLAN APPROVAL IS VALID FOR 180 DAYS. PRIOR TO PLAN APPROVAL EXPIRATION, ALL ASSOCIATED PERMITS SHALL BE PURCHASED OR THE PLANS SHALL BE RESUBMITTED FOR EXTENSION OF PLAN APPROVAL. THE EXPIRATION, EXTENSION, AND REINSTATEMENT OF CIVIL ENGINEERING PLANS AND PERMITS SHALL FOLLOW THE SAME GUIDELINES AS THOSE INDICATED IN THE PHOENIX BUILDING CONSTRUCTION CODE ADMINISTRATIVE PROVISIONS SECTION 105.3 FOR BUILDING PERMITS.
- 25. FOR SHUTDOWNS NECESSARY TO ACCOMPLISH APPROVED WORK, THE CONTRACTOR SHALL CONTACT THE PROJECT INSPECTOR EARLY IN THE PROJECT TO COORDINATE A SHUTDOWN WITH THE WATER SERVICES DEPARTMENT, FIELD DISTRIBUTION & COLLECTIONS STAFF. THE CONTRACTOR SHALL HAVE ALL MATERIALS AND EQUIPMENT ON THE PROJECT SITE TO COMPLETE THE CONNECTION(S) PRIOR TO THE SHUTDOWN.

ONCE THE EXISTING WATER PIPE IS CUT, IT SHALL BE THE CONTRACTOR'S RESPONSIBILITY TO KEEP THE PIPE CLEAN AND FREE OF DIRT AND DEBRIS BY CAPPING THE ENDS UNTIL THE FINAL CONNECTIONS CAN BE COMPLETED, PRIOR TO THE FINAL CONNECTIONS, THE EXISTING PIPE SHALL BE SWABBED WITH A MINIMUM 50 PPM CHLORINE SOLUTION FOR A DISTANCE OF 10 FEET FROM THE OPENING.

THE CONTRACTOR SHALL BE RESPONSIBLE FOR MAINTAINING ACCESSIBILITY TO THE VALVE OPERATING NUT FOR ALL VALVES, WITHIN THE PROJECT BOUNDARIES. FAILURE TO MAINTAIN ACCESSIBILITY TO VALVES SHALL BE CAUSE FOR CANCELING THE SHUTDOWN AND THE CONTRACTOR MUST PROPERLY REQUEST A SCHEDULE REVISION.

THE WATER SERVICES DEPARTMENT IS INDEMNIFIED FOR ANY AND ALL RESULTANT COSTS INCURRED BY THE CONTRACTOR SUCH AS, BUT NOT LIMITED TO TRAFFIC CONTROL, DELAYS, LOSS OF INCENTIVES, STANDBY AND PENALTIES IF THE CONTRACTOR DID NOT PROPERLY REQUEST A SHUTDOWN; OR FAILED TO MAINTAIN ACCESSIBILITY TO VALVES; OR ON THE SCHEDULED DATE WORK HAD NOT PROGRESSED TO THE POINT AT WHICH THE SHUTDOWN WAS NEEDED.

- 26. VALVE BOX REMOVAL AFTER ACCEPTANCE OF THE NEW WATERLINES, FIRE HYDRANTS AND SERVICE CONNECTIONS THE CONTRACTOR SHALL SHUT THE VALVE, REMOVE THE BOX AND COVER, BACKFILL AND COMPACT THE VOID WITH ABC AS APPLICABLE, COVER WITH 2-INCH AC (C) PAVEMENT, OR AS REQUIRED TO MATCH EXISTING GROUND.
- 27. CUT AND PLUG —THE CONTRACTOR SHALL CUT AND PLUG EXISTING WATERLINES AS NOTED ON THE APPROVED PLANS AFTER ALL EXISTING WATER SERVICES HAVE BEEN TIED OVER TO THE NEW WATERLINE.
- 28. SWING CONNECTIONS AFTER THE NEW WATERLINE IS ACCEPTED FOR SERVICE, THE CONTRACTOR SHALL MAKE "SWING CONNECTIONS" TO EXISTING WATERLINES AS INDICATED ON THE APPROVED PLANS. "SWING CONNECTIONS" SHALL INCLUDE ALL PIPING AND APPURTENANCES (OFFSETS, BENDS, ETC.) REQUIRED TO AFFECT A CONNECTION.
- 29. WATER SERVICES THE CONTRACTOR SHALL REPLACE EXISTING WATER SERVICES AS INDICATED ON THE APPROVED PLANS WITH NEW SERVICE PIPE AND CURB STOP FOR THE RELOCATED EXISTING WATER METERS. (ALL SERVICE CONNECTIONS MUST BE AT MINIMUM 1-INCH. FOR 3/4-INCH METERS, A 3/4-INCH REDUCER MUST BE INSTALLED TO ACCOMMODATE THE METER).
- 30. METER AND BOX THE CONTRACTOR SHALL RELOCATE THE EXISTING METERS AND METER BOXES, AND CONNECT THEM AS INDICATED ON THE APPROVED PLANS AFTER THE NEW WATERLINE HAS BEEN ACCEPTED FOR SERVICE.
- 31. NEW WATER METERS AND SERVICES WILL BE INSTALLED AFTER THE CONTRACTOR MAKES PROPER APPLICATION AND PAYS THE PREVAILING FEES. APPLICATION AND PAYMENT OF FEES CAN BE MADE AT THE FOLLOWING ADDRESS: CITY OF PHOENIX, WATER SERVICES DEPARTMENT, INFRASTRUCTURE RECORD SERVICES DIVISION, 200 WEST WASHINGTON STREET, 8TH FLOOR, PHOENIX, A2 85003.
- 32. SURPLUS ABANDONED FIRE HYDRANTS (BARREL PORTION ONLY) TO THE CITY OF PHOENIX WATER DEPARTMENT - SUPPORT SERVICES, 4436 N. 35TH AVENUE, PHOENIX. CONTACT THE WATER DEPARTMENT - SUPPORT SERVICES BY CALLING 602-262-5077 FOR ANY ADDITIONAL INFORMATION.
- 33. CITY OF PHOENIX WATER DEPARTMENT PERSONNEL SHALL REMOVE ALL PROPOSED EXISTING WATER METERS THAT ARE TO BE ABANDONED ONCE ALL REQUIRED FEES HAVE BEEN PAIN BY THE APPLICANT AT COUNTER 8 - CIVIL PERMITS, ON THE SECOND FLOOR OF CITY OF PHOENIX CITY HALL, LOCATED AT 200 W. WASHINGTON STREET.
- 34. ALL CONSTRUCTION ACTIVITIES SHALL BE CONTAINED WITHIN THE PUBLIC RIGHT OF WAY OR IN EASEMENTS GRANTED FOR THE WATER AND/OR SEWER MAIN INSTALLATION.
- 35. TRAFFIC CONTROL SHALL CONFORM TO THE RIGHT-OF-WAY MANAGEMENT PROGRAM (RMP), ADOPTED BY THE CITY OF PHOENIX AND SHALL ALSO BE SUBJECT TO CITY REVIEW AND APPROVAL.
- 36. ALL DIMENSIONS SHOWN ARE TO THE MONUMENT LINE OTHERWISE. IN RIGHT OF WAY, UNLESS NOTED

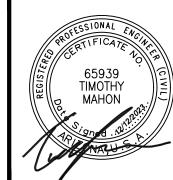

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WATER NOTES CONT.

- 37. BIDDERS ARE ADVISED THAT THE LOCATION, NUMBER, AND TYPE OF UTILITIES SHOWN ON THESE PLANS AND SPECIFICATIONS ARE ONLY AS ACCURATE AS THE BEST INFORMATION AVAILABLE FROM PUBLIC UTILITIES, OWNERS, AND USERS AT THE TIME THESE PLANS AND SPECIFICATIONS WERE PREPARED. UNDERGROUND UTILITIES MAY BE PRESENT ON THIS PROJECT WHICH WERE NOT DISCLOSED TO THE ENGINEER. NO REPRESENTATION IS MADE THAT THE UTILITIES LOCATIONS INDICATED ON THESE PLANS ARE ACCURATE, COMPLETE, OR EXCLUSIVE. BIDDERS ARE ADVISED TO UNDERTAKE THEIR OWN INVESTIGATIONS OF EXISTING CONDITIONS BEFORE SUBMITTING A PROPOSAL ON THIS PROJECT. THE CONTRACTOR IS RESPONSIBLE FOR THE COST OF ALL TEST PITS OR THE PRE-CONSTRUCTION INVESTIGATION OF UNDERGROUND UTILITIES OR STRUCTURE. PURSUANT TO ARIZONA REVISED STATUTE 40-360.21, THE CONTRACTOR MUST CONTACT "BLUE STAKE" AT (602)261-1100 OR THE APPROPRIATE PUBLIC UTILITY FOR ASSISTANCE IN LOCATING UNDERGROUND FACILITIES, LINES, AND APPURTENANCES PRIOR TO CONSTRUCTION.
- 38. BY SUBMITTING A PROPOSAL ON THIS PROJECT, BIDDERS ARE REPRESENTING THAT THEY HAVE CONSIDERED THE POTENTIAL IMPACT OF TEMPORARY OR PERMANENT RELOCATION OF EXISTING UNDERGROUND UTILITIES LOCATED WITHIN THE PROJECT ON THEIR COSTS, AND THAT THEY HAVE INCLUDED IN THEIR PROPOSALS THE COST OF FINDING, PROTECTING, AND RELOCATING ALL EXISTING UTILITIES WITHIN THE PROJECT. NO ADDITIONAL COMPENSATION FOR DAMAGES WILL BE PAID FOR ANY COST, LOSS, DAMAGE, HINDRANCE, OR DELAY INCURRED BY A CONTRACTOR OR SUBCONTRACTOR DUE TO CONFLICTS WITH EXISTING UTILITIES; REGARDLESS OF WHETHER OR NOT THOSE UTILITIES ARE INDICATED ON THE PLANS OR SPECIFICATIONS FOR THIS PROJECT.
- 39. THE SOLE AND EXCLUSIVE REMEDY FOR ANY COST, HINDRANCE, OR DELAY CAUSED BY ANY UTILITIES LOCATED WITHIN THE PROJECT (WHETHER OR NOT INDICATED ON THE PLANS OR SPECIFICATIONS) SHALL BE AN EXTENSION OF THE CONTRACT TIME; THE NEED FOR OR DURATION OF WHICH SHALL BE DETERMINED BY THE ENGINEER IN ITS SOLE DISCRETION.
- 40. PER MAG SECTION 630, THE CONTRACTOR SHALL FURNISH SHOP DRAWINGS AND TECHNICAL DATA REQUIRED FOR EVALUATING AND APPROVAL OF EACH TYPE OF VALVE. TAPPING SLEEVE AND VALVE AND BUTTERFLY VALVE. SHOP DRAWINGS MUST BE SUBMITTED TO WATER SERVICES AFTER THE ENGINEER OF RECORD HAS PROVIDED THEIR RECOMMENDATION OR APPROVAL
- 41. THE CONTRACTOR SHALL USE EXTREME CAUTION WHILE WORKING IN THE VICINITY OF ALL GAS AND POWER LINES. THE CONTRACTOR SHALL MAINTAIN THE INTEGRITY OF THE GAS AND POWER TRENCHES AND PIPELINES AT ALL TIMES. SPECIAL ATTENTION SHALL BE GIVEN TO BRACING AND SUPPORT FOR UNDERGROUND POWER CROSSINGS. TRENCHING WITHIN A TWO FOOT VICINITY OF GAS LINES SHALL BE BY HAND. ALL POWER LINE CROSSINGS SHALL BE BRACED DURING CONSTRUCTION. BRACING SHALL BE A NON PAY ITEM UNLESS NOTED OTHERWISE. POLE BRACING MAY BE REQUIRED WHEN EXCAVATING NEAR POWER POLES.
- 42. THE CONTRACTOR SHALL SUPPORT AND PROTECT IN PLACE ALL EXISTING UTILITIES WITHIN THE EXCAVATION AS REQUIRED BY THE MAG SPECIFICATIONS.
- 43. THE CONTRACTOR SHALL CONSTRUCT PERMANENT OR TEMPORARY PIPE SUPPORTS AS SHOWN ON MAG STANDARD DETAILS 403-1, 403-2 AND 403-3 FOR ALL UTILITY CROSSINGS ON THIS PROJECT. PIPE SUPPORTS SHALL BE A NON PAY ITEM.
- 44. THE CONTRACTOR MUST PROTECT THE ADJACENT PROPERTY AND IMPROVEMENTS THERETO FROM ANY DAMAGE DURING CONSTRUCTION. ANY DAMAGE TO ADJACENT PROPERTY OR IMPROVEMENTS MUST BE REPAIRED OR REPLACED, TO THE PROPERTY OWNER'S SATISFACTION, AT THE CONTRACTOR'S EXPENSE.
- 45. OPEN CUT SLOPES AND SHORING FOR TRENCH EXCAVATIONS SHALL AS A MINIMUM COMPLY WITH OSHA REQUIREMENTS, WHERE EXCAVATIONS ARE DEEPER THAN 20 FEET. THE CONTRACTOR SHALL HAVE A PROFESSIONAL CIVIL ENGINEER, REGISTERED IN THE STATE OF ARIZONA, DESIGN OPEN CUT SLOPES AND SHORING. THE CONTRACTOR SHALL SUBMIT THE DESIGN TO THE ENGINEER FOR APPROVAL PRIOR TO CONSTRUCTION.

"PER CITY OF PHOENIX CITY CODE CHAPTER 2, SECTION 2-28 THESE PLANS ARE FOR OFFICIAL USE ONLY & MAY NOT BE SHARED WITH OTHERS EXCEPT AS REQUIRED TO FULFILL THE OBLIGATIONS OF THE CONTRACTOR'S CONTRACT WITH THE CITY OF PHOENIX."

LEGEND NOTES

CITY OF PHOENIX, ARIZONA STREET TRANSPORTATION DEPARTMENT

> SHEA BLVD 24TH ST TO 26TH ST ST83140123

R: LNB DES: CJR CK: TMM DRAWING SERIES NO. ATE: 12/23 DATE: 12/23 DATE: 12/23 SCALE: NONE HORIZONTAL G-1.02

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THE HORIZONTAL DATUM IS NAD83(HARN) STATE PLANE, ARIZONA CENTRAL ZONE, ADJUSTED FROM GRID TO GROUND USING A COMBINED SCALE FACTOR OF 1.00016 WITH A SCALE POINT OF X=0.00, Y=0.00.

THE BASIS OF BEARING IS GRID NORTH NAD 83 STATE PLANE, ARIZONA CENTRAL ZONE ELEVATIONS ARE ON THE NGVD27 VERTICAL DATUM

	1			
POINT	STATION	NORTHING	EASTING	DESCRIPTION
1001	12+34.69	939,545.38	665,994.06	CITY OF PHOENIX BRASS CAP
107	20+00.00	939,558.91	666,759.24	INTERSECTION OF 26TH ST AND SHEA BLVD
1002	22+42.43	939,562.97	667,001.64	CITY OF PHOENIX BRASS CAP
108	16+74.99	939,553.17	666,434.29	INTERSECTION OF 25TH PL AND SHEA BLVD



"PER CITY OF PHOENIX CITY CODE CHAPTER 2, SECTION 2-28 THESE PLANS ARE FOR OFFICIAL USE ONLY & MAY NOT BE SHARED WITH OTHERS EXCEPT AS REQUIRED TO FULFILL THE OBLIGATIONS OF THE CONTRACTOR'S CONTRACT WITH THE CITY OF PHOENIX."

GEOMETRIC CONTROL

CITY OF PHOENIX, ARIZONA STREET TRANSPORTATION DEPARTMENT

SHEA BLVD 24TH ST TO 26TH ST ST83140123

DR: LNB | DES: CJR | CK: TMM | DRAWING SERIES NO. DATE: 12/23 | DATE: 12/23 | DATE: 12/23 | DRAWING SERIES NO. SCALE: 1"=100" | HORIZONTAL | G-2.01

NO. DESCRIPTION REV BY CHOENI	City of Phoenix N	5+00 N 25TH PL OATH SHEA BLAD	V + 0 C C C C C C C C C C C C C C C C C C	77-42
NO. DESCRIPTION REV BY CKD BY DATE	BP: 12+34.69 12 N 25TH ST	N1.06,30, M 120.82, 108	N89'02'2 EP: 20+00.00 242.43	3"E 1002
NO. DESCRIPTION REV BY CKD BY DATE				

LOCAL DRAINAGE MITIGATION PROGRAM PHOENIX STREETS — MARICOPA CO.

cragan

PROJ. NO. NO. TOTAL REGION AMERICAN RESCUE PLAN ACT LOCAL DRAINAGE MITIGATION PROGRAM ST83140123 | 47 | ARIZ PHOENIX STREETS - MARICOPA CO. DRAWN: LNB DESIGN: CJR CHECKED: TMM ANTITY S MMARY ITEM No. DESCRIPTION SHEET N MBERS TOTAL TY M###### (DESCRIPTION) NIT SD 4.01 TOTAL TY M3001002 | SAWCUT & REMOVE PORTLAND CEMENT CONCRETE CURB AND GUTTER 248 248 SF M3001003 | SAWCUT & REMOVE CONCRETE SIDEWALK & RAMP 11 4 11 4 SY M3010001 S BGRADE PREPARATION 14 14 M3360224 SAWCUT, REMOVE, AND REPLACE A.C. PAVEMENT, COP STD DET P-1200 MAG SPEC 336 SY 482 482 SY M3362002 | SLURRY SEAL COAT 608 608 M3400240 | CONCRETE VALLEY GUTTER & APRON, MAG STD DTL 240 SF 118 118 M3400400 | CONCRETE SIDEWALK, COP STD DTL P1230 SF 11 4 11 4 M3402201 | CONCRETE CURB AND GUTTER, MAG STD DTL 220, TYPE A H=6" 83 83 M3402222 CONCRETE SINGLE CURB, MAG STD DTL 222, TYPE "B" 143 143 M3402243 CONCRETE CURB TRANSITION PER MAG STD DET 221 20 20 M3 00020 | REMOVE PORTLAND CEMENT VALLEY GUTTER SF 118 118 M3 00041 REMOVE EXISTING 30" ST B PIPE LF M 0 1 24 | CONCRETE CATCH BASIN, TYPE M, COP STD DTL P1569-1 EΑ M6014030 WATERLINE REPLACEMENT 6" & 12" EΑ 4 PERMANENT PIPE SUPPORT, MAG STANDARD DETAILS 403-1, 403-2, OR 403-3 EΑ M6012100 2 SANITARY SEWER ENCASEMENT, MAG STD DTL 404 3 LF 12 12 LF 15" STORM DRAIN PIPE M618001 M6180018 | 18" STORM DRAIN PIPE LF 66 66 M6180024 24" STORM DRAIN PIPE LF 233 233 M6180036 36" STORM DRAIN PIPE 1 2 1 2 M618042 PIPE PLUG, MAG STD DETAIL 427 EΑ M6180 06 | CONCRETE PIPE COLLAR FOR 24" PIPE COP STANDARD DETAIL P 1 0 EΑ EΑ M6186004 | 18" X 18" X 15" PREFABRICATED TEE EΑ M6186032 36" X 36" X 18" PREFABRICATED TEE STORM SEWER MANHOLE, MAG STD DETAIL 22, COP DTL P1 20 EΑ M62 000 CONNECT NEW PIPE TO EXISTING MANHOLE EΑ 1 WATER SERVICE CONNECTION (MAIN TO METER) EΑ **KEY MAP** City of Phoenix SD 1.01 SHEA BO LEVARD 22+42 15+00 "PER CITY OF PHOENIX CITY CODE CHAPTER 2, SECTION 2-28 THESE PLANS ARE FOR OFFICIAL USE ONLY & MAY NOT BE SHARED WITH OTHERS EXCEPT AS REQUIRED TO FULFILL THE OBLIGATIONS OF THE CONTRACTOR'S CONTRACT WITH THE CITY OF PHOENIX." ANTITY S MMARY CITY OF PHOENIX, ARIZONA STREET TRANSPORTATION DEPARTMENT SHEA BO LEVARD 26TH ST AND SHEA BLVD ST83140123 DR: LNB DES: CJR CK: TMM DRAWING SERIES NO. HORIZONTAL SCALE: NONE G - 3.01

