

**MAYOR**  
**Kate Gallego**  
**CITY COUNCIL**

- DISTRICT 1 **Ann O'Brien**
- DISTRICT 2 **Jim Waring**
- DISTRICT 3 **Debra Stark**
- DISTRICT 4 **Laura Pastor**
- DISTRICT 5 **Betty Guardado**
- DISTRICT 6 **Kevin Robinson**
- DISTRICT 7 **Carlos Galindo-Elvira**
- DISTRICT 8 **Kesha Hodge Washington**



# City of Phoenix

## WATER SERVICES DEPARTMENT

### LIFT STATION 40 REFURBISHMENT

#### INDEX NO. WS90400085

#### RAY ROAD & I-10

#### AUGUST 2024

### ISSUED FOR CONSTRUCTION

**CITY MANAGER**  
**Jeffrey Barton**

**CITY ENGINEER**  
**Eric Froberg, PE**

**WATER SERVICES DIRECTOR**  
**Troy Hayes, PE**

**APPROVALS**

	09/24/2024
WATER SERVICES DEPARTMENT	<b>DATE</b>
	7/18/2024
MARICOPA COUNTY ENVIRONMENTAL SERVICES DEPT.	<b>DATE</b>
WWR-24-00230	


**DEFERRED SUBMITTALS FOR REVIEW WITH THE CITY OF PHOENIX FIRE DEPT.:**

1. ABOVE GROUND TANK FOR THE GENERATOR.
2. FIRE DEPARTMENT ACCESS GATES AND ACCESS ROADS DETAILS SIGNS/MARKINGS.
3. ABOVE GROUND TANKS FOR THE HAZARDOUS CHEMICALS.
4. DEMO OF EXISTING CHEMICAL TANKS AND PROCESS PIPING
5. CONTRACTOR TO INSTALL A NEW FIRE HYDRANT PER PCF 507.5.1 AS APPROVED UNDER THE OWNER'S ALLOWANCE.

  
Eric Froberg, P.E., City Engineer 11/7/2024  
11/7/2024

**UTILITY NO CONFLICT DESIGN CONTACTS:**

UTILITY COMPANY / CITY	PLANS SUBMITTED TO	DATE SENT	PLANS REVIEWED BY	NO CONFLICT RESPONSE RECEIVED	PHONE NUMBER
SRP	SRP	11/28/2023	HENERY SOLZ	12/22/2023	(602) 236-0890
SW GAS	SOUTHWEST GAS	02/09/2024	ZACH STEVENSON	02/27/2024	(480) 730-3555
LUMEN	TERRA TECHNOLOGIES	02/09/2024	KEVIN WAGNER	02/27/2024	(815) 245-9640
COX COMMUNICATIONS	COX COMMUNICATION	02/09/2024	JACOB HORSMAN	02/27/2024	(623) 238-2202
WATER - CITY OF PHOENIX	CITY OF PHOENIX	--	--	01/15/2024	(XXX) XXX-XXXX
SEWER - CITY OF PHOENIX	CITY OF PHOENIX	--	--	01/15/2024	(XXX) XXX-XXXX

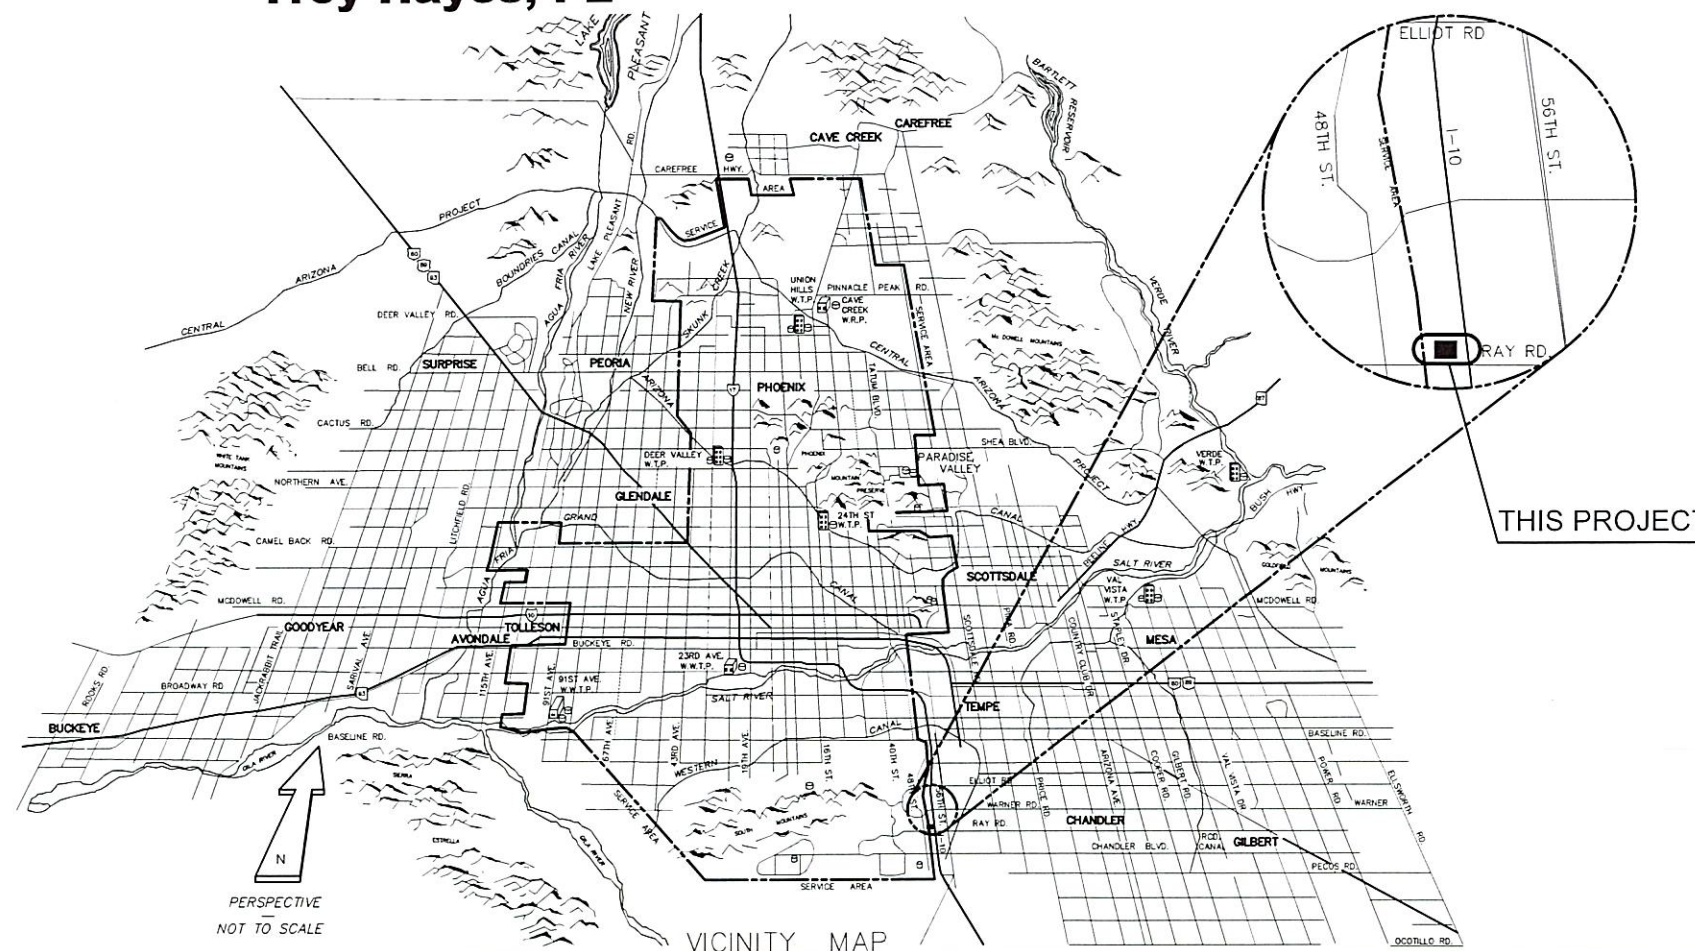

"PER CITY OF PHOENIX CODE CHAPTER 2, SECTION 2-28, THESE PLANS ARE FOR OFFICIAL USE ONLY AND MAY NOT BE SHARED WITH OTHERS EXCEPT AS REQUIRED TO FULFILL THE OBLIGATIONS OF THE CONTRACTOR'S CONTRACT WITH THE CITY OF PHOENIX." THIS DOCUMENT MUST BE KEPT SECURE AT ALL TIMES.



THIS DRAWING MUST BE FIELD VERIFIED BEFORE USE  
DRAWING NOT TO SCALE UNLESS SCALE BAR IS PRESENT

FOR CONSTRUCTION

"PER CITY OF PHOENIX CODE CHAPTER 2, SECTION 2-28, THESE PLANS ARE  
FOR OFFICIAL USE ONLY AND MAY NOT BE SHARED WITH OTHERS EXCEPT AS  
REQUIRED TO FULFILL THE OBLIGATIONS OF THE CONTRACTOR'S CONTRACT  
WITH THE CITY OF PHOENIX."  
THIS DOCUMENT MUST BE KEPT SECURE AT ALL TIMES.

SHEET INDEX

SHEET INDEX


SHEET INDEX

SHEET NO.	INDEX NO.	TITLE
<b>GENERAL</b>		
01	G-01	COVER SHEET AND VICINITY MAP
02	G-02	INDEX OF SHEETS
03	G-03	LEGEND & SYMBOLS
04	G-04	GENERAL NOTES
05	G-05	GENERAL ABBREVIATIONS
<b>CIVIL</b>		
06	C-01	SURVEY CONTROL
07	C-02	GENERAL DETAILS 1
08	C-03	GENERAL DETAILS 2
09	C-04	GENERAL DETAILS 3
10	C-05	GENERAL DETAILS 4
11	C-06	GENERAL DETAILS 5
12	C-07	GENERAL DETAILS 6
13	C-08	DEMOLITION PLAN 01
14	C-09	DEMOLITION PLAN 02
15	C-10	DEMOLITION PLAN 03
16	C-11	DEMOLITION PLAN 04
17	C-12	DEMOLITION PLAN 05
18	C-13	DEMOLITION PLAN 06
19	C-14	DEMOLITION PLAN 07
20	C-15	DEMOLITION PLAN 08
21	C-16	DEMOLITION PLAN 09
22	C-17	BYPASS PLAN 01
23	C-18	BYPASS PLAN 02
24	C-19	BYPASS PLAN 03
25	C-20	SITE LAYOUT - CONTROL PLAN
26	C-21	OVERALL CIVIL SITE PLAN SHEET 1 OF 2
27	C-22	OVERALL CIVIL SITE PLAN SHEET 2 OF 2
28	C-23	OVERALL UTILITY PLAN SHEET 1 OF 2
29	C-24	OVERALL UTILITY PLAN SHEET 2 OF 2
30	C-25	GRADING AND DRAINAGE PLAN 01
31	C-26	GRADING AND DRAINAGE PLAN 02
32	C-27	FERROUS CHLORIDE SYSTEM SITE PLAN
33	C-28	BIOFILTER SCHEMATIC
34	C-29	BIOFILTER ENLARGED SITE PLAN
35	C-30	BIOFILTER SECTIONS AND DETAILS
36	C-31	BIOFILTER DETAILS
<b>MECHANICAL PROCESS</b>		
37	M-01	MECHANICAL LEGENDS AND SYMBOLS
38	M-02	GENERAL DETAILS 1
39	M-03	GENERAL DETAILS 2
40	M-04	GENERAL DETAILS 3
41	M-05	GENERAL DETAILS 4
42	M-06	GENERAL DETAILS 6 NEW LAUNCHING STRUCTURE
43	M-07	LS YARD PIPING PLAN SHEET 1 OF 3
44	M-08	LS YARD PIPING PLAN SHEET 2 OF 3
45	M-09	LS YARD PIPING PLAN SHEET 3 OF 3
46	M-10	LS 42" SW LINE PLAN AND PROFILE STA 5+00.00 TO 7+50.00 SHEET 1 OF 2
47	M-11	LS 42" SW LINE PLAN AND PROFILE STA 7+50.00 TO 9+49.41 SHEET 2 OF 2
48	M-12	LS YARD WET WELL SECTIONS 1 & 2
49	M-13	LS YARD PIPING SECTIONS 3 & 4
50	M-14	LS YARD PIPING SECTIONS 5, & 6
51	M-15	LS YARD PIPING SECTIONS 7, 8, 9, & 10
52	M-16	24" FORCE MAIN BARREL 1 DI PIPE PLAN AND PROFILE STA 5+00.00 TO 6+71.37
53	M-17	24" FORCE MAIN BARREL 2 DI PIPE PLAN AND PROFILE STA 10+00.00 TO 11+63.21
54	M-18	24" FORCE MAIN BARREL 3 DI PIPE PLAN AND PROFILE STA 15+00.00 TO 16+63.21
55	M-19	FERROUS CHLORIDE SYSTEM SECTION
56	M-20	EQUIPMENT SCHEDULE

SHEET NO.	INDEX NO.	TITLE
<b>STRUCTURAL</b>		
57	S-01	GENERAL STRUCTURAL NOTES
58	S-02	SPECIAL INSPECTION SCHEDULE
59	S-03	STANDARD STRUCTURAL DETAILS 1
60	S-04	STANDARD STRUCTURAL DETAILS 2
61	S-05	STANDARD STRUCTURAL DETAILS 3
62	S-06	ELECTRICAL AND CONTROL BUILDING FOUNDATION PLAN
63	S-07	ELECTRICAL AND CONTROL BUILDING ROOF FRAMING PLAN
64	S-08	ELECTRICAL AND CONTROL BUILDING SECTIONS AND DETAILS
65	S-09	WET WELL FOUNDATION PLAN AND CHANNEL PARTIAL PLAN
66	S-10	WET WELL ROOF PLAN AND PIPING SUPPORT PAD
67	S-11	WET WELL SECTIONS AND DETAILS
68	S-12	CHEMICAL CONTAINMENT AREA FOUNDATION PLAN
69	S-13	CHEMICAL CONTAINMENT AREA ROOF FRAMING PLAN
70	S-14	CHEMICAL CONTAINMENT AREA SECTIONS AND DETAILS
71	S-15	GENERATOR & PIG LAUNCHING PAD FOUNDATION PLANS AND SECTION
72	S-16	BIOFILTER FOUNDATION PLAN, SECTIONS AND DETAILS
73	S-17	STRUCTURAL SECTIONS AND DETAILS 1
74	S-18	STRUCTURAL SECTIONS AND DETAILS 2
75	S-19	STRUCTURAL SECTIONS AND DETAILS 3
<b>ARCHITECTURAL</b>		
76	A-01	ELECTRICAL BUILDING LIFE SAFETY AND CODES
77	A-02	ELECTRICAL BUILDING FLOOR PLAN
78	A-03	ELECTRICAL BUILDING ROOF PLAN
79	A-04	ELECTRICAL BUILDING EXTERIOR ELEVATIONS
80	A-05	ELECTRICAL BUILDING EXTERIOR ELEVATIONS
81	A-06	ELECTRICAL BUILDING AND EXTERIOR ELEVATIONS AND BUILDING SECTION
82	A-07	ELECTRICAL BUILDING WALL SECTIONS AND DETAILS
83	A-08	ELECTRICAL BUILDING DETAILS
84	A-09	ELECTRICAL BUILDING SCHEDULES AND DETAILS
<b>HVAC</b>		
85	H-01	LEGEND AND SYMBOLS
86	H-02	HVAC/PLUMBING DETAILS
87	H-03	ELECTRICAL BUILDING HVAC PLAN
88	H-04	ELECTRICAL BUILDING HVAC ROOF PLAN
89	H-05	HVAC SECTIONS
90	H-06	HVAC/PLUMBING SCHEDULES
<b>PLUMBING</b>		
91	P-01	ELECTRICAL BUILDING PLUMBING PLAN


SHEET NO.	INDEX NO.	TITLE
<b>ELECTRICAL</b>		
92	E-01	ABBREVIATIONS - 1
93	E-02	ABBREVIATIONS - 2
94	E-03	SYMBOLS AND LEGEND - 1
95	E-04	SYMBOLS AND LEGEND - 2
96	E-05	OVERALL SITE PLAN
97	E-06	DEMO SITE PLAN
98	E-07	DEMO SITE PLAN DETAILS 1
99	E-08	DEMO SITE PLAN DETAILS 2
100	E-09	DEMO SITE PLAN DETAILS 3
101	E-10	DEMO SITE PLAN DETAILS 4
102	E-11	SITE PLAN POWER AND CONTROL
103	E-12	SITE PLAN LIGHTING AND GROUNDING
104	E-13	ELECTRICAL BUILDING POWER AND CONTROL
105	E-14	ELECTRICAL BUILDING LIGHTING AND GROUNDING
106	E-15	WET WELL PLAN
107	E-16	SINGLE LINE DIAGRAM
108	E-17	LOAD SUMMARY
109	E-18	POWER PANEL SCHEDULES
110	E-19	CONTROL SCHEMATIC - 1
111	E-20	CONTROL SCHEMATIC - 2
112	E-21	CONTROL SCHEMATIC - 3
113	E-22	CONTROL SCHEMATIC - 4
114	E-23	CONTROL SCHEMATIC - 5
115	E-24	CONTROL SCHEMATIC - 6
116	E-25	CONTROL SCHEMATIC - 7
117	E-26	CONDUIT BLOCK DIAGRAMS
118	E-27	CONDUIT BLOCK DIAGRAMS
119	E-28	ELECTRICAL DETAILS 1
120	E-29	ELECTRICAL DETAILS 2
121	E-30	ELECTRICAL DETAILS 3
122	E-31	ELECTRICAL DETAILS 4
123	E-32	ELECTRICAL DETAILS 5
124	E-33	ELECTRICAL DETAILS 6
<b>INSTRUMENTATION</b>		
125	I-01	SYMBOLS AND LEGENDS 1
126	I-02	SYMBOLS AND LEGENDS 2
127	I-03	ABBREVIATIONS
128	I-04	P&ID SHEET 1
129	I-05	P&ID SHEET 2
130	I-06	P&ID SHEET 3
131	I-07	P&ID SHEET 4
132	I-08	P&ID SHEET 5
133	I-09	P&ID SHEET 6
134	I-10	P&ID SHEET 7

FOR CITY OF PHOENIX USE ONLY - REFERENCE CID NUMBER: #	PROJECT NO.	PROJECT NAME	DATE	DWG NUMBER	REMARKS

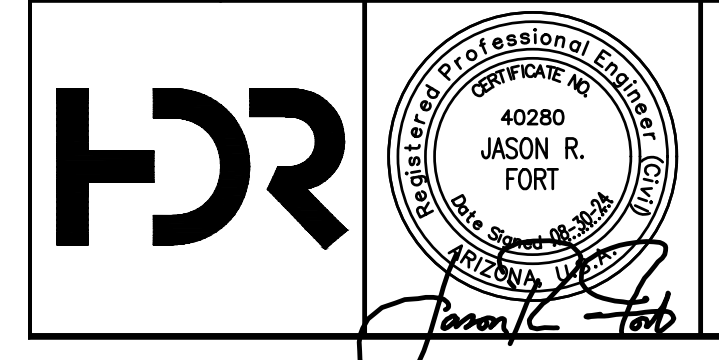

NO.	BY	DATE	CKD	REVISIONS	REMARKS
A	RS	10/2023	JF	30% SUBMITTAL	
B	RS	01/2024	JF	90% SUBMITTAL	
C	RS	04/2024	JF	AGENCY REVIEW	
D	DFD	08/2024	JF	ISSUED FOR CONSTRUCTION	
*					
*					
*					

DES	FS
DWN	RS
CKD	JF

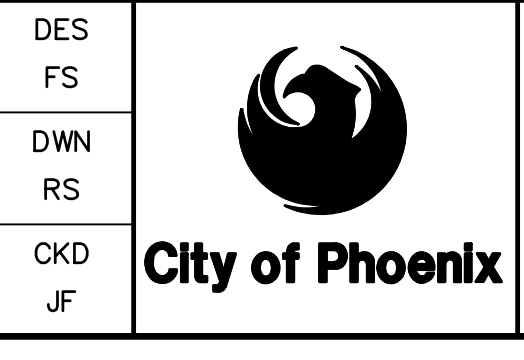

CITY OF PHOENIX  
WATER SERVICES DEPARTMENT  
  
LIFT STATION 40  
REFURBISHMENT

GENERAL  
  
**INDEX OF SHEETS**

COPYRIGHT © 2007-JANUARY  
CITY PROJECT NO. WS90400085  
DATE: 08/2024  
**G-02** SHEET 2 OF 134  
CAD FILE: CSCLS40A02.dwg

THIS DRAWING MUST BE FIELD VERIFIED BEFORE USE  
DRAWING NOT TO SCALE UNLESS SCALE BAR IS PRESENT

FOR CONSTRUCTION

"PER CITY OF PHOENIX CODE CHAPTER 2, SECTION 2-28, THESE PLANS ARE FOR OFFICIAL USE ONLY AND MAY NOT BE SHARED WITH OTHERS EXCEPT AS REQUIRED TO FULFILL THE OBLIGATIONS OF THE CONTRACTOR'S CONTRACT WITH THE CITY OF PHOENIX."  
THIS DOCUMENT MUST BE KEPT SECURE AT ALL TIMES.


**GENERAL SYMBOLS**

**PIPE TAG**

DESIGN      EXISTING      FUTURE  
 12" RW      P 1001      P 1001

\* PIPING SYSTEM DESIGNATIONS FOR EXISTING PIPE INDICATE TYPE OF SERVICE ONLY AND DO NOT IMPLY PIPE MATERIALS USED.

PIPING IS CALLED OUT BY SIZE FOLLOWED BY PIPING SYSTEM, ENCLOSED AS SHOWN:

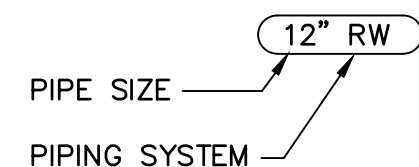


**EQUIPMENT TAG**

X X X X X X X X

7-DIGIT SERIALIZED KEY

ASSIGNED TO PROJECT BY CITY'S PROJECT MANAGER



**APPEARANCE**

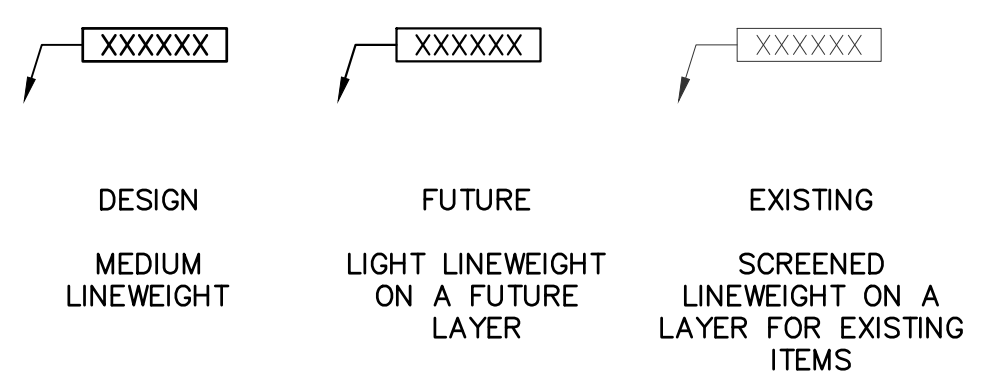

ITEMS TO HAVE EQUIPMENT TAGS:  
 ALL MANUAL VALVES FOUR (4) INCHES AND LARGER, ALL VALVES ELECTRICAL OPERATED.  
 ALL INSTRUMENTS, MOTORS, AND EQUIPMENT


WHERE THE SAME ITEM IS SHOWN IN SEVERAL DISCIPLINES, THEY SHALL REPEAT IN APPEARANCE IN ALL ELECTRICAL, INSTRUMENTATION, PROCESS MECHANICAL DRAWINGS.

**SECTION/ DETAIL MARKERS**

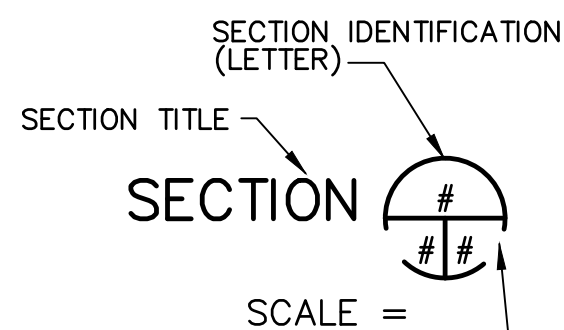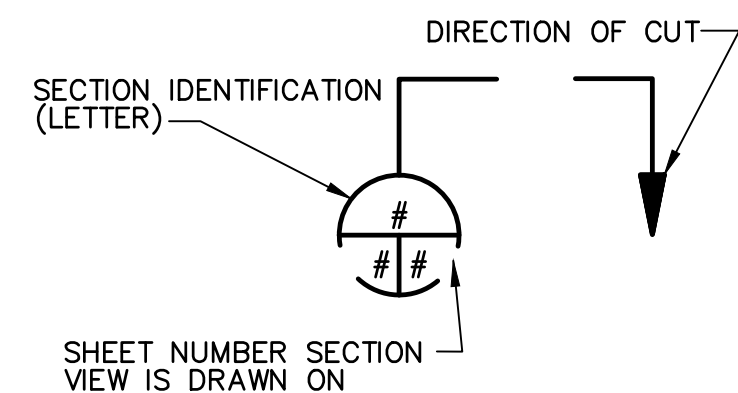

SCALE =

BACK-REFERENCE TO SHEET SECTION IS TAKEN FROM

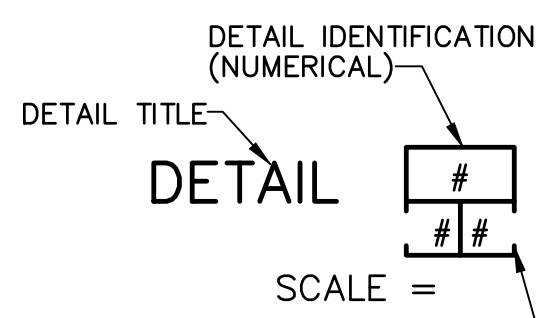

SCALE =

SHEET NUMBER DETAIL VIEW IS DRAWN ON

**MATERIAL LIST**

**DEMOLITION:**

- REMOVE AND DISPOSE

**NEW CONSTRUCTION:**

- FURNISH AND INSTALL

**SITE PLAN SYMBOLOGY**


=====	EXISTING UNDERGROUND PIPING 12" AND GREATER (SIZE & TYPE)	//////	DEMOLITION
-----	EXISTING UNDERGROUND PIPING LESS THAN 12" (SIZE & TYPE)		GRAVEL
⊗	EXISTING GATE OR BUTTERFLY VALVE		PAVEMENT
—□	EXISTING SUMP	.....	CONCRETE
○	EXISTING MANHOLE	.....	CLSM
=====	NEW ABOVE GROUND PIPING 12" AND GREATER (SIZE & TYPE)		EXISTING CMU
-----	NEW UNDERGROUND PIPE 12" AND GREATER (SIZE & TYPE)	//////	ABANDONMENT
-----	NEW UNDERGROUND PIPING LESS THAN 12" (SIZE & TYPE)		

**SHEET IDENTIFICATION**


- A ARCHITECTURAL (ARCHITECTURAL EXTERIORS, INTERIORS, RENDERINGS)
- C CIVIL SITE (PAVING AND GRADING, YARD PIPING,)
- E ELECTRICAL (POWER DISTRIBUTION AND ELECTRICAL EQUIPMENT WITHIN STRUCTURES OR ON SITE)
- F FIRE PROTECTION
- G GENERAL (COVER, INDEX, GENERAL ABBREVIATIONS, HYDRAULIC PROCESS)
- H HVAC (HEATING, VENTILATION AND AIR CONDITIONING)
- I INSTRUMENTATION (P&ID'S)
- L LANDSCAPE (VEGETATION AND HARDSCAPE, IRRIGATION SUPPLY)
- M MECHANICAL (PROCESS PIPING & EQUIPMENT)
- P PLUMBING (EQUIPMENT DRAINS, ROOF DRAINS, SEWERS, VENTS)
- Q EQUIPMENT PURCHASED BY THE OWNER
- S STRUCTURAL (STRUCTURE WALLS, SLABS, REINFORCED BUILDING OR CONCRETE ELEMENTS)
- T TELECOMMUNICATIONS (ELECTRONIC COMMUNICATIONS EQUIPMENT, CONDUIT)
- X OTHER DISCIPLINES OR DEMOLITION
- Z CONTRACTOR/SHOP DRAWINGS

FACILITY DRAWINGS  
 This drawing was supplied by a Consultant Engineer from a past construction project. The information provided by the Contractor to provide the Record Drawing. The City does not warranty this drawing to be a complete and accurate portrayal of facilities as they exist in the field.

FOR CITY OF PHOENIX USE ONLY - REFERENCE CID NUMBER: #	PROJECT NO.	PROJECT NAME	DATE	CAD FILE NAME	DWG NUMBER	REMARKS
#						
#						
#						

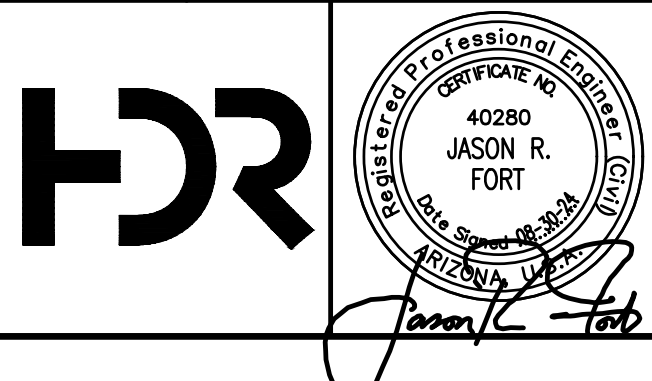

REVISIONS					
NO.	BY	DATE	CKD	REMARKS	
A	RS	10/2023	JF	30% SUBMITTAL	
B	RS	01/2024	JF	90% SUBMITTAL	
C	RS	04/2024	JF	AGENCY REVIEW	
D	DFD	08/2024	JF	ISSUED FOR CONSTRUCTION	
*					
*					
*					

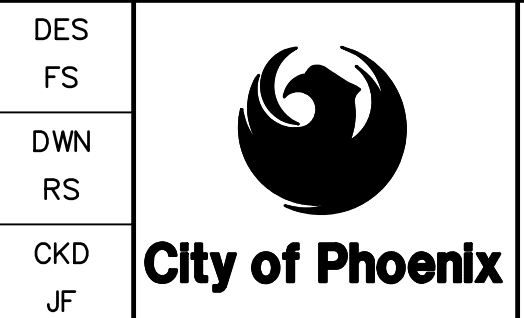

CITY OF PHOENIX  
 WATER SERVICES DEPARTMENT  
  
**LIFT STATION 40  
 REFURBISHMENT**

GENERAL  
**LEGEND & SYMBOLS**

COPYRIGHT © 2007-JANUARY  
 CITY PROJECT NO. WS90400085  
 DATE: 08/2024  
**G-03** SHEET 3 OF 134  
 CAD FILE: CSCLS40A03.dwg

USER: FBEASRFAUD FILE: C:\pwworking\west01\03411623\03\_CSCLS40A03.dwg DATE: 9/04/24 TIME: 03:17pm

THIS DRAWING MUST BE FIELD VERIFIED BEFORE USE  
DRAWING NOT TO SCALE UNLESS SCALE BAR IS PRESENT

FOR CONSTRUCTION

"PER CITY OF PHOENIX CODE CHAPTER 2, SECTION 2-28, THESE PLANS ARE FOR OFFICIAL USE ONLY AND MAY NOT BE SHARED WITH OTHERS EXCEPT AS REQUIRED TO FULFILL THE OBLIGATIONS OF THE CONTRACTOR'S CONTRACT WITH THE CITY OF PHOENIX."  
THIS DOCUMENT MUST BE KEPT SECURE AT ALL TIMES.

CITY OF PHOENIX SANITARY SEWER GENERAL NOTES

- 1. PLANNING & DEVELOPMENT DEPARTMENT'S CIVIL/SITE INSPECTION STAFF SHALL BE NOTIFIED 48 HOURS BEFORE ANY CONSTRUCTION BEGINS, TELEPHONE (602) 262-7811.
2. ANY SEWER MAIN 15 INCH IN SIZE OR 12 FEET IN DEPTH, OR GREATER, REQUIRES 5' MANHOLES.
3. ALL MANHOLES NEWLY CONSTRUCTED OR EXISTING THAT ARE WORKED IN FOR CONNECTIONS SHALL BE PAINTED WITH INSECTICIDE PAINT PER CITY OF PHOENIX SUPPLEMENT TO (MAG) SECTION 627.
4. MANHOLES WITH 60" DIAMETER AND PIPES GREATER THAN 12" REQUIRE COATING PER CITY OF PHOENIX SUPPLEMENT 626. ANY EXISTING MANHOLES WITH CORROSION COATING THAT ARE DISTURBED OR ADJUSTED TO NEW FINISH GRADES SHALL HAVE ANY DAMAGED COATING REPAIRED, INCLUDING ALL ADJUSTING RINGS.
5. THIS SET OF PLANS HAS BEEN INITIALLY REVIEWED BY THE CITY OF PHOENIX. SUCH REVIEW IS PART OF THE PROCESS THAT DEVELOPER(S)/CONTRACTOR(S) MUST GO THROUGH IN ORDER TO OBTAIN A CONSTRUCTION PERMIT. THE RESULTS OF SUCH INITIAL REVIEW, HOWEVER, SHALL NOT DICTATE THE CITY OF PHOENIX'S FINAL DETERMINATION AS TO THE ACCEPTABILITY OF THE PLANS, NOR SHALL IT PREVENT THE CITY OF PHOENIX FROM REQUIRING THAT ERRORS AND OMISSIONS, AS FOUND ON PLANS, BE ADDRESSED BY DEVELOPER(S)/CONTRACTOR(S), WHERE SUCH ERRORS AND OMISSIONS CAUSE THE PLANS TO BE IN VIOLATION OF OR INADEQUATE UNDER APPLICABLE FEDERAL/STATE/COUNTY/LOCAL CODES, ORDINANCES, REGULATIONS, OR OTHER LAWS. THIS REVIEWED AND STAMPED SET OF PLANS MUST BE KEPT AT THE CONSTRUCTION SITE AT ALL TIMES.
6. ALL CONSTRUCTION IN CITY OF PHOENIX RIGHT-OF-WAY, OR EASEMENT, IS TO CONFORM TO (MAG) SPECIFICATIONS AND DETAILS AND CITY OF PHOENIX SUPPLEMENT TO (MAG) SPECIFICATIONS AND DETAILS, UNLESS MODIFIED ON THE PLANS.
7. ALL SEWER MAINS MUST HAVE A T.V. INSPECTION BEFORE ACCEPTED AS COMPLETE (SEE CITY OF PHOENIX SUPPLEMENT TO (MAG) SPECIFICATION SECTION 615.11(C)).
8. TRAFFIC REGULATIONS: ALL WORK MUST COMPLY WITH REQUIREMENTS OF THE CURRENT CITY OF PHOENIX "TRAFFIC BARRICADE MANUAL."
9. THE FOLLOWING (MAG) DETAILS ARE SPECIFICALLY NOT APPROVED: 425 24" ALUMINUM FRAME AND COVER.
10. NEW MANHOLES ARE TO BE BUILT WITHOUT STEPS.
11. COMPACTION SHALL COMPLY WITH (MAG) SECTION 601 & CITY OF PHOENIX SUPPLEMENTS.
12. NEW SEWER LINES ARE TO BE BUILT IN ACCORDANCE WITH CITY OF PHOENIX "STANDARD UTILITY LOCATIONS".
13. A SIX (6) FOOT MINIMUM HORIZONTAL SEPARATION FROM ANY UNDERGROUND UTILITY SHALL BE PROVIDED FOR SEWER MAINS, SEWER SERVICES, WATER MAINS, AND WATER SERVICES. THE MINIMUM HORIZONTAL SEPARATION IS MEASURED FROM OUTSIDE OF SEWER MAIN, SEWER SERVICE, WATER MAIN, OR WATER SERVICE TO OUTSIDE OF UNDERGROUND UTILITY.
14. A ONE (1) FOOT MINIMUM VERTICAL SEPARATION FROM ANY DRY UNDERGROUND UTILITY CROSSING SHALL BE PROVIDED FOR SEWER MAINS, SEWER SERVICES, WATER MAINS, AND WATER SERVICES. THE MINIMUM VERTICAL SEPARATION IS MEASURED FROM OUTSIDE OF SEWER MAIN, SEWER SERVICE, WATER MAIN, OR WATER SERVICE TO OUTSIDE OF DRY UNDERGROUND UTILITY.
15. A TWO (2) FOOT MINIMUM VERTICAL SEPARATION SHALL BE PROVIDED BETWEEN ANY SEWER MAIN OR STORM DRAIN MAIN CROSSING A WATER MAIN. THE MINIMUM VERTICAL SEPARATION IS MEASURED FROM OUTSIDE OF WATER MAIN TO OUTSIDE OF SEWER MAIN OR STORM DRAIN MAIN. SEE (MAG) STANDARD DETAIL 404 FOR ADDITIONAL INFORMATION AND/OR PROVISIONS FOR CLEARANCE.
16. EXCEPTIONS OR DEVIATIONS FROM THE ABOVE MINIMUM CLEARANCES MUST BE APPROVED AND SHOWN ON THE APPROVED WATER AND SEWER PLANS. WHEN UTILITY CONFLICTS ARE FOUND DURING CONSTRUCTION, ALL CHANGES AND REVISIONS MUST BE PRECEDED BY AN APPROVED PLAN REVISION.
17. ANY AND ALL MORE STRINGENT SEPARATION REQUIREMENTS REQUIRED BY FEDERAL, STATE, COUNTY, OR LOCAL CODES OR ORDINANCES TAKE PRECEDENCE.
18. ANY SEWER LINES THAT ARE INSTALLED WITH LESS THAN .004 FT/FT SLOPE MUST BE INSTALLED USING A LASER.
19. WHEN DIP SEWER PIPE IS USED, LINING IS REQUIRED PER CITY OF PHOENIX SUPPLEMENT TO (MAG) SEC. 750.1.
20. CONCRETE OR ASPHALT DAMAGED DURING THE COURSE OF CONSTRUCTION SHALL BE REMOVED AND REPLACED IN KIND PRIOR TO FINAL INSPECTION.
21. RECORD DRAWING SUBMITTALS MUST COMPLY WITH WATER SERVICES DEPARTMENT ENGINEERING POLICY P-69. A COPY OF THE POLICY CAN BE OBTAINED IN THE DEPARTMENT'S WEBSITE: HTTP://PHOENIX.GOV/WATERSERVICES/DESIGN/ENGPOLICIES/INDEX.HTML
22. "PER CITY OF PHOENIX ORDINANCE G-4396, THESE PLANS ARE FOR OFFICIAL USE ONLY AND MAY NOT BE SHARED WITH OTHERS EXCEPT AS REQUIRED FOR THE CONSTRUCTION OF THE PUBLIC WORKS FACILITIES HEREON. THE PROJECT OWNER, AND THE OWNER'S LENDERS, CONSULTANTS, CONTRACTORS AND SUBCONTRACTORS ARE PROHIBITED FROM DISCLOSING THE PLANS AND SPECIFICATIONS TO ANY PERSONS OTHER THAN THOSE WHO HAVE A NEED TO KNOW THE INFORMATION FOR THE PURPOSE OF THE PROJECT."
23. A PAVEMENT CUT SURCHARGE SHALL BE ASSESSED ON THIS PROJECT FOR ANY TRENCHING OR POTHOLING IN NEW ASPHALT PAVEMENT THAT IS LESS THAN 30 MONTHS OLD. SURCHARGE FEES ASSESSED ARE IN ADDITION TO THE REGULAR PERMIT FEES AND ARE OVER AND ABOVE ANY SPECIAL BACKFILL, COMPACTION, AND PAVEMENT REPLACEMENT STIPULATIONS THAT MAY BE IMPOSED AS A CONDITION OF PERMITTING. PAVEMENT CUT SURCHARGE FEES IS ASSESSED IN ACCORDANCE WITH SECTION 31-36 OF THE PHOENIX CITY CODE.
24. LIFT STATIONS SHALL BE SECURED TO PREVENT TAMPERING AND AFFIX ON ITS EXTERIOR, OR ON THE NEAREST VERTICAL OBJECT IF THE LIFT STATION IS ENTIRELY BELOW GRADE, AT LEAST ONE WARNING SIGN THAT INCLUDES THE 24-HOUR EMERGENCY PHONE NUMBER OF THE OWNER OR OPERATOR OF THE COLLECTION SYSTEM PER AAC (R18-9-E301.D.5.a).

CITY OF PHOENIX SANITARY SEWER GENERAL NOTES (CON'T)

- 25. PLAN APPROVAL IS VALID FOR 180 DAYS. PRIOR TO PLAN APPROVAL EXPIRATION, ALL ASSOCIATED PERMITS SHALL BE PURCHASED OR THE PLANS SHALL BE RESUBMITTED FOR EXTENSION OF PLAN APPROVAL. THE EXPIRATION, EXTENSION, AND REINSTATEMENT OF CIVIL ENGINEERING PLANS AND PERMITS SHALL FOLLOW THE SAME GUIDELINES AS THOSE INDICATED IN THE PHOENIX BUILDING CONSTRUCTION CODE ADMINISTRATIVE PROVISIONS SECTION 105.3 FOR BUILDING PERMITS.
26. FOR LOTS FRONTING AN EXISTING SEWER MAIN, SEWER SERVICES SHALL BE CONSTRUCTED BY THE CONTRACTOR AFTER PROPER APPLICATION AND PAYMENT OF PREVAILING FEES FOR CITY FORCES TO PROVIDE THE CONNECTION OR "WYE" IN ACCORDANCE WITH WATER SERVICES DEPARTMENT POLICY P-1, SEWER ORDINANCE G-2358, SECTION D. FOR INFORMATION, CALL 602-262-6551.
27. THIS PLAN IS APPROVED SUBJECT TO COMPLETION OF SOME LINES LABELED 'EXISTING' WHICH HAVE BEEN PROPOSED AS A PART OF ANOTHER DEVELOPMENT. THE DEVELOPER OF THIS PROJECT MAY BE REQUIRED TO CONSTRUCT THOSE LINES PER CITY REQUIREMENTS PRIOR TO RECEIVING SERVICE FOR THIS PROJECT.

ENGINEER'S GENERAL NOTES

- 1. ALL CONSTRUCTION SHALL BE PERFORMED IN ACCORDANCE WITH THE CONTRACT DRAWINGS, SPECIAL PROVISIONS, TECHNICAL SPECIFICATIONS, SUPPLEMENTAL GENERAL CONDITIONS, MARICOPA ASSOCIATION OF GOVERNMENTS (MAG) STANDARD SPECIFICATIONS FOR PUBLIC WORKS CONSTRUCTION (2023 EDITION OR AS NOTED), MAG UNIFORM STANDARD DETAILS FOR PUBLIC WORKS CONSTRUCTION (2023 EDITION OR AS NOTED) AND THE CITY OF PHOENIX STANDARD DETAILS (2021 CITY SUPPLEMENT TO THE 2019 MAG STANDARD DETAILS) AND SPECIFICATIONS (2015 CITY SUPPLEMENT TO THE 2015 MAG SPECIFICATIONS).
2. NEW FORCE MAINS SHALL BE CONSTRUCTED OF MATERIALS IN ACCORDANCE WITH THE SPECIFICATIONS.
3. VALVES SHALL BE OF THE TYPE DESIGNATED ON THE DRAWINGS AND SHALL COMPLY WITH MAG STANDARD SPECIFICATION SECTION 630 WITH THE EXCEPTION THAT GATE VALVES (14-INCH THROUGH 36-INCH) SHALL BE INSTALLED FOR OPERATION IN THE VERTICAL POSITION. VALVE BOXES AND COVERS ARE REQUIRED FOR ALL GATE VALVES. VALVE BOXES SHALL BE ADJUSTED TO FINISH GRADE.
4. JOINT RESTRAINT SHALL BE PROVIDED AT LOCATIONS SHOWN ON THE DRAWINGS AND AT ALL CHANGES IN PIPELINE DIRECTION, TEES, BENDS, DEAD ENDS AND VALVES. RESTRAINED JOINT LENGTHS SHALL BE IN ACCORDANCE WITH MAG STANDARD DETAIL 303 UNLESS OTHERWISE SHOWN ON THE DRAWINGS OR APPROVED BY THE ENGINEER. CONNECTIONS TO EXISTING FORCE MAINS SHALL INCLUDE THRUST BLOCKS AS REQUIRED PER MAG SPECIFICATION SECTION 610 AND MAG STANDARD DETAIL 380.
5. THE CONTRACTOR SHALL CONFIRM PIPE MATERIAL AT DESIGNATED CONNECTION POINTS PRIOR TO ORDERING FITTINGS.
6. ALL NEW FORCE MAINS SHALL BE PRESSURE TESTED PRIOR TO ACCEPTANCE. UNLESS OTHERWISE NOTED IN THE SPECIFICATIONS, PRESSURE TESTING SHALL BE IN ACCORDANCE WITH ASTM F2164 UNLESS SPECIFICALLY AUTHORIZED BY THE CITY, PRESSURE TESTING AGAINST EXISTING SYSTEM COMPONENTS WILL NOT BE ALLOWED.
7. TRAFFIC CONTROL SHALL BE IN ACCORDANCE WITH THE GOVERNING AGENCY'S REQUIREMENTS. CONTRACTOR SHALL SUBMIT TRAFFIC CONTROL PLANS TO THE GOVERNING AGENCIES AS REQUIRED BY THE AGENCY.
8. CONTRACTOR'S WORK ACTIVITIES SHALL BE SCHEDULED AND PHASED SO AS NOT TO UNDULY IMPEDE OR PREVENT ACCESS TO PRIVATE RESIDENCES, PUBLIC FACILITIES, SCHOOLS, OR BUSINESS EXCEPT BY PRIOR WRITTEN AGREEMENT WITH THE IMPACTED OWNER(S) OR OPERATORS.
9. CONCRETE SIDEWALK, CURB, CURB & GUTTER SHALL BE SAWCUT, REMOVED & REPLACED TO THE NEAREST JOINT.
10. AS-BUILT DRAWINGS SHALL BE PREPARED IN ACCORDANCE WITH WATER SERVICES DEPARTMENT GENERAL NOTE 17 AND ENGINEERING POLICY P-85. ALL VALVES, HYDRANTS, FITTINGS AND SERVICE CONNECTIONS SHOWN ON CONTRACTOR'S AS-BUILT REDLINES SHALL REFERENCE PROJECT STATIONING.
11. REMOVAL OF ASBESTOS CEMENT PIPE (ACP) SHALL BE ACCOMPLISHED BY A CONTRACTOR LICENSED BY THE STATE OF ARIZONA REGISTRAR OF CONTRACTORS TO PERFORM ASBESTOS REMOVALS. ALL ASBESTOS REMOVAL, HANDLING AND DISPOSAL SHALL BE IN ACCORDANCE WITH ALL APPLICABLE LOCAL STATE AND FEDERAL LAWS. THE CONTRACTOR SHALL BE RESPONSIBLE FOR ANY SAFETY AND ALL NOTIFICATIONS, FEES, TAXES, PERMITS, REGISTRATIONS AND REGULATORY INSPECTIONS AS REQUIRED BY APPLICABLE LAWS.
12. EXISTING UTILITIES AND OTHER FACILITIES HAVE BEEN SHOWN ON THE CONTRACT DRAWINGS BASED ON FIELD SURVEYS, EXISTING MAPS, AND OTHER INFORMATION GATHERED BY THE ENGINEER DURING DESIGN. THE CONTRACTOR SHALL BE RESPONSIBLE FOR VERIFYING THE EXACT LOCATIONS OF ALL UTILITIES IMPACTING CONSTRUCTION AND PROTECTION OF SAID UTILITIES. IF RELOCATION OF UTILITIES IS REQUIRED, THE CONTRACTOR SHALL COORDINATE THE RELOCATION WITH THE OWNER. UTILITIES DAMAGED BY CONTRACTOR'S ACTIVITIES SHALL BE REPAIRED WITH NEW MATERIALS AT NO COST TO THE OWNER AND TO THE OWNER'S SATISFACTION.
13. CONTRACTOR SHALL SUPPORT AND PROTECT IN-PLACE UTILITIES WITHIN THE EXCAVATION IN ACCORDANCE WITH MAG SPECIFICATIONS, UNLESS OTHERWISE APPROVED IN WRITING BY THE OWNER OF THE UTILITY.
14. EXISTING FEATURES AND FACILITIES WHICH ARE NOT SPECIFICALLY LOCATED WITH HORIZONTAL AND VERTICAL CONTROLS ARE LOCATED APPROXIMATELY WITH THE BEST AVAILABLE INFORMATION. VARIATIONS BETWEEN PLAN LOCATION AND ACTUAL DIMENSIONS WILL NOT BE A BASIS FOR A MODIFICATION OF THE CONTRACT AMOUNT.

FACILITY DRAWINGS  
This drawing was supplied by a Consultant Engineer from a past construction project. The information provided by the Contractor to provide the Record Drawing. The City does not warranty this drawing to be a complete and accurate portrayal of facilities as they exist in the field.

Table with columns: FOR CITY OF PHOENIX USE ONLY, REFERENCE, CID, NUMBER, #, PROJECT NO., PROJECT NAME, DATE, CAD FILE NAME, DWG NUMBER, REMARKS


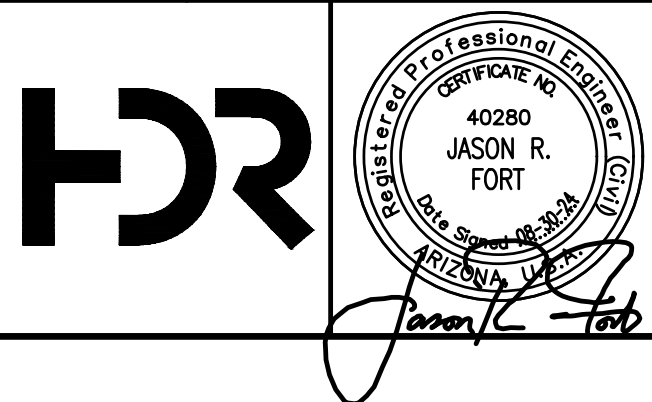


Table with columns: NO., BY, DATE, CKD, REMARKS

Table with columns: NO., BY, DATE, CKD, REMARKS

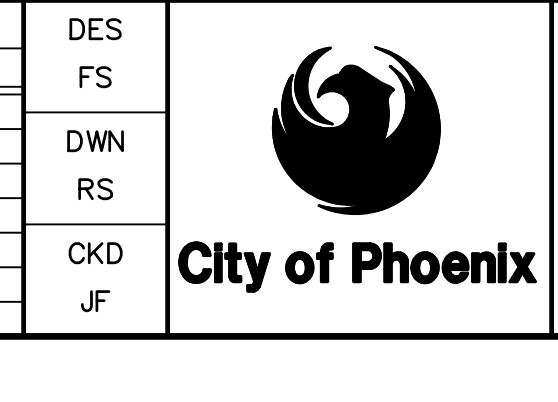

CITY OF PHOENIX WATER SERVICES DEPARTMENT  
LIFT STATION 40 REFURBISHMENT

GENERAL  
GENERAL NOTES  
COPYRIGHT © 2007-JANUARY  
CITY PROJECT NO. WS90400085  
DATE: 08/2024  
G-04 SHEET 4 OF 134  
CAD FILE: CSCLS40A04.dwg


USER: FBREA5FRALUD FILE: C:\pwworking\west01\03411625\04\_CSCLS40A04.dwg DATE: 8/04/24 TIME: 03:17pm



FOR CONSTRUCTION

THIS DRAWING MUST BE FIELD VERIFIED BEFORE USE. DRAWING NOT TO SCALE UNLESS SCALE BAR IS PRESENT

"PER CITY OF PHOENIX CODE CHAPTER 2, SECTION 2-28, THESE PLANS ARE FOR OFFICIAL USE ONLY AND MAY NOT BE SHARED WITH OTHERS EXCEPT AS REQUIRED TO FULFILL THE OBLIGATIONS OF THE CONTRACTOR'S CONTRACT WITH THE CITY OF PHOENIX." THIS DOCUMENT MUST BE KEPT SECURE AT ALL TIMES.

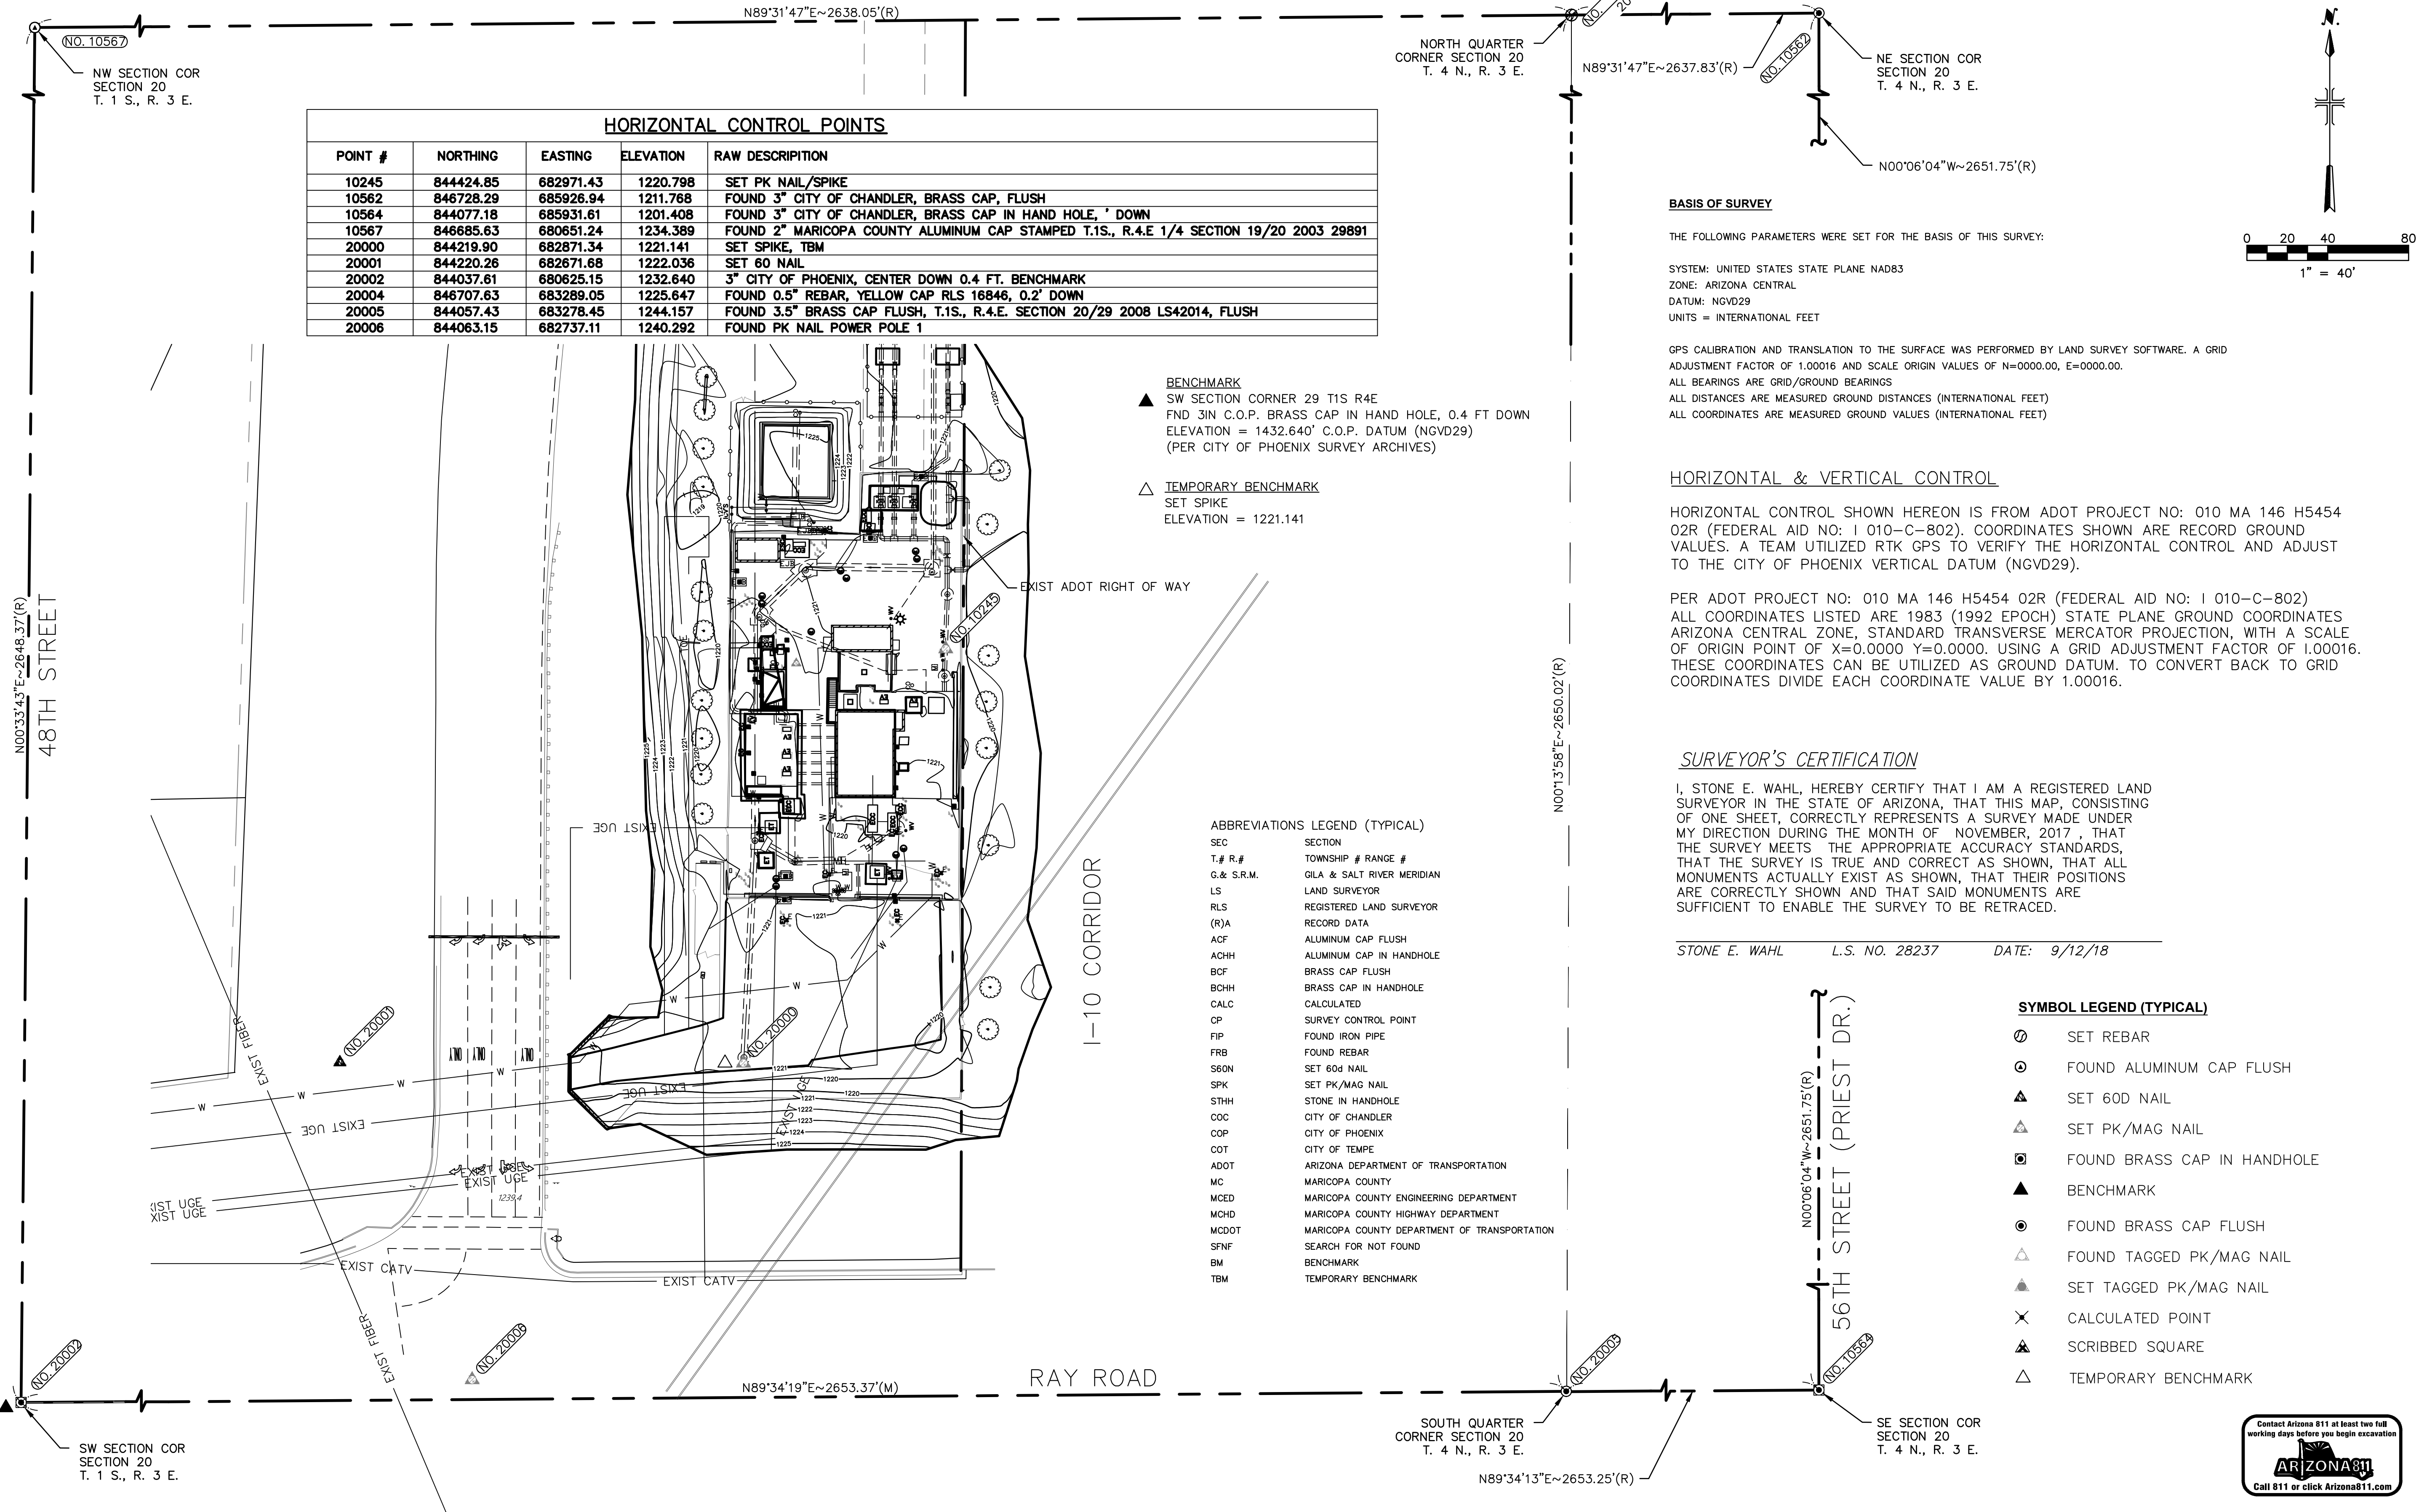

HORIZONTAL CONTROL POINTS				
POINT #	NORTHING	EASTING	ELEVATION	RAW DESCRIPTION
10245	844424.85	682971.43	1220.798	SET PK NAIL/SPIKE
10562	846728.29	685926.94	1211.768	FOUND 3" CITY OF CHANDLER, BRASS CAP, FLUSH
10564	844077.18	685931.61	1201.408	FOUND 3" CITY OF CHANDLER, BRASS CAP IN HAND HOLE, ' DOWN
10567	846685.63	680651.24	1234.389	FOUND 2" MARICOPA COUNTY ALUMINUM CAP STAMPED T.1S., R.4.E 1/4 SECTION 19/20 2003 29891
20000	844219.90	682871.34	1221.141	SET SPIKE, TBM
20001	844220.26	682671.68	1222.036	SET 60 NAIL
20002	844037.61	680625.15	1232.640	3" CITY OF PHOENIX, CENTER DOWN 0.4 FT. BENCHMARK
20004	846707.63	683289.05	1225.647	FOUND 0.5" REBAR, YELLOW CAP RLS 16846, 0.2' DOWN
20005	844057.43	683278.45	1244.157	FOUND 3.5" BRASS CAP FLUSH, T.1S., R.4.E. SECTION 20/29 2008 LS42014, FLUSH
20006	844063.15	682737.11	1240.292	FOUND PK NAIL POWER POLE 1

- BENCHMARK**  
▲ SW SECTION CORNER 29 T1S R4E  
FND 3IN C.O.P. BRASS CAP IN HAND HOLE, 0.4 FT DOWN  
ELEVATION = 1432.640' C.O.P. DATUM (NGVD29)  
(PER CITY OF PHOENIX SURVEY ARCHIVES)
- △ TEMPORARY BENCHMARK  
SET SPIKE  
ELEVATION = 1221.141

ABBREVIATIONS LEGEND (TYPICAL)

SEC	SECTION
T.# R.#	TOWNSHIP # RANGE #
G.& S.R.M.	GILA & SALT RIVER MERIDIAN
LS	LAND SURVEYOR
RLS	REGISTERED LAND SURVEYOR
(R)A	RECORD DATA
ACF	ALUMINUM CAP FLUSH
ACHH	ALUMINUM CAP IN HANDHOLE
BCF	BRASS CAP FLUSH
BCHH	BRASS CAP IN HANDHOLE
CALC	CALCULATED
CP	SURVEY CONTROL POINT
FIP	FOUND IRON PIPE
FRB	FOUND REBAR
S60N	SET 60d NAIL
SPK	SET PK/MAG NAIL
STHH	STONE IN HANDHOLE
COC	CITY OF CHANDLER
COP	CITY OF PHOENIX
COT	CITY OF TEMPE
ADOT	ARIZONA DEPARTMENT OF TRANSPORTATION
MC	MARICOPA COUNTY
MCED	MARICOPA COUNTY ENGINEERING DEPARTMENT
MCHD	MARICOPA COUNTY HIGHWAY DEPARTMENT
MCDOT	MARICOPA COUNTY DEPARTMENT OF TRANSPORTATION
SFNF	SEARCH FOR NOT FOUND
BM	BENCHMARK
TBM	TEMPORARY BENCHMARK

**BASIS OF SURVEY**

THE FOLLOWING PARAMETERS WERE SET FOR THE BASIS OF THIS SURVEY:

SYSTEM: UNITED STATES STATE PLANE NAD83  
ZONE: ARIZONA CENTRAL  
DATUM: NGVD29  
UNITS = INTERNATIONAL FEET

GPS CALIBRATION AND TRANSLATION TO THE SURFACE WAS PERFORMED BY LAND SURVEY SOFTWARE. A GRID ADJUSTMENT FACTOR OF 1.00016 AND SCALE ORIGIN VALUES OF N=0000.00, E=0000.00.  
ALL BEARINGS ARE GRID/GROUND BEARINGS  
ALL DISTANCES ARE MEASURED GROUND DISTANCES (INTERNATIONAL FEET)  
ALL COORDINATES ARE MEASURED GROUND VALUES (INTERNATIONAL FEET)

**HORIZONTAL & VERTICAL CONTROL**

HORIZONTAL CONTROL SHOWN HEREON IS FROM ADOT PROJECT NO: 010 MA 146 H5454 02R (FEDERAL AID NO: I 010-C-802). COORDINATES SHOWN ARE RECORD GROUND VALUES. A TEAM UTILIZED RTK GPS TO VERIFY THE HORIZONTAL CONTROL AND ADJUST TO THE CITY OF PHOENIX VERTICAL DATUM (NGVD29).

PER ADOT PROJECT NO: 010 MA 146 H5454 02R (FEDERAL AID NO: I 010-C-802)  
ALL COORDINATES LISTED ARE 1983 (1992 EPOCH) STATE PLANE GROUND COORDINATES ARIZONA CENTRAL ZONE, STANDARD TRANSVERSE MERCATOR PROJECTION, WITH A SCALE OF ORIGIN POINT OF X=0.0000 Y=0.0000. USING A GRID ADJUSTMENT FACTOR OF 1.00016. THESE COORDINATES CAN BE UTILIZED AS GROUND DATUM. TO CONVERT BACK TO GRID COORDINATES DIVIDE EACH COORDINATE VALUE BY 1.00016.

**SURVEYOR'S CERTIFICATION**

I, STONE E. WAHL, HEREBY CERTIFY THAT I AM A REGISTERED LAND SURVEYOR IN THE STATE OF ARIZONA, THAT THIS MAP, CONSISTING OF ONE SHEET, CORRECTLY REPRESENTS A SURVEY MADE UNDER MY DIRECTION DURING THE MONTH OF NOVEMBER, 2017, THAT THE SURVEY MEETS THE APPROPRIATE ACCURACY STANDARDS, THAT THE SURVEY IS TRUE AND CORRECT AS SHOWN, THAT ALL MONUMENTS ACTUALLY EXIST AS SHOWN, THAT THEIR POSITIONS ARE CORRECTLY SHOWN AND THAT SAID MONUMENTS ARE SUFFICIENT TO ENABLE THE SURVEY TO BE RETRACED.

STONE E. WAHL L.S. NO. 28237 DATE: 9/12/18

**SYMBOL LEGEND (TYPICAL)**

○	SET REBAR
⊙	FOUND ALUMINUM CAP FLUSH
▲	SET 60D NAIL
△	SET PK/MAG NAIL
⊠	FOUND BRASS CAP IN HANDHOLE
▲	BENCHMARK
⊙	FOUND BRASS CAP FLUSH
△	FOUND TAGGED PK/MAG NAIL
▲	SET TAGGED PK/MAG NAIL
×	CALCULATED POINT
⊠	SCRIBBED SQUARE
△	TEMPORARY BENCHMARK



REVISIONS				
NO.	BY	DATE	CKD	REMARKS
A	RS	10/2023	JF	30% SUBMITTAL
B	RS	01/2024	JF	90% SUBMITTAL
C	RS	04/2024	JF	AGENCY REVIEW
D	DFD	08/2024	JF	ISSUED FOR CONSTRUCTION
*				
*				
*				

CITY OF PHOENIX  
WATER SERVICES DEPARTMENT

LIFT STATION 40  
REFURBISHMENT

CIVIL

SURVEY CONTROL

COPYRIGHT © 2007-JANUARY

CITY PROJECT NO. WS90400085

DATE: 08/2024

C-01 SHEET 6 OF 134

CAD FILE: DSCLS40P01.DWG


FACILITY DRAWINGS  
This drawing was supplied by a Consultant Engineer from a permit construction project. The Consultant Engineer is not responsible for construction information provided by the Contractor to provide the Record Drawing. The City does not warrant this drawing to be a complete and accurate portrayal of facilities as they exist in the field.

FOR CITY OF PHOENIX USE ONLY	REFERENCE CID NUMBER	#	DATE	CAD FILE NAME	DWG NUMBER	REMARKS

USER: FBEAS\FRAUD FILE: C:\pwworking\west01\03411840\06\_DSCLS40P01.dwg DATE: 9/14/24 TIME: 03:17pm

**FOR CONSTRUCTION**


THIS DRAWING MUST BE FIELD VERIFIED BEFORE USE  
DRAWING NOT TO SCALE UNLESS SCALE BAR IS PRESENT

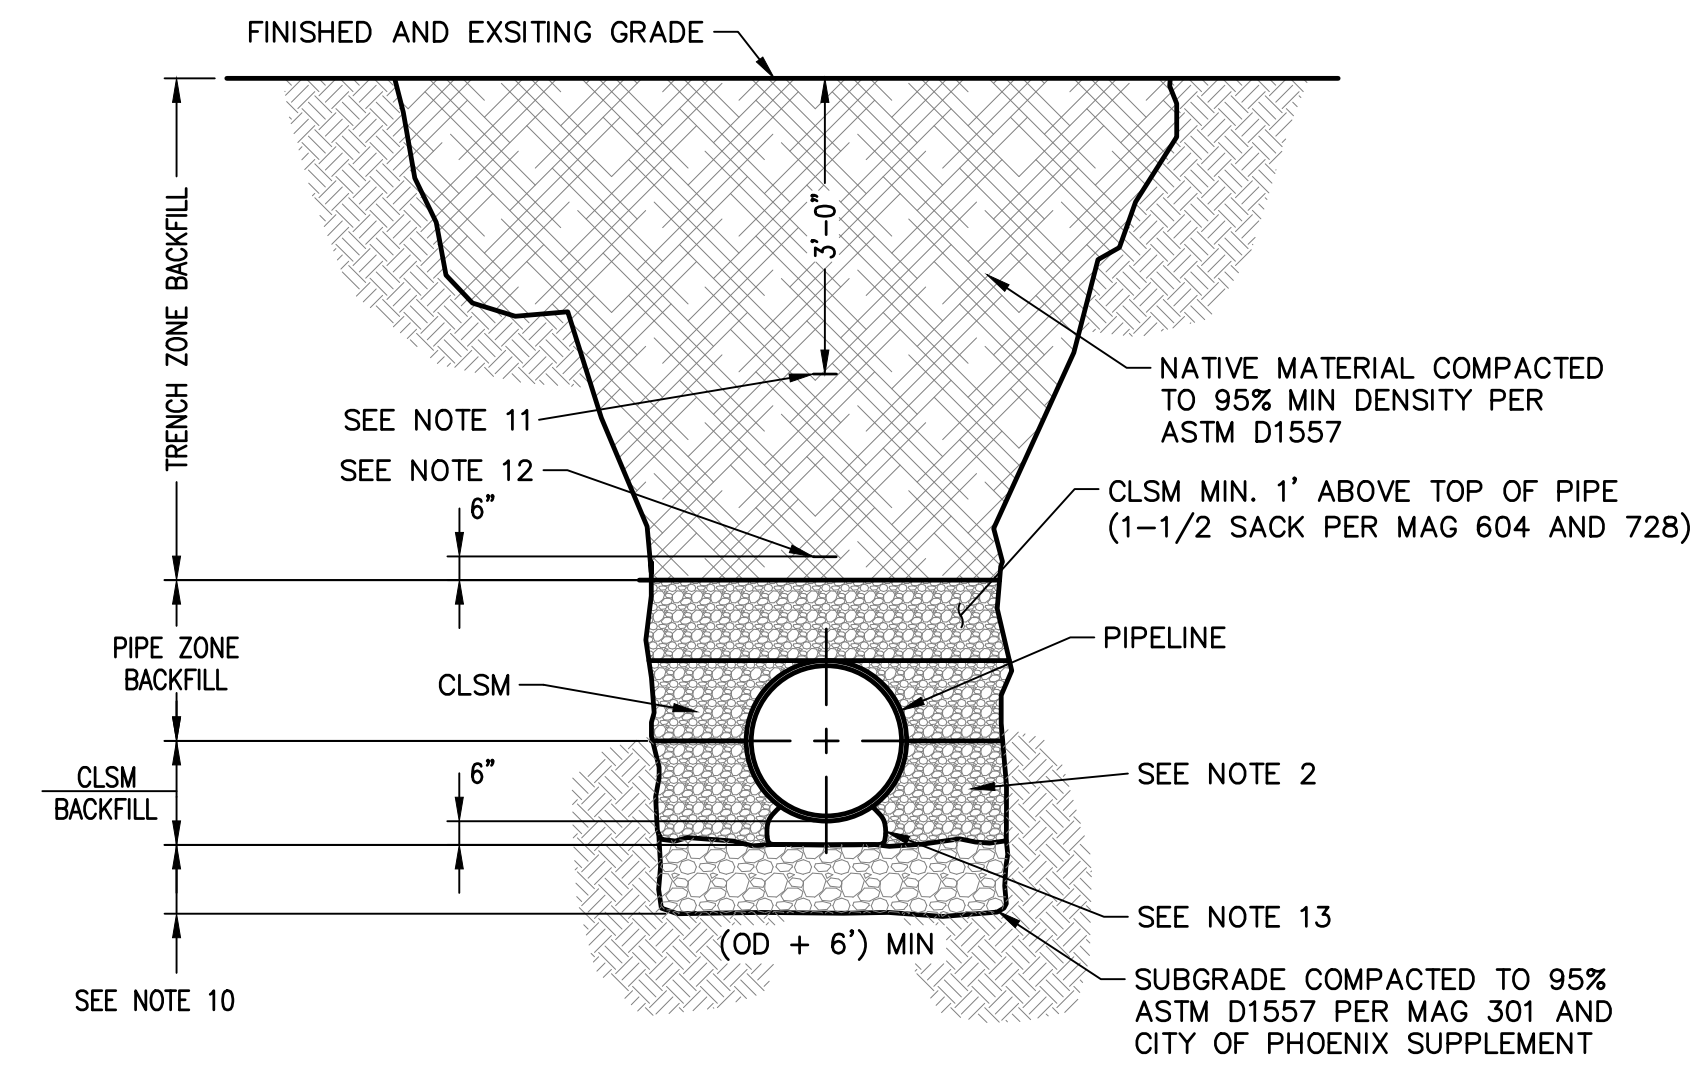

**NOTES:**

- PIPE TRENCH BRACING AND SHORING SHALL CONFORM TO ARIZONA DEPARTMENT OF OCCUPATIONAL SAFETY AND HEALTH ADMINISTRATION (AOSHA) AND OCCUPATIONAL SAFETY AND HEALTH (ADOSH) REQUIREMENTS.
- CLSM ENCASUREMENT SHALL BE FROM THE BOTTOM OF THE TRENCH TO TOP OF ALL PIPE. ENCASUREMENT SHALL BE 1-1/2-SACK CLSM UNLESS REINFORCED CONCRETE IS SHOWN ON DRAWINGS. SEE SPEC SEC. 03 30 00.
- ACCEPTABLE METHODS OF COMPACTION
  - CLSM BACKFILL - VIBRATE CLSM
  - PIPE ZONE - MECHANICAL COMPACTION
  - TRENCH ZONE - MECHANICAL COMPACTION
- TRENCH EXCAVATION SHALL COMPLY WITH THE CURRENT REGULATIONS AS DETERMINED BY ADOSH AND OSHA.
- THE CONTRACTOR MAY EXPECT VARIOUS OSHA SOIL CLASSIFICATIONS TO BE ENCOUNTERED ALONG THE PROJECT AND MAY EXPECT THE TRENCH TO CONTAIN VERTICALLY VARYING OSHA SOIL CLASSIFICATIONS.
- THE VARYING CONDITIONS MAY REQUIRE THE CONTRACTOR TO VARY TRENCH EXCAVATIONS AND STABILIZATION METHODS ALONG THE PROJECT.
- THE CONTRACTOR IS SOLELY RESPONSIBLE FOR DETERMINATION OF OSHA SOIL CLASSIFICATIONS AND DETERMINATION, SELECTION, AND IMPLEMENTATION OF EXCAVATIONS AND TRENCH STABILIZATION METHODS APPROPRIATE FOR THE TRENCH DEPTH AND OSHA SOIL CLASSIFICATIONS ENCOUNTERED, IN CONFORMANCE WITH ADOSH AND OSHA REQUIREMENTS.
- IF CONTRACTOR'S SELECTED METHODS OF TRENCH EXCAVATION AND STABILIZATION REQUIRE QUANTITIES OF PIPE ZONE BACKFILL MATERIALS (CLSM OR CONCRETE ENCASUREMENT) IN EXCESS OF THE MINIMUMS SHOWN, PROVIDE ADDITIONAL MATERIALS AT NO ADDITIONAL COST TO THE CITY.
- IN UNPAVED AREAS, THE TRENCH ZONE BACKFILL SHALL EXTEND TO FINISH GRADE.
- IN AREAS OF EXCESSIVE GROUND WATER OR POOR SUBGRADE MATERIAL AS DETERMINED BY CONSTRUCTION MANAGER, OVER EXCAVATE AND STABILIZE W/ CRUSHED ROCK BACKFILL (CO8.0207 UNIFORM STANDARDS) TO A MAXIMUM DEPTH OF 18". DEPTHS OF GREATER THAN 18" SHALL BE AS DIRECTED BY THE OWNER.
- PLASTIC MARKING TAPE - MINIMUM 6" WIDE, PER SPECIFICATION SECTION 33 14 10; 3.2A
- METALLIC LOCATOR TAPE - MINIMUM 3" WIDE, PER SPECIFICATION SECTION 33 14 10; 3.2B
- PIPE SUPPORT SAND BAG. CONTRACTOR TO COORDINATE ALLOWABLE SPACING WITH PIPE MANUFACTURER.

**TYPICAL PIPE TRENCH WITHOUT PAVEMENT**  
DETAIL 1  
C-02 C-02  
NOT TO SCALE

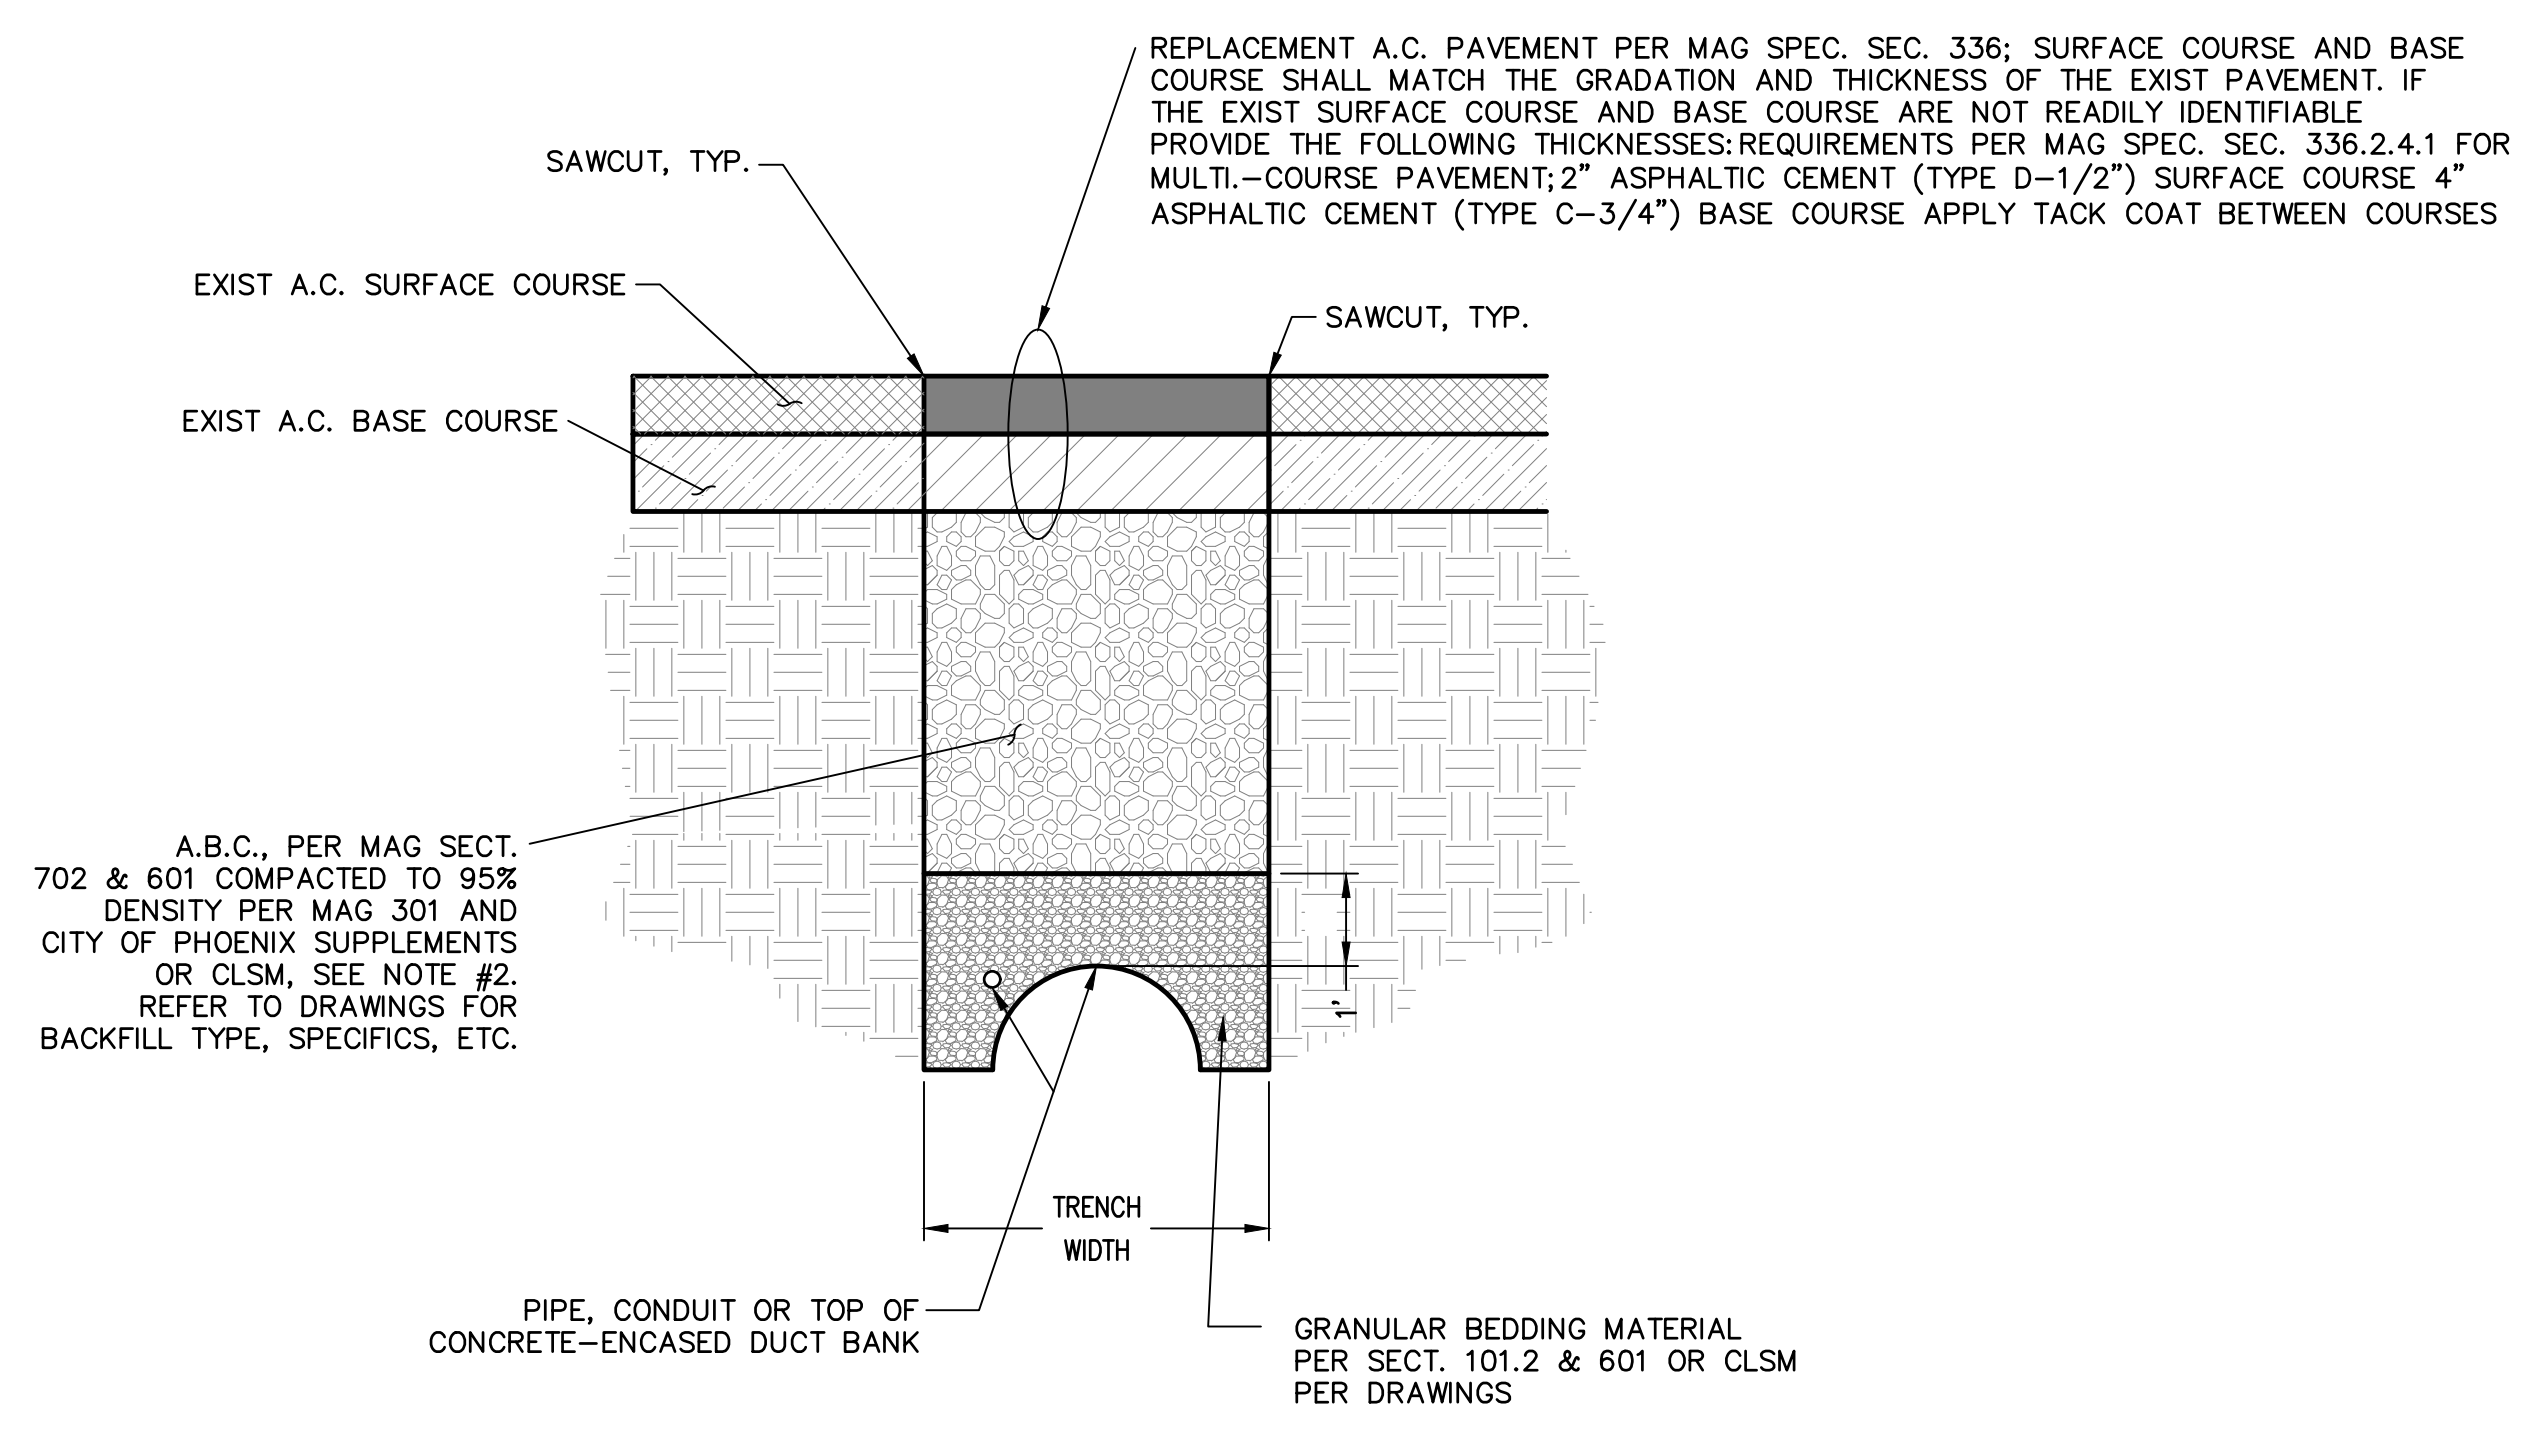

**NOTES:**


- BEDDING PER SECTION 601 FOR ALL TRENCH TYPES.
- CONTROLLED LOW STRENGTH MATERIAL (CLSM) SHALL BE 1-1/2 SACK, CEMENT-ENRICHED ABC SLURRY (MAX COMPRESSIVE STRENGTH = 150 PSI @28 DAYS). (PER SPEC SEC. 03 30 00).
- TRENCH WIDTH PER SECTION 336 & 601.
- EXPOSED WATER SERVICE PIPE THAT CROSS TRENCHES TO BE BACKFILLED WITH CLSM SHALL BE WRAPPED WITH MIN. 3/4" THICK CLOSED CELL FOAM INSULATION PRIOR TO PLACEMENT OF CLSM.
- FOR TRENCHES UP TO 24" WIDE, CLSM MAY BE USED UP TO THE REPLACEMENT PAVEMENT SUBGRADE LEVEL. FOR TRENCHES BETWEEN 24" AND 6' WIDE, CLSM SHALL ONLY BE PLACED IN THE TOP 24" OF TRENCH.
- MARKING TAPE NOT SHOWN FOR CLARITY.

**TRENCH BACKFILL & SURFACE REPLACEMENT**  
**CITY OF PHOENIX DETAIL NO. P1200, TYPE 'B'**  
DETAIL 2  
C-02 C-02  
NOT TO SCALE

"PER CITY OF PHOENIX CODE CHAPTER 2, SECTION 2-28, THESE PLANS ARE FOR OFFICIAL USE ONLY AND MAY NOT BE SHARED WITH OTHERS EXCEPT AS REQUIRED TO FULFILL THE OBLIGATIONS OF THE CONTRACTOR'S CONTRACT WITH THE CITY OF PHOENIX." THIS DOCUMENT MUST BE KEPT SECURE AT ALL TIMES.

FACILITY DRAWINGS  
This drawing was supplied by a Consultant Engineer from a past construction project. The Consultant Engineer is not responsible for the construction information provided by the Contractor to provide the Record Drawing. The City does not warrant this drawing to be a complete and accurate portrayal of facilities as they exist in the field.

FOR CITY OF PHOENIX USE ONLY - REFERENCE CID NUMBER: #	PROJECT NO.	PROJECT NAME	DATE	CAD FILE NAME	DWG NUMBER	REMARKS

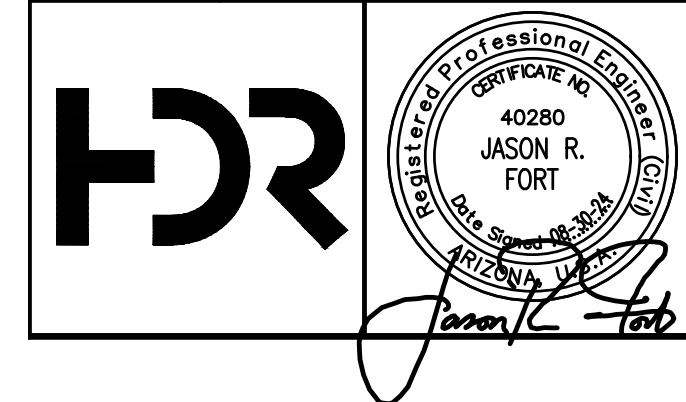

REVISIONS					
NO.	BY	DATE	CKD	REMARKS	
A	RS	10/2023	JF	30% SUBMITTAL	DES
B	RS	01/2024	JF	90% SUBMITTAL	DWN
C	RS	04/2024	JF	AGENCY REVIEW	RS
D	DFD	08/2024	JF	ISSUED FOR CONSTRUCTION	CKD
*					JF
*					
*					



CITY OF PHOENIX  
WATER SERVICES DEPARTMENT  
**LIFT STATION 40**  
**REFURBISHMENT**

CIVIL  
**GENERAL DETAILS 1**


COPYRIGHT © 2007-JANUARY  
CITY PROJECT NO. WS90400085  
DATE: 08/2024  
**C-02** SHEET 7 OF 134  
CAD FILE: CSCLS40D01.DWG

USER: FBEAS\FR\AUD FILE: C:\pwworking\west01\03411840\07\_CSCLS40D01.dwg DATE: 09/04/24 TIME: 03:17pm

THIS DRAWING MUST BE FIELD VERIFIED BEFORE USE. DRAWING NOT TO SCALE UNLESS SCALE BAR IS PRESENT.

FOR CONSTRUCTION

"PER CITY OF PHOENIX CODE CHAPTER 2, SECTION 2-28, THESE PLANS ARE FOR OFFICIAL USE ONLY AND MAY NOT BE SHARED WITH OTHERS EXCEPT AS REQUIRED TO FULFILL THE OBLIGATIONS OF THE CONTRACTOR'S CONTRACT TO THE CITY OF PHOENIX." THIS DOCUMENT MUST BE KEPT SECURE AT ALL TIMES.

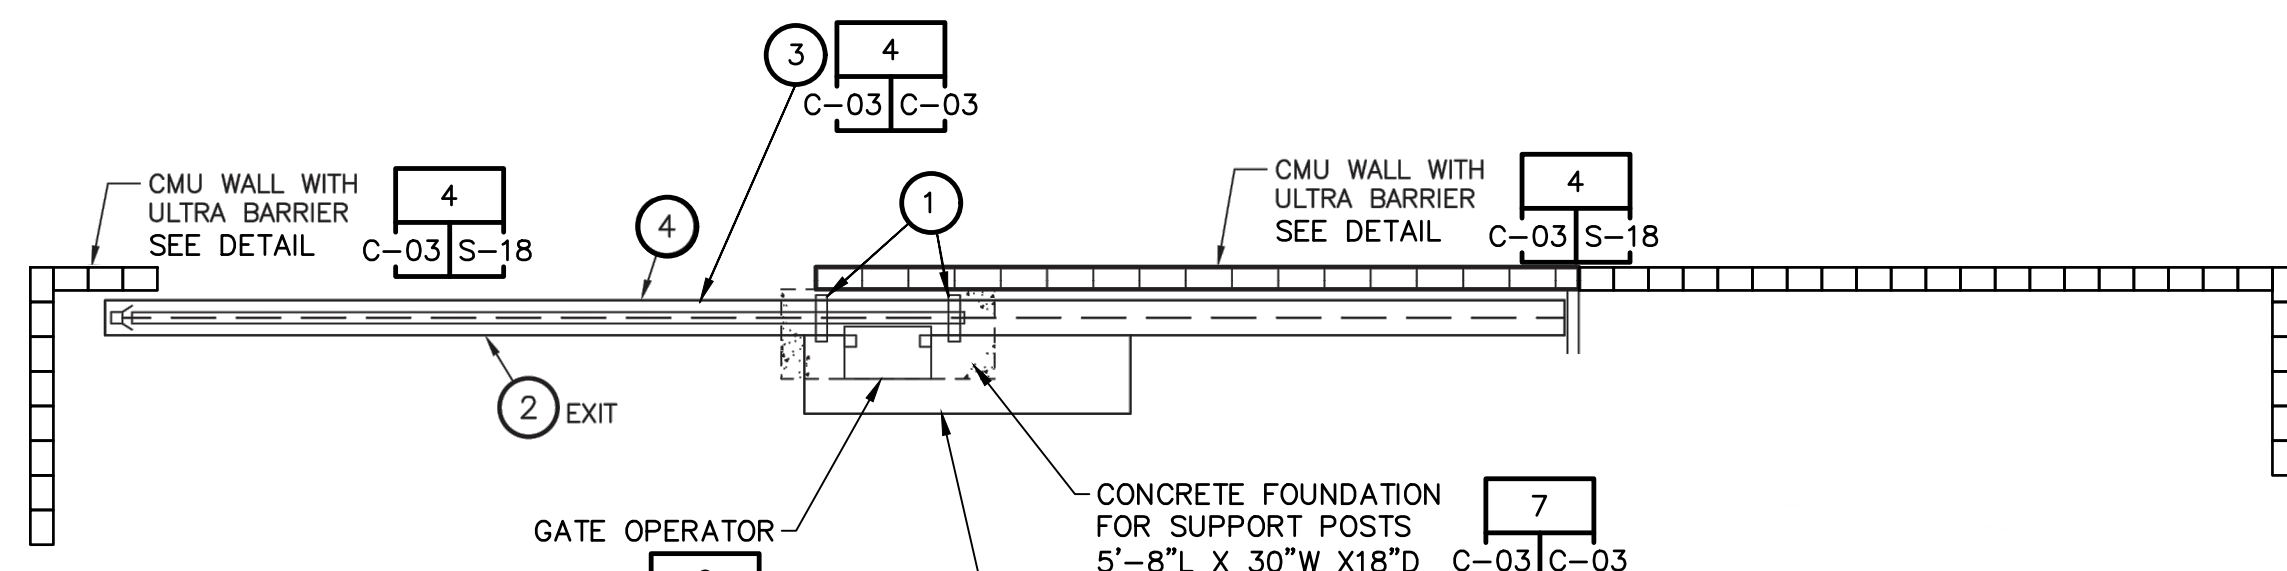


**GATE OPERATOR MOUNTAIN DETAIL (PLAN VIEW)**

**DETAIL 3**  
C-03 C-03  
NOT TO SCALE


CONTRACTOR SHALL FURNISH AND INSTALL ULTRA BARRIER STRIPS ON TOP CROSS MEMBER OF ROLLING GATES. STRIPS SHALL BE INSTALLED WEAVE IN AND OUT OF AMERISTAR IMPASSE PALES AND PER MANUFACTURER'S RECOMMENDATION. ULTRA BARRIER IS MANUFACTURED BY UNISEC INC. INFORMATION CAN BE FOUND AT THE FOLLOWING WEBSITE: WWW.ULTRABARRIER.COM OR PER DET. 18, SEE SHEET C-04

SECURE FENCE CROWN TO GATE FRAME USING A #8 BY 6, INCH SELF-TAPPING SCREW AND WASHER, PER DET. 8, THIS SHEET.

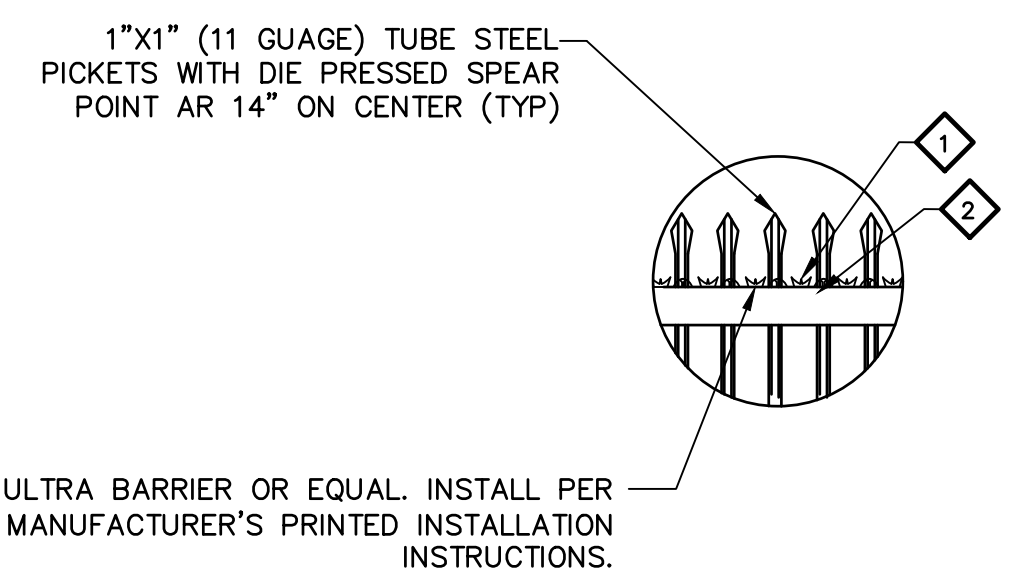

**ENLARGED VIEW**

ULTRA BARRIER OR EQUAL. INSTALL PER MANUFACTURER'S PRINTED INSTALLATION INSTRUCTIONS.

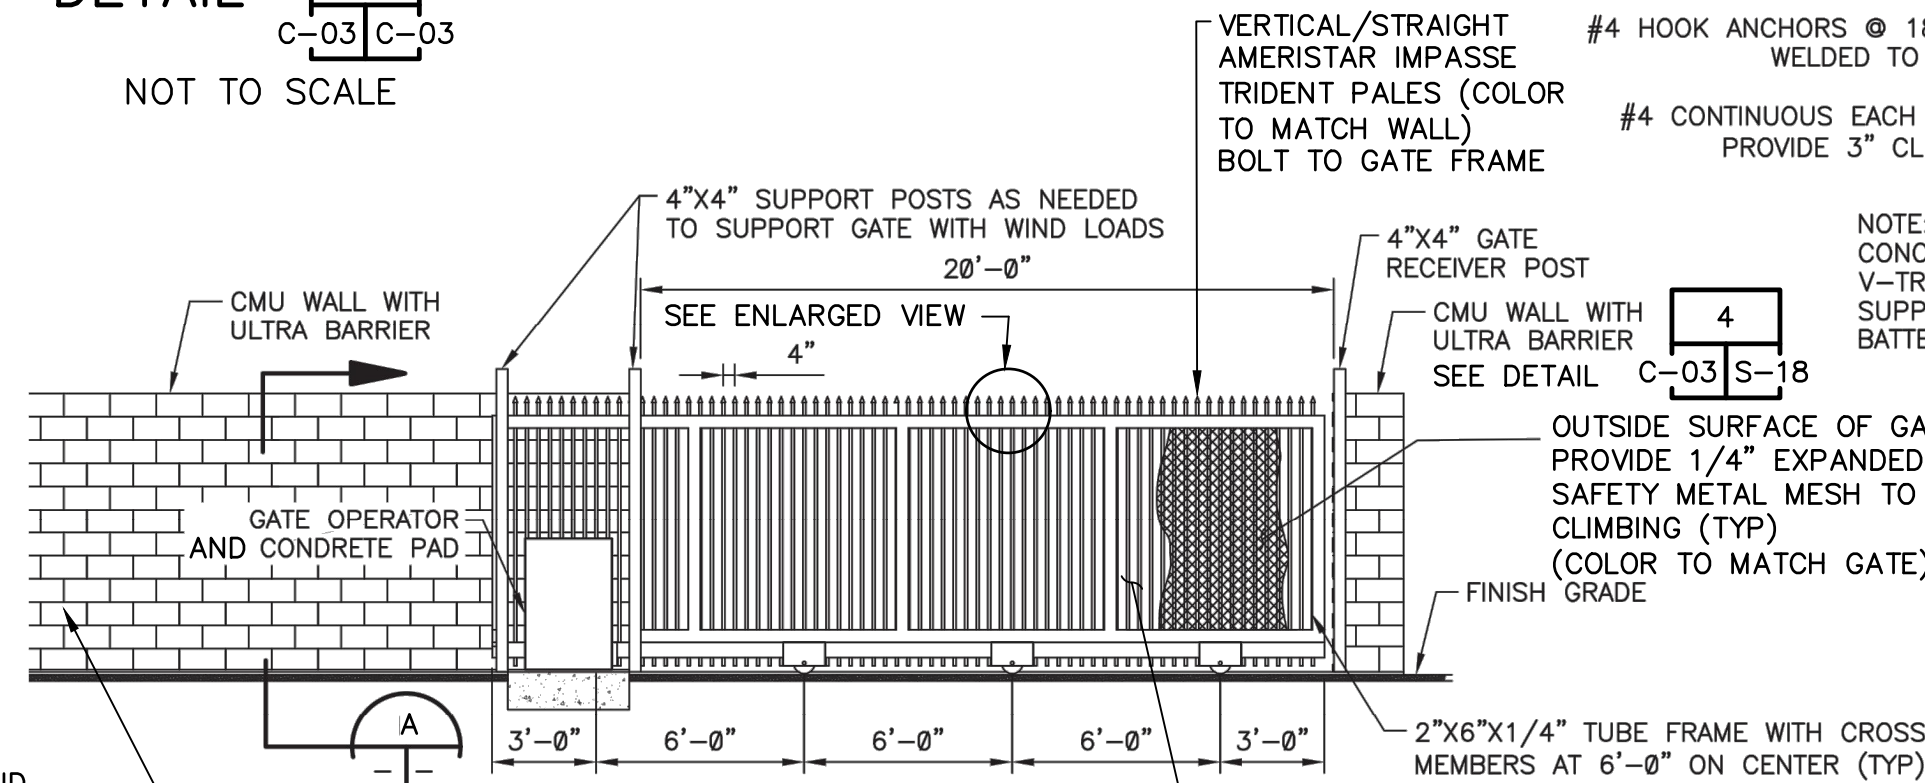


**ROLLING GATE DETAIL (LOOKING SOUTH)**

**DETAIL 6**  
C-03 C-03  
NOT TO SCALE

NOTE: 1. FURNISH AND INSTALL ELECTRICAL AND OPERATOR COMPONENTS WITHIN THE FACILITY LOOKING SOUTH FROM THE GATES.


CMU WALL SHALL BE PAINTED DESERT TAN (2153-50) AS MANUFACTURED BY BENJAMIN MOORE.

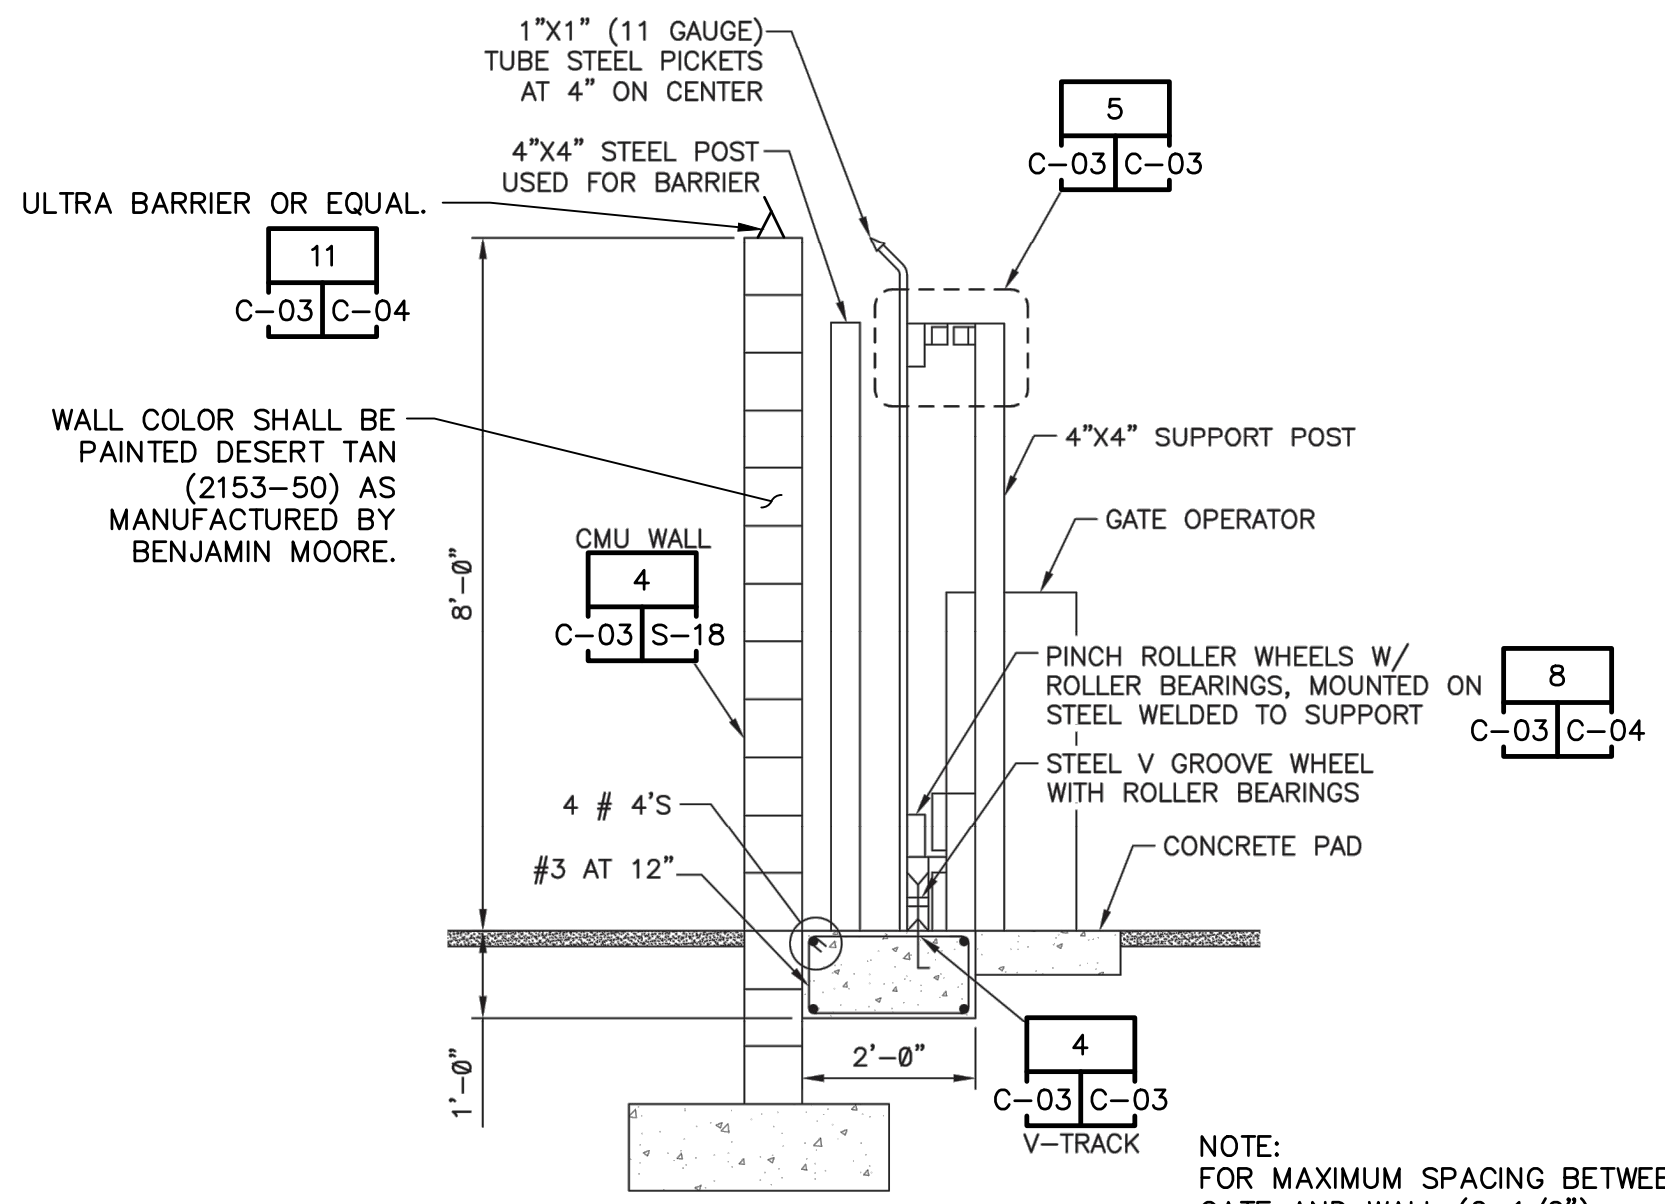

**ROLLING GATE SECTION**


**SECTION A**  
NOT TO SCALE

NOTE: FOR MAXIMUM SPACING BETWEEN GATE AND WALL (2-1/2")

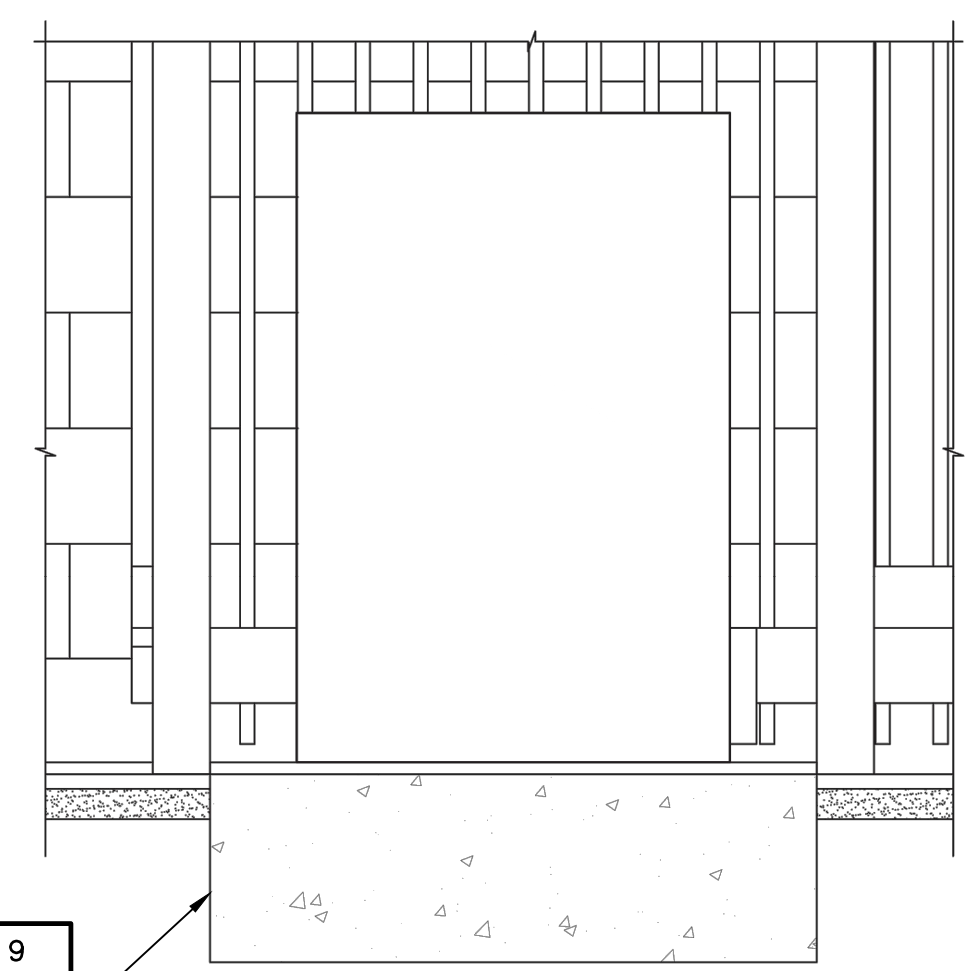

**GATE OPERATOR DETAIL**


**DETAIL 6**  
C-03 C-03  
NOT TO SCALE

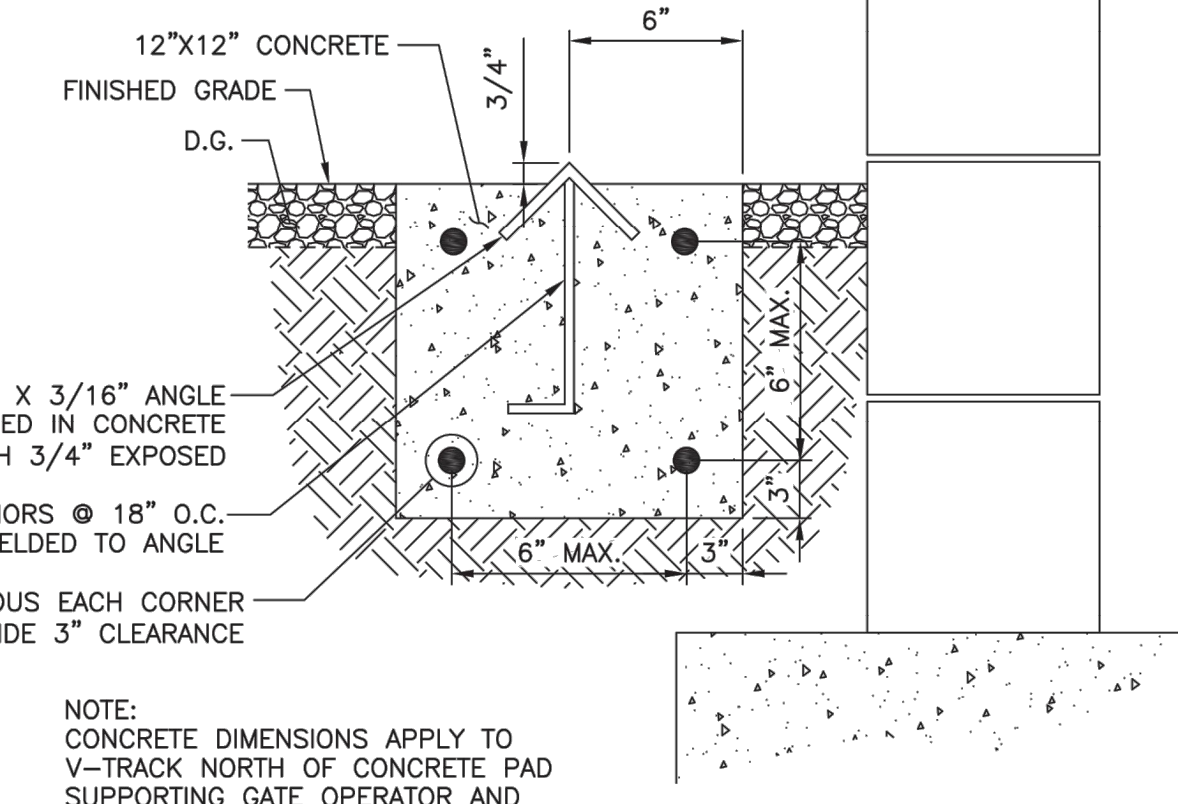

**V-TRACK DETAIL**

**DETAIL 4**  
C-03 C-03  
NOT TO SCALE


NOTE: CONCRETE DIMENSIONS APPLY TO V-TRACK NORTH OF CONCRETE PAD SUPPORTING GATE OPERATOR AND BATTERY BACKUP.

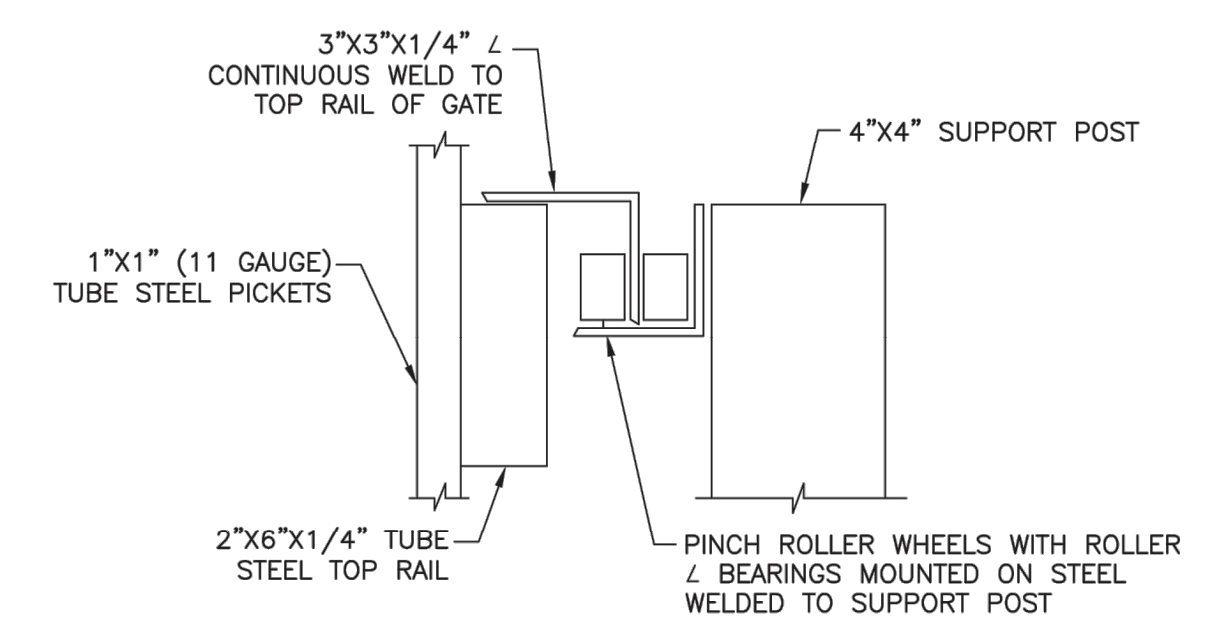

**DETAIL 5**

C-03 C-03  
NOT TO SCALE

NOTE: 1. 1"x11" PICKETS AND 2"x6" AND 4"x4" GATE MEMBERS SHALL HAVE PRESSED STEEL CAPS AT EACH END.

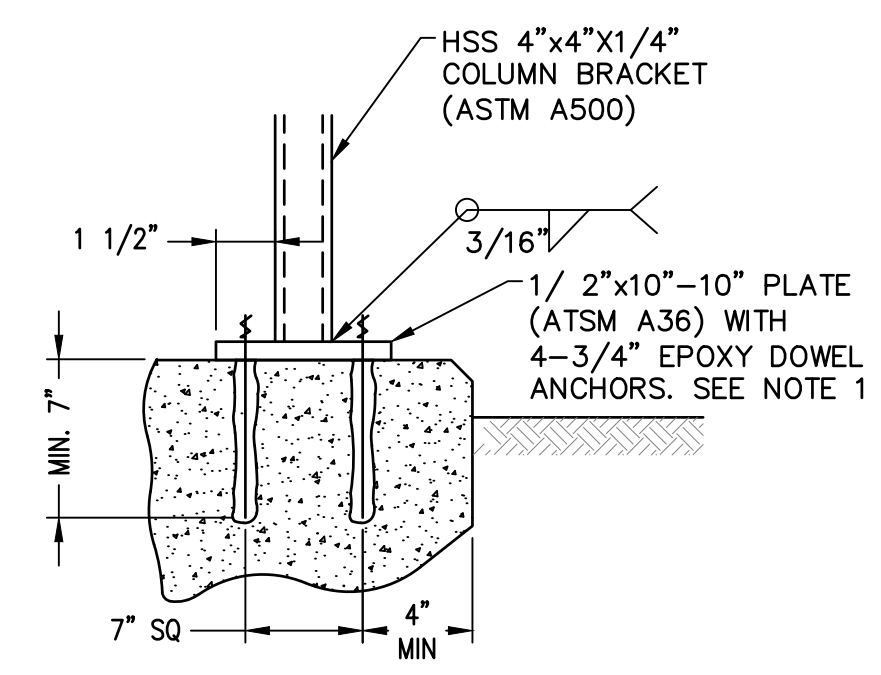

**SUPPORT POST PLATE**

**DETAIL 7**  
C-03 C-03  
NOT TO SCALE


NOTE: 1. INSTALL USING HILTI HIT-RE 500-SD EPOXY ANCHORING SYSTEM (OR APPROVED EQUAL) AND IN ACCORDANCE WITH MANUFACTURER'S RECOMMENDATIONS. DOWEL SHALL BE ASTM F593 CW2 (316) STAINLESS STEEL ALL-THREAD. ISOLATE DISSIMILAR METALS W/ SLEEVES AND WASHERS.

**NOTES:**


- 1 ROLLING GATE SUPPORT POST (SEE SECTION A THIS SHEET)
- 2 ROLLING GATE
- 3 V-TRACK
- 4 GATE SIGNAGE (SEE SHEET C-05)

FACILITY DRAWINGS  
This drawing was supplied by a Consultant Engineer from a past project. The City of Phoenix is not responsible for the accuracy of the information provided by the Contractor to provide the Record Drawing. The City does not warranty this drawing to be a complete and accurate portrayal of facilities as they exist in the field.

REVISION	DATE	PROJECT NAME	PROJECT NO.	PROJECT NAME	DATE	CAD FILE NAME	DWG NUMBER	REMARKS

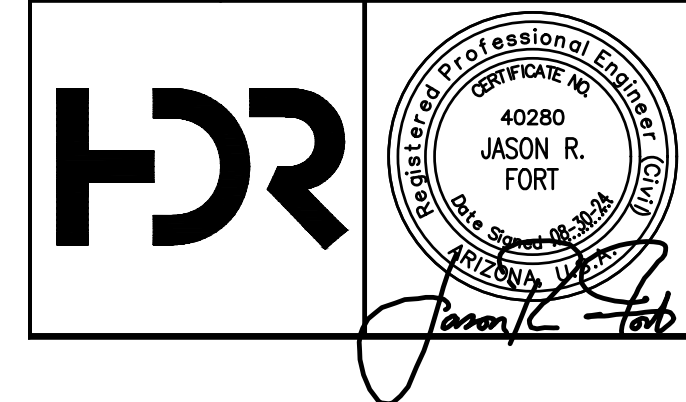

REVISIONS				
NO.	BY	DATE	CKD	REMARKS
A	RS	10/2023	JF	30% SUBMITTAL
B	RS	01/2024	JF	90% SUBMITTAL
C	RS	04/2024	JF	AGENCY REVIEW
D	DFD	08/2024	JF	ISSUED FOR CONSTRUCTION

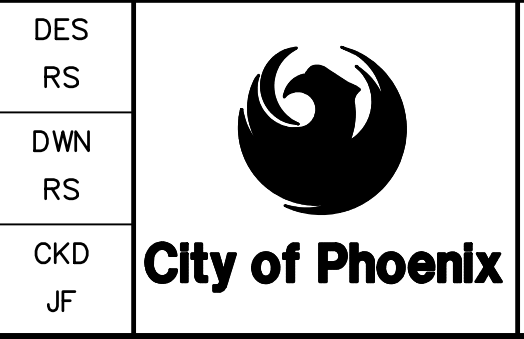

CITY OF PHOENIX  
WATER SERVICES DEPARTMENT

**LIFT STATION 40  
REFURBISHMENT**

CIVIL

GENERAL DETAILS 2

COPYRIGHT © 2007-JANUARY

CITY PROJECT NO. WS90400085

DATE: 08/2024

C-03 SHEET 8 OF 134

CAD FILE: CSCLS40D02.DWG


USER: FBERASR\AUD FILE: C:\pwworking\west01\03411640\08\_CSCLS40D02.dwg DATE: 9/04/24 TIME: 03:13pm



THIS DRAWING MUST BE FIELD VERIFIED BEFORE USE. DRAWING NOT TO SCALE UNLESS SCALE BAR IS PRESENT.


FOR CONSTRUCTION

"PER CITY OF PHOENIX CODE CHAPTER 2, SECTION 2-28, THESE PLANS ARE FOR OFFICIAL USE ONLY AND MAY NOT BE SHARED WITH OTHERS EXCEPT AS REQUIRED TO FULFILL THE OBLIGATIONS OF THE CONTRACTOR'S CONTRACT WITH THE CITY OF PHOENIX." THIS DOCUMENT MUST BE KEPT SECURE AT ALL TIMES.

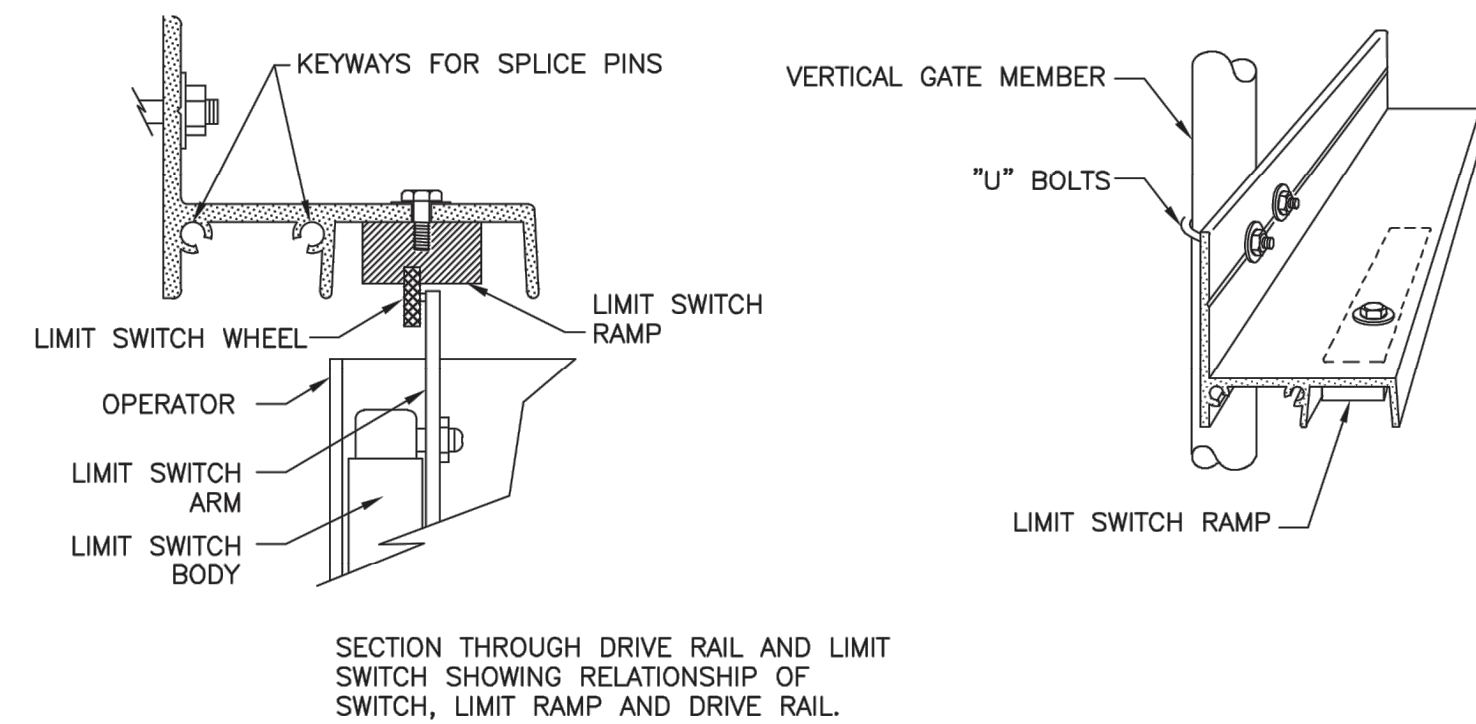


SECTION THROUGH DRIVE RAIL AND LIMIT SWITCH SHOWING RELATIONSHIP OF SWITCH, LIMIT RAMP AND DRIVE RAIL.

IN OPERATION, TAPERED ENDS, ALWAYS POINT SIDE VIEW OF LIMIT RAMP AND LIMIT SWITCH TOWARD THE OPERATOR DRIVE WHEELS.

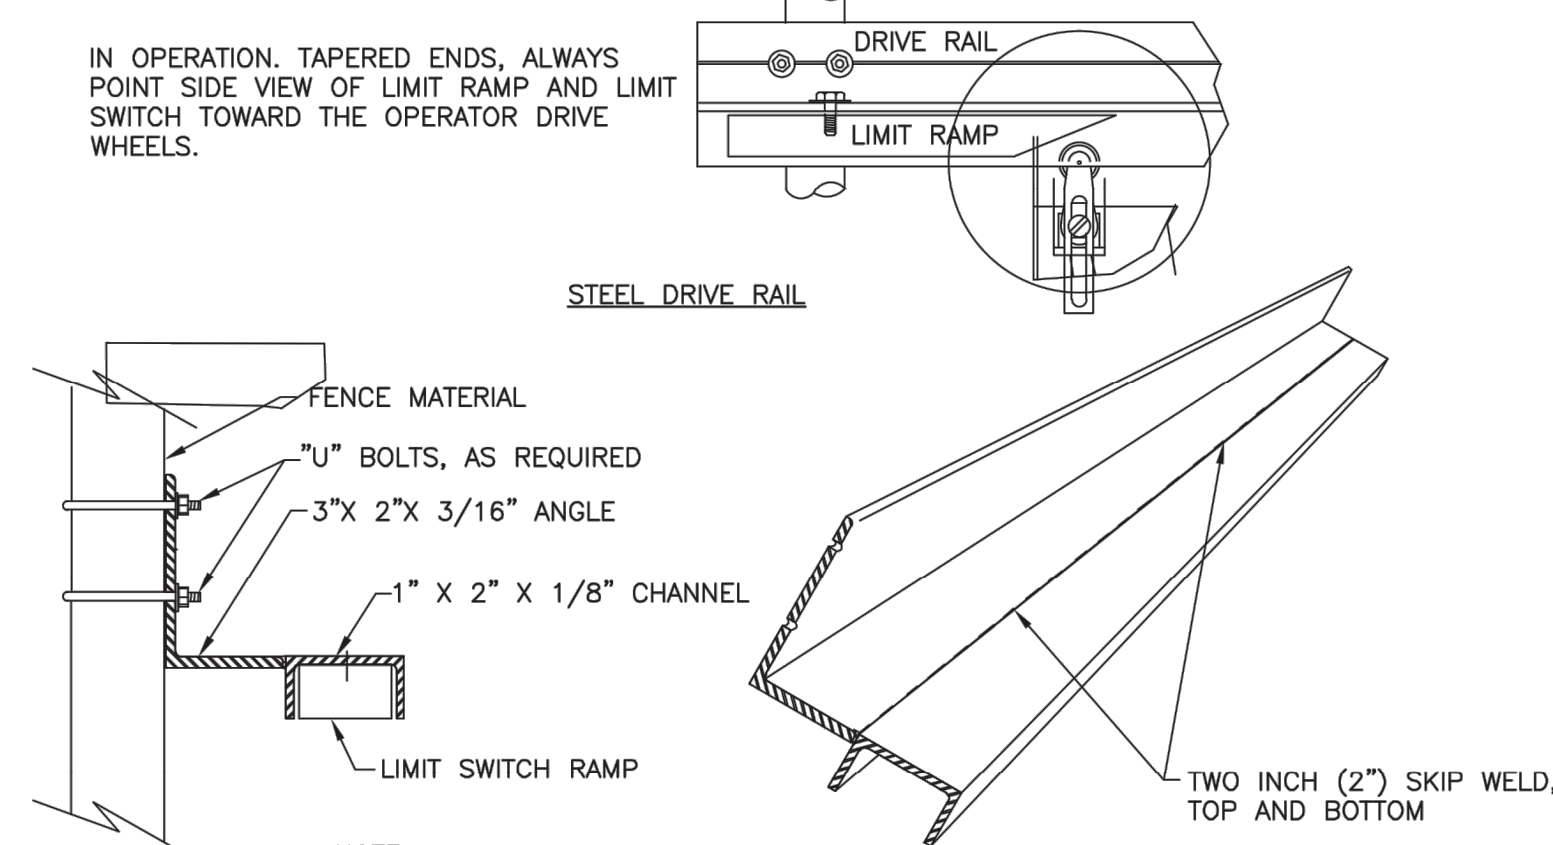

**DRIVE RAIL FOR SIDE GATE OPERATOR**

DETAIL 8  
C-03 C-04  
NOT TO SCALE

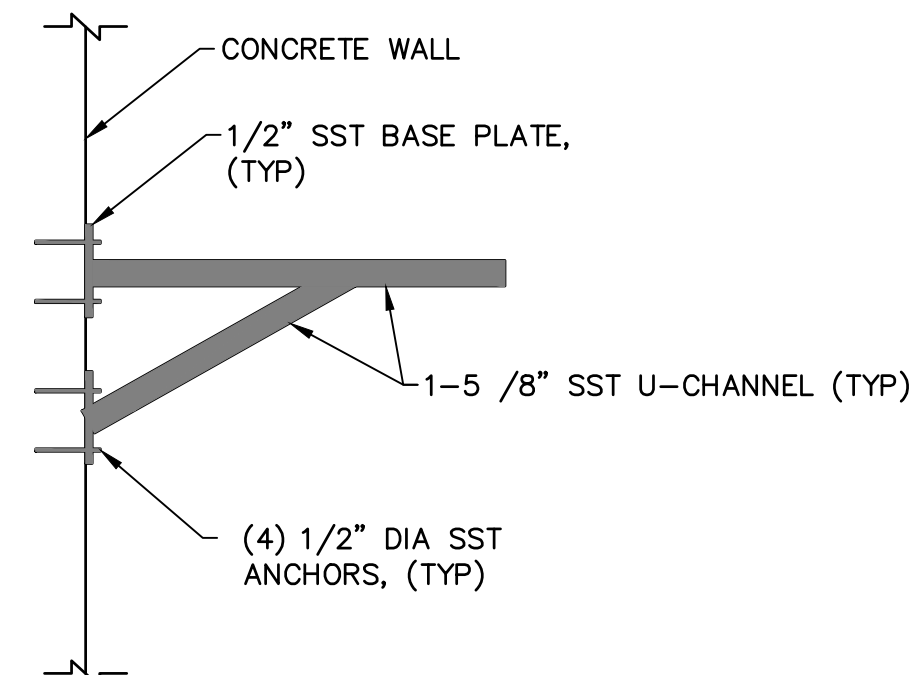


**WET-WELL LEVEL SENSOR SUPPORT DETAIL**

DETAIL 12  
C-04 C-04  
NOT TO SCALE


- NOTES**
- 1 1/4" EXPANDED METAL SAFETY MESH (COLOR TO MATCH GATE FRAME AND PALES, 16 GAUGE MESH SHALL COVER ENTIRE GATE LENGTH)
  - 2 AMERISTAR IMPASSE TRIDENT PALES AT 4 INCHES

**MAN GATE DETAIL**  
DETAIL 13  
C-04 C-04  
NOT TO SCALE

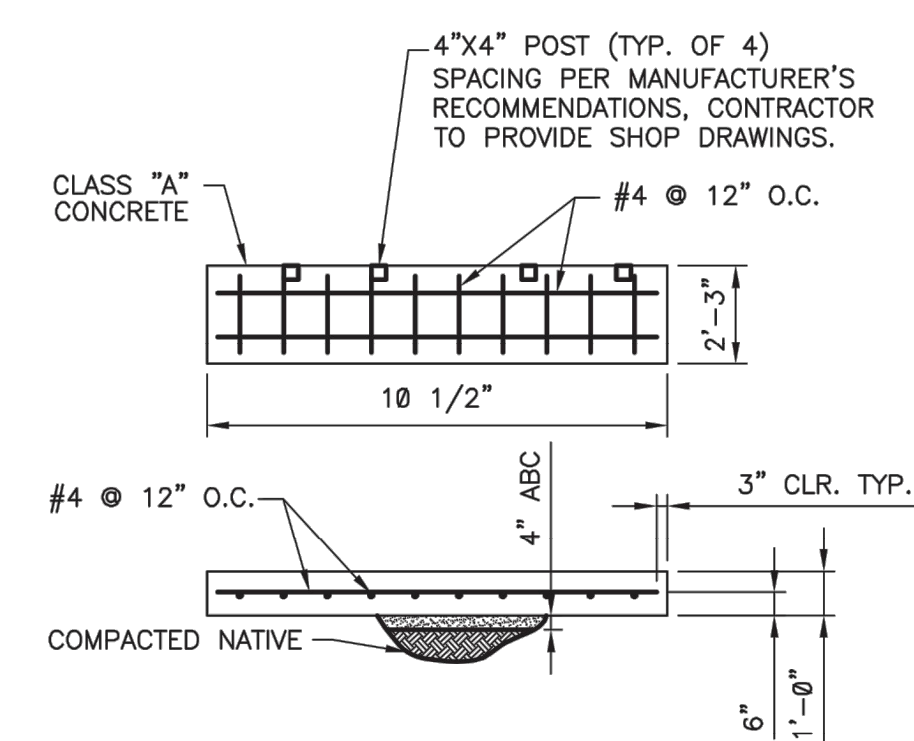


**GATE OPERATOR PAD**

DETAIL 9  
C-03 C-04  
SCALE = 1/4" = 1'-0"

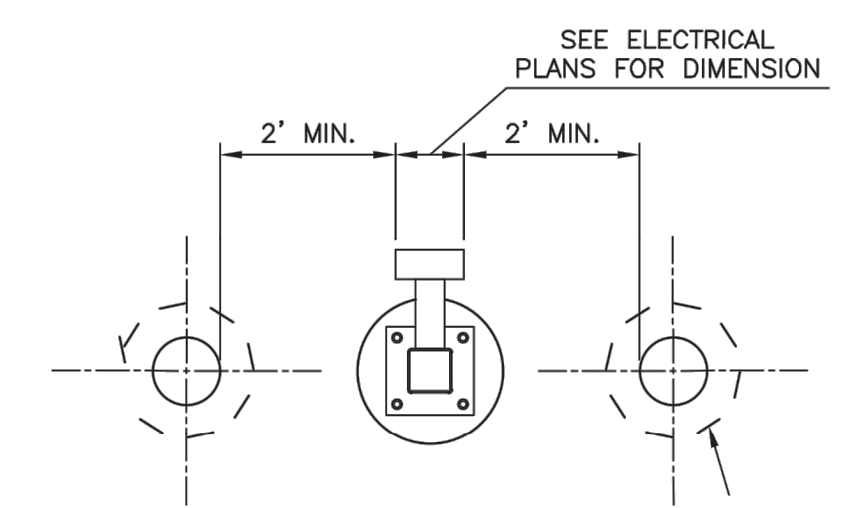

**BOLLARD LOCATION AND CARD READER**


DETAIL 10  
C-03 C-04  
SCALE = 1/4" = 1'-0"

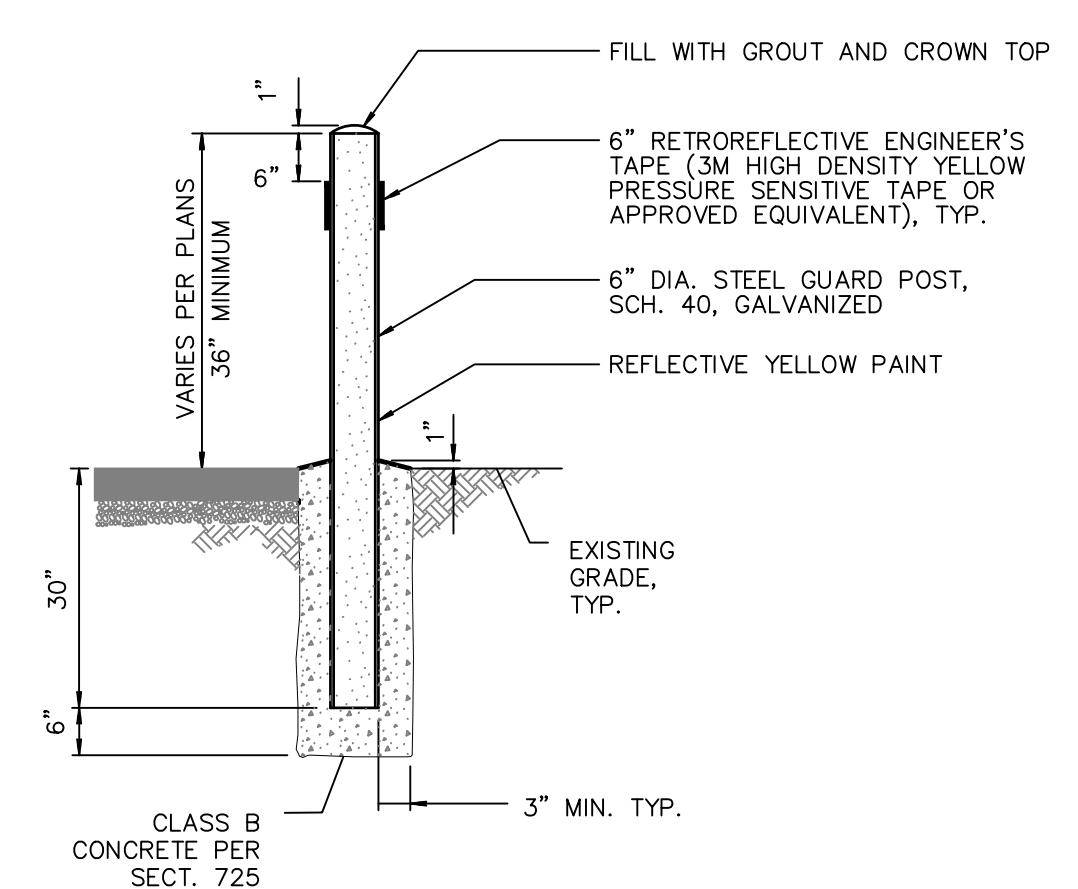

**PERMANENT BOLLARD**

DETAIL 14  
C-03 C-04  
NOT TO SCALE


- NOTES**
- BOLLARDS SHALL HAVE A HEIGHT OF 3 FEET. POSTS SHALL BE PLACED A MINIMUM OF 4" FROM THE WALL.
  - REMOVABLE POSTS SHALL HAVE 1" DIA. HOLES DRILLED THROUGH AT A DISTANCE 1/5 THE OVERALL POST LENGTH FROM TOP.
  - REMOVABLE POST - GRIND SMOOTH ALL SHARP EDGES PRIOR TO GALVANIZATION. GALVANIZE PER ASTM A54 AFTER FABRICATION.

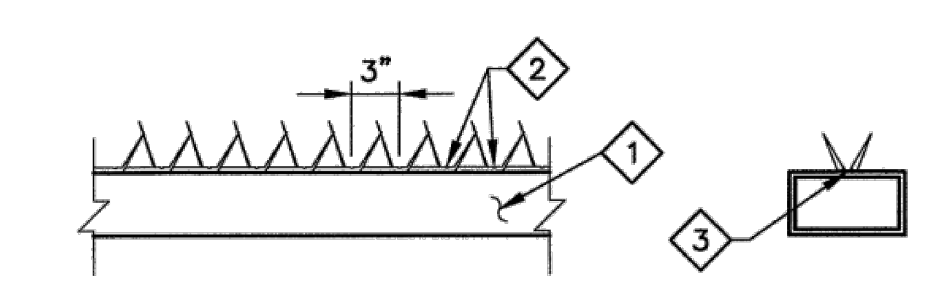

- NOTES**
- 1 GATE FRAME.
  - 2 MOUNTING SLOTS EVERY 3".
  - 3 OVERLAP ULTRA-BARRIER STRIPS AND SECURELY FASTEN, APPROXIMATELY EVERY 12" USING A ZINC CHROMATE SHEET METAL SCREW AND WASHER. (PAN HEAD #8 BY 1 INCH)


**ULTRA-BARRIER MOUNTING DETAILS FOR GATE FRAME**

DETAIL 11  
C-03 C-04  
NOT TO SCALE

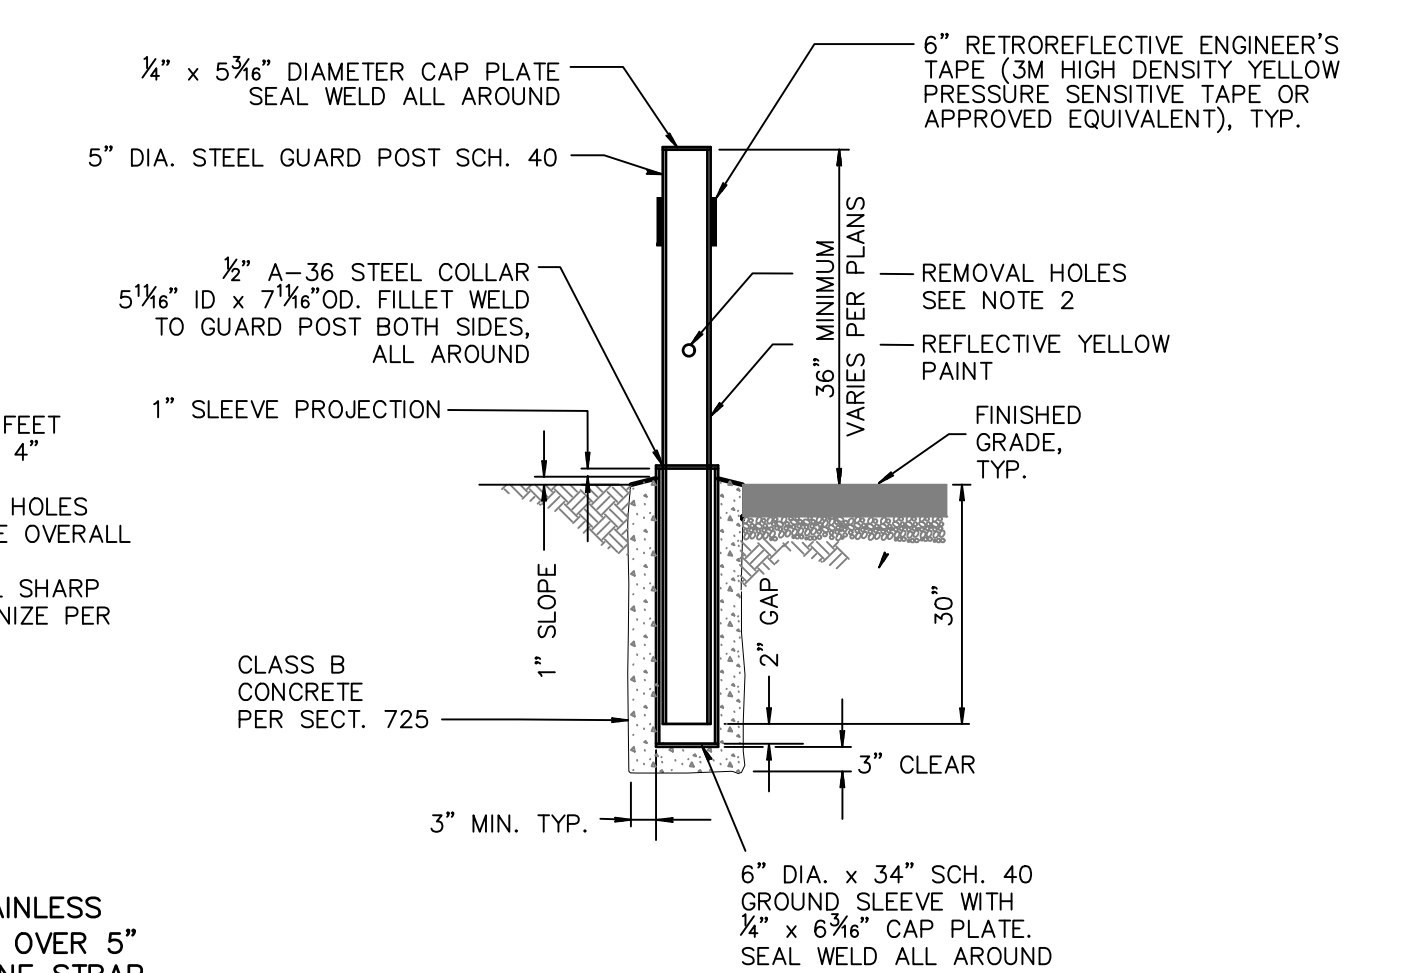


**REMOVABLE BOLLARD**

DETAIL 15  
C-03 C-04  
NOT TO SCALE

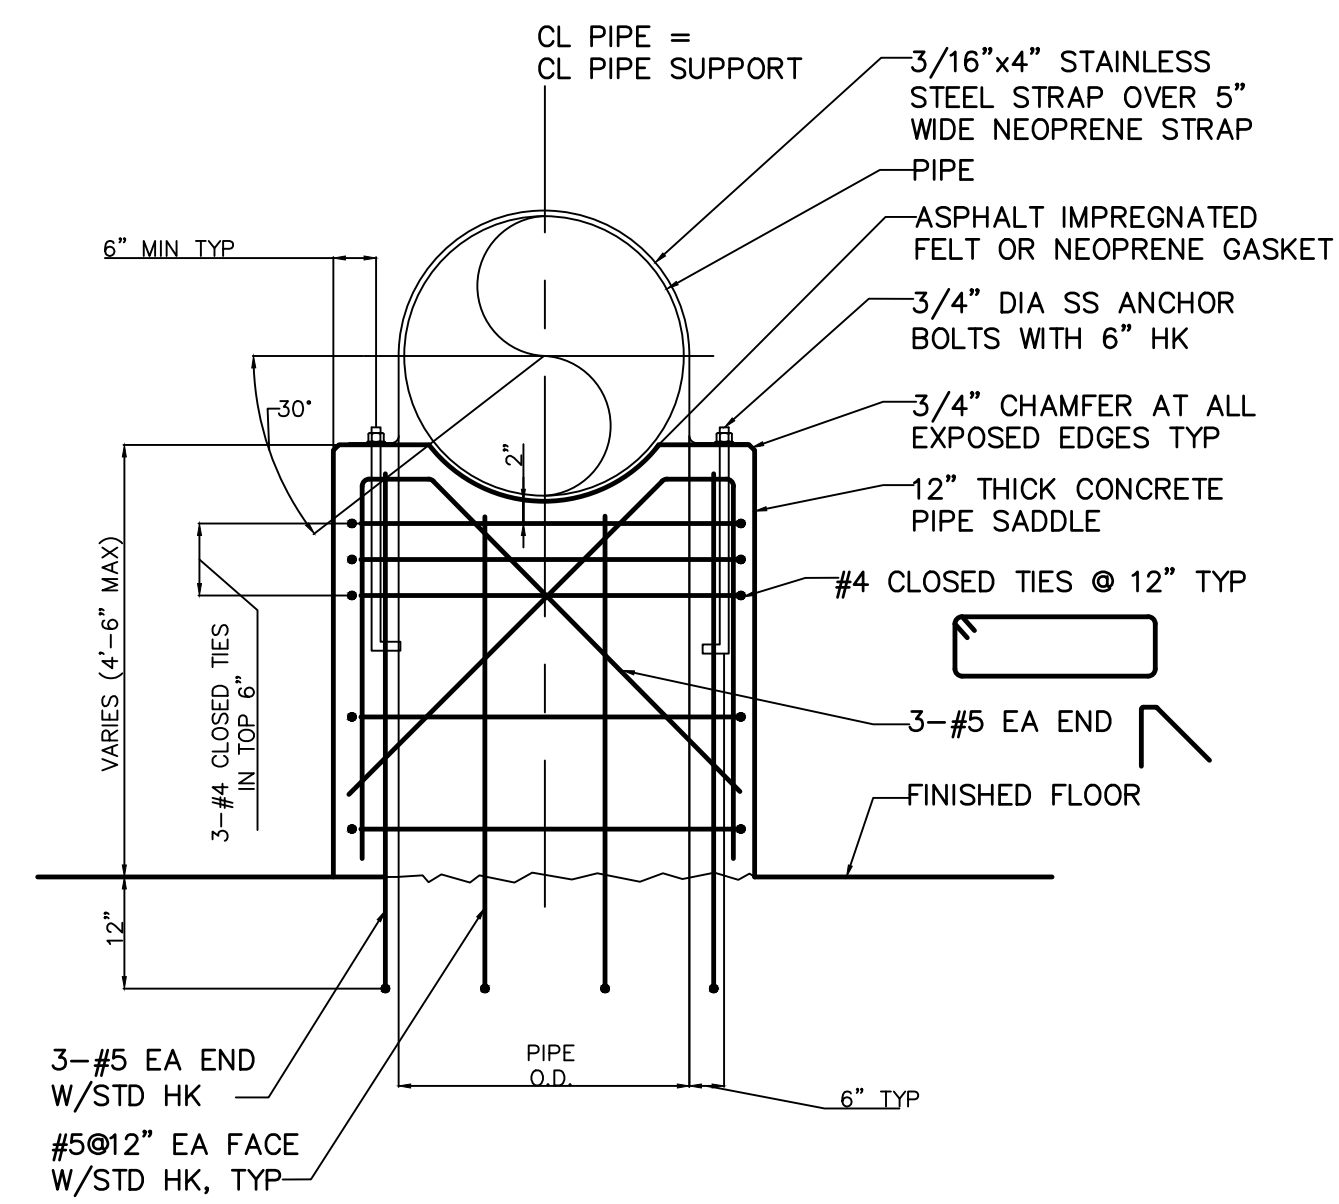


**CONCRETE PEDESTAL SUPPORT**

DETAIL 16  
C-04 C-04  
NOT TO SCALE

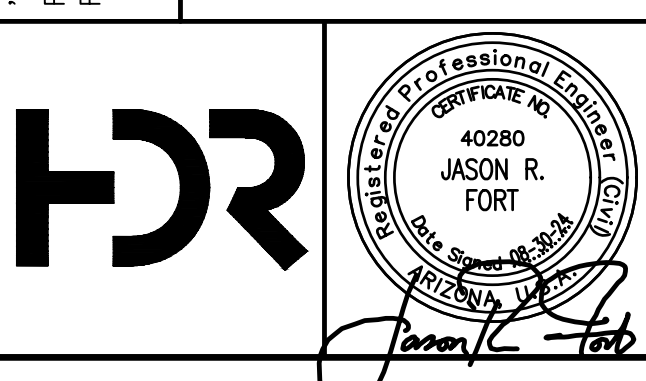

NO.	BY	DATE	CKD	REVISIONS	REMARKS
A	RS	10/2023	JF	30% SUBMITTAL	
B	RS	01/2024	JF	90% SUBMITTAL	
C	RS	04/2024	JF	AGENCY REVIEW	
D	DFD	08/2024	JF	ISSUED FOR CONSTRUCTION	
*					
*					
*					

DES	REVISIONS	REMARKS
RS		
DWN		
RS		
CKD		
JF		

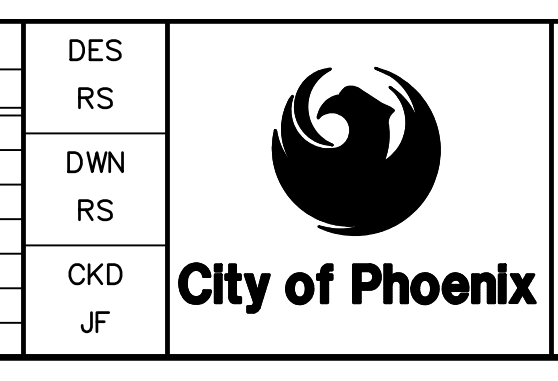

CITY OF PHOENIX  
WATER SERVICES DEPARTMENT  
  
LIFT STATION 40  
REFURBISHMENT

CIVIL  
  
GENERAL DETAILS 3

COPYRIGHT © 2007-JANUARY  
CITY PROJECT NO. WS90400085  
DATE: 08/2024  
C-04 SHEET 9 OF 134  
CAD FILE: CSCLS40D03.DWG

FOR CITY OF PHOENIX USE ONLY - REFERENCE CID NUMBER: #	DATE	CAD FILE NAME	DWG NUMBER	REMARKS
REVISION ENGINEERING COMPANY				
PROJECT NO.				
PROJECT NAME				
#				
#				

USER: FBERASR\AUD FILE: C:\pwworking\west01\33411840\09\_CSCLS40D03.dwg DATE: 9/04/24 TIME: 03:13pm

THIS DRAWING MUST BE FIELD VERIFIED BEFORE USE  
DRAWING NOT TO SCALE UNLESS SCALE BAR IS PRESENT

FOR CONSTRUCTION

"PER CITY OF PHOENIX CODE CHAPTER 2, SECTION 2-28, THESE PLANS ARE FOR OFFICIAL USE ONLY AND MAY NOT BE SHARED WITH OTHERS EXCEPT AS REQUIRED TO FULFILL THE OBLIGATIONS OF THE CONTRACTOR'S CONTRACT WITH THE CITY OF PHOENIX."  
THIS DOCUMENT MUST BE KEPT SECURE AT ALL TIMES.



"NO TRESPASSING" SIGN LAYOUT



SAFETY FIRST SIGN



EXIT ONLY SIGN



EXIT ONLY SIGN



FIRE LANE SIGN




FACILITY IDENTIFICATION SIGN



- NOTES:
1. THE SIGN (FACE) SHALL BE 24" WIDE AND FABRICATED FROM 3003 ALUMINUM SHEET WITH 1/16" THICK CORNERS.
  2. LETTERS 1 1/4" X 1/4" STROKE, FONT STYLE USED IS MARTEL GOTHIC CAPITAL FONT.
  3. THE SIGN FACE SHALL HAVE A WHITE BUILT-UP FINISH OR AN ALUMINUM REFLECTIVE FINISH OR 400 GRADE OR EQUIVALENT FINISH TO A BACKGROUND OF PLUMBER PLATE.
  4. LETTERING/GRAPHICS SHALL BE ONE OF THE FOLLOWING:
    - A. 3M 5000L LITE ADHESIVE, TRANSPARENT, ELECTROSTATIC OUTTABLE FINISHED (100 SERIES REFLECTIVE CO) TO ALLOW WHITE REFLECTIVE BACKGROUND TO SHOW THROUGH.
    - B. SIZES 4000 SERIES TO 4000 OR 8000-80 SERIES TRAFFIC SIGN RED WITH PROCESSED IN OR IN W/ALUMINUM 4 RED FIELD WHITE COPY.
  5. ALL SIGN MOUNTING SHALL BE IN COMPLIANCE WITH THE REFLECTIVE SHEETING MANUFACTURER'S MOUNTING SYSTEM.
  6. REQUIRED PER APPROVAL BY THE PHOENIX EMERGENCY ACCESS OFFICER.
- PHOENIX FIRE DEPARTMENT ACCESS SIGN

FACILITY IDENTIFICATION SIGN

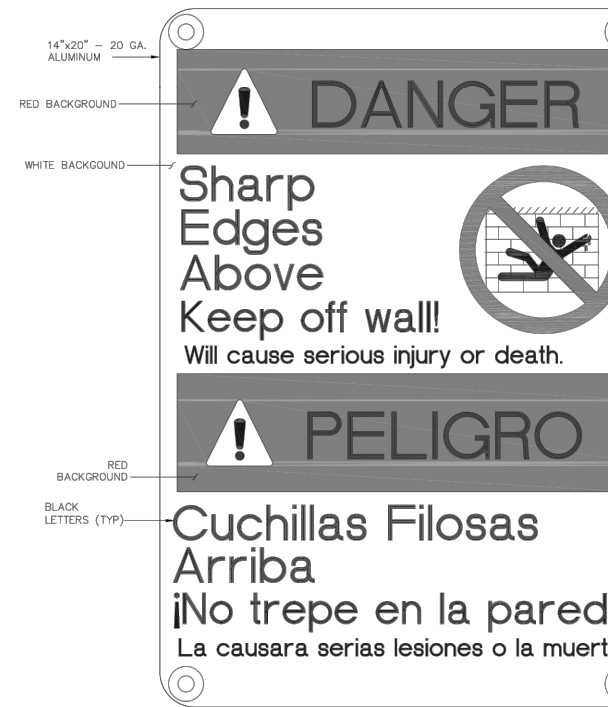

- NOTES:
1. 1/2" X 1/2" X 1/2" BORDER, WHITE ON WHITE.
  - RECTANGLE RED: [BORDER] BLACK C 50% SPACING, [BORDER] BLACK C 50% SPACING, [BORDER] BLACK C 50% SPACING, [BORDER] BLACK C 50% SPACING.
  - RECTANGLE RED: [BORDER] BLACK C 50% SPACING, [BORDER] BLACK C 50% SPACING, [BORDER] BLACK C 50% SPACING, [BORDER] BLACK C 50% SPACING.
  - RECTANGLE RED: [BORDER] BLACK C 50% SPACING, [BORDER] BLACK C 50% SPACING, [BORDER] BLACK C 50% SPACING, [BORDER] BLACK C 50% SPACING.
  - [BORDER] BLACK C 50% SPACING, [BORDER] BLACK C 50% SPACING, [BORDER] BLACK C 50% SPACING, [BORDER] BLACK C 50% SPACING.
  - [BORDER] BLACK C 50% SPACING, [BORDER] BLACK C 50% SPACING, [BORDER] BLACK C 50% SPACING, [BORDER] BLACK C 50% SPACING.
- DANGER SIGN LAYOUT

DANGER SIGN LAYOUT

DETAIL 19 C-03 C-04 NOT TO SCALE

DETAIL 20 C-03 C-04 NOT TO SCALE


DETAIL 21 C-03 C-04 NOT TO SCALE

DETAIL 22 C-03 C-04 NOT TO SCALE


DETAIL 23 C-03 C-04 NOT TO SCALE

DETAIL 24 C-03 C-04 NOT TO SCALE

DETAIL 25 C-03 C-04 NOT TO SCALE

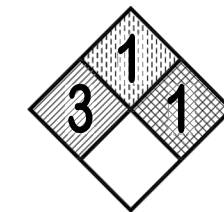


FERROUS CHLORIDE TANK NO. 1 7,800 GAL. MAX.

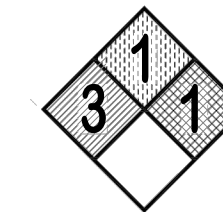


FERROUS CHLORIDE TANK NO. 2 7,800 GAL. MAX.

DETAIL 26 C-03 C-04 NOT TO SCALE

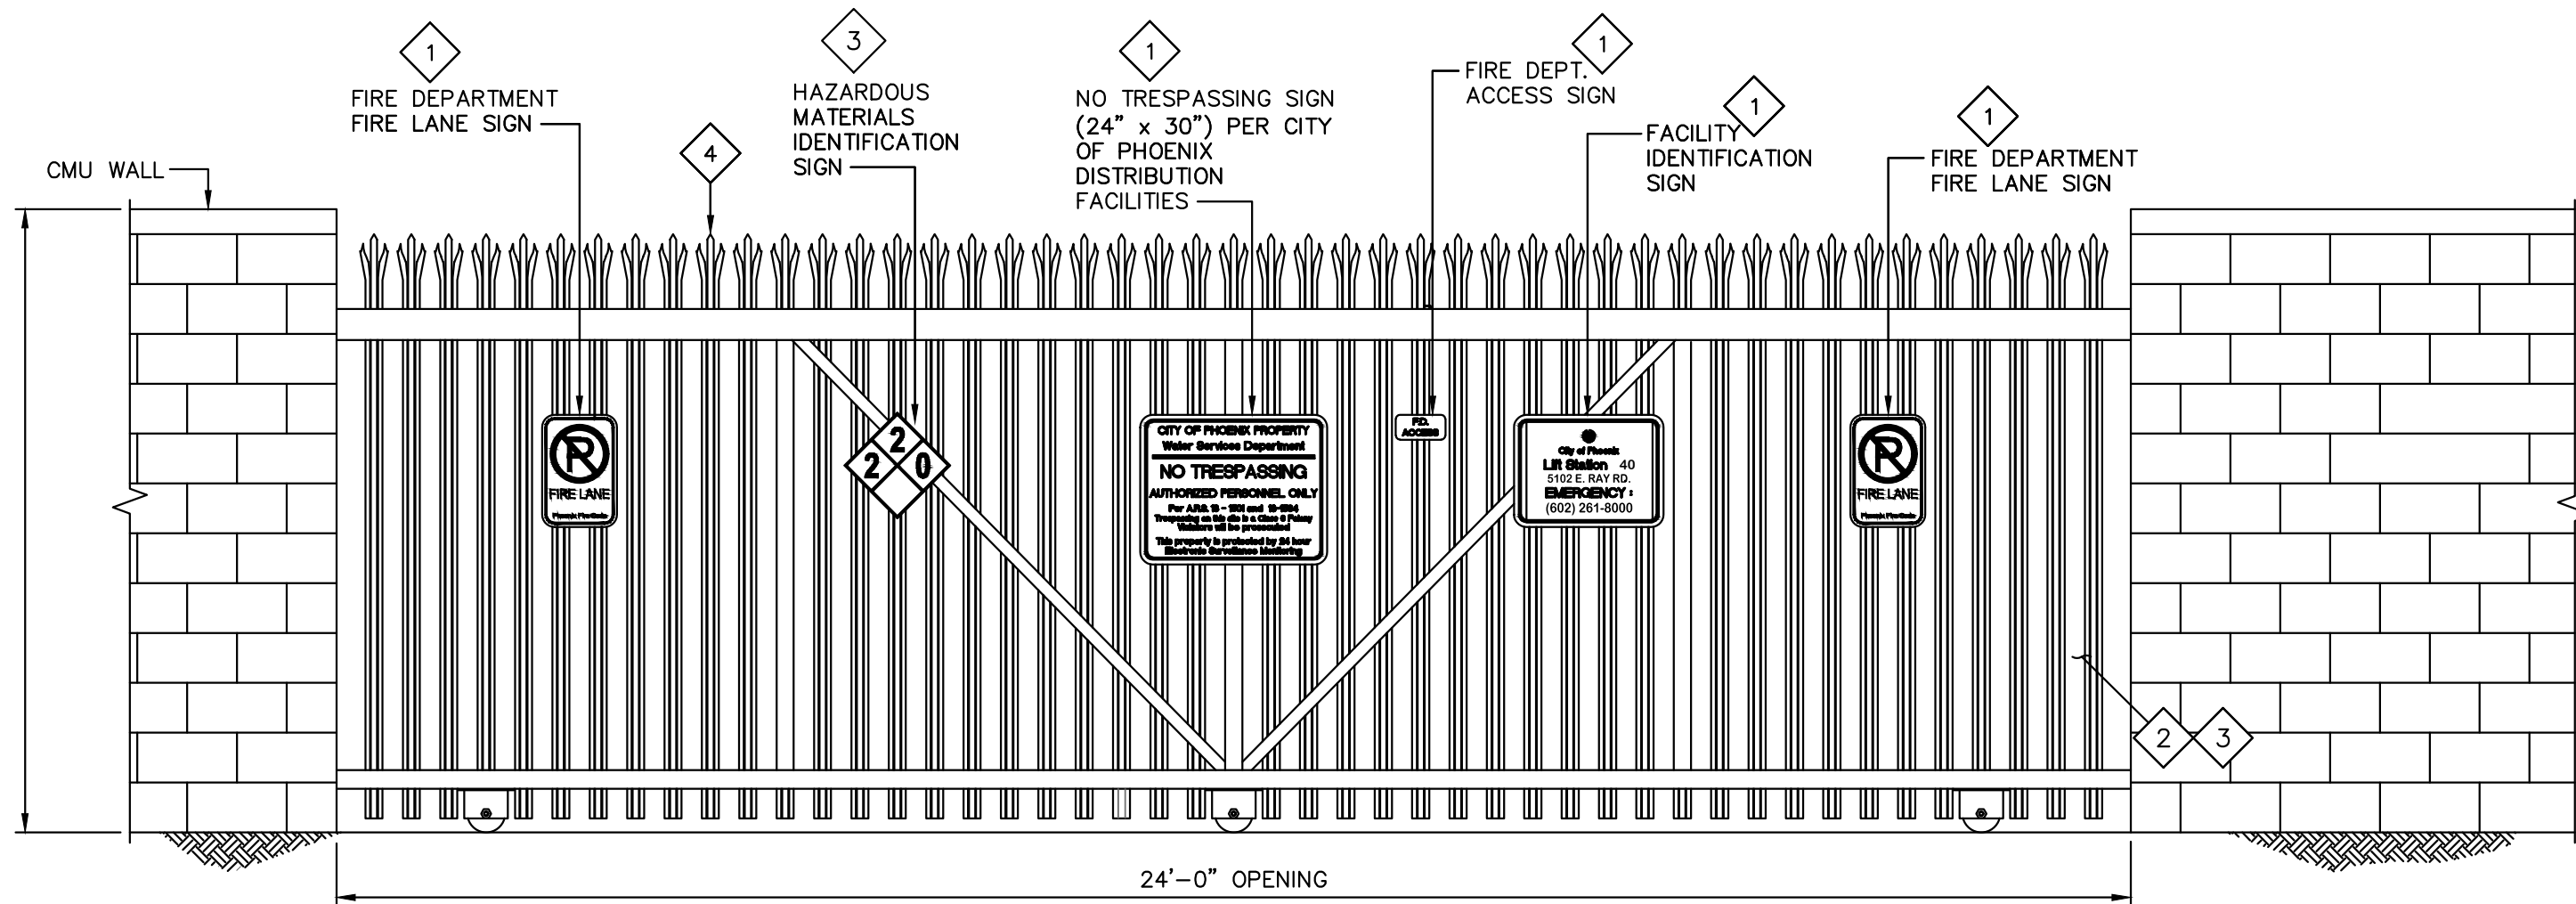

GATE SIGN ELEVATION STREET SIDE (LOOKING NORTH)

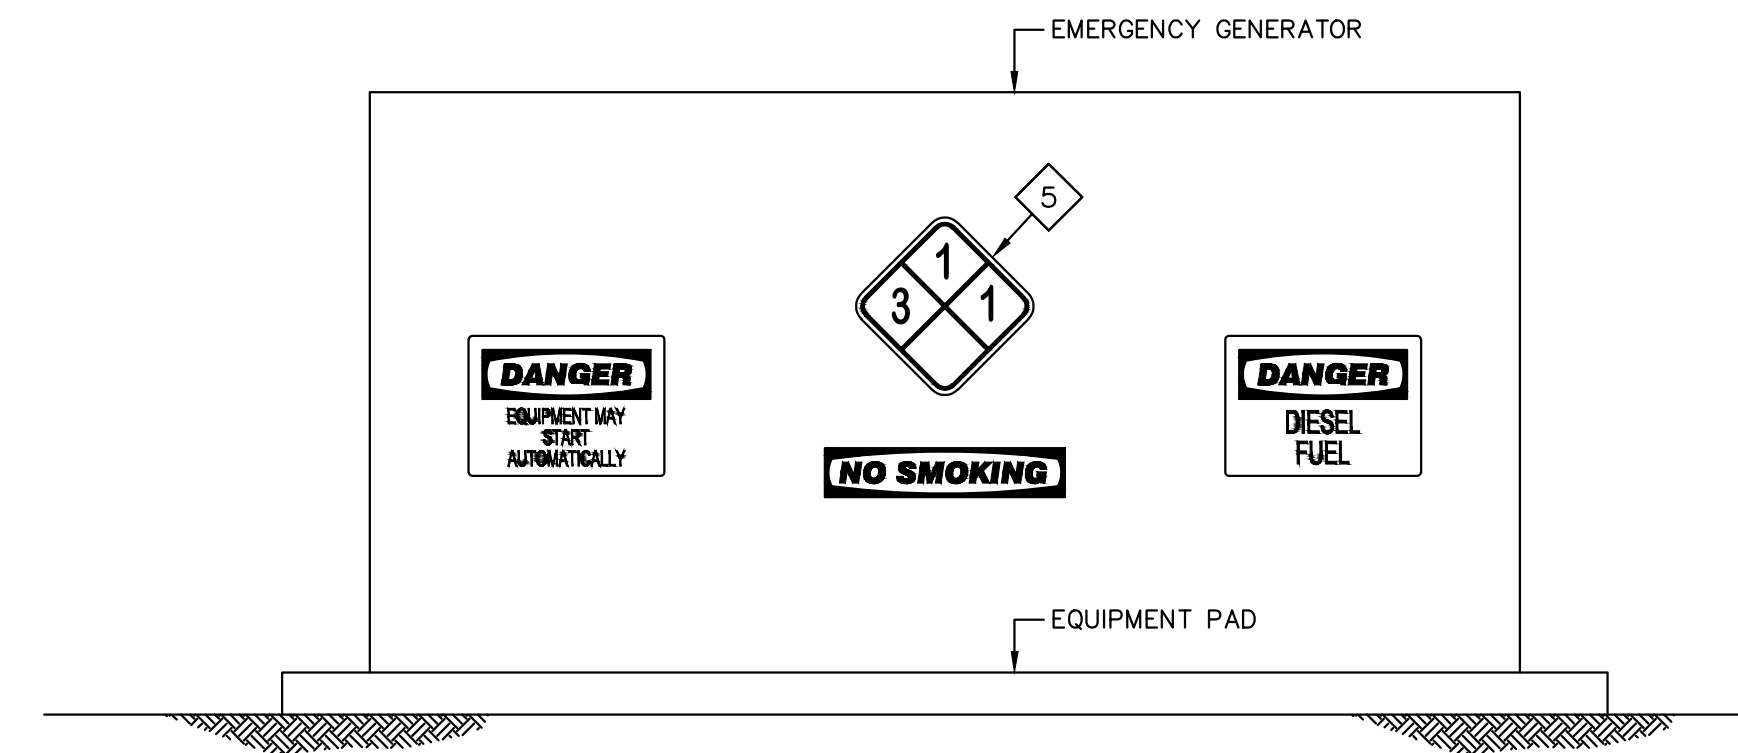

EMERGENCY GENERATOR ELEVATION

N.T.S.

KEY NOTES


1. INSTALL REQUIRED SIGNS PER CITY OF PHOENIX FIRE DEPARTMENT EMERGENCY APPROVED DETAILS (TYP).
2. SIGNS SHOWN ON ENTRANCE GATE ARE APPROXIMATE LOCATION (TO BE VERIFIED) (TYP).
3. SEE THIS SHEET AND C-06 FOR SIGN DETAILS.
4. THE SOUTH 2 GATES ARE MOTOR OPERATED ROLLING GATE WITH KEY PAD.

CONSTRUCTION NOTE:

CONTRACTOR SHALL SUBMIT ALL FIRE ITEMS (ACCESS GATES AND FIRE DEPARTMENT ACCESS) TO PROOF OF DELIVERY AS A DEFERRED SUBMITTAL FOR APPROVAL PRIOR TO FABRICATION AND INSTALLATION.


FACILITY DRAWINGS  
This drawing was supplied by a Consultant Engineer from a permit construction information provided by the Contractor to provide the Record Drawing. The City does not warrant this drawing to be a complete and accurate portrayal of facilities as they exist in the field.

FOR CITY OF PHOENIX USE ONLY - REFERENCE CID NUMBER: #	PROJECT NAME	DATE	CAD FILE NAME	DWG NUMBER	REMARKS

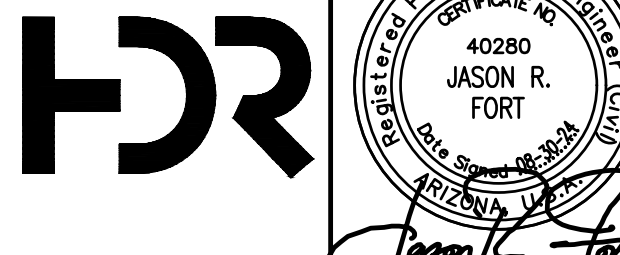

NO.	BY	DATE	CKD	REVISIONS	REMARKS
A	RS	10/2023	JF	30% SUBMITTAL	
B	RS	01/2024	JF	90% SUBMITTAL	
C	RS	04/2024	JF	AGENCY REVIEW	
D	FD	08/2024	JF	ISSUED FOR CONSTRUCTION	

DES	RS	DWN	RS	CKD	JF

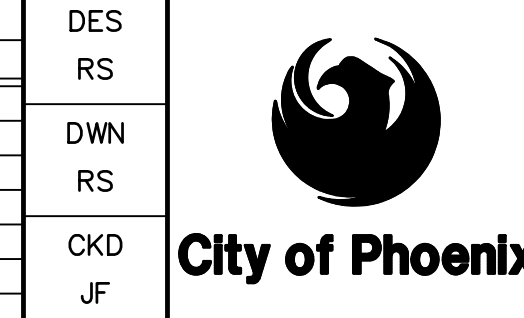

CITY OF PHOENIX WATER SERVICES DEPARTMENT  
LIFT STATION 40 REFURBISHMENT

CIVIL  
GENERAL DETAILS 4


COPYRIGHT © 2007-JANUARY  
CITY PROJECT NO. WS90400085  
DATE: 08/2024  
C-05 SHEET 10 OF 134  
CAD FILE: CSCLS40D04.DWG

USER: FBERASRAUD FILE: C:\pwworking\west01\03411940\10\_CSCLS40D04.dwg DATE: 08/24/24 TIME: 03:17pm

THIS DRAWING MUST BE FIELD VERIFIED BEFORE USE. DRAWING NOT TO SCALE UNLESS SCALE BAR IS PRESENT.

FOR CONSTRUCTION

"PER CITY OF PHOENIX CODE CHAPTER 2, SECTION 2-28, THESE PLANS ARE FOR OFFICIAL USE ONLY AND MAY NOT BE SHARED WITH OTHERS EXCEPT AS REQUIRED TO FULFILL THE OBLIGATIONS OF THE CONTRACTOR'S CONTRACT WITH THE CITY OF PHOENIX." THIS DOCUMENT MUST BE KEPT SECURE AT ALL TIMES.

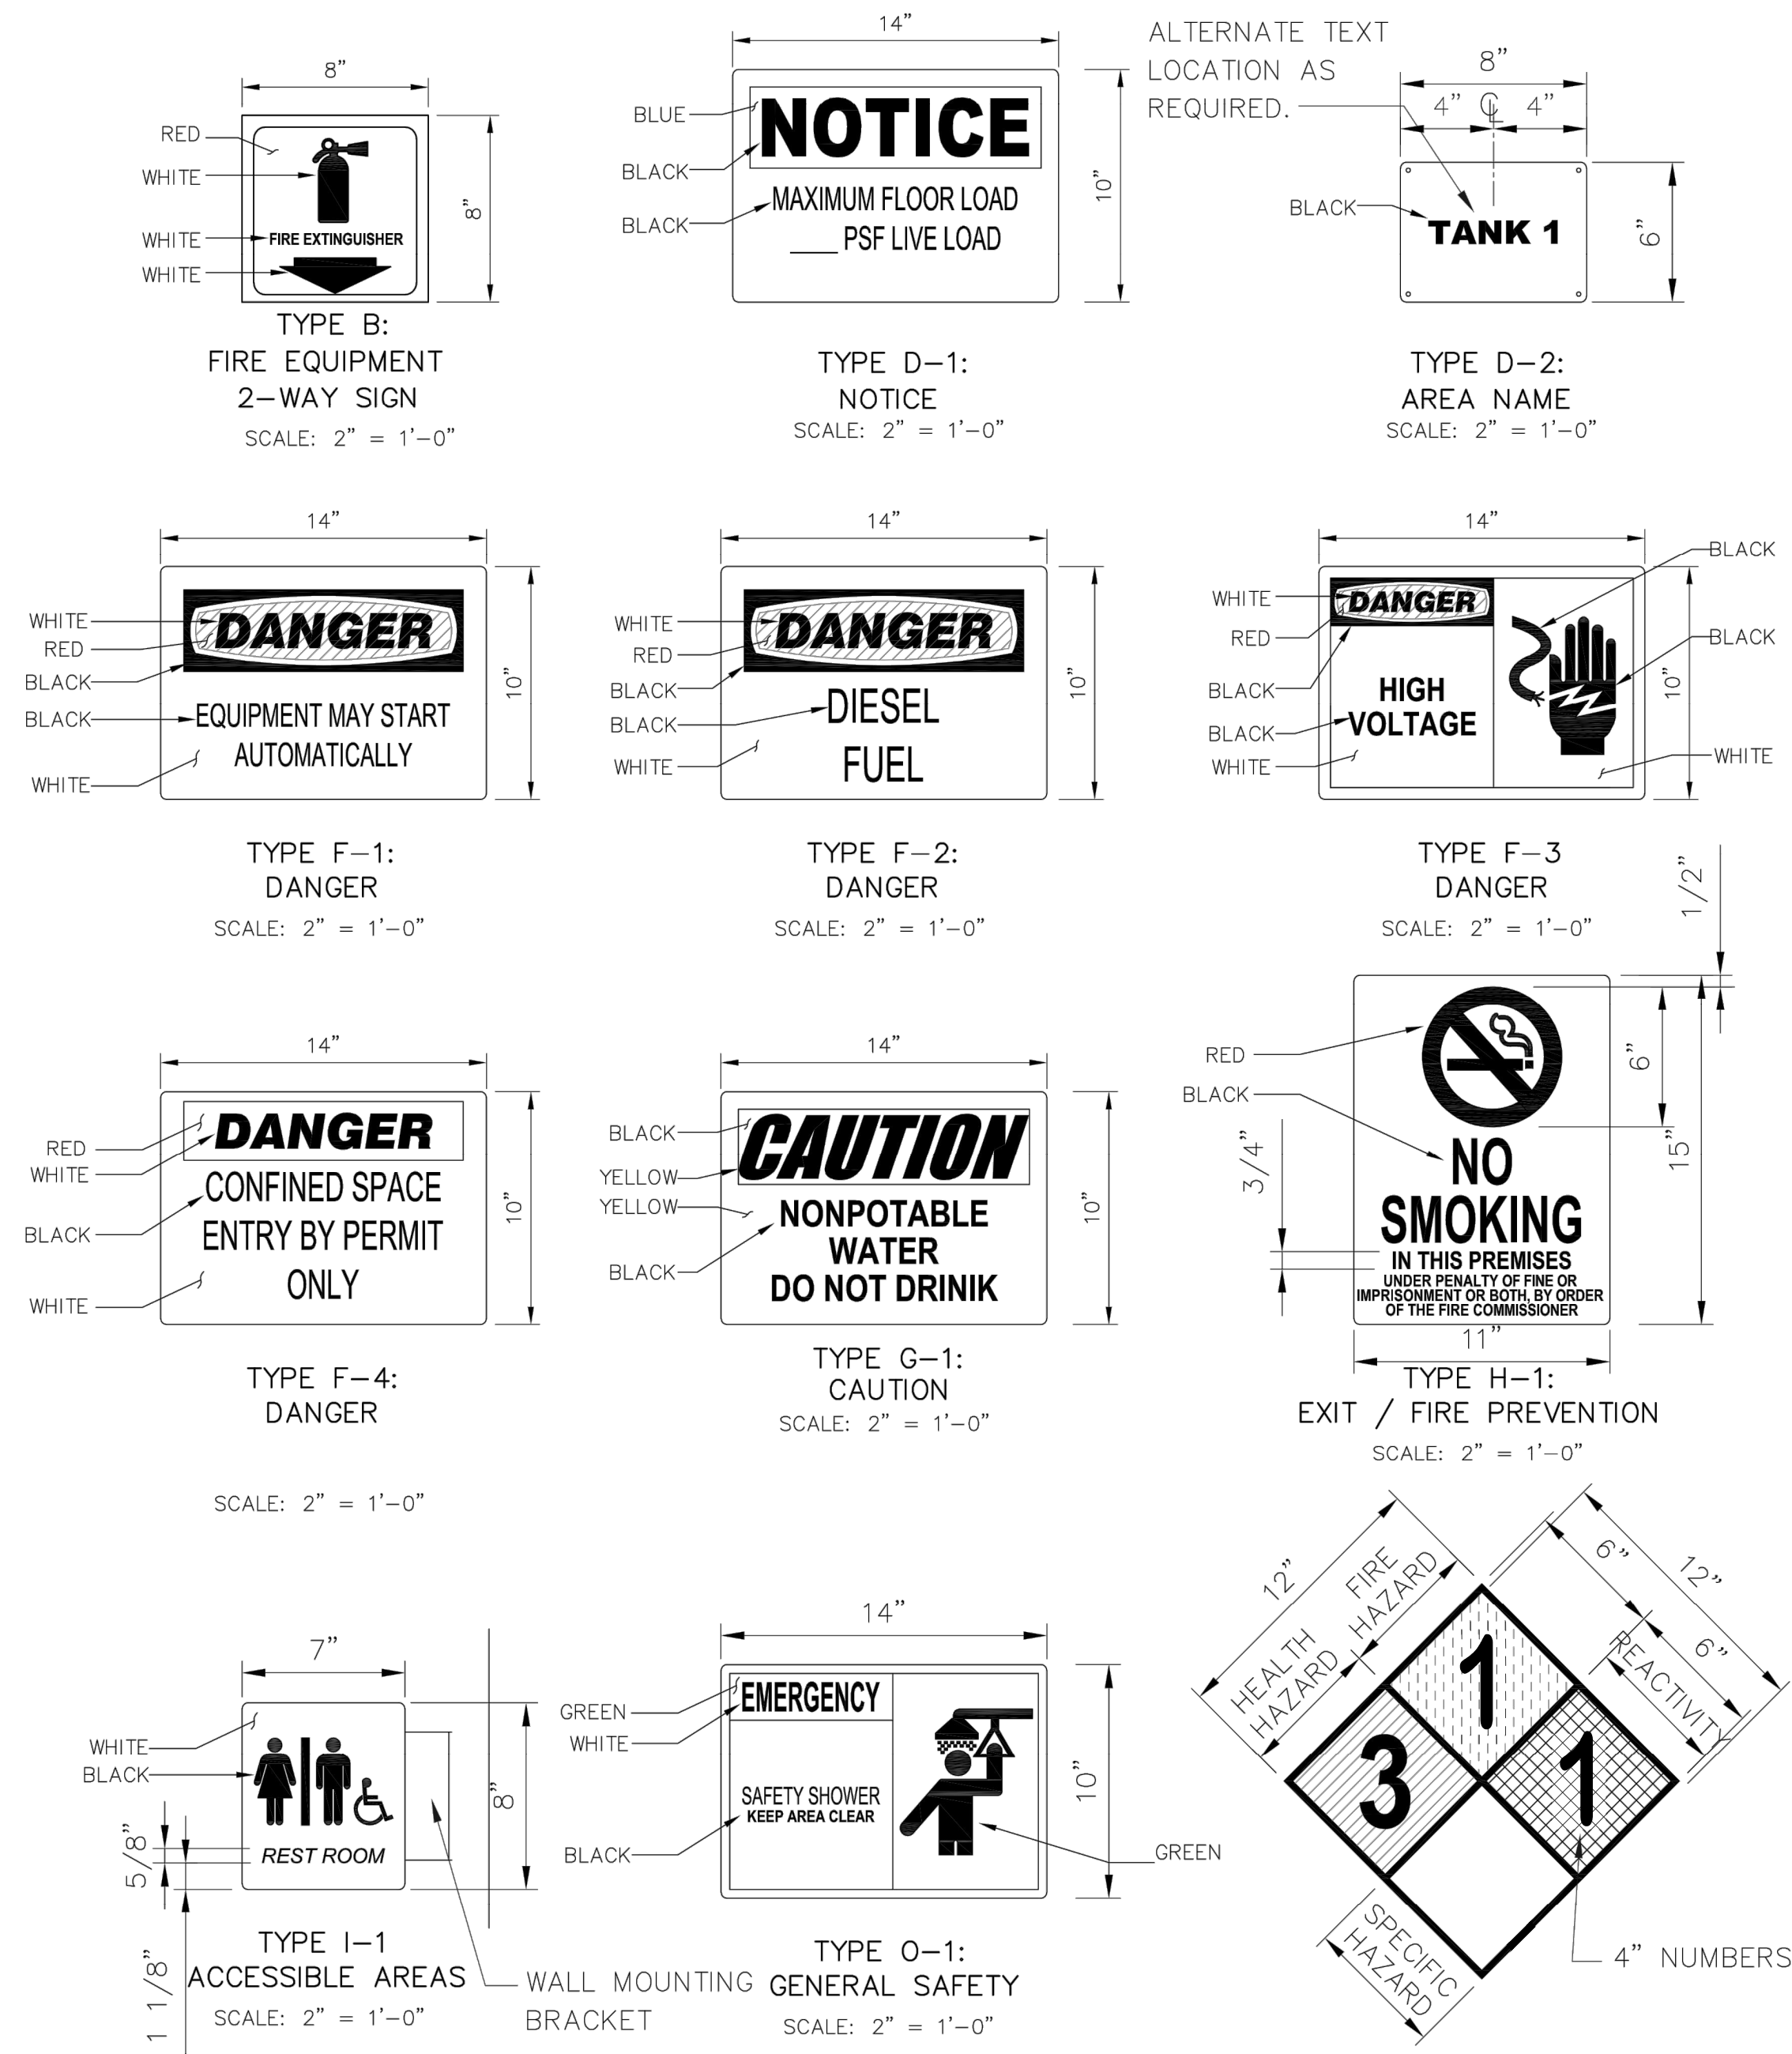


**SIGNAGE NOTES:**

- PROVIDE HAZARD RATING SIGNS / RIGHT-TO-KNOW SIGNS, LABELS AND TAGS TO COMPLY WITH NFPA 704, OSHA 1910.1200, AND OSHA SUBPART Z, FOR PROPER IDENTIFICATION OF ALL THE CHEMICALS AND MATERIALS PRESENT. THE HAZARDS ASSOCIATED WITH THESE CHEMICALS AND MATERIALS, AND WHERE THEY ARE LOCATED. VERIFY EXACT INFORMATION FOR SIGNS AND LOCATION OF SIGNS IN THE FIELD WITH OWNER AND ENGINEER.
- PROVIDE ALL ACCIDENT PREVENTION, HEALTH, SAFETY AND WARNING SIGNS IN COMPLIANCE WITH ANSI Z525.1, ANSI Z636.2, AND Z535.3 AND OSHA 1910.44 AND 1910.145. FIELD VERIFY EXACT LOCATION OF SIGNS WITH OWNER AND ENGINEER.
- FIELD VERIFY WHICH SIGNS REQUIRE BEING SUSPENDED, AND WHAT THEY WILL BE SUSPENDED FROM. PROVIDE ENGINEER APPROVED MATERIALS AND FASTENERS TO SECURELY ATTACH AND SUSPEND THESE SIGNS.
- SUSPEND DOUBLE SIDED SIGN - INDICATES SIGNS THAT WILL IN SOME CASES NEED TO BE SUSPENDED. THOSE THAT ARE SUSPENDED WILL BE A CUSTOM DOUBLE SIDED SIGN, FIELD VERIFY EXACT LOCATION.
- FIELD VERIFY DIRECTION ARROW HEADS SHOULD BE POINTING ON ALL DIRECTION SIGNS, VERIFY EXACT LOCATION OF SIGNS WITH OWNER AND ENGINEER.
- ALL SIGNS SHALL BE PLACED SO THAT THEY ARE READILY VISIBLE AND READABLE. DOORS SHALL NOT BLOCK SIGNS WHEN IN THE OPEN POSITION. VERIFY EXACT ARRANGEMENT AND PLACEMENT OF SIGNS WITH OWNER AND ENGINEER.


DETAIL 26  
C-06 C-06  
NOT TO SCALE

SIGNAGE SCHEDULE						
QUAN.	SIGN TYPE	MESSAGE	FORMS OF MESSAGE/SYMBOL TYPE (AS REQUIRED)	MATERIAL/SPECIAL INSTRUCTIONS	LOCATION	OPTIONS/REMARKS
2	B	FIRE EXTINGUISHER	TEXT, SYMBOL, ARROW	ACRYLIC	ELECTRICAL BUILDING	
2	D-1	NOTICE NO FIRE SUPPRESSION PRESENT	TEXT	ALUMINUM	ELECTRICAL BUILDING	
4	D-1	NOTICE MAXIMUM FLOOR LOAD 300 PSF LIVE LOAD	TEXT	ALUMINUM	PUMP ACCESS HATCHES	AFFIX ADJACENT TO PUMP ACCESS HATCHES
1	D-2	TANK 1	TEXT	ALUMINUM	FILL STATION	
1	D-2	TANK 1	TEXT	VINYL LABEL	CHEMICAL TANK 1	
1	D-2	TANK 2	TEXT	ALUMINUM	FILL STATION	
1	D-2	TANK 2	TEXT	VINYL LABEL	CHEMICAL TANK 2	
1	D-2	DO NOT POUR DRIP BUCKET INTO SUMP	TEXT	ALUMINUM	FILL STATION	
6	F-1	DANGER EQUIPMENT MAY START AUTOMATICALLY	TEXT	ALUMINUM	STANDBY GENERATOR MOTORIZED PLUG VALVES	
1	F-2	DANGER DIESEL FUEL	TEXT	ALUMINUM	STANDBY GENERATOR	
2	F-3	DANGER HIGH VOLTAGE	TEXT	ALUMINUM	ELECTRICAL BUILDING	
4	F-4	DANGER CONFINED SPACE ENTRY BY PERMIT ONLY	TEXT		CHEMICAL TANKS	
3	G-1	CAUTION NONPOTABLE WATER DO NOT DRINK	TEXT	ALUMINUM	AT ALL HOSEBIBS	
1	H-1		TEXT, SYMBOLS	ALUMINUM	FILL STATION	FIRE PREVENTATION/NO SMOKING SIGN FOR MESSAGE SEE TYPE H-1
1	I-1	RESTROOM	TEX, T/B, SYMBOL	ALUMINUM		
3	O-1	EMERGENCY SAFETY SHOWER KEEP AREA CLEAR	TEXT, SYMBOLS	ALUMINUM	SAFETY SHOWER/ EYEWASH	
2	R-1		TEXT, SYMBOLS	VINYL LABEL	CHEMICAL TANKS	FIRE PREVENTATION/NO SMOKING SIGN FOR MESSAGE SEE TYPE H-1
3	R-1		TEXT, SYMBOLS	ALUMINUM	SITE ENTRANCES	HAZAED RATING SEE NOTE 1
1	R-1		TEXT, SYMBOLS	ALUMINUM	STANDBY GENERATOR	HAZAED RATING SEE NOTE 1

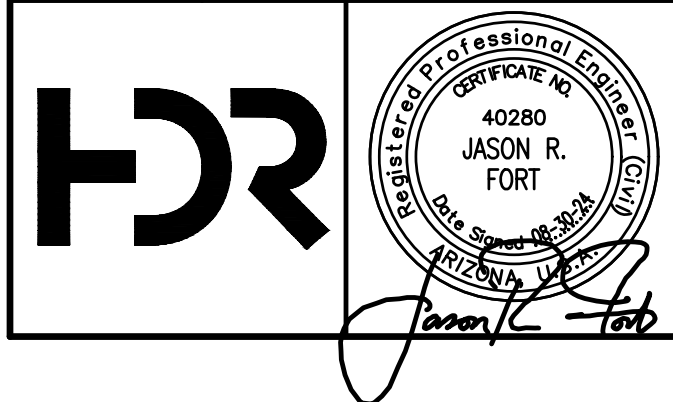

REVISIONS				
NO.	BY	DATE	CKD	REMARKS
A	RS	10/2023	JF	30% SUBMITTAL
B	RS	01/2024	JF	90% SUBMITTAL
C	RS	04/2024	JF	AGENCY REVIEW
D	FD	08/2024	JF	ISSUED FOR CONSTRUCTION
*				
*				
*				

DES	RS
DWN	RS
CKD	JF

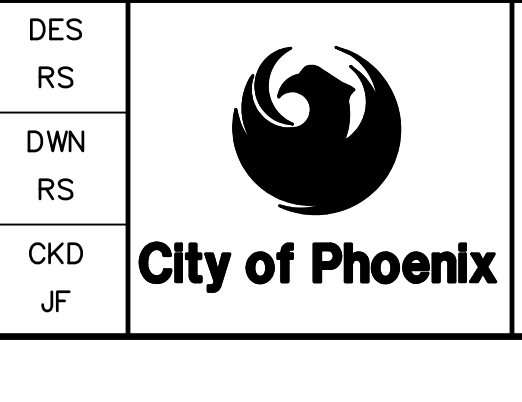

CITY OF PHOENIX  
WATER SERVICES DEPARTMENT  
  
LIFT STATION 40  
REFURBISHMENT

CIVIL  
  
COPYRIGHT © 2007--JANUARY  
CITY PROJECT NO. WS90400085  
DATE: 08/2024  
C-06 SHEET 11 OF 134  
CAD FILE: CSLS40D05.DWG

FACILITY DRAWINGS  
This drawing was supervised by an Engineer from a post construction project. The original construction drawing was modified based on information provided by the Contractor to provide the Record Drawing. The City does not warrant this drawing to be a complete and accurate portrayal of facilities as they exist in the field.


REVISION	DATE	PROJECT NAME	PROJECT NO.	COMPANY	FOR CITY OF PHOENIX USE ONLY - REFERENCE CID NUMBER: #	DATE	CAD FILE NAME	DWG NUMBER	REMARKS

USER: FDEBASRAJ.D FILE: C:\pwworking\west01\43411840\1\CSLS40D05.dwg DATE: 9/04/24 TIME: 03:17pm

FOR CONSTRUCTION

THIS DRAWING MUST BE FIELD VERIFIED BEFORE USE. DRAWING NOT TO SCALE UNLESS SCALE BAR IS PRESENT

"PER CITY OF PHOENIX CODE CHAPTER 2, SECTION 2-28, THESE PLANS ARE FOR OFFICIAL USE ONLY AND MAY NOT BE SHARED WITH OTHERS EXCEPT AS REQUIRED TO FULFILL THE OBLIGATIONS OF THE CONTRACTOR'S CONTRACT WITH THE CITY OF PHOENIX." THIS DOCUMENT MUST BE KEPT SECURE AT ALL TIMES.

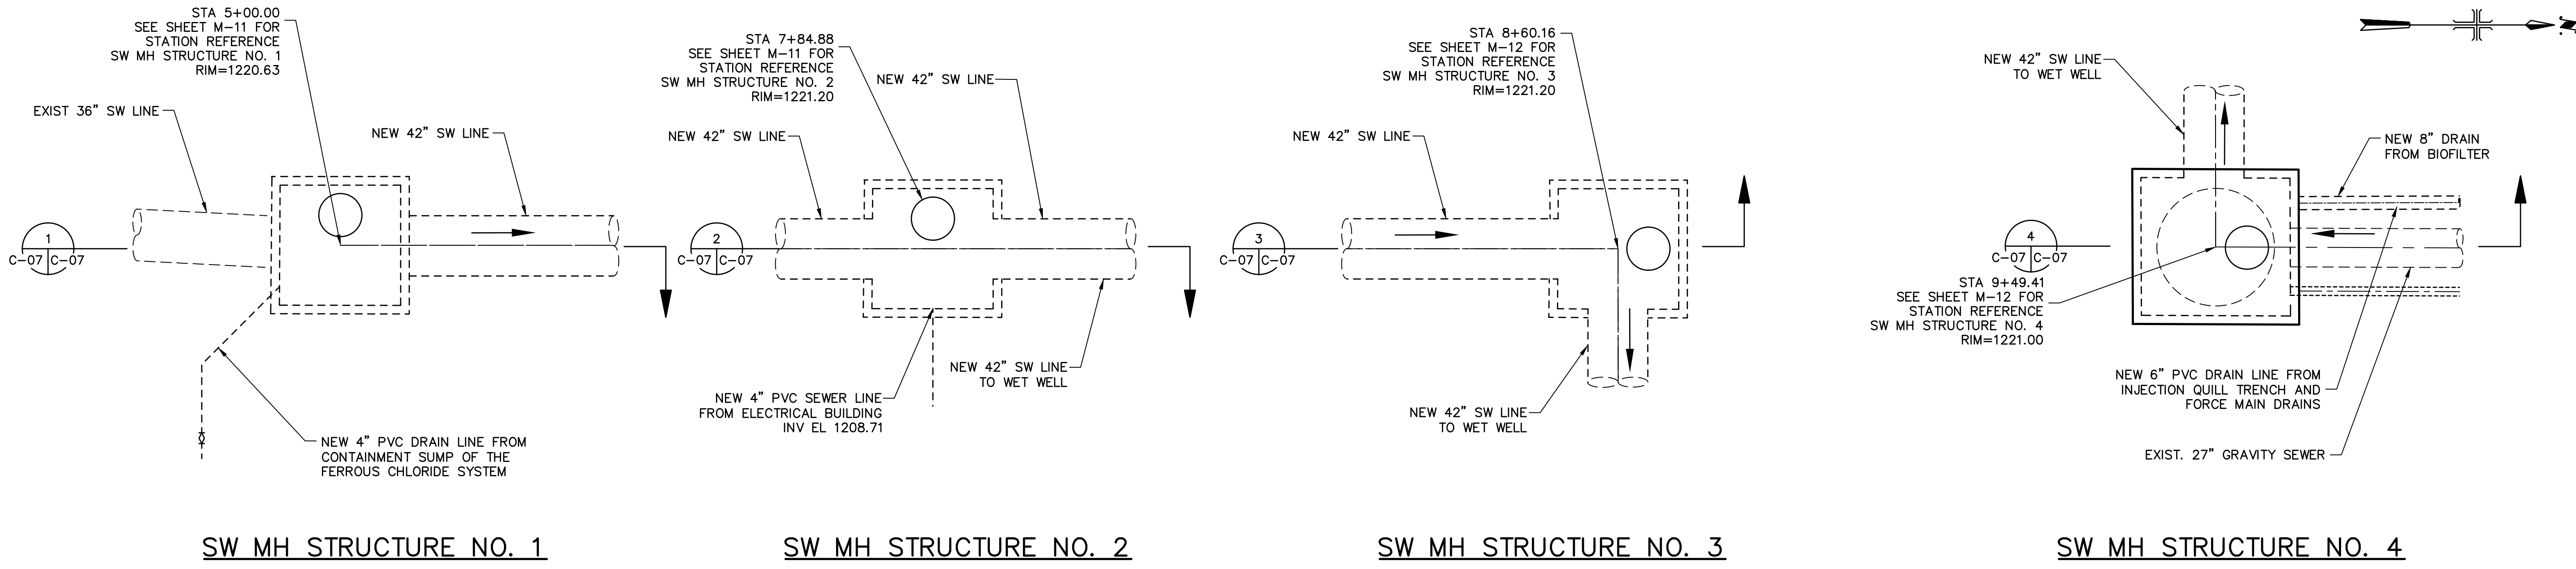

SW MH STRUCTURE NO. 1

SW MH STRUCTURE NO. 2

SW MH STRUCTURE NO. 3


SW MH STRUCTURE NO. 4

GENERAL NOTES:

- APPLY 2 COATS OF EPOXYTEC ON ALL EXPOSED CONCRETE IN MANHOLE, AT OPENINGS, AT BENCH, ON ADJUSTING RINGS, AND ON THE INTERNAL EXPOSED SURFACES OF MANHOLE FRAMES AND COVERS. FIRST COAT TO DRY PRIOR TO APPLICATION OF SECOND COAT.
- A 2" DEEP IMPRESSION SHALL BE MADE IN THE CONCRETE MANHOLE BASE USING A FIBERGLASS IMPRESSION RING. MANHOLE RISER SHALL NOT BE PLACED IN THE IMPRESSION IN THE CONCRETE MANHOLE BASE LESS THAN 24 HOURS AFTER THE CONCRETE MANHOLE BASE HAS BEEN PLACED.
- ALL MANHOLE RISERS AND ECCENTRIC CONES SHALL BE LINED WITH PVC LINER PLATE. PVC LINER SHALL BE TURNED BACK AT THE TOP OF THE ECCENTRIC CONE AND AT THE BOTTOM OF THE MANHOLE RISER SECTION USING 2-1/2" X 2-1/2" PVC LINER ANGLE STRIPS. AT MANHOLE RISER JOINTS AND AT JOINTS BETWEEN MANHOLE RISERS ECCENTRIC CONES, 4" PVC LINER WELD STRIPS SHALL BE WELDED TO PVC LINER ON ADJACENT RISERS OR CONES WITH A MIN. 1" LAP OVER EACH LINER PLATE.

GENERAL NOTES CON'T:

- SEE DRAWING C-20 FOR ORIENTATION.
- CONTRACTOR SHALL UNCOVER AND FIELD VERIFY INVERT ELEVATIONS OF EXIST 27" AND 42" SW LINE PRIOR TO ANY TRENCHING OR SETTING OF GRADES FOR THE NEW 42" SW AND THE 8" SW LINES AND MANHOLES 1, 2 AND 3.
- SEWER PIPE SHALL BE PER CITY OF PHOENIX STANDARDS.
- SANITARY SEWER MANHOLES SHALL BE COATED PER SPEC SECTION 09 96 22.

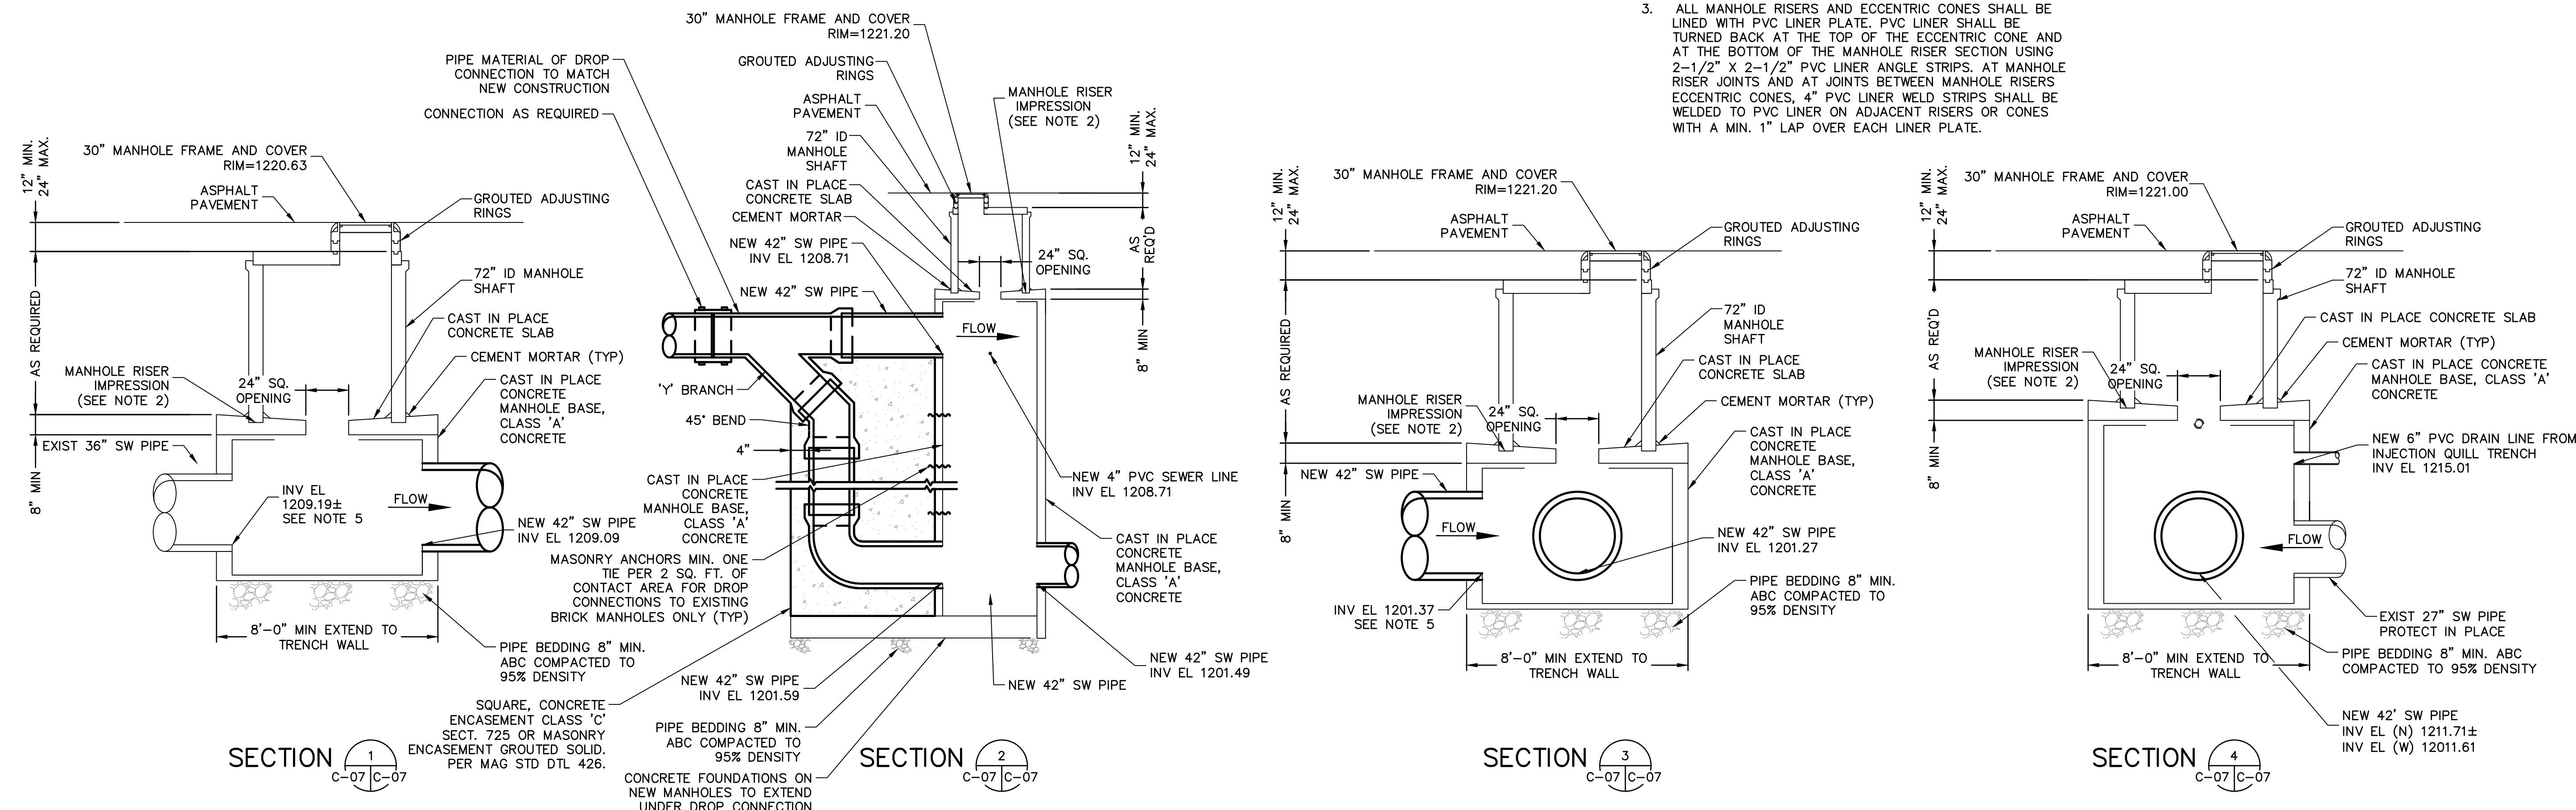


SECTION 1 C-07 | C-07

SECTION 2 C-07 | C-07

SECTION 3 C-07 | C-07

SECTION 4 C-07 | C-07

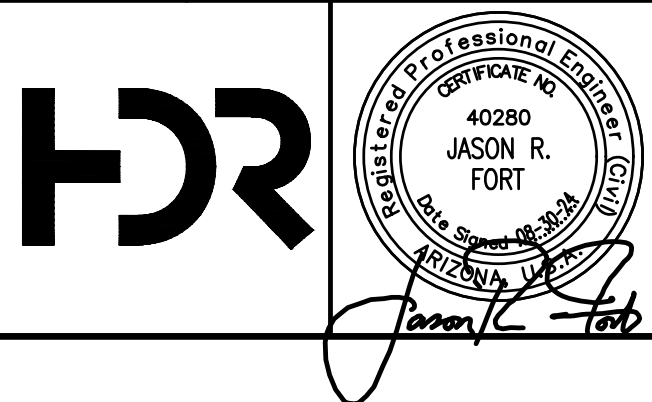

NO.	BY	DATE	CKD	REMARKS
A	RS	10/2023	JF	30% SUBMITTAL
B	RS	01/2024	JF	90% SUBMITTAL
C	RS	04/2024	JF	AGENCY REVIEW
D	DFD	08/2024	JF	ISSUED FOR CONSTRUCTION
*				
*				
*				



CITY OF PHOENIX  
WATER SERVICES DEPARTMENT  
  
LIFT STATION 40  
REFURBISHMENT

CIVIL  
  
GENERAL DETAILS 6

COPYRIGHT © 2007-JANUARY  
CITY PROJECT NO. WS90400085  
DATE: 08/2024  
C-07 SHEET 12 OF 134  
CAD FILE: CSCLS40D06.DWG

FACILITY DRAWINGS  
This drawing was supplied by a Consultant Engineer from a past project. The Consultant Engineer is not responsible for the accuracy of the information provided by the Contractor to provide the Record Drawing. The City does not warrant this drawing to be a complete and accurate portrayal of facilities as they exist in the field.


REVISION	DATE	CAD FILE NAME	DWG NUMBER	REMARKS

USER: FBERASFRALD FILE: C:\pwworking\west01\33411940\12\_CSCLS40D06.dwg DATE: 09/04/24 TIME: 03:18pm

THIS DRAWING MUST BE FIELD VERIFIED BEFORE USE  
DRAWING NOT TO SCALE UNLESS SCALE BAR IS PRESENT

FOR CONSTRUCTION

"PER CITY OF PHOENIX CODE CHAPTER 2, SECTION 2-28, THESE PLANS ARE FOR OFFICIAL USE ONLY AND MAY NOT BE SHARED WITH OTHERS EXCEPT AS REQUIRED TO FULFILL THE OBLIGATIONS OF THE CONTRACTOR'S CONTRACT WITH THE CITY OF PHOENIX."  
THIS DOCUMENT MUST BE KEPT SECURE AT ALL TIMES.

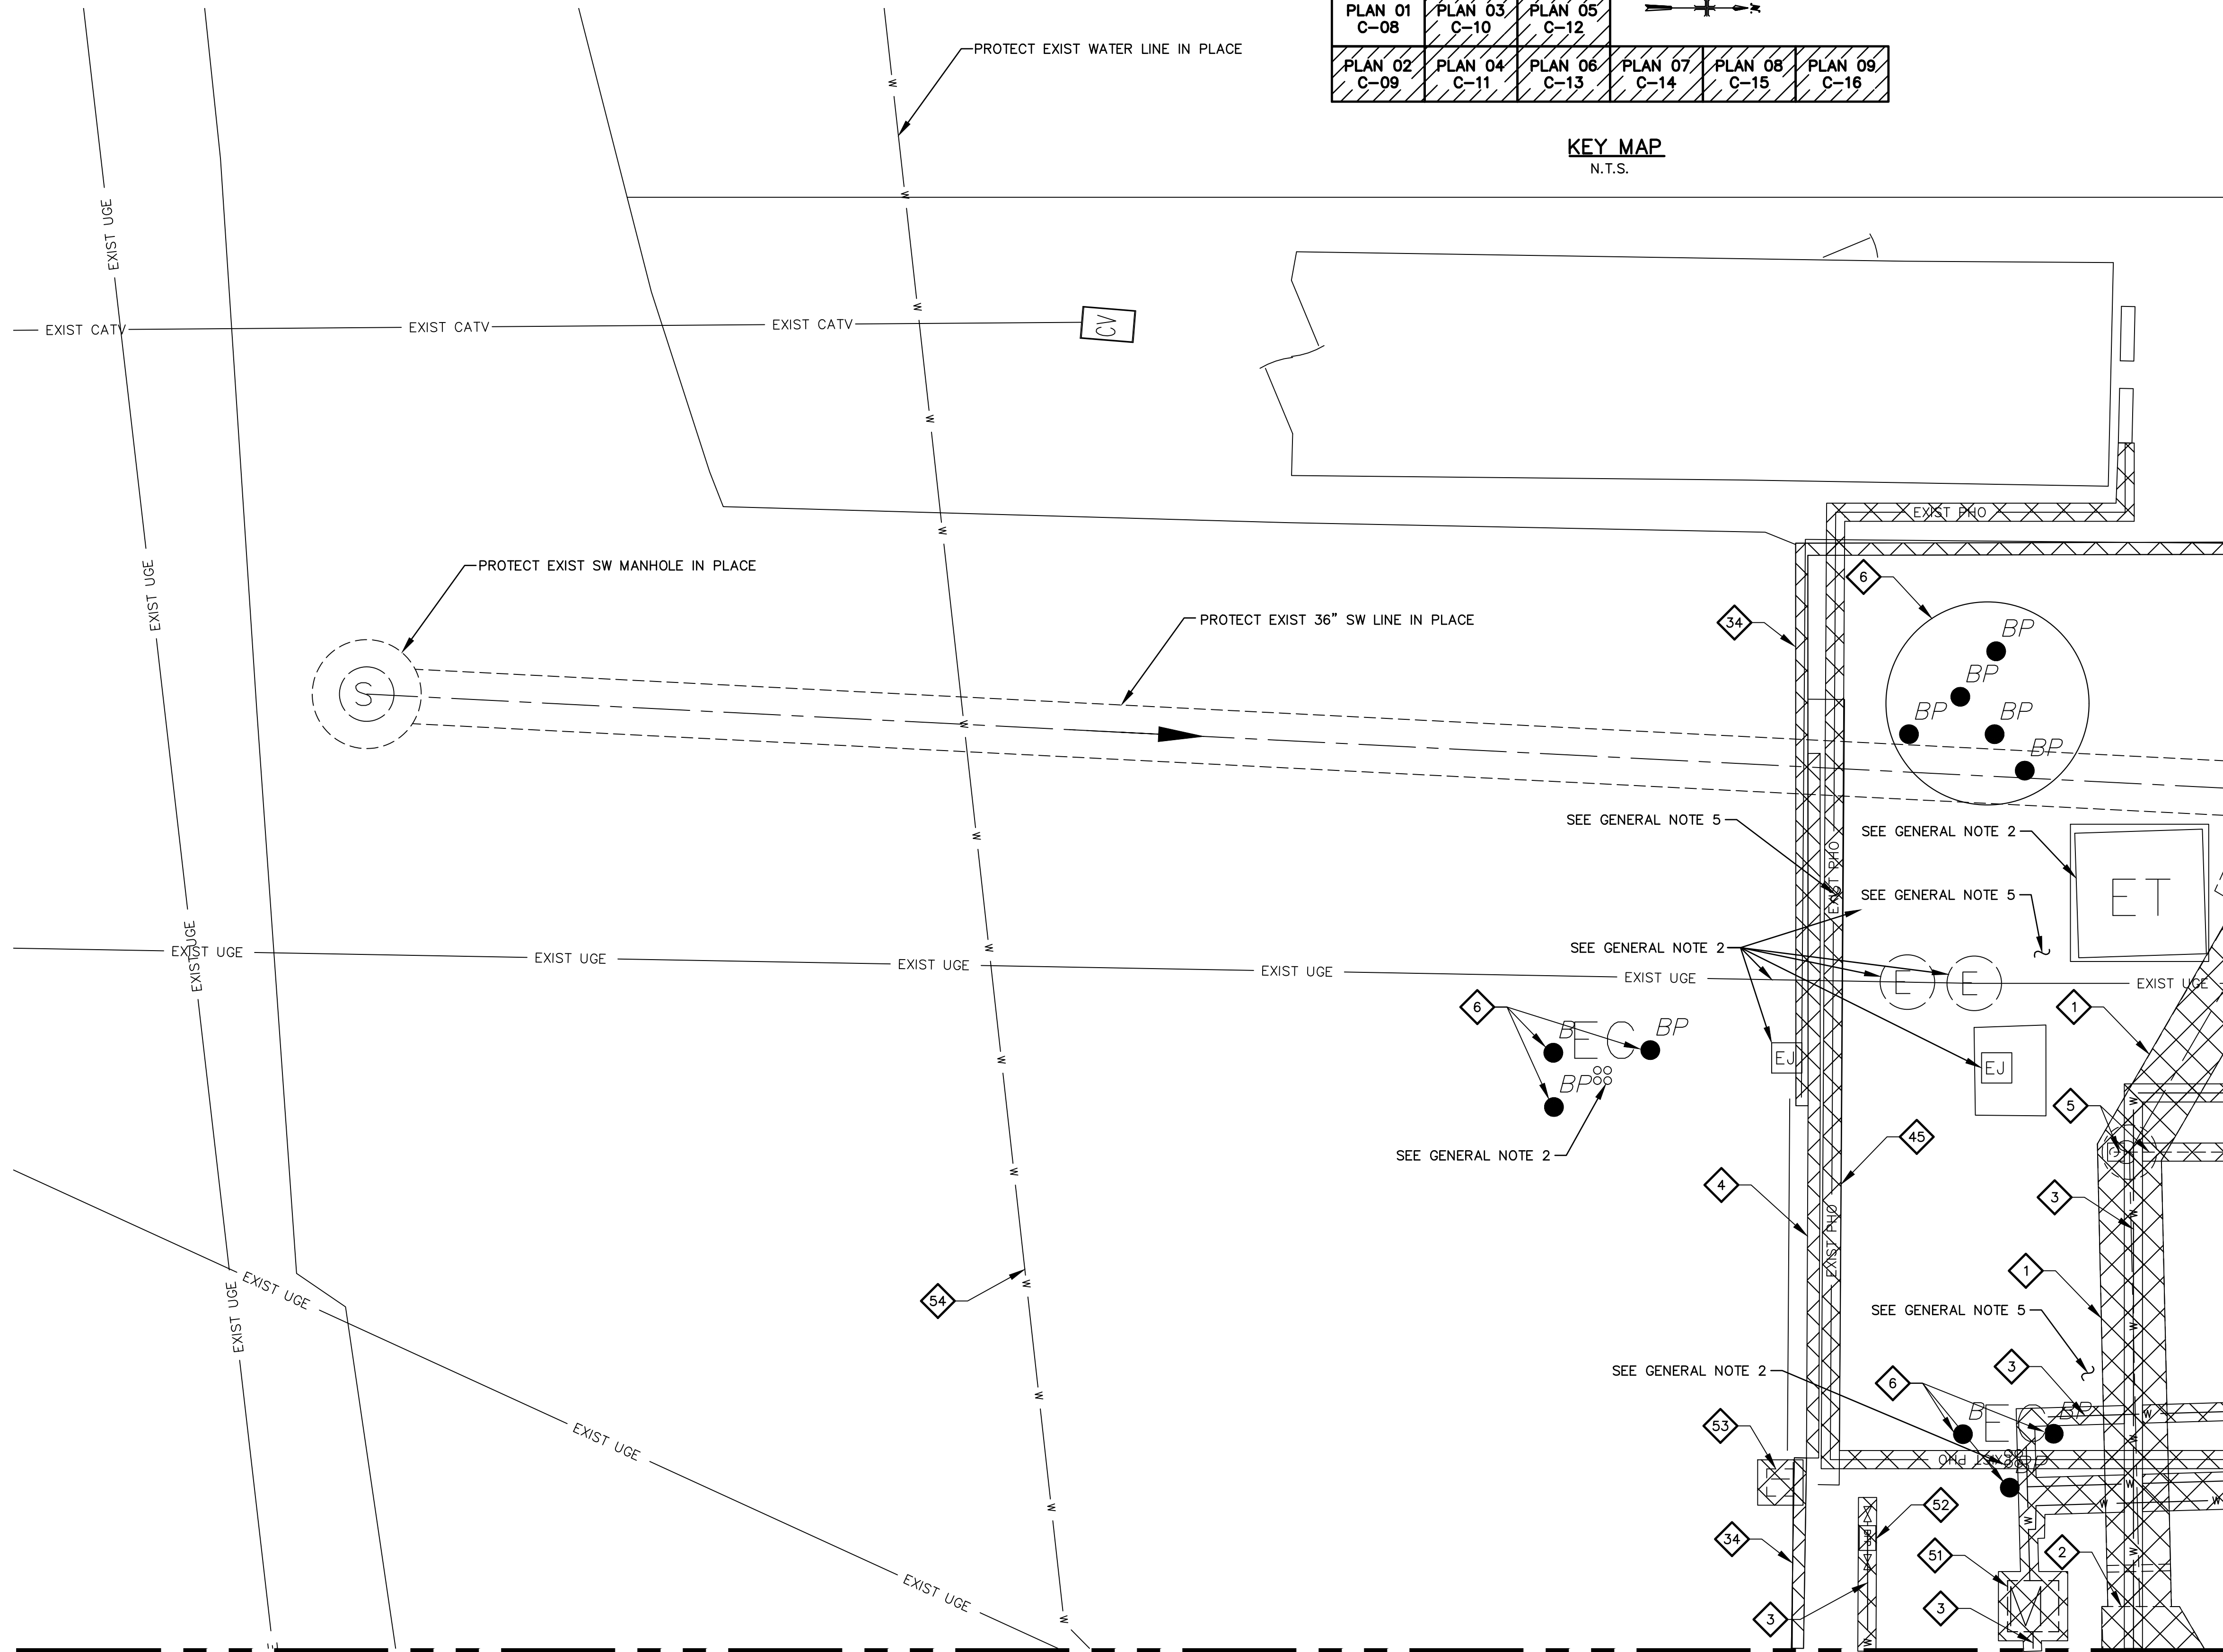

PLAN 01 C-08	PLAN 03 C-10	PLAN 05 C-12			
PLAN 02 C-09	PLAN 04 C-11	PLAN 06 C-13	PLAN 07 C-14	PLAN 08 C-15	PLAN 09 C-16

KEY MAP  
N.T.S.

KEY NOTES


- 1 REMOVE EXIST 42" SW LINE.
- 2 REMOVE EXIST SW STRUCTURE.
- 3 REMOVE EXIST 3" WATER LINE.
- 4 REMOVE EXIST 20' VEHICULAR SLIDE GATE.
- 5 REMOVE EXIST 6" PVC SW LINE.
- 6 REMOVE EXIST BOLLARD.
- 34 REMOVE EXIST 8" CMU WALL.
- 45 REMOVE EXIST TELEPHONE LINE.
- 51 REMOVE EXIST WATER METER.
- 52 REMOVE EXIST BACKFLOW PREVENTOR.
- 53 REMOVE EXIST IRRIGATION BOX.
- 54 PROTECT EXIST 3" WATER LINE IN PLACE.

LEGEND

- DEMOLITION OF EXIST UTILITIES AND EXIST STRUCTURES WITH ALL APPURTENANCES AND CONCRETE SLABS. SEE GENERAL NOTE 4 AND 7.
- ABANDONMENT OF EXIST UTILITIES. SEE GENERAL NOTE 6.


GENERAL NOTE

1. CONTRACTOR TO VERIFY SIZE AND LOCATION OF THE EXIST UTILITY LINES, VALVES, AND METERS PRIOR TO RELOCATION AND ABANDONMENT.
2. ALL EXIST ELECTRICAL LINES, EQUIPMENT, CONCRETE PADS AND MANHOLES ARE SHOWN AS PART OF THE SURVEY AND THE OWNER'S UTILITY MAP. FOR ALL ELECTRICAL DEMOLITION, RELOCATION AND ABANDONMENT OF ANY AND ALL ELECTRICAL LINES, EQUIPMENT, CONCRETE PADS AND MANHOLES SEE ELECTRICAL PLANS.
3. FOR CONTINUATION OF DEMOLITION SEE SHEET C-09, SHEET C-10 AND SHEET C-11.
4. FOR ALL EXIST STRUCTURES THE CONTRACTOR SHALL REFER TO SPECIFICATION 01 11 00 - SUMMARY OF WORK FOR SEQUENCE OF DEMOLITION AND CONSTRUCTION. COORDINATE WITH THE CITY OF PHOENIX FOR SALVAGING ANY ITEMS AND FOR SPECIAL INSTRUCTIONS. COMPACT VOIDED AREA TO 95% DENSITY.
5. CONTRACTOR TO REMOVE EXIST AC PAVEMENT AND CONCRETE AND REPLACE IN-KIND. BEFORE REPLACING ANY NEW AC PAVEMENT AND NEW CONCRETE REFER TO THE CIVIL SHEETS FOR ALL NEW BURIED UTILITY CONSTRUCTION.
6. ITEMS CALLED OUT TO BE ABANDONED CAN BE REMOVED FOR CONTRACTOR'S CONVENIENCE AT NO ADDITIONAL COST TO THE CITY.
7. ITEMS CALLED OUT TO BE REMOVED SHALL BE REMOVED A MINIMUM OF 2' VERTICALLY AND 6' HORIZONTALLY FROM NEW WORK TO BE INSTALLED.

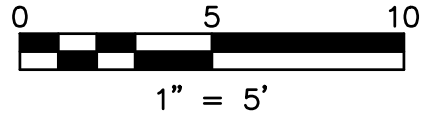


FACILITY DRAWINGS  
 This drawing was supplied by a Consultant Engineer from a past project. The Consultant Engineer is not responsible for the accuracy of the information provided by the Contractor to provide the Record Drawing. The City does not warrant this drawing to be a complete and accurate portrayal of facilities as they exist in the field.

REVISION	ENGINEERING COMPANY	PROJECT NO.	PROJECT NAME	DATE	CAD FILE NAME	DWG NUMBER	REMARKS

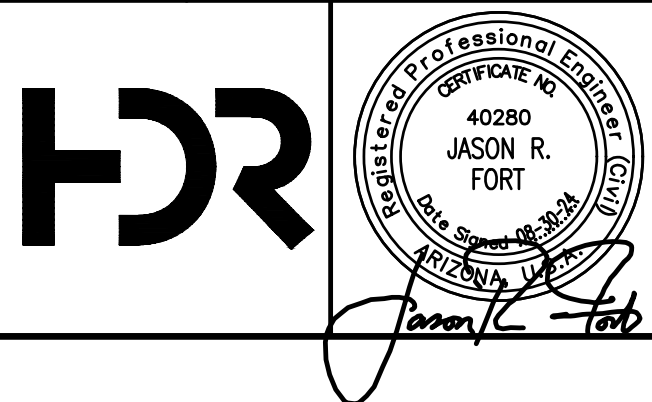

NO.	BY	DATE	CKD	REVISIONS	REMARKS
A	RS	10/2023	JF	30% SUBMITTAL	
B	RS	01/2024	JF	90% SUBMITTAL	
C	RS	04/2024	JF	AGENCY REVIEW	
D	DFD	08/2024	JF	ISSUED FOR CONSTRUCTION	
*					
*					
*					

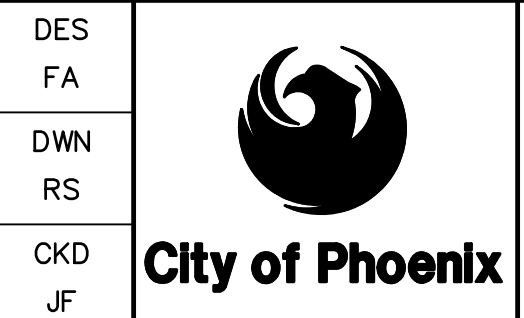

CITY OF PHOENIX  
WATER SERVICES DEPARTMENT  
  
LIFT STATION 40  
REFURBISHMENT

CIVIL  
  
DEMOLITION PLAN 01


COPYRIGHT © 2007-JANUARY  
CITY PROJECT NO. WS90400085  
DATE: 08/2024  
C-08 SHEET 13 OF 134  
CAD FILE: CSCLS40M01.dwg

USER: FIDESR\FRALD FILE: C:\pwworking\west01\33411840\13\_CSCLS40M01.dwg DATE: 8/24/24 TIME: 03:18pm

**FOR CONSTRUCTION**

THIS DRAWING MUST BE FIELD VERIFIED BEFORE USE. DRAWING NOT TO SCALE UNLESS SCALE BAR IS PRESENT.

"PER CITY OF PHOENIX CODE CHAPTER 2, SECTION 2-28, THESE PLANS ARE FOR OFFICIAL USE ONLY AND MAY NOT BE SHARED WITH OTHERS EXCEPT AS REQUIRED TO FULFILL THE OBLIGATIONS OF THE CONTRACTOR'S CONTRACT WITH THE CITY OF PHOENIX." THIS DOCUMENT MUST BE KEPT SECURE AT ALL TIMES.

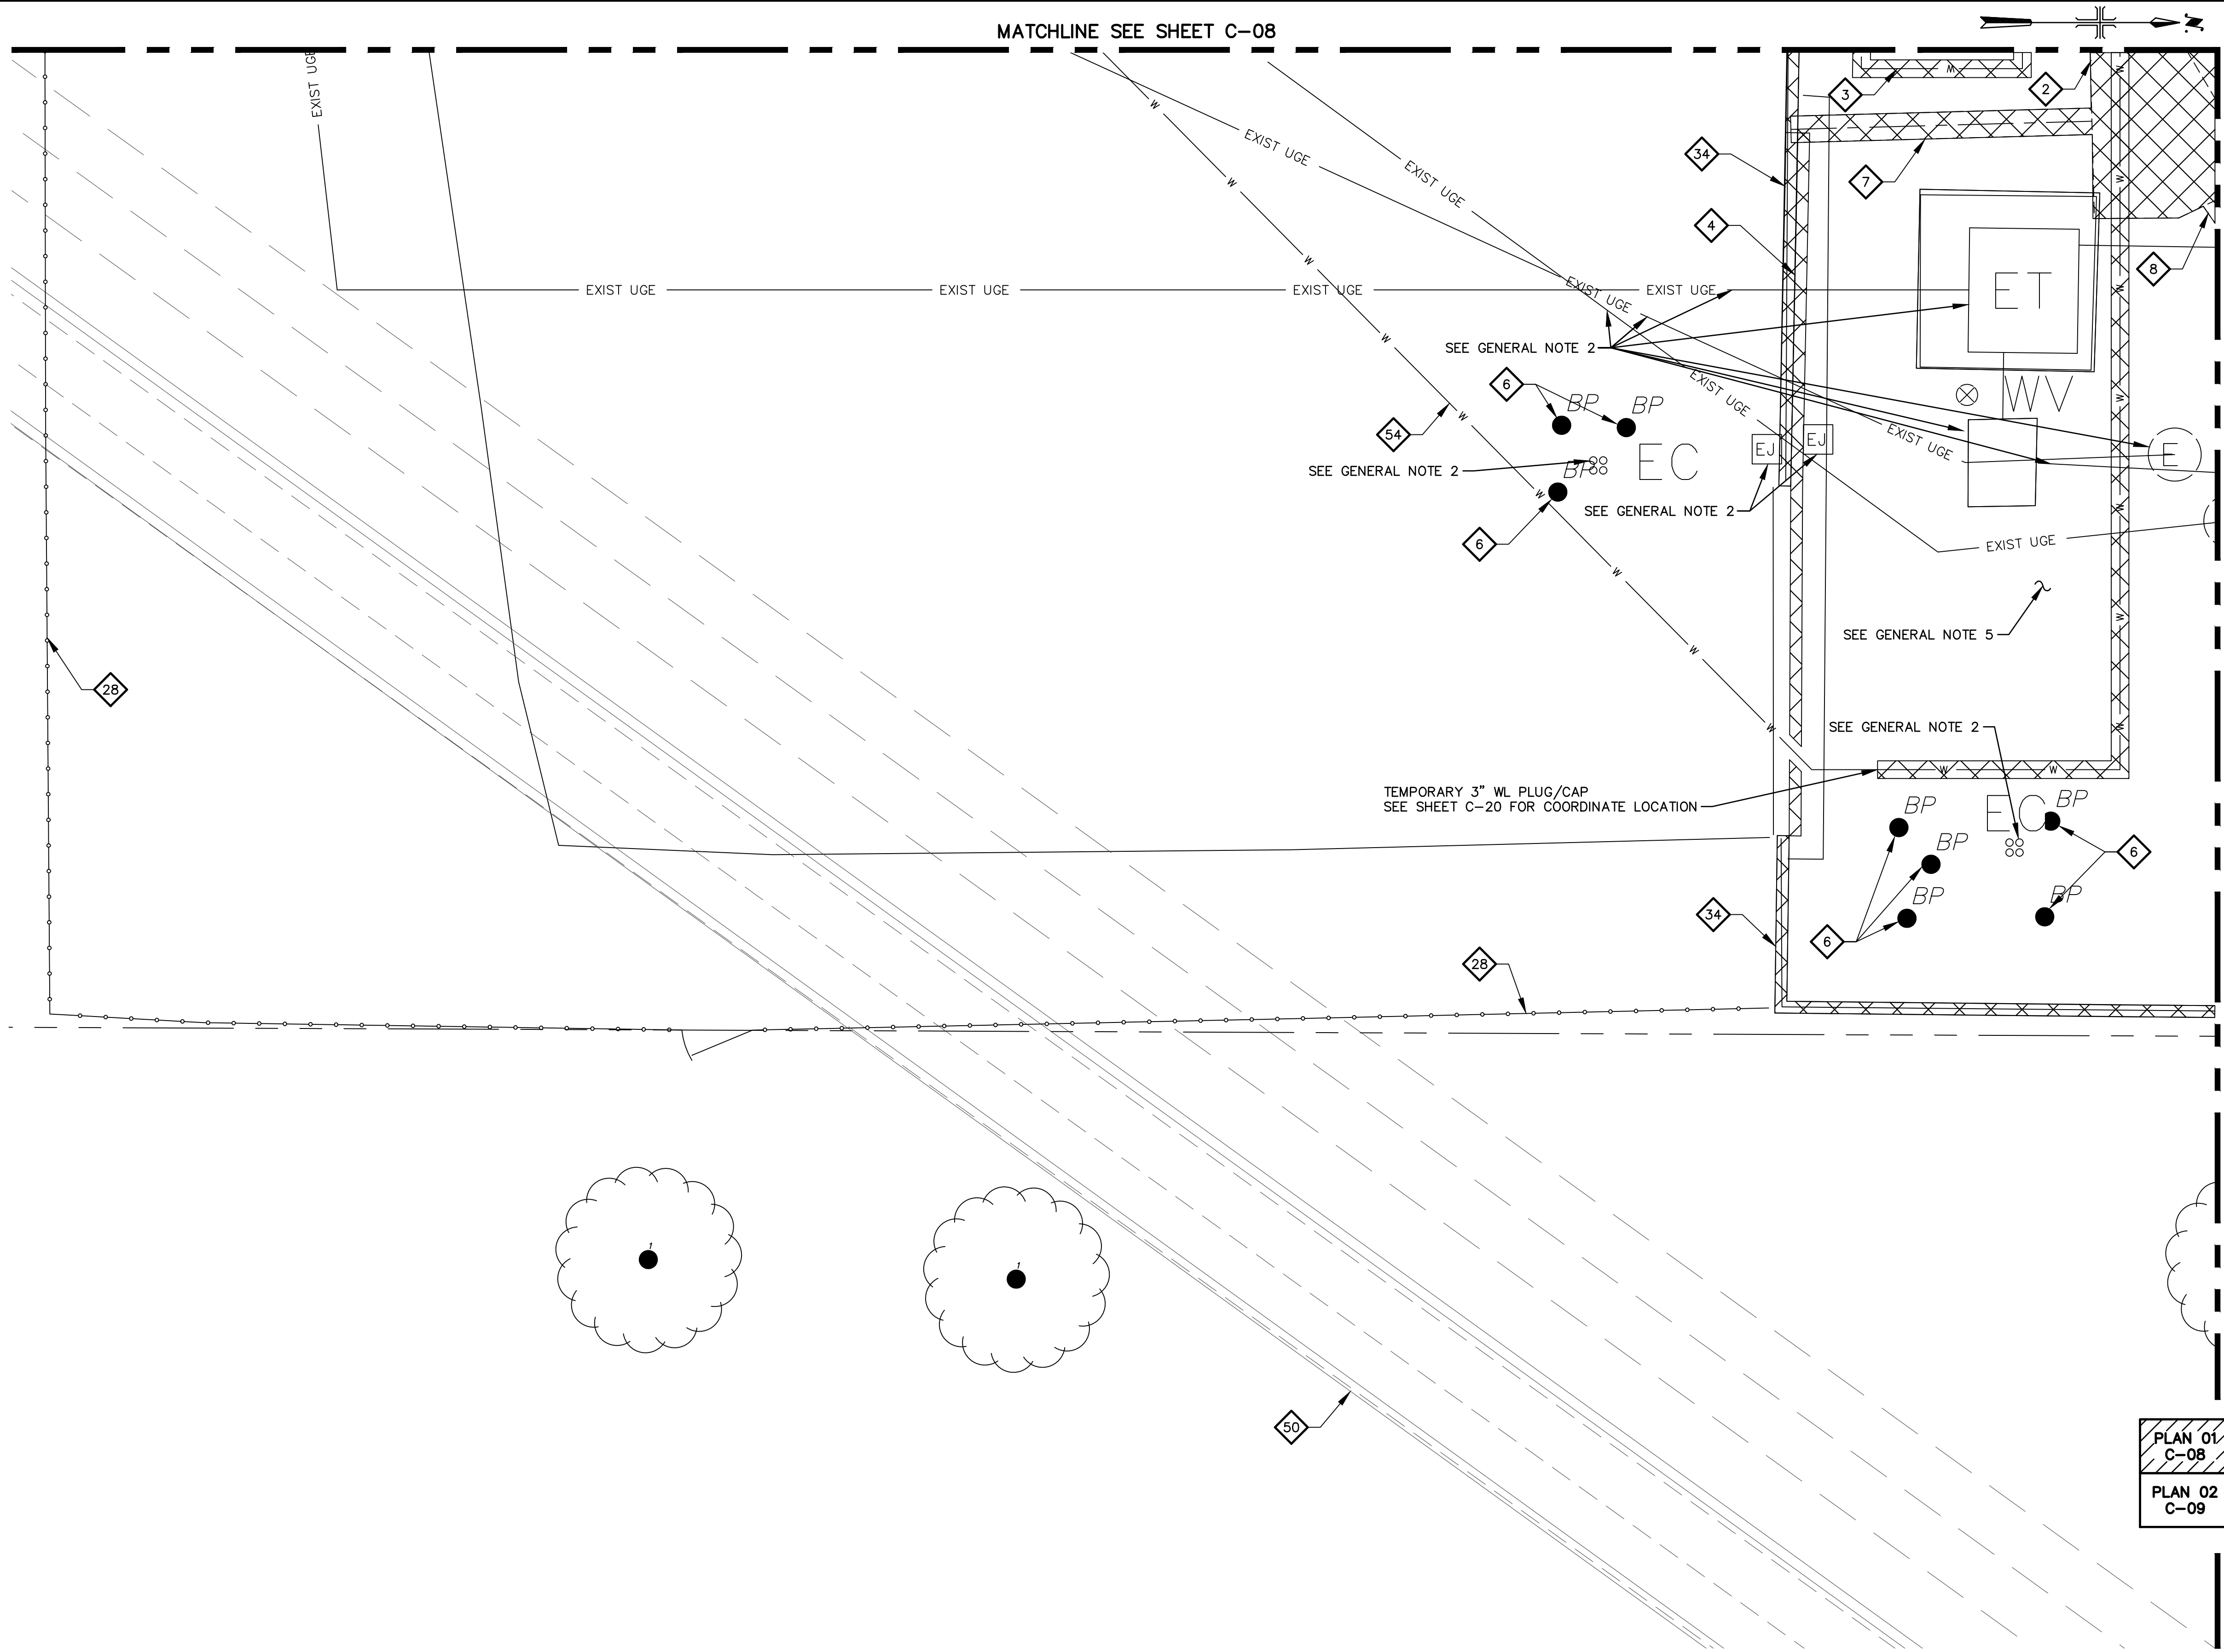

MATCHLINE SEE SHEET C-08

MATCHLINE SEE SHEET C-11

**KEY NOTES**


- 2 REMOVE EXIST SW STRUCTURE.
- 3 REMOVE EXIST 3" WATER LINE.
- 4 REMOVE EXIST 20' VEHICULAR SLIDE GATE.
- 6 REMOVE EXIST BOLLARD.
- 7 REMOVE EXIST 18" SW LINE.
- 8 REMOVE EXIST 30" SW LINE.
- 28 PROTECT CHAIN LINK FENCE IN PLACE.
- 34 REMOVE EXIST 8" CMU WALL.
- 50 PROTECT EXIST 72" SRP IRRIGATION LINE IN PLACE.
- 54 PROTECT EXIST 3" WATER LINE IN PLACE.

**LEGEND**


- DEMOLITION OF EXIST UTILITIES AND EXIST STRUCTURES WITH ALL APPURTENANCES AND CONCRETE SLABS. SEE GENERAL NOTE 4 AND 7.
- ABANDONMENT OF EXIST UTILITIES. SEE GENERAL NOTE 6.

**GENERAL NOTE**

1. CONTRACTOR TO VERIFY SIZE AND LOCATION OF THE EXIST UTILITY LINES, VALVES, AND METERS PRIOR TO RELOCATION AND ABANDONMENT.
2. ALL EXIST ELECTRICAL LINES, EQUIPMENT, CONCRETE PADS AND MANHOLES ARE SHOWN AS PART OF THE SURVEY AND THE OWNER'S UTILITY MAP. FOR ALL ELECTRICAL DEMOLITION, RELOCATION AND ABANDONMENT OF ANY AND ALL ELECTRICAL LINES, EQUIPMENT, CONCRETE PADS AND MANHOLES SEE ELECTRICAL PLANS.
3. FOR CONTINUATION OF DEMOLITION SEE SHEET C-08, SHEET C-10 AND SHEET C-11.
4. FOR ALL EXIST STRUCTURES THE CONTRACTOR SHALL REFER TO SPECIFICATION 01 11 00 - SUMMARY OF WORK FOR SEQUENCE OF DEMOLITION AND CONSTRUCTION. COORDINATE WITH THE CITY OF PHOENIX FOR SALVAGING ANY ITEMS AND FOR SPECIAL INSTRUCTIONS. COMPACT VOIDED AREA TO 95% DENSITY.
5. CONTRACTOR TO REMOVE EXIST AC PAVEMENT AND CONCRETE AND REPLACE IN-KIND. BEFORE REPLACING ANY NEW AC PAVEMENT AND NEW CONCRETE REFER TO THE CIVIL SHEETS FOR ALL NEW BURIED UTILITY CONSTRUCTION.
6. ITEMS CALLED OUT TO BE ABANDONED CAN BE REMOVED FOR CONTRACTOR'S CONVENIENCE AT NO ADDITIONAL COST TO THE CITY.
7. ITEMS CALLED OUT TO BE REMOVED SHALL BE REMOVED A MINIMUM OF 2' VERTICALLY AND 6' HORIZONTALLY FROM NEW WORK TO BE INSTALLED.

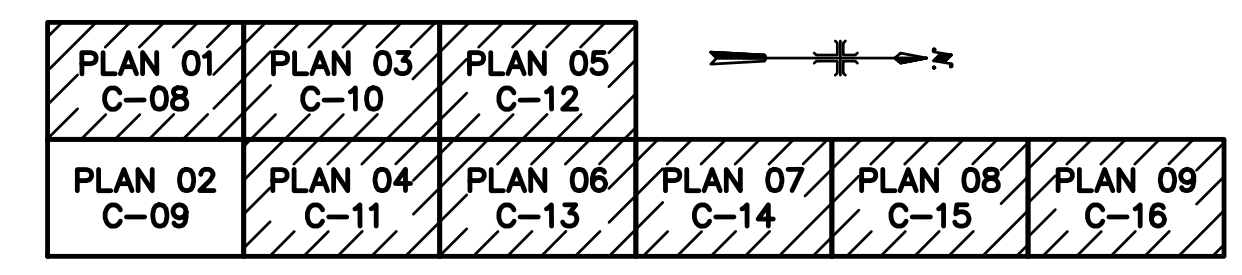


**KEY MAP**  
N.T.S.

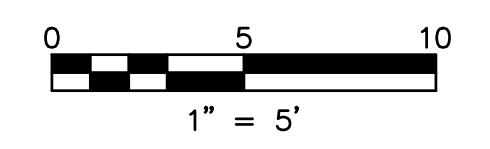


FACILITY DRAWINGS  
This drawing was supplied by a Consultant Engineer from a past project. The Consultant Engineer is not responsible for the construction information provided by the Contractor to provide the Record Drawing. The City does not warrant this drawing to be a complete and accurate portrayal of facilities as they exist in the field.

REVISION	DATE	CAD FILE NAME	DWG NUMBER	REMARKS

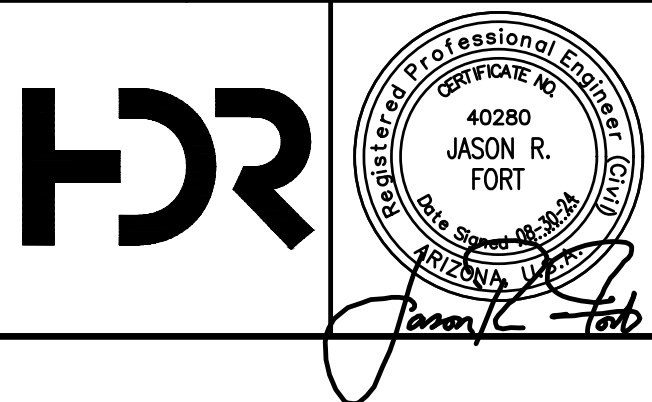

REVISIONS				
NO.	BY	DATE	CKD	REMARKS
A	RS	10/2023	JF	30% SUBMITTAL
B	RS	01/2024	JF	90% SUBMITTAL
C	RS	04/2024	JF	AGENCY REVIEW
D	FDF	08/2024	JF	ISSUED FOR CONSTRUCTION
*				
*				
*				

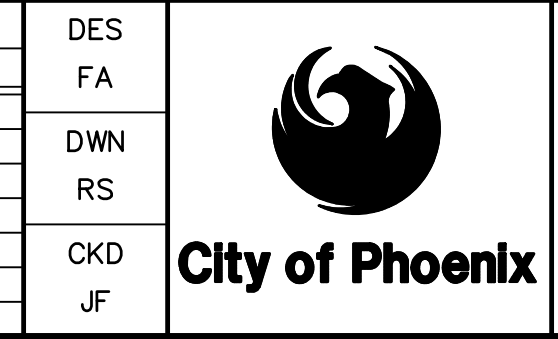

CITY OF PHOENIX  
WATER SERVICES DEPARTMENT  
  
LIFT STATION 40  
REFURBISHMENT

CIVIL  
  
DEMOLITION PLAN 02


COPYRIGHT © 2007-JANUARY  
CITY PROJECT NO. WS90400085  
DATE: 08/2024  
C-09 SHEET 14 OF 134  
CAD FILE: CSCLS40M02.dwg

USER: FDEBASFRALD0 FILE: C:\pwworking\west01\03411840\14\_CSCLS40M02.dwg DATE: 9/24/24 TIME: 03:18pm

THIS DRAWING MUST BE FIELD VERIFIED BEFORE USE  
DRAWING NOT TO SCALE UNLESS SCALE BAR IS PRESENT


FOR CONSTRUCTION

"PER CITY OF PHOENIX CODE CHAPTER 2, SECTION 2-28, THESE PLANS ARE FOR OFFICIAL USE ONLY AND MAY NOT BE SHARED WITH OTHERS EXCEPT AS REQUIRED TO FULFILL THE OBLIGATIONS OF THE CONTRACTOR'S CONTRACT WITH THE CITY OF PHOENIX."  
THIS DOCUMENT MUST BE KEPT SECURE AT ALL TIMES.

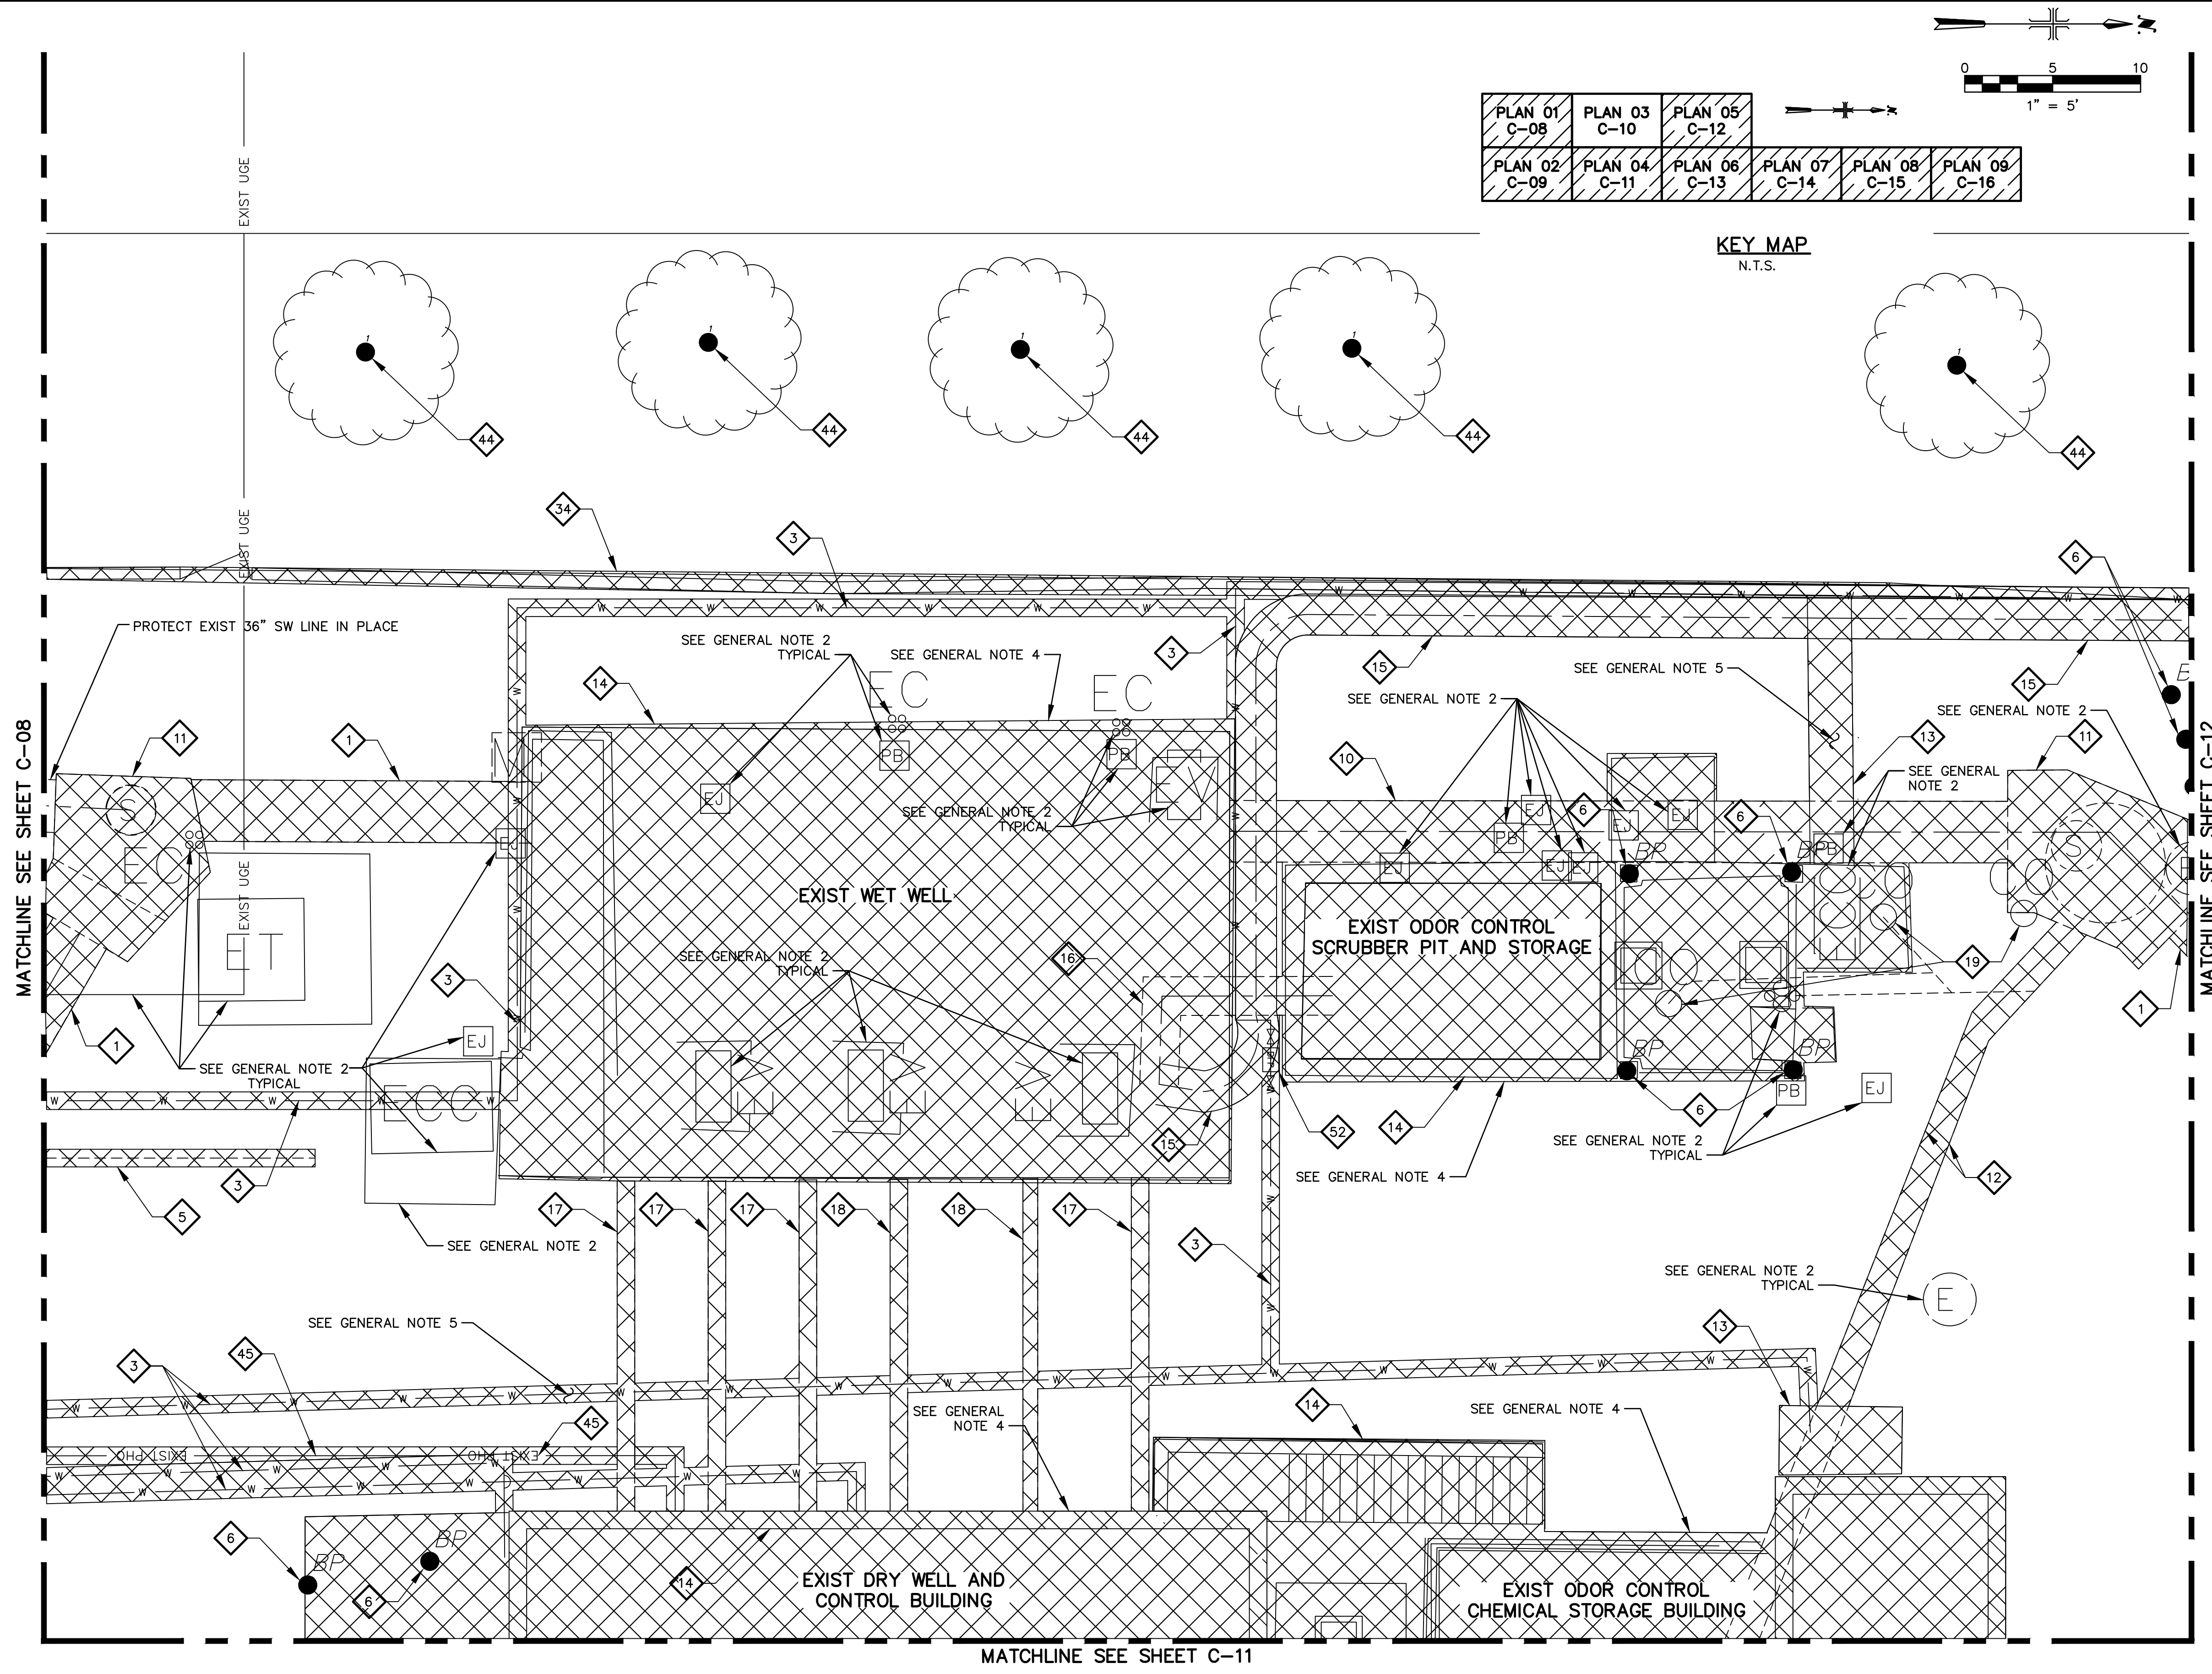

PLAN 01 C-08	PLAN 03 C-10	PLAN 05 C-12	PLAN 07 C-14	PLAN 08 C-15	PLAN 09 C-16
PLAN 02 C-09	PLAN 04 C-11	PLAN 06 C-13	PLAN 07 C-14	PLAN 08 C-15	PLAN 09 C-16

KEY MAP  
N.T.S.

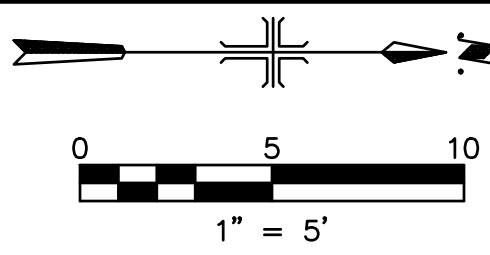

KEY NOTES

- 1 REMOVE EXIST 42" SW LINE.
- 3 REMOVE EXIST 3" WATER LINE.
- 5 REMOVE EXIST 6" PVC SW LINE.
- 6 REMOVE EXIST BOLLARD.
- 10 REMOVE EXIST 42" SW LINE.
- 11 REMOVE EXIST SW STRUCTURE.
- 12 REMOVE EXIST 3" AND 4" DRAIN LINES FROM THE EXIST BUILDING SUMP AND DRY WELL.
- 13 REMOVE EXIST CONCRETE SLAB.
- 14 REMOVE EXIST STRUCTURE AND ALL APPURTENANCES ASSOCIATED WITH THE STRUCTURE. COORDINATE WITH THE CITY OF PHOENIX TO MOVE TO A DESIGNATED LOCATION.
- 15 REMOVE EXIST 28" FOUL AIR DUCT.
- 16 REMOVE EXIST 30" FOUL AIR DUCT.
- 17 REMOVE EXIST 12" SW LINE.
- 18 REMOVE EXIST 10" SW LINE.
- 19 REMOVE EXIST SW CLEANOUT.
- 34 REMOVE EXIST 8" CMU WALL.
- 44 REMOVE EXIST TREE. CUT AND CAP IRRIGATION LINE.
- 45 REMOVE EXIST TELEPHONE LINE.
- 52 REMOVE EXIST BACKFLOW PREVENTER.

LEGEND


- DEMOLITION OF EXIST UTILITIES AND EXIST STRUCTURES WITH ALL APPURTENANCES AND CONCRETE SLABS. SEE GENERAL NOTE 4 AND 7.
- ABANDONMENT OF EXIST UTILITIES. SEE GENERAL NOTE 6.

GENERAL NOTE


1. CONTRACTOR TO VERIFY SIZE AND LOCATION OF THE EXIST UTILITY LINES, VALVES, AND METERS PRIOR TO RELOCATION AND ABANDONMENT.
2. ALL EXIST ELECTRICAL LINES, EQUIPMENT, CONCRETE PADS AND MANHOLES ARE SHOWN AS PART OF THE SURVEY AND THE OWNER'S UTILITY MAP. FOR ALL ELECTRICAL DEMOLITION, RELOCATION AND ABANDONMENT OF ANY AND ALL ELECTRICAL LINES, EQUIPMENT, CONCRETE PADS AND MANHOLES SEE ELECTRICAL PLANS.
3. FOR CONTINUATION OF DEMOLITION SEE SHEET C-08, SHEET C-09, SHEET C-11, SHEET C-12 AND SHEET C-13.
4. FOR ALL EXIST STRUCTURES THE CONTRACTOR SHALL REFER TO SPECIFICATION 01 11 00 - SUMMARY OF WORK FOR SEQUENCE OF DEMOLITION AND CONSTRUCTION. COORDINATE WITH THE CITY OF PHOENIX FOR SALVAGING ANY ITEMS AND FOR SPECIAL INSTRUCTIONS. COMPACT VOIDED AREA TO 95% DENSITY.
5. CONTRACTOR TO REMOVE EXIST AC PAVEMENT AND CONCRETE AND REPLACE IN-KIND. BEFORE REPLACING ANY NEW AC PAVEMENT AND NEW CONCRETE REFER TO THE CIVIL SHEETS FOR ALL NEW BURIED UTILITY CONSTRUCTION.
6. ITEMS CALLED OUT TO BE ABANDONED CAN BE REMOVED FOR CONTRACTOR'S CONVENIENCE AT NO ADDITIONAL COST TO THE CITY.
7. ITEMS CALLED OUT TO BE REMOVED SHALL BE REMOVED A MINIMUM OF 2' VERTICALLY AND 6' HORIZONTALLY FROM NEW WORK TO BE INSTALLED.

FACILITY DRAWINGS  
This drawing was supplied by a Consultant Engineer from a paper based on information provided by the Contractor to provide the Record Drawing. The City does not warrant this drawing to be a complete and accurate portrayal of facilities as they exist in the field.

REVISION	DATE	PROJECT NAME	DWG NUMBER	REMARKS

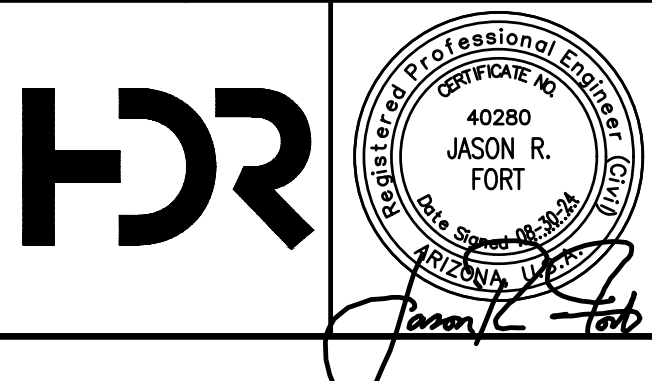

NO.	BY	DATE	CKD	REMARKS
A	RS	10/2023	JF	30% SUBMITTAL
B	RS	01/2024	JF	90% SUBMITTAL
C	RS	04/2024	JF	AGENCY REVIEW
D	DFD	08/2024	JF	ISSUED FOR CONSTRUCTION
*				
*				
*				

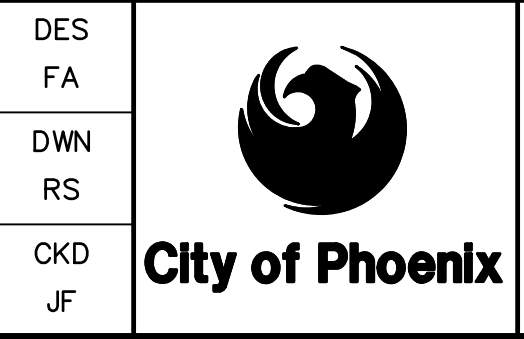

CITY OF PHOENIX  
WATER SERVICES DEPARTMENT  
  
LIFT STATION 40  
REFURBISHMENT


CIVIL  
  
DEMOLITION PLAN 03

COPYRIGHT © 2007-JANUARY  
CITY PROJECT NO. WS90400085  
DATE: 08/2024  
C-10 SHEET 15 OF 134  
CAD FILE: CSCLS40M03.dwg

THIS DRAWING MUST BE FIELD VERIFIED BEFORE USE  
DRAWING NOT TO SCALE UNLESS SCALE BAR IS PRESENT

FOR CONSTRUCTION

"PER CITY OF PHOENIX CODE CHAPTER 2, SECTION 2-28, THESE PLANS ARE FOR OFFICIAL USE ONLY AND MAY NOT BE SHARED WITH OTHERS EXCEPT AS REQUIRED TO FULFILL THE OBLIGATIONS OF THE CONTRACTOR'S CONTRACT WITH THE CITY OF PHOENIX."  
THIS DOCUMENT MUST BE KEPT SECURE AT ALL TIMES.

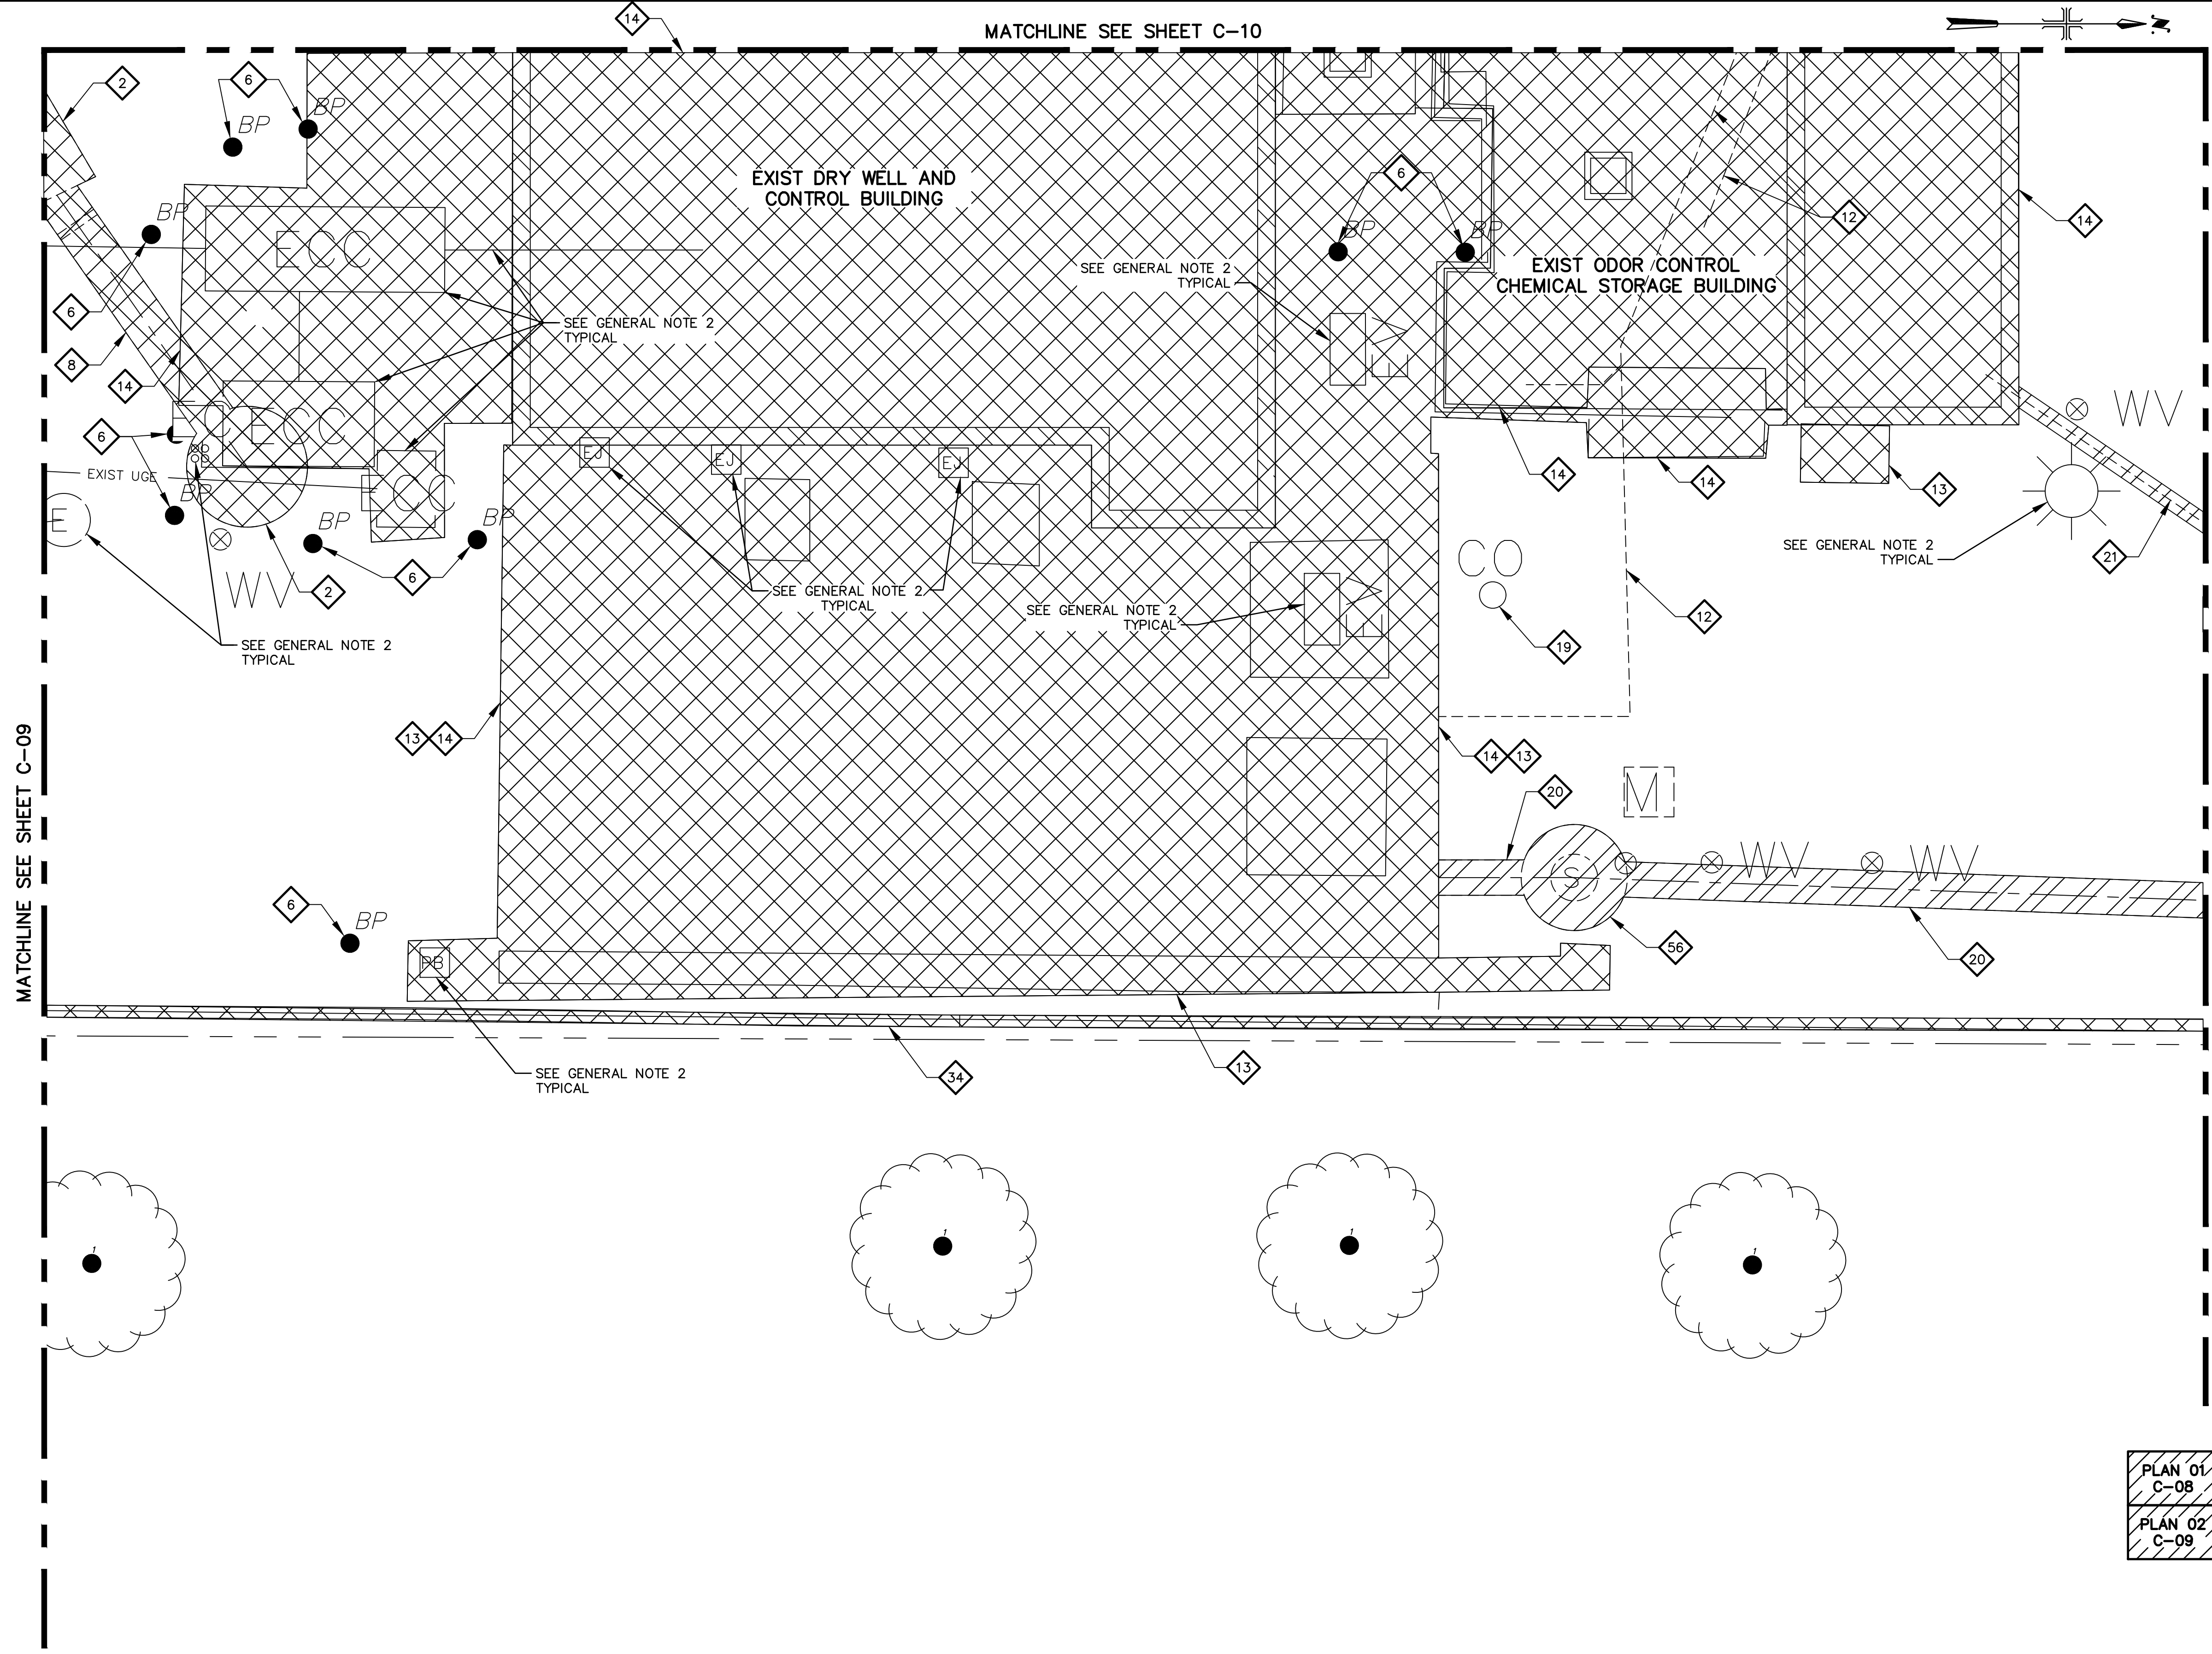

**KEY NOTES**

- 2 REMOVE EXIST SW STRUCTURE.
- 6 REMOVE EXIST BOLLARD.
- 8 REMOVE EXIST 30" SW LINE.
- 11 REMOVE EXIST SW STRUCTURE.
- 12 REMOVE EXIST 3" AND 4" DRAIN LINES FROM THE EXIST BUILDING SUMP AND DRY WELL.
- 13 REMOVE EXIST CONCRETE SLAB.
- 14 REMOVE EXIST STRUCTURE AND ALL APPURTENANCES ASSOCIATED WITH THE STRUCTURE. COORDINATE WITH THE CITY OF PHOENIX TO MOVE TO A DESIGNATED LOCATION.
- 19 REMOVE EXIST SW CLEANOUT.
- 20 ABANDON EXIST 36" SW LINE IN PLACE.
- 21 ABANDON 2" CHEMICAL FEED INSIDE 4" PVC CONTAINMENT PIPE IN PLACE.
- 34 REMOVE EXIST CMU WALL.
- 56 ABANDON EXIST SW STRUCTURE IN PLACE AND FILL WITH CLSM.

**LEGEND**


- DEMOLITION OF EXIST UTILITIES AND EXIST STRUCTURES WITH ALL APPURTENANCES AND CONCRETE SLABS. SEE GENERAL NOTE 4 AND 7.
- ABANDONMENT OF EXIST UTILITIES. SEE GENERAL NOTE 6.

**GENERAL NOTE**

1. CONTRACTOR TO VERIFY SIZE AND LOCATION OF THE EXIST UTILITY LINES, VALVES, AND METERS PRIOR TO RELOCATION AND ABANDONMENT.
2. ALL EXIST ELECTRICAL LINES, EQUIPMENT, CONCRETE PADS AND MANHOLES ARE SHOWN AS PART OF THE SURVEY AND THE OWNER'S UTILITY MAP. FOR ALL ELECTRICAL DEMOLITION, RELOCATION AND ABANDONMENT OF ANY AND ALL ELECTRICAL LINES, EQUIPMENT, CONCRETE PADS AND MANHOLES SEE ELECTRICAL PLANS.
3. FOR CONTINUATION OF DEMOLITION SEE SHEET C-08, SHEET C-09, SHEET C-10, SHEET C-12 AND SHEET C-13.
4. FOR ALL EXIST STRUCTURES THE CONTRACTOR SHALL REFER TO SPECIFICATION 01 11 00 - SUMMARY OF WORK FOR SEQUENCE OF DEMOLITION AND CONSTRUCTION. COORDINATE WITH THE CITY OF PHOENIX FOR SALVAGING ANY ITEMS AND FOR SPECIAL INSTRUCTIONS. COMPACT VOIDED AREA TO 95% DENSITY.
5. CONTRACTOR TO REMOVE EXIST AC PAVEMENT AND CONCRETE AND REPLACE IN-KIND. BEFORE REPLACING ANY NEW AC PAVEMENT AND NEW CONCRETE REFER TO THE CIVIL SHEETS FOR ALL NEW BURIED UTILITY CONSTRUCTION.
6. ITEMS CALLED OUT TO BE ABANDONED CAN BE REMOVED FOR CONTRACTOR'S CONVENIENCE AT NO ADDITIONAL COST TO THE CITY.
7. ITEMS CALLED OUT TO BE REMOVED SHALL BE REMOVED A MINIMUM OF 2' VERTICALLY AND 6' HORIZONTALLY FROM NEW WORK TO BE INSTALLED.


PLAN 01 C-08	PLAN 03 C-10	PLAN 05 C-12			
PLAN 02 C-09	PLAN 04 C-11	PLAN 06 C-13	PLAN 07 C-14	PLAN 08 C-15	PLAN 09 C-16

**KEY MAP**

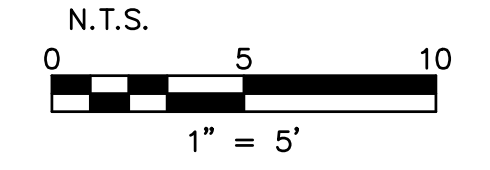


FACILITY DRAWINGS  
 This drawing was supplied by a Consultant Engineer from a past construction project. The City of Phoenix is providing this drawing for information only. The City does not warrant this drawing to be a complete and accurate portrayal of facilities as they exist in the field.

REVISION	DWG NUMBER	CAD FILE NAME	DATE	PROJECT NAME	PROJECT NO.	REFERENCE CID NUMBER: #	REMARKS

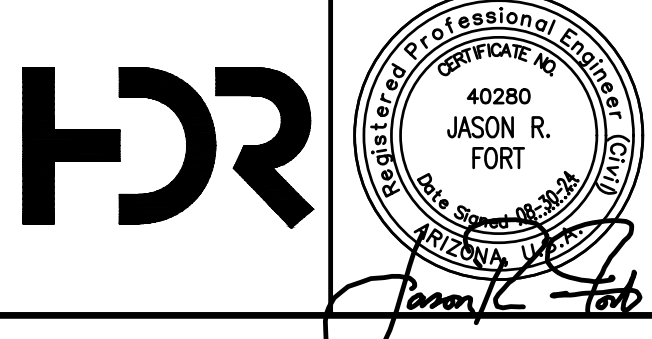

NO.	BY	DATE	CKD	REVISIONS	REMARKS
A	RS	10/2023	JF	30% SUBMITTAL	
B	RS	01/2024	JF	90% SUBMITTAL	
C	RS	04/2024	JF	AGENCY REVIEW	
D	DFD	08/2024	JF	ISSUED FOR CONSTRUCTION	
*					
*					
*					

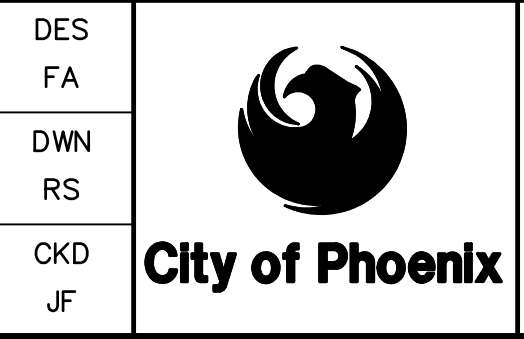

CITY OF PHOENIX  
WATER SERVICES DEPARTMENT  
  
LIFT STATION 40  
REFURBISHMENT

CIVIL  
  
DEMOLITION PLAN 04

COPYRIGHT © 2007-JANUARY  
CITY PROJECT NO. WS90400085  
DATE: 08/2024  
C-11 SHEET 16 OF 134  
CAD FILE: CSCLS40M04.dwg


USER: FIDESRFAUD FILE: C:\pwworking\west01\03411640\16\_CSCLS40M04.dwg DATE: 9/04/24 TIME: 03:18pm



THIS DRAWING MUST BE FIELD VERIFIED BEFORE USE  
DRAWING NOT TO SCALE UNLESS SCALE BAR IS PRESENT

FOR CONSTRUCTION

"PER CITY OF PHOENIX CODE CHAPTER 2, SECTION 2-28, THESE PLANS ARE FOR OFFICIAL USE ONLY AND MAY NOT BE SHARED WITH OTHERS EXCEPT AS REQUIRED TO FULFILL THE OBLIGATIONS OF THE CONTRACTOR'S CONTRACT WITH THE CITY OF PHOENIX."  
THIS DOCUMENT MUST BE KEPT SECURE AT ALL TIMES.

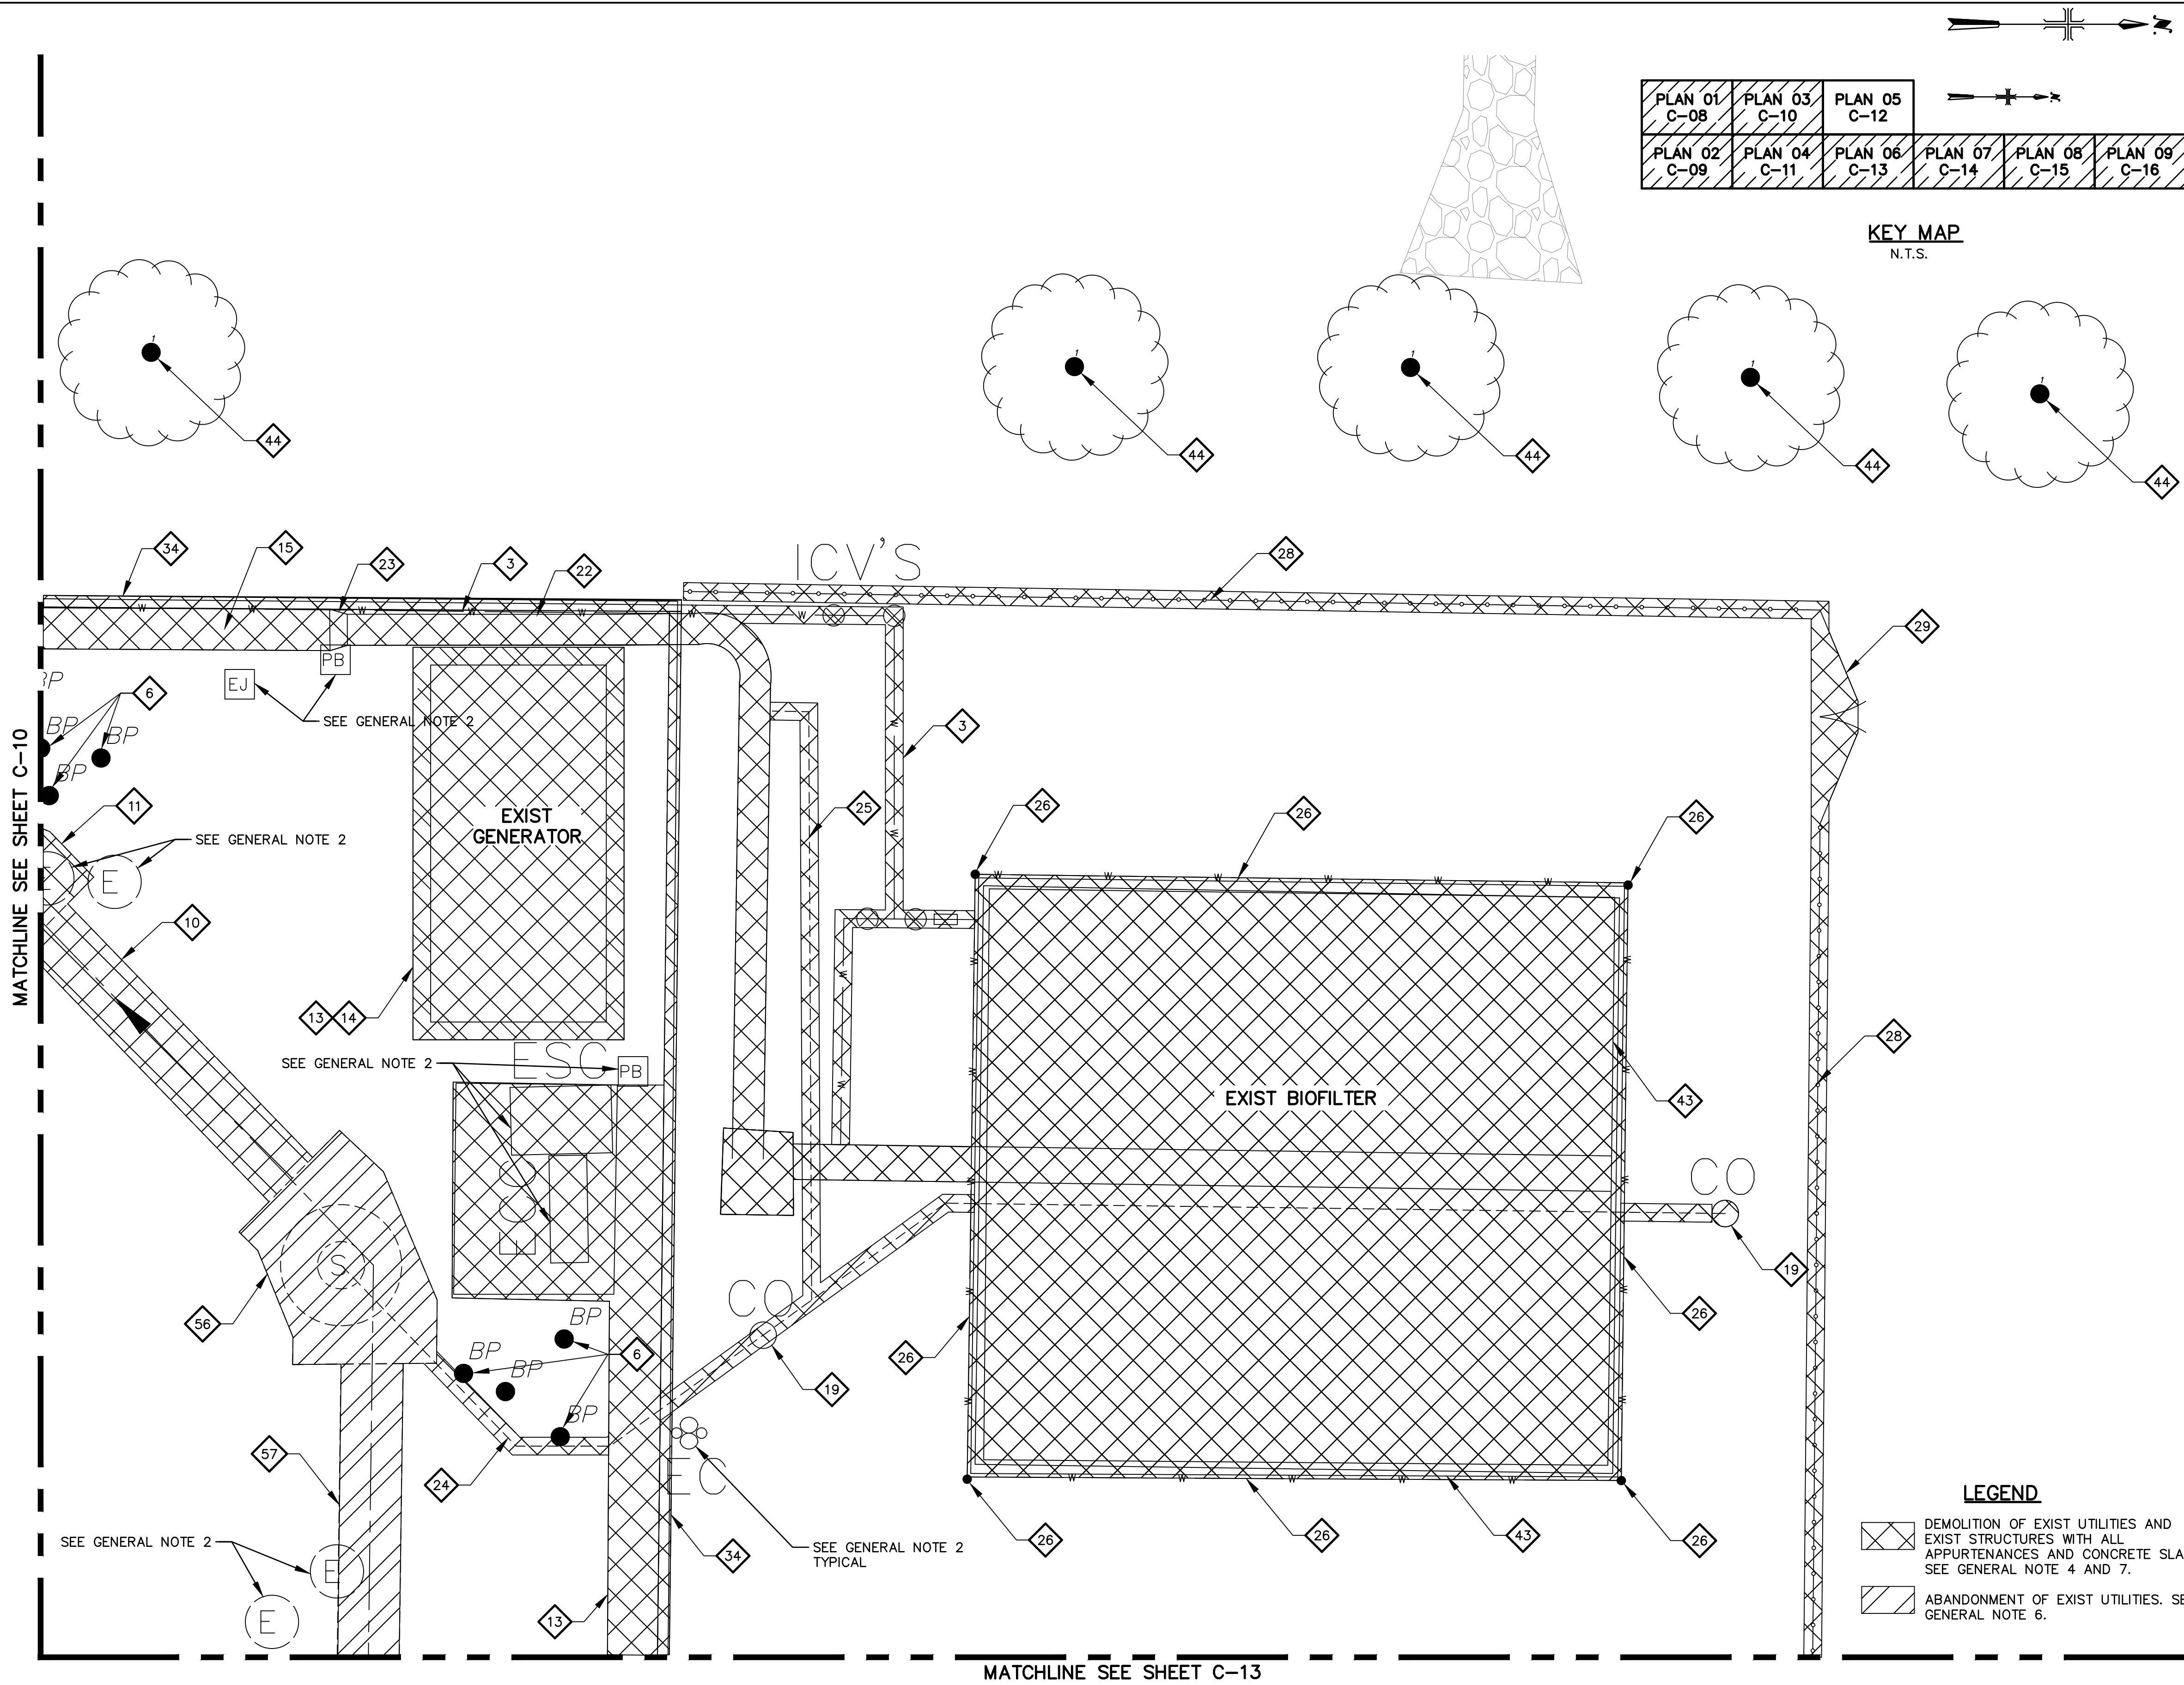


- KEY NOTES**
- 3 REMOVE EXIST 3" WATER LINE.
  - 6 REMOVE EXIST BOLLARD.
  - 10 REMOVE EXIST 42" SW LINE.
  - 11 REMOVE EXIST SW STRUCTURE.
  - 13 REMOVE EXIST CONCRETE SLAB.
  - 14 REMOVE EXIST STRUCTURE AND ALL APPURTENANCES ASSOCIATED WITH THE STRUCTURE. COORDINATE WITH THE CITY OF PHOENIX TO MOVE TO A DESIGNATED LOCATION.
  - 15 REMOVE EXIST 28" FAD.
  - 19 REMOVE EXIST SW CLEANOUT.
  - 22 REMOVE EXIST 24" FAD.
  - 23 REMOVE FAD 28"x21" REDUCER.
  - 24 REMOVE EXIST 8" DRAIN LINE.
  - 25 REMOVE EXIST 1" DRAIN LINE.
  - 26 REMOVE EXIST 1" SERVICE WATER LINE AND SPRINKLER HEADS.
  - 28 REMOVE EXIST CHAIN LINK FENCE.
  - 29 REMOVE EXIST 20' VEHICULAR SWING GATE.
  - 34 REMOVE EXIST 8" CMU WALL.
  - 43 REMOVE EXIST BIOFILTER MEDIA, AIR DISTRIBUTION PIPING, BIOFILTER CONCRETE STRUCTURE.
  - 44 REMOVE EXIST TREE. CUT AND CAP IRRIGATION LINE.
  - 56 ABANDON EXIST SW STRUCTURE IN PLACE AND FILL WITH CLSM.
  - 57 ABANDON EXIST 42" SW LINE IN PLACE.

- GENERAL NOTE**
1. CONTRACTOR TO VERIFY SIZE AND LOCATION OF THE EXIST UTILITY LINES, VALVES, AND METERS PRIOR TO RELOCATION AND ABANDONMENT.
  2. ALL EXIST ELECTRICAL LINES, EQUIPMENT, CONCRETE PADS AND MANHOLES ARE SHOWN AS PART OF THE SURVEY AND THE OWNER'S UTILITY MAP. FOR ALL ELECTRICAL DEMOLITION, RELOCATION AND ABANDONMENT OF ANY AND ALL ELECTRICAL LINES, EQUIPMENT, CONCRETE PADS AND MANHOLES SEE ELECTRICAL PLANS.
  3. FOR CONTINUATION OF DEMOLITION SEE SHEET C-10, SHEET C-11 AND SHEET C-13.
  4. FOR ALL EXIST STRUCTURES THE CONTRACTOR SHALL REFER TO SPECIFICATION 01 11 00 - SUMMARY OF WORK FOR SEQUENCE OF DEMOLITION AND CONSTRUCTION. COORDINATE WITH THE CITY OF PHOENIX FOR SALVAGING ANY ITEMS AND FOR SPECIAL INSTRUCTIONS. COMPACT VOIDED AREA TO 95% DENSITY.
  5. CONTRACTOR TO REMOVE EXIST AC PAVEMENT AND CONCRETE AND REPLACE IN-KIND, BEFORE REPLACING ANY NEW AC PAVEMENT AND NEW CONCRETE REFER TO THE CIVIL SHEETS FOR ALL NEW BURIED UTILITY CONSTRUCTION.
  6. ITEMS CALLED OUT TO BE ABANDONED CAN BE REMOVED FOR CONTRACTOR'S CONVENIENCE AT NO ADDITIONAL COST TO THE CITY.
  7. ITEMS CALLED OUT TO BE REMOVED SHALL BE REMOVED A MINIMUM OF 2' VERTICALLY AND 6' HORIZONTALLY FROM NEW WORK TO BE INSTALLED.

**LEGEND**


DEMOLITION OF EXIST UTILITIES AND EXIST STRUCTURES WITH ALL APPURTENANCES AND CONCRETE SLABS. SEE GENERAL NOTE 4 AND 7.

ABANDONMENT OF EXIST UTILITIES. SEE GENERAL NOTE 6.

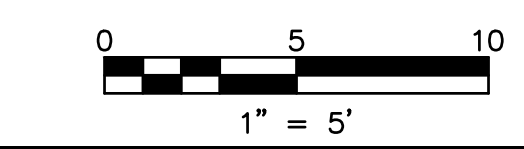


FACILITY DRAWINGS  
This drawing was supplied by a Consultant Engineer from a past project and is not intended for construction. The Contractor shall verify the information provided by the Contractor to provide a complete and accurate portrayal of facilities as they exist in the field.  
The City does not warrant this drawing to be a complete and accurate portrayal of facilities as they exist in the field.

REVISION #	DATE	PROJECT NAME	PROJECT NO.	PROJECT NAME	DATE	CAD FILE NAME	REMARKS

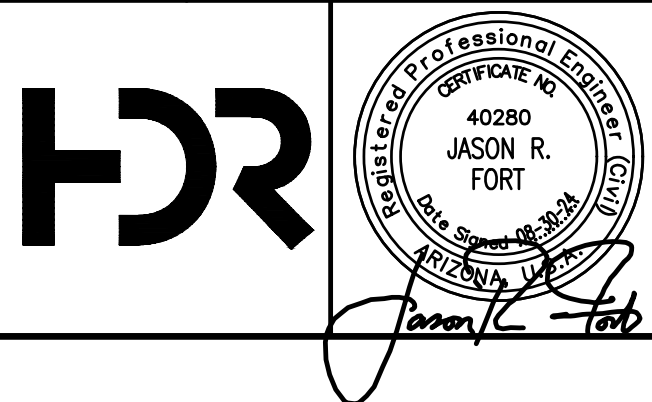

NO.	BY	DATE	CKD	REVISIONS	REMARKS
A	RS	10/2023	JF	30% SUBMITTAL	
B	RS	01/2024	JF	90% SUBMITTAL	
C	RS	04/2024	JF	AGENCY REVIEW	
D	DFD	08/2024	JF	ISSUED FOR CONSTRUCTION	

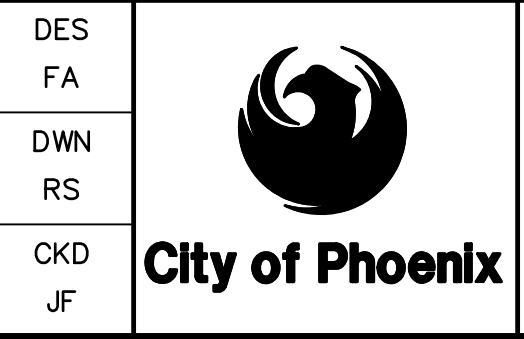

CITY OF PHOENIX  
WATER SERVICES DEPARTMENT

LIFT STATION 40  
REFURBISHMENT

CIVIL

DEMOLITION PLAN 05

COPYRIGHT © 2007-JANUARY

CITY PROJECT NO. WS90400085

DATE: 08/2024


C-12 SHEET 17 OF 134

CAD FILE: CSCLS40M05.dwg

THIS DRAWING MUST BE FIELD VERIFIED BEFORE USE  
DRAWING NOT TO SCALE UNLESS SCALE BAR IS PRESENT

FOR CONSTRUCTION



"PER CITY OF PHOENIX CODE CHAPTER 2, SECTION 2-28, THESE PLANS ARE FOR OFFICIAL USE ONLY AND MAY NOT BE SHARED WITH OTHERS EXCEPT AS REQUIRED TO FULFILL THE OBLIGATIONS OF THE CONTRACTOR'S CONTRACT WITH THE CITY OF PHOENIX."  
THIS DOCUMENT MUST BE KEPT SECURE AT ALL TIMES.

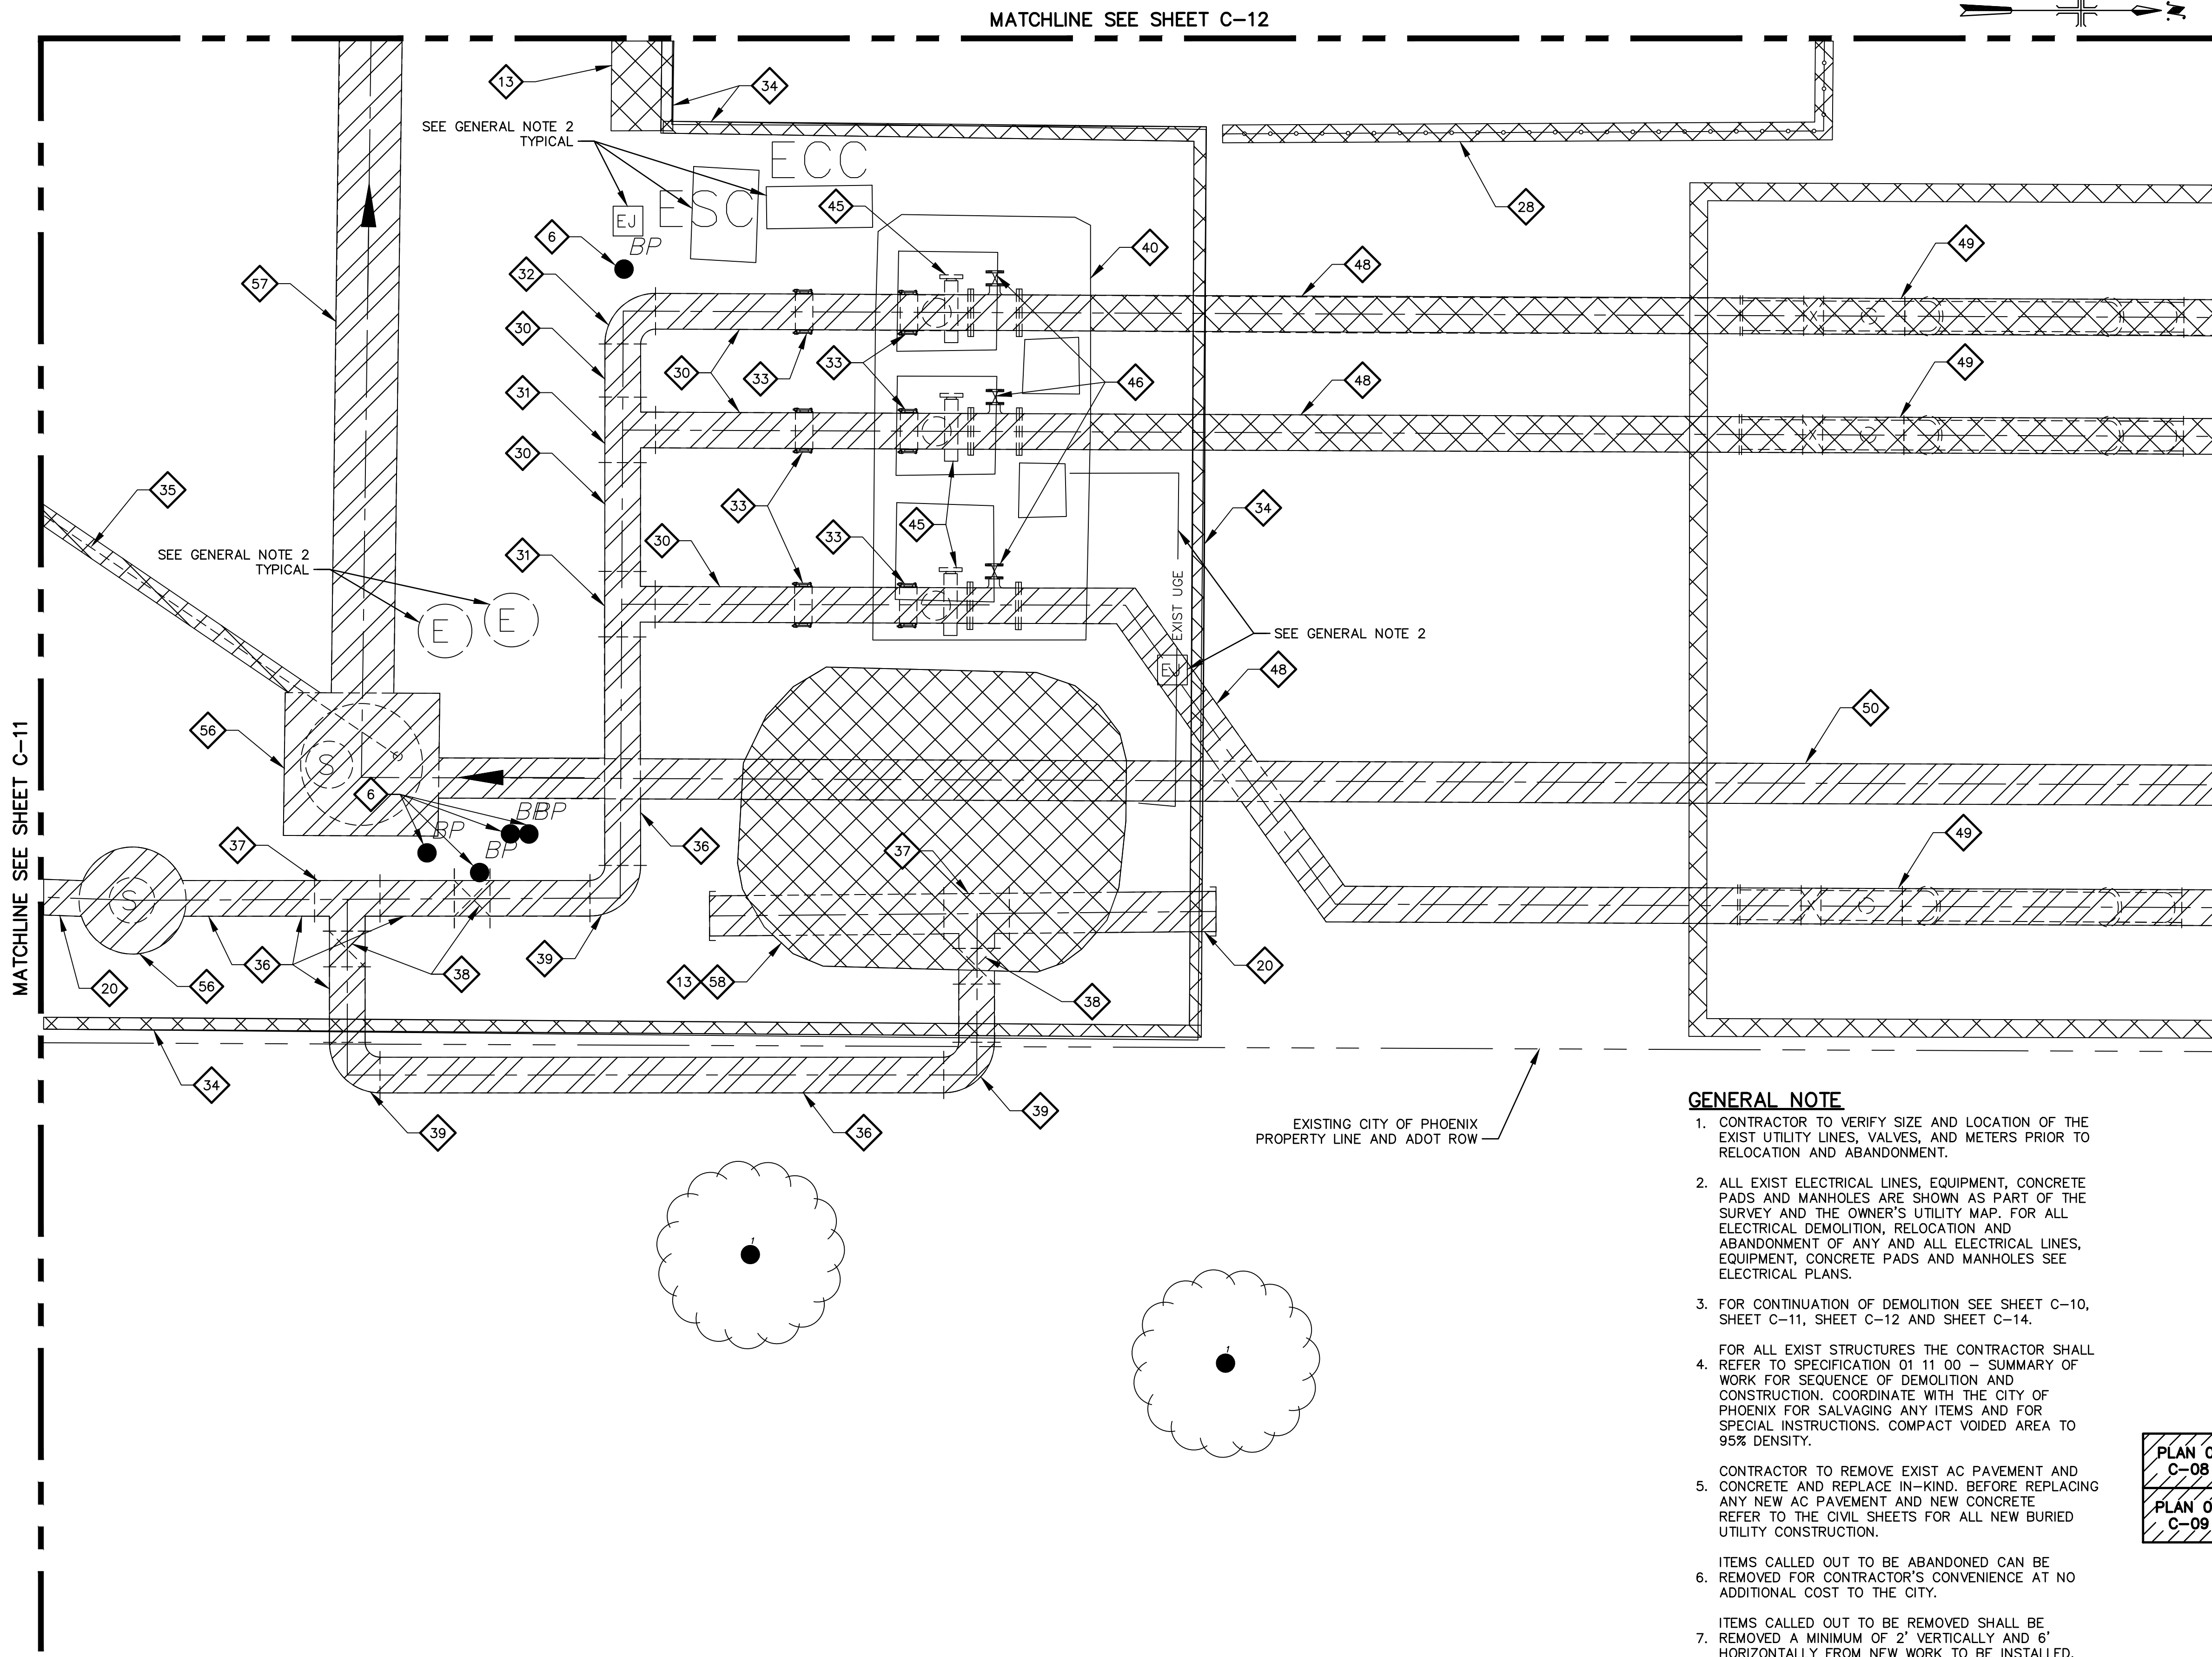

- ### KEY NOTES
- 6 REMOVE EXIST BOLLARD.
  - 10 REMOVE EXIST 42" SW LINE IN PLACE.
  - 11 REMOVE EXIST SW STRUCTURE IN PLACE AND FILL WITH LOW STRENGTH GROUT.
  - 13 REMOVE EXIST CONCRETE SLAB.
  - 20 ABANDON EXIST 24" SW LINE IN PLACE.
  - 28 REMOVE EXIST CHAIN LINK FENCE IN PLACE.
  - 30 ABANDON EXIST 24" SW LINE IN PLACE.
  - 31 ABANDON EXIST 24"x24"x24" SW TEE.
  - 32 ABANDON EXIST 24" 90° SW BEND.
  - 33 REMOVE EXIST 24" FLEX COUPLING.
  - 34 REMOVE EXIST 8" CMU WALL.
  - 35 REMOVE EXIST SW DRAIN.
  - 36 ABANDON 24" SW LINE IN PLACE.
  - 37 ABANDON 24" SW TEE IN PLACE.
  - 38 ABANDON 24" SW VALVE IN PLACE.
  - 39 ABANDON 24" 90° BEND IN PLACE.
  - 40 ABANDON EXIST FORCE MAIN WASTE VAULT.
  - 45 REMOVE EXIST 24" PLUG VALVE.
  - 46 REMOVE EXIST 6" GATE VALVE.
  - 48 REMOVE EXIST 24" FORCE MAIN.
  - 49 REMOVE EXIST PIG LAUNCHING STATION.
  - 50 ABANDON EXIST 27" SW PIPE IN PLACE.
  - 56 ABANDON EXIST SW STRUCTURE IN PLACE AND FILL WITH CLSM.
  - 57 ABANDON EXIST 42" SW LINE IN PLACE.
  - 58 REMOVE EXIST FERROUS CHLORIDE SYSTEM. CONTRACTOR TO DRAIN RESIDUAL CHEMICALS. FLUSH AND DISPOSE OF RINSATE FOR TANKS, PIPING, PUMPS, ETC.


- ### GENERAL NOTE
1. CONTRACTOR TO VERIFY SIZE AND LOCATION OF THE EXIST UTILITY LINES, VALVES, AND METERS PRIOR TO RELOCATION AND ABANDONMENT.
  2. ALL EXIST ELECTRICAL LINES, EQUIPMENT, CONCRETE PADS AND MANHOLES ARE SHOWN AS PART OF THE SURVEY AND THE OWNER'S UTILITY MAP. FOR ALL ELECTRICAL DEMOLITION, RELOCATION AND ABANDONMENT OF ANY AND ALL ELECTRICAL LINES, EQUIPMENT, CONCRETE PADS AND MANHOLES SEE ELECTRICAL PLANS.
  3. FOR CONTINUATION OF DEMOLITION SEE SHEET C-10, SHEET C-11, SHEET C-12 AND SHEET C-14.
  4. FOR ALL EXIST STRUCTURES THE CONTRACTOR SHALL REFER TO SPECIFICATION 01 11 00 - SUMMARY OF WORK FOR SEQUENCE OF DEMOLITION AND CONSTRUCTION. COORDINATE WITH THE CITY OF PHOENIX FOR SALVAGING ANY ITEMS AND FOR SPECIAL INSTRUCTIONS. COMPACT VOIDED AREA TO 95% DENSITY.
  5. CONTRACTOR TO REMOVE EXIST AC PAVEMENT AND CONCRETE AND REPLACE IN-KIND. BEFORE REPLACING ANY NEW AC PAVEMENT AND NEW CONCRETE REFER TO THE CIVIL SHEETS FOR ALL NEW BURIED UTILITY CONSTRUCTION.
  6. ITEMS CALLED OUT TO BE ABANDONED CAN BE REMOVED FOR CONTRACTOR'S CONVENIENCE AT NO ADDITIONAL COST TO THE CITY.
  7. ITEMS CALLED OUT TO BE REMOVED SHALL BE REMOVED A MINIMUM OF 2' VERTICALLY AND 6' HORIZONTALLY FROM NEW WORK TO BE INSTALLED.

- ### LEGEND
- DEMOLITION OF EXIST UTILITIES AND EXIST STRUCTURES WITH ALL APPURTENANCES AND CONCRETE SLABS. SEE GENERAL NOTE 4 AND 7.
  - ABANDONMENT OF EXIST UTILITIES. SEE GENERAL NOTE 6.

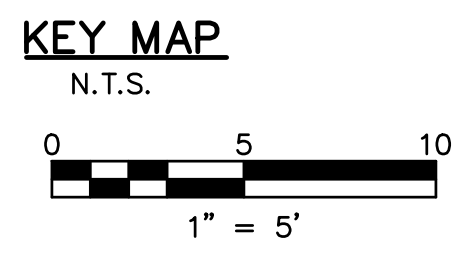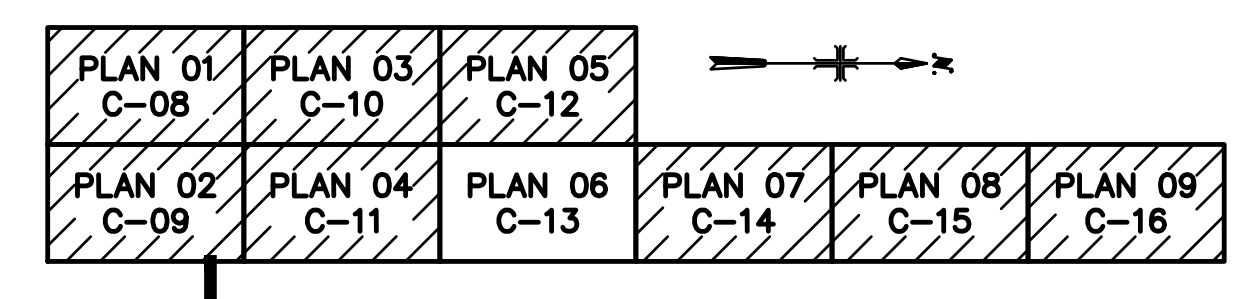


FACILITY DRAWINGS  
This drawing was supplied by a Consultant Engineer from a past project and is being provided for information only. The Contractor is responsible for providing the Record Drawing. The City does not warrant this drawing to be a complete and accurate portrayal of facilities as they exist in the field.

REVISION	DATE	PROJECT NO.	PROJECT NAME	DWG NUMBER	REMARKS

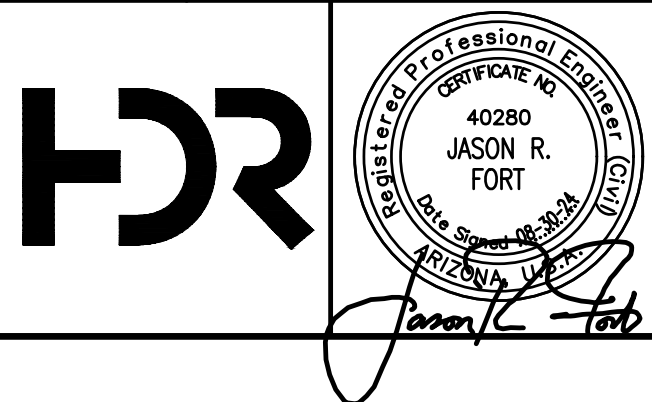

NO.	BY	DATE	CKD	REVISIONS	REMARKS
A	RS	10/2023	JF	30% SUBMITTAL	
B	RS	01/2024	JF	90% SUBMITTAL	
C	RS	04/2024	JF	AGENCY REVIEW	
D	DFD	08/2024	JF	ISSUED FOR CONSTRUCTION	
*					
*					
*					

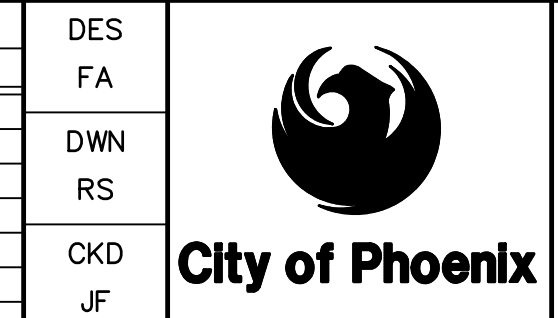

CITY OF PHOENIX  
WATER SERVICES DEPARTMENT

LIFT STATION 40  
REFURBISHMENT

CIVIL

DEMOLITION PLAN 06

COPYRIGHT © 2007-JANUARY

CITY PROJECT NO. WS90400085

DATE: 08/2024


C-13 SHEET 18 OF 134

CAD FILE: CSCLS40M06.dwg

**FOR CONSTRUCTION**

THIS DRAWING MUST BE FIELD VERIFIED BEFORE USE  
DRAWING NOT TO SCALE UNLESS SCALE BAR IS PRESENT

"PER CITY OF PHOENIX CODE CHAPTER 2, SECTION 2-28, THESE PLANS ARE FOR OFFICIAL USE ONLY AND MAY NOT BE SHARED WITH OTHERS EXCEPT AS REQUIRED TO FULFILL THE OBLIGATIONS OF THE CONTRACTOR'S CONTRACT WITH THE CITY OF PHOENIX."  
THIS DOCUMENT MUST BE KEPT SECURE AT ALL TIMES.

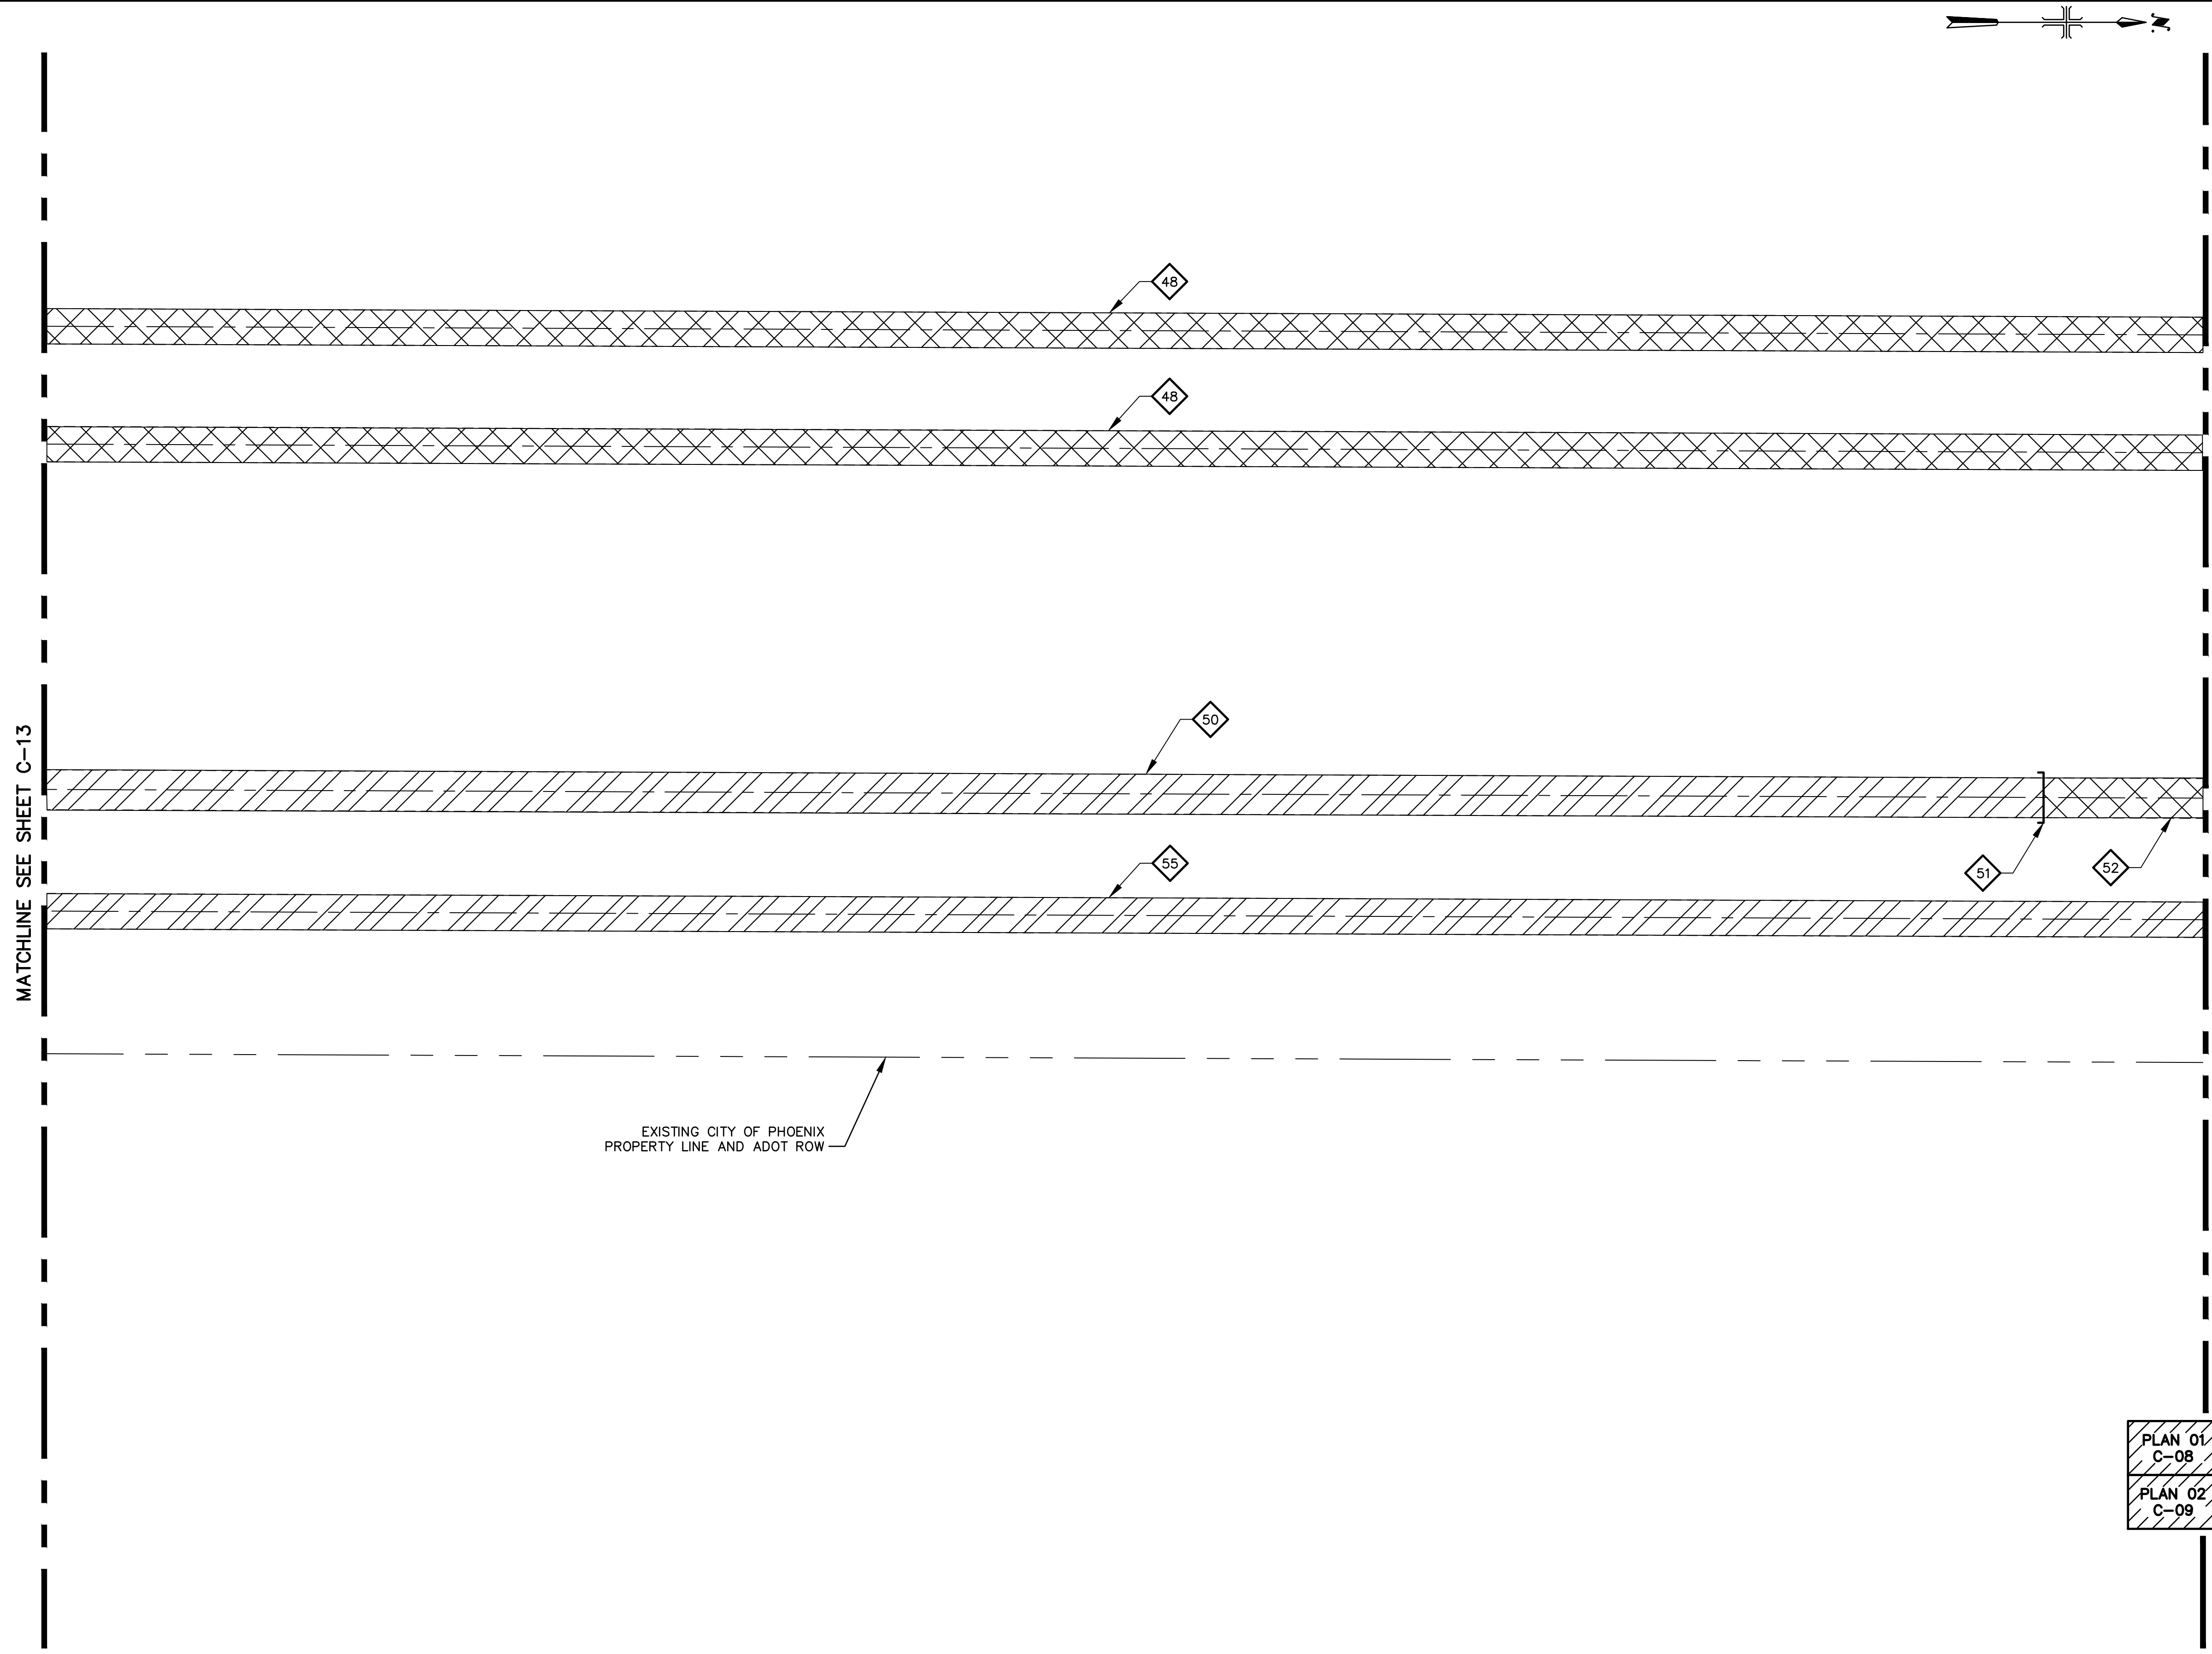

EXISTING CITY OF PHOENIX  
PROPERTY LINE AND ADOT ROW

**KEY NOTES**


- 48 REMOVE EXIST 24" FORCE MAIN.
- 50 ABANDON EXIST 27" SW PIPE IN PLACE.
- 51 CUT AND PLUG EXIST 27" SW PIPE.
- 52 REMOVE EXIST 27" SW PIPE.
- 55 ABANDON EXIST 24" FORCE MAIN IN PLACE.

**LEGEND**


- DEMOLITION OF EXIST UTILITIES AND EXIST STRUCTURES WITH ALL APPURTENANCES AND CONCRETE SLABS. SEE GENERAL NOTE 4 AND 7.
- ABANDONMENT OF EXIST UTILITIES. SEE GENERAL NOTE 6.

**GENERAL NOTE**

1. CONTRACTOR TO VERIFY SIZE AND LOCATION OF THE EXIST UTILITY LINES, VALVES, AND METERS PRIOR TO RELOCATION AND ABANDONMENT.
2. ALL EXIST ELECTRICAL LINES, EQUIPMENT, CONCRETE PADS AND MANHOLES ARE SHOWN AS PART OF THE SURVEY AND THE OWNER'S UTILITY MAP. FOR ALL ELECTRICAL DEMOLITION, RELOCATION AND ABANDONMENT OF ANY AND ALL ELECTRICAL LINES, EQUIPMENT, CONCRETE PADS AND MANHOLES SEE ELECTRICAL PLANS.
3. FOR CONTINUATION OF DEMOLITION SEE SHEET C-13, AND SHEET C-15.
4. FOR ALL EXIST STRUCTURES THE CONTRACTOR SHALL REFER TO SPECIFICATION 01 11 00 - SUMMARY OF WORK FOR SEQUENCE OF DEMOLITION AND CONSTRUCTION. COORDINATE WITH THE CITY OF PHOENIX FOR SALVAGING ANY ITEMS AND FOR SPECIAL INSTRUCTIONS. COMPACT VOIDED AREA TO 95% DENSITY.
5. CONTRACTOR TO REMOVE EXIST AC PAVEMENT AND CONCRETE AND REPLACE IN-KIND. BEFORE REPLACING ANY NEW AC PAVEMENT AND NEW CONCRETE REFER TO THE CIVIL SHEETS FOR ALL NEW BURIED UTILITY CONSTRUCTION.
6. ITEMS CALLED OUT TO BE ABANDONED CAN BE REMOVED FOR CONTRACTOR'S CONVENIENCE AT NO ADDITIONAL COST TO THE CITY.
7. ITEMS CALLED OUT TO BE REMOVED SHALL BE REMOVED A MINIMUM OF 2' VERTICALLY AND 6' HORIZONTALLY FROM NEW WORK TO BE INSTALLED.

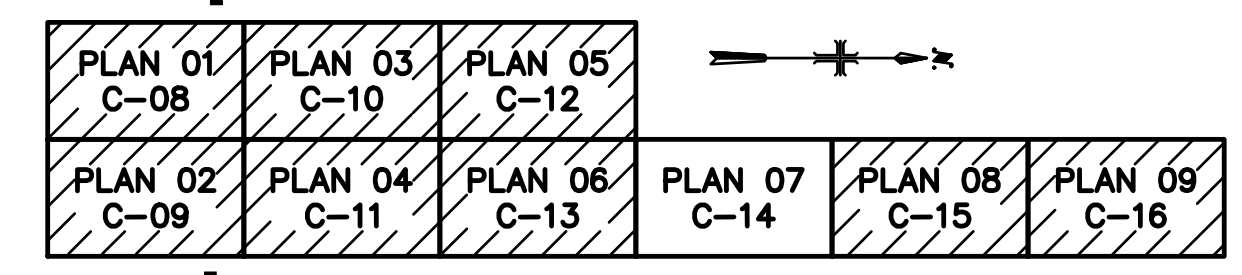


**KEY MAP**  
N.T.S.

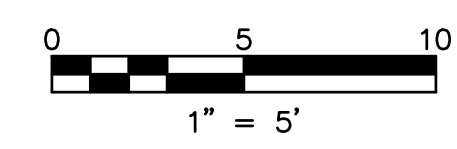


FACILITY DRAWINGS  
This drawing was supplied by a Consultant Engineer from a past construction project. The Consultant Engineer is not responsible for the construction information provided by the Contractor to provide the Record Drawing. The City does not warrant this drawing to be a complete and accurate portrayal of facilities as they exist in the field.

REVISION	DATE	CAD FILE NAME	DWG NUMBER	REMARKS
#				
#				
#				

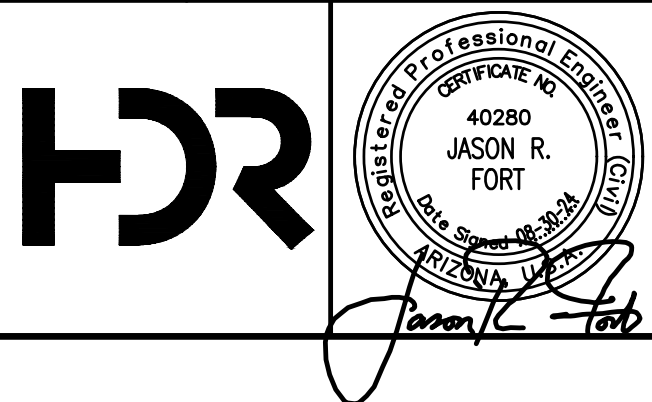

REVISIONS				
NO.	BY	DATE	CKD	REMARKS
A	RS	10/2023	JF	30% SUBMITTAL
B	RS	01/2024	JF	90% SUBMITTAL
C	RS	04/2024	JF	AGENCY REVIEW
D	DFD	08/2024	JF	ISSUED FOR CONSTRUCTION
*				
*				
*				

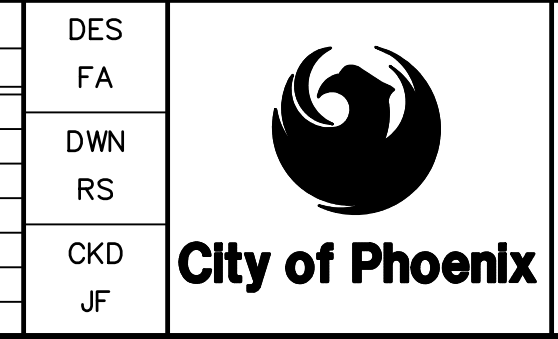

CITY OF PHOENIX  
WATER SERVICES DEPARTMENT  
  
LIFT STATION 40  
REFURBISHMENT


CIVIL  
  
DEMOLITION PLAN 07

COPYRIGHT © 2007-JANUARY  
CITY PROJECT NO. WS90400085  
DATE: 08/2024  
C-14 SHEET 19 OF 134  
CAD FILE: CSCLS40M07.dwg

**FOR CONSTRUCTION**

THIS DRAWING MUST BE FIELD VERIFIED BEFORE USE  
DRAWING NOT TO SCALE UNLESS SCALE BAR IS PRESENT



"PER CITY OF PHOENIX CODE CHAPTER 2, SECTION 2-28, THESE PLANS ARE FOR OFFICIAL USE ONLY AND MAY NOT BE SHARED WITH OTHERS EXCEPT AS REQUIRED TO FULFILL THE OBLIGATIONS OF THE CONTRACTOR'S CONTRACT WITH THE CITY OF PHOENIX."  
THIS DOCUMENT MUST BE KEPT SECURE AT ALL TIMES.

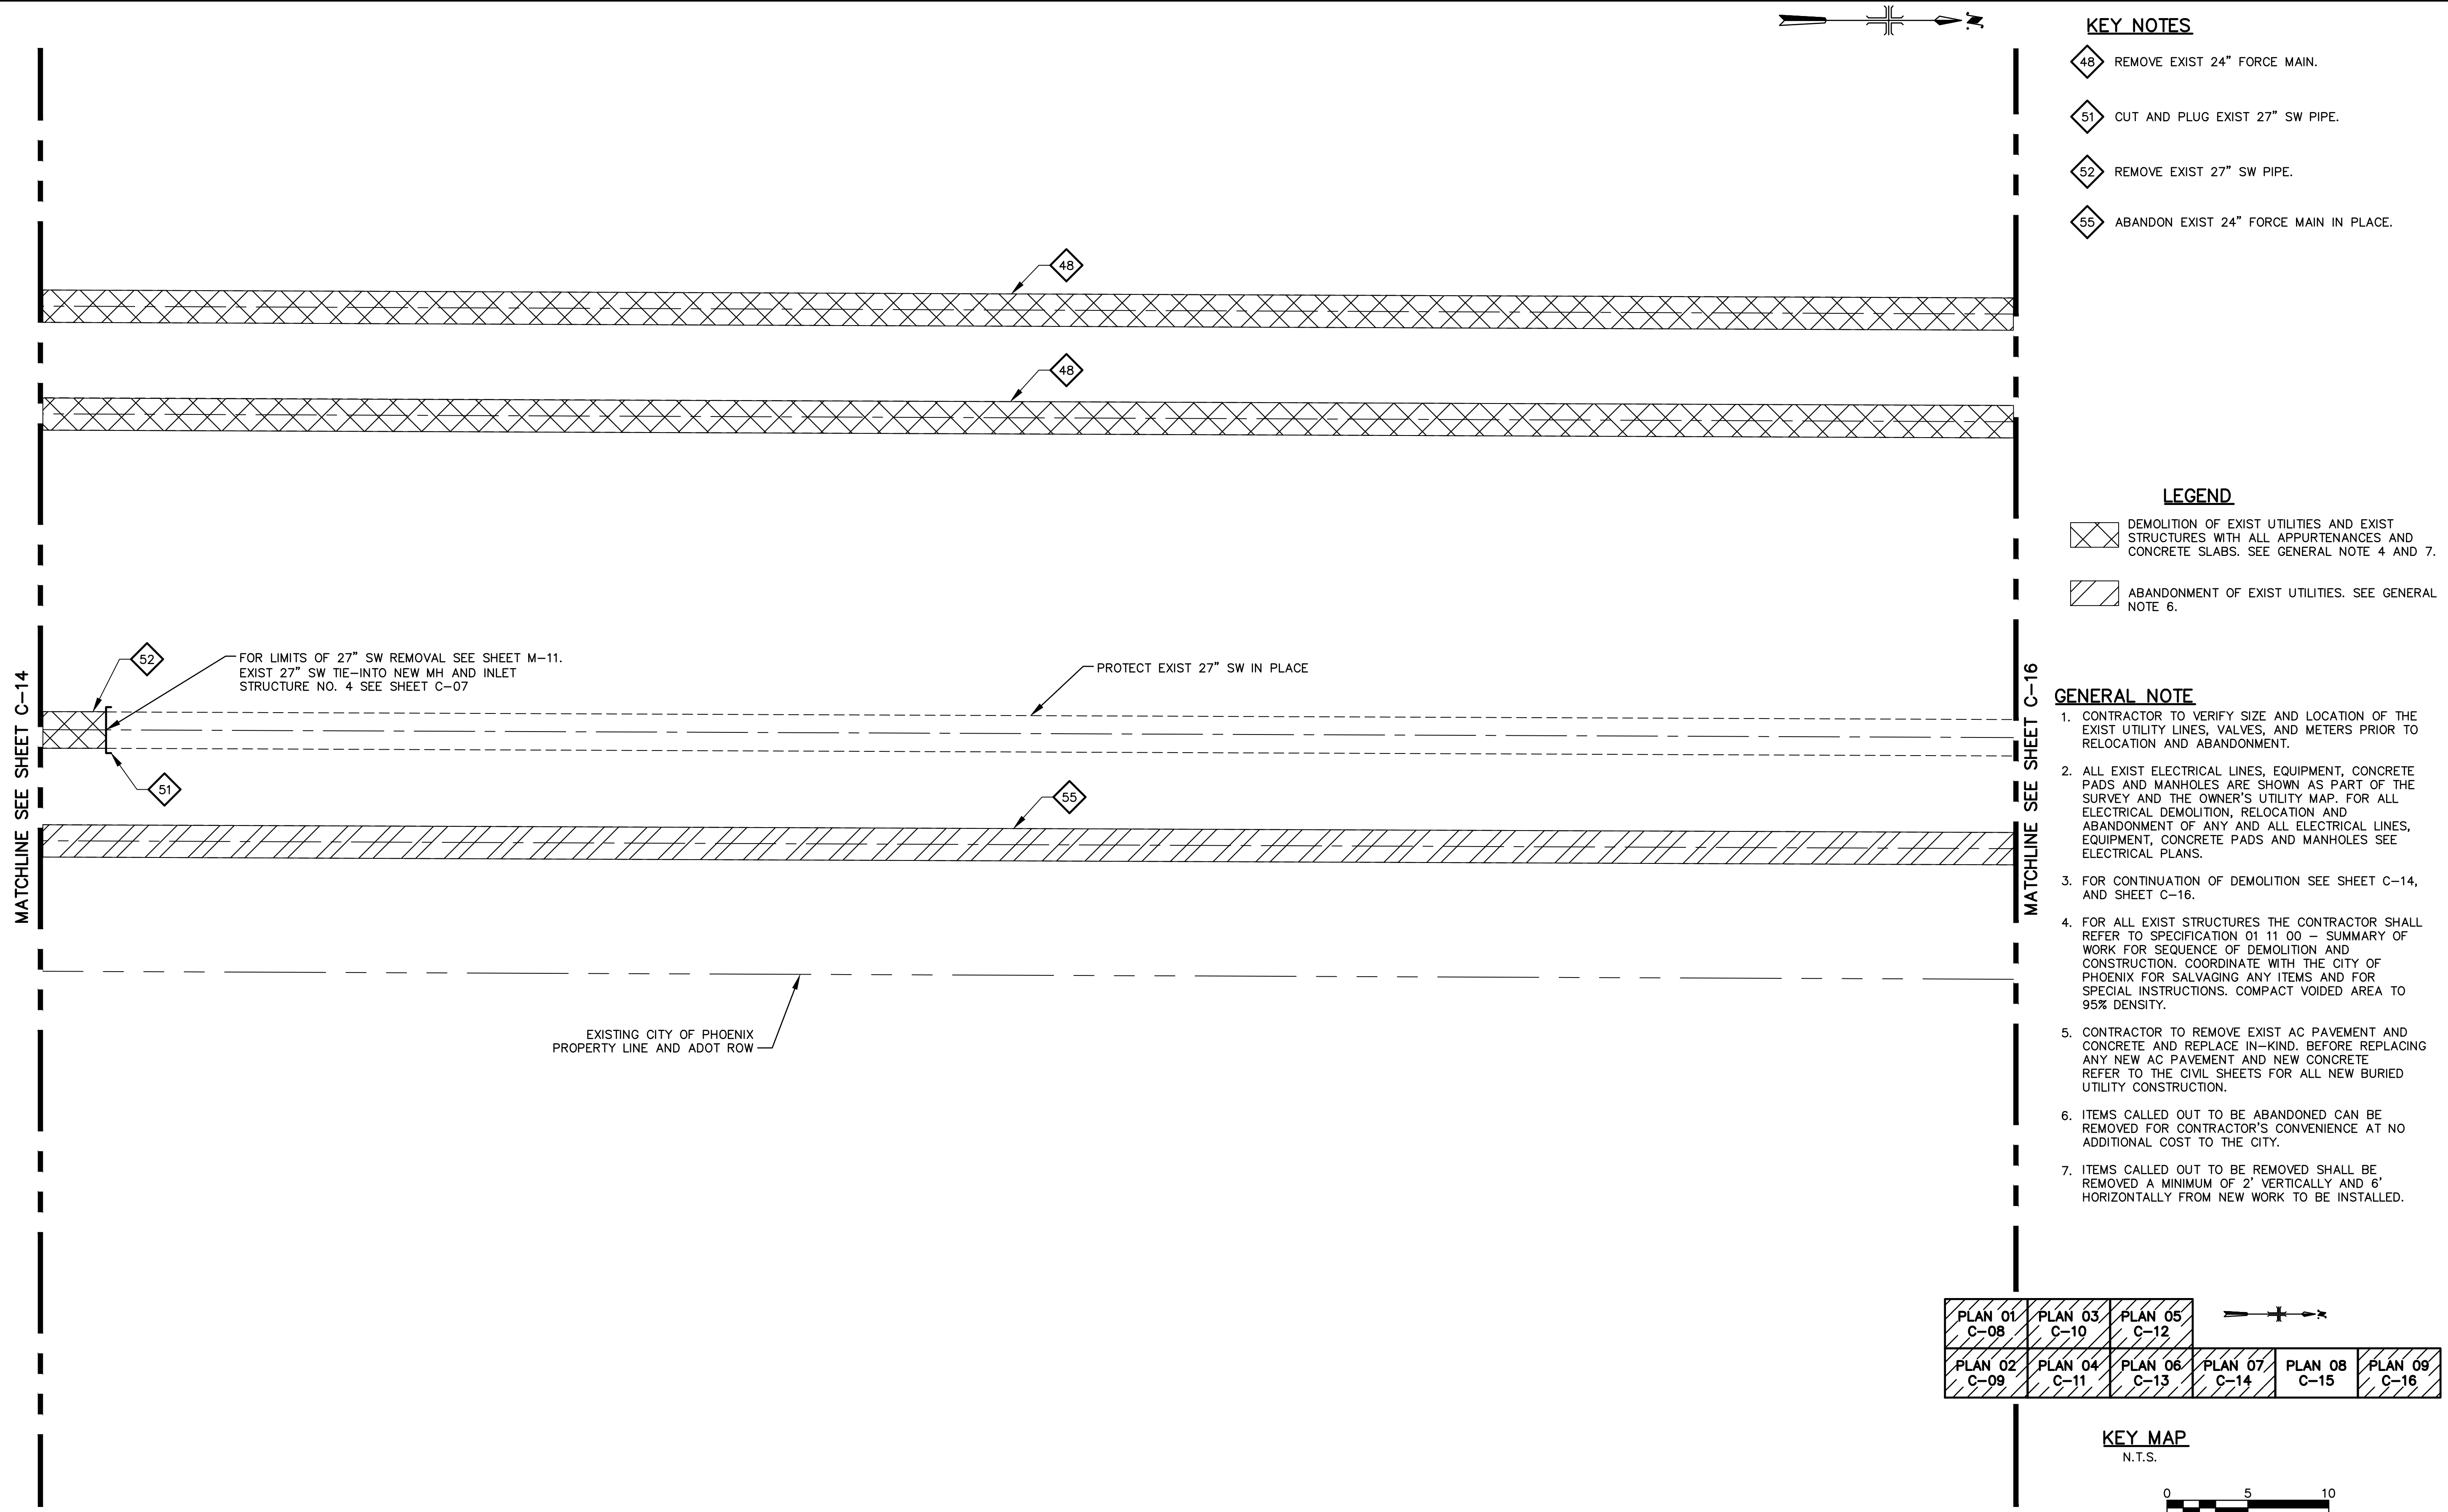

- KEY NOTES**
- 48 REMOVE EXIST 24" FORCE MAIN.
  - 51 CUT AND PLUG EXIST 27" SW PIPE.
  - 52 REMOVE EXIST 27" SW PIPE.
  - 55 ABANDON EXIST 24" FORCE MAIN IN PLACE.


- LEGEND**
- DEMOLITION OF EXIST UTILITIES AND EXIST STRUCTURES WITH ALL APPURTENANCES AND CONCRETE SLABS. SEE GENERAL NOTE 4 AND 7.
  - ABANDONMENT OF EXIST UTILITIES. SEE GENERAL NOTE 6.

- GENERAL NOTE**
1. CONTRACTOR TO VERIFY SIZE AND LOCATION OF THE EXIST UTILITY LINES, VALVES, AND METERS PRIOR TO RELOCATION AND ABANDONMENT.
  2. ALL EXIST ELECTRICAL LINES, EQUIPMENT, CONCRETE PADS AND MANHOLES ARE SHOWN AS PART OF THE SURVEY AND THE OWNER'S UTILITY MAP. FOR ALL ELECTRICAL DEMOLITION, RELOCATION AND ABANDONMENT OF ANY AND ALL ELECTRICAL LINES, EQUIPMENT, CONCRETE PADS AND MANHOLES SEE ELECTRICAL PLANS.
  3. FOR CONTINUATION OF DEMOLITION SEE SHEET C-14, AND SHEET C-16.
  4. FOR ALL EXIST STRUCTURES THE CONTRACTOR SHALL REFER TO SPECIFICATION 01 11 00 - SUMMARY OF WORK FOR SEQUENCE OF DEMOLITION AND CONSTRUCTION. COORDINATE WITH THE CITY OF PHOENIX FOR SALVAGING ANY ITEMS AND FOR SPECIAL INSTRUCTIONS. COMPACT VOIDED AREA TO 95% DENSITY.
  5. CONTRACTOR TO REMOVE EXIST AC PAVEMENT AND CONCRETE AND REPLACE IN-KIND. BEFORE REPLACING ANY NEW AC PAVEMENT AND NEW CONCRETE REFER TO THE CIVIL SHEETS FOR ALL NEW BURIED UTILITY CONSTRUCTION.
  6. ITEMS CALLED OUT TO BE ABANDONED CAN BE REMOVED FOR CONTRACTOR'S CONVENIENCE AT NO ADDITIONAL COST TO THE CITY.
  7. ITEMS CALLED OUT TO BE REMOVED SHALL BE REMOVED A MINIMUM OF 2' VERTICALLY AND 6' HORIZONTALLY FROM NEW WORK TO BE INSTALLED.

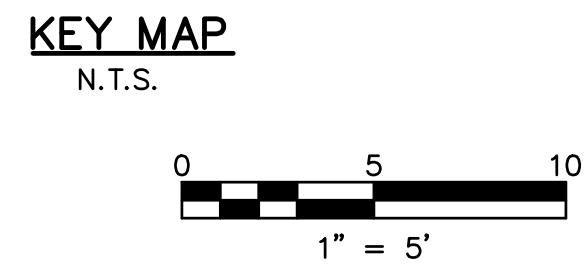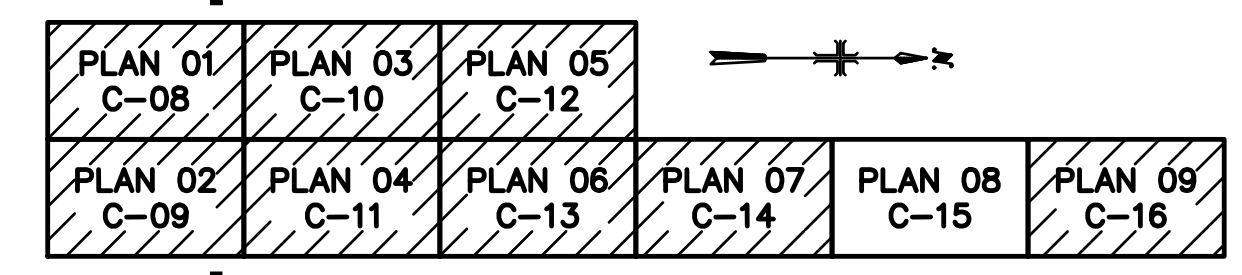


FACILITY DRAWINGS  
This drawing was supplied by a Consultant Engineer from a past project. The Consultant Engineer is not responsible for the construction information provided by the Contractor to provide the Record Drawing. The City does not warranty this drawing to be a complete and accurate portrayal of facilities as they exist in the field.

REVISION #	PROJECT NO.	DWG NUMBER	REMARKS

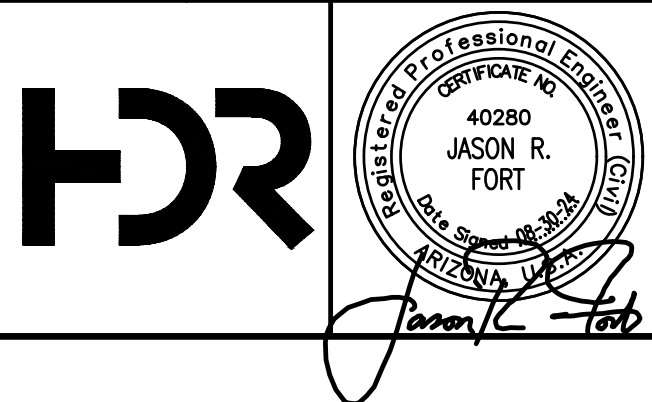

NO.	BY	DATE	CKD	REVISIONS	REMARKS
A	RS	10/2023	JF	30% SUBMITTAL	
B	RS	01/2024	JF	90% SUBMITTAL	
C	RS	04/2024	JF	AGENCY REVIEW	
D	DFD	08/2024	JF	ISSUED FOR CONSTRUCTION	
*					
*					
*					

DES	FA
DWN	RS
CKD	JF

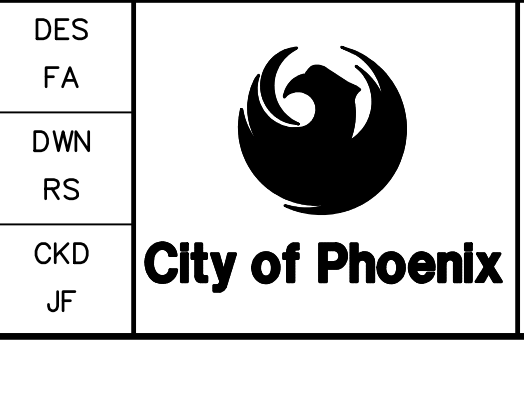

CITY OF PHOENIX  
WATER SERVICES DEPARTMENT

**LIFT STATION 40  
REFURBISHMENT**

CIVIL

**DEMOLITION PLAN 08**

COPYRIGHT © 2007-JANUARY

CITY PROJECT NO. WS90400085

DATE: 08/2024

**C-15** SHEET 20 OF 134

CAD FILE: CSCLS40M08.dwg


USER: FIDES\FR\AUD FILE: C:\pwworking\west01\03411840\00\_CSCLS40M08.dwg DATE: 9/04/24 TIME: 03:19pm

**FOR CONSTRUCTION**

THIS DRAWING MUST BE FIELD VERIFIED BEFORE USE. DRAWING NOT TO SCALE UNLESS SCALE BAR IS PRESENT.

"PER CITY OF PHOENIX CODE CHAPTER 2, SECTION 2-28, THESE PLANS ARE FOR OFFICIAL USE ONLY AND MAY NOT BE SHARED WITH OTHERS EXCEPT AS REQUIRED TO FULFILL THE OBLIGATIONS OF THE CONTRACTOR'S CONTRACT WITH THE CITY OF PHOENIX." THIS DOCUMENT MUST BE KEPT SECURE AT ALL TIMES.

MATCHLINE SEE SHEET C-15

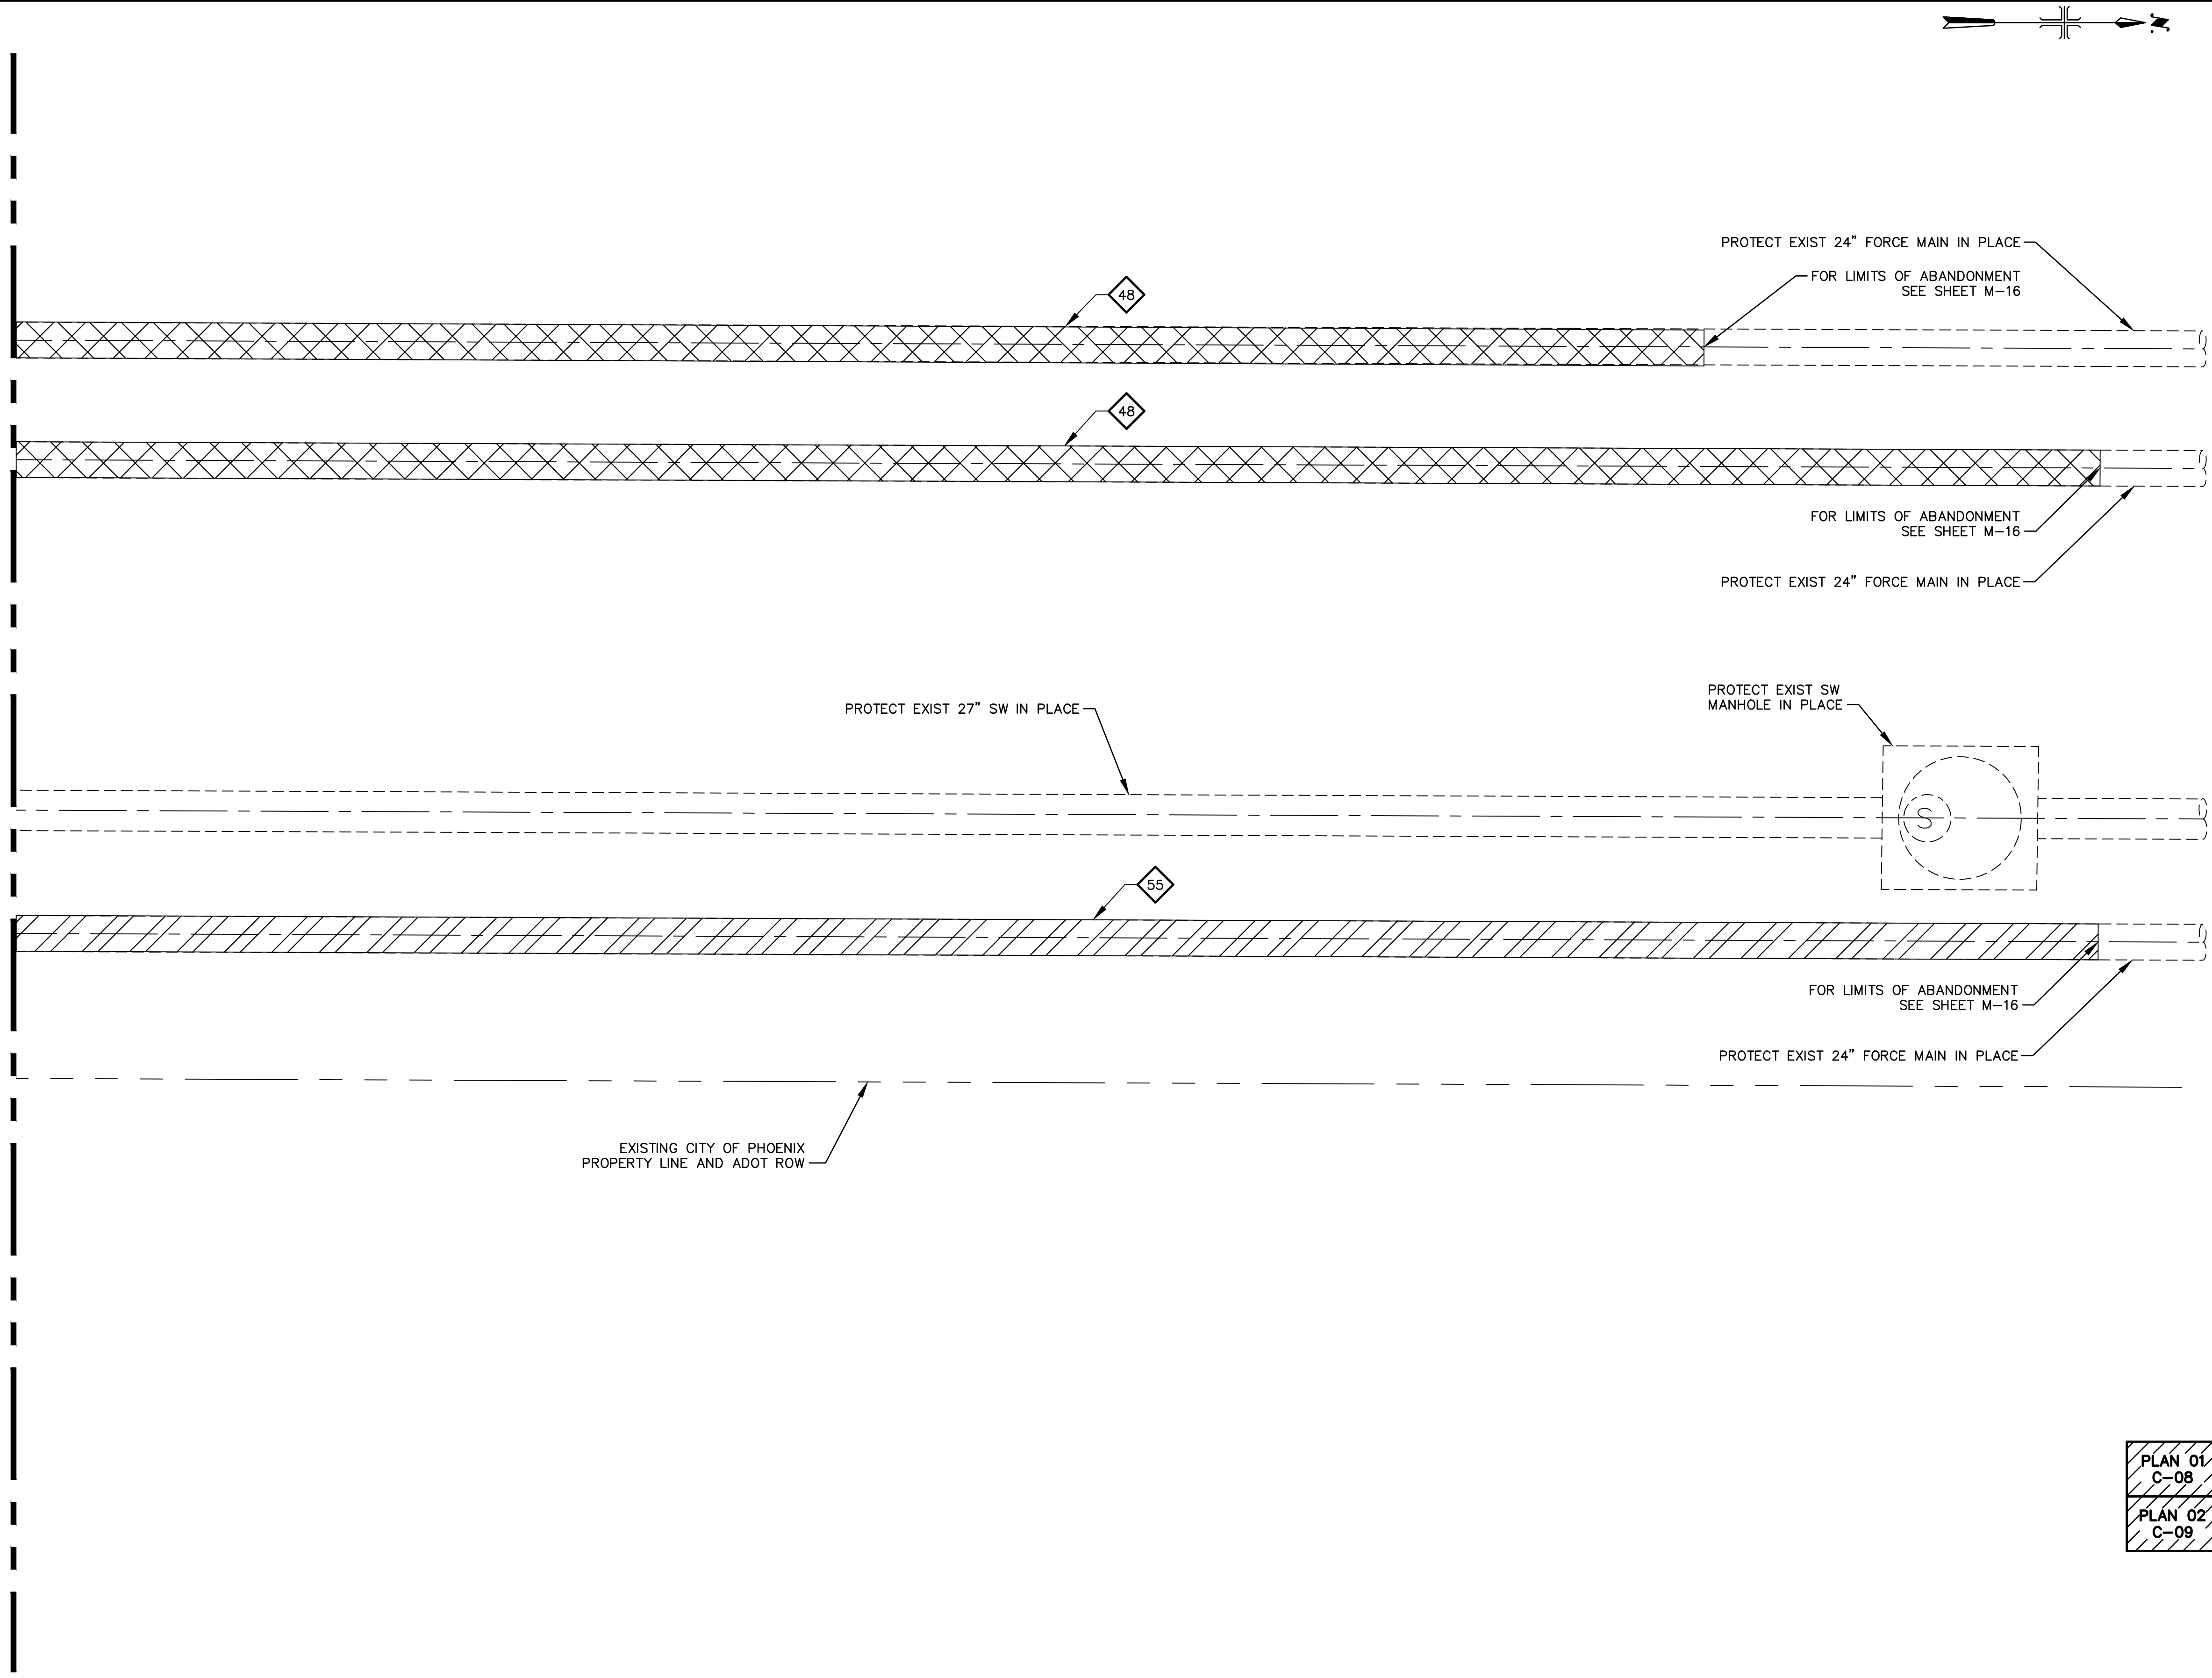

**KEY NOTES**


- 48 REMOVE EXIST 24" FORCE MAIN.
- 55 ABANDON EXIST 24" FORCE MAIN IN PLACE.

**LEGEND**


- DEMOLITION OF EXIST UTILITIES AND EXIST STRUCTURES WITH ALL APPURTENANCES AND CONCRETE SLABS. SEE GENERAL NOTE 4 AND 7.
- ABANDONMENT OF EXIST UTILITIES. SEE GENERAL NOTE 6.

**GENERAL NOTE**

1. CONTRACTOR TO VERIFY SIZE AND LOCATION OF THE EXIST UTILITY LINES, VALVES, AND METERS PRIOR TO RELOCATION AND ABANDONMENT.
2. ALL EXIST ELECTRICAL LINES, EQUIPMENT, CONCRETE PADS AND MANHOLES ARE SHOWN AS PART OF THE SURVEY AND THE OWNER'S UTILITY MAP. FOR ALL ELECTRICAL DEMOLITION, RELOCATION AND ABANDONMENT OF ANY AND ALL ELECTRICAL LINES, EQUIPMENT, CONCRETE PADS AND MANHOLES SEE ELECTRICAL PLANS.
3. FOR CONTINUATION OF DEMOLITION SEE SHEET C-15.
4. FOR ALL EXIST STRUCTURES THE CONTRACTOR SHALL REFER TO SPECIFICATION 01 11 00 - SUMMARY OF WORK FOR SEQUENCE OF DEMOLITION AND CONSTRUCTION. COORDINATE WITH THE CITY OF PHOENIX FOR SALVAGING ANY ITEMS AND FOR SPECIAL INSTRUCTIONS. COMPACT VOIDED AREA TO 95% DENSITY.
5. CONTRACTOR TO REMOVE EXIST AC PAVEMENT AND CONCRETE AND REPLACE IN-KIND. BEFORE REPLACING ANY NEW AC PAVEMENT AND NEW CONCRETE REFER TO THE CIVIL SHEETS FOR ALL NEW BURIED UTILITY CONSTRUCTION.
6. ITEMS CALLED OUT TO BE ABANDONED CAN BE REMOVED FOR CONTRACTOR'S CONVENIENCE AT NO ADDITIONAL COST TO THE CITY.
7. ITEMS CALLED OUT TO BE REMOVED SHALL BE REMOVED A MINIMUM OF 2' VERTICALLY AND 6' HORIZONTALLY FROM NEW WORK TO BE INSTALLED.

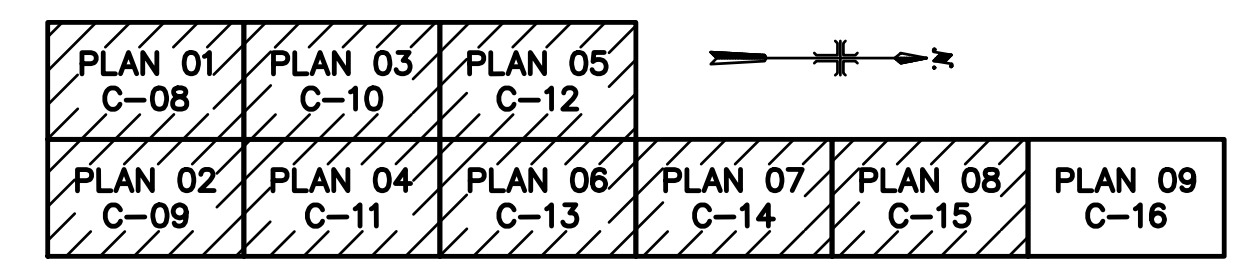


**KEY MAP**  
N.T.S.

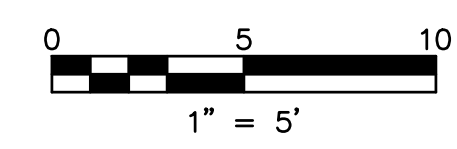


FACILITY DRAWINGS  
This drawing was supplied by a Consultant Engineer from a past construction project. The Consultant Engineer is not responsible for the construction information provided by the Contractor to provide the Record Drawing. The City does not warranty this drawing to be a complete and accurate portrayal of facilities as they exist in the field.

REVISION	ENGINEERING COMPANY	PROJECT NO.	PROJECT NAME	DATE	CAD FILE NAME	DWG NUMBER	REMARKS
#							
#							

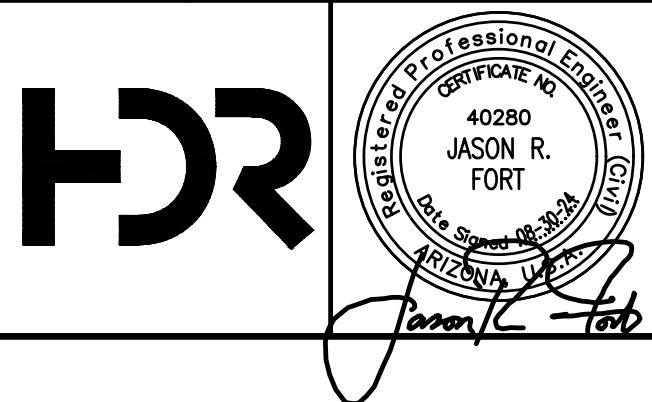

REVISIONS				
NO.	BY	DATE	CKD	REMARKS
A	RS	10/2023	JF	30% SUBMITTAL
B	RS	01/2024	JF	90% SUBMITTAL
C	RS	04/2024	JF	AGENCY REVIEW
D	DFD	08/2024	JF	ISSUED FOR CONSTRUCTION
*				
*				
*				

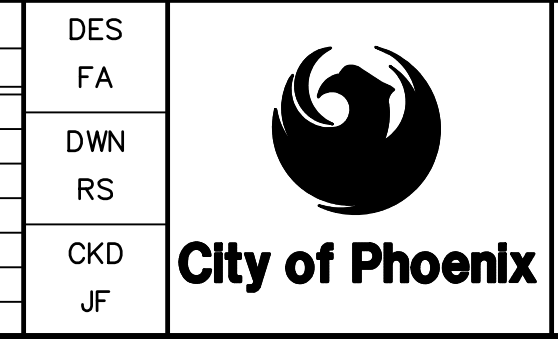

CITY OF PHOENIX  
WATER SERVICES DEPARTMENT  
  
LIFT STATION 40  
REFURBISHMENT



CIVIL  
  
DEMOLITION PLAN 09

COPYRIGHT © 2007-JANUARY  
CITY PROJECT NO. WS90400085  
DATE: 08/2024  
C-16 SHEET 21 OF 134  
CAD FILE: CSCLS40M09.dwg

FOR CONSTRUCTION

THIS DRAWING MUST BE FIELD VERIFIED BEFORE USE  
DRAWING NOT TO SCALE UNLESS SCALE BAR IS PRESENT

"PER CITY OF PHOENIX CODE CHAPTER 2, SECTION 2-28, THESE PLANS ARE FOR OFFICIAL USE ONLY AND MAY NOT BE SHARED WITH OTHERS EXCEPT AS REQUIRED TO FULFILL THE OBLIGATIONS OF THE CONTRACTOR'S CONTRACT WITH THE CITY OF PHOENIX." THIS DOCUMENT MUST BE KEPT SECURE AT ALL TIMES.

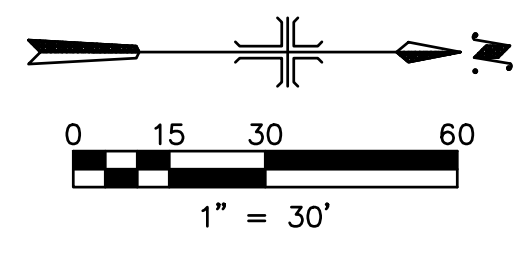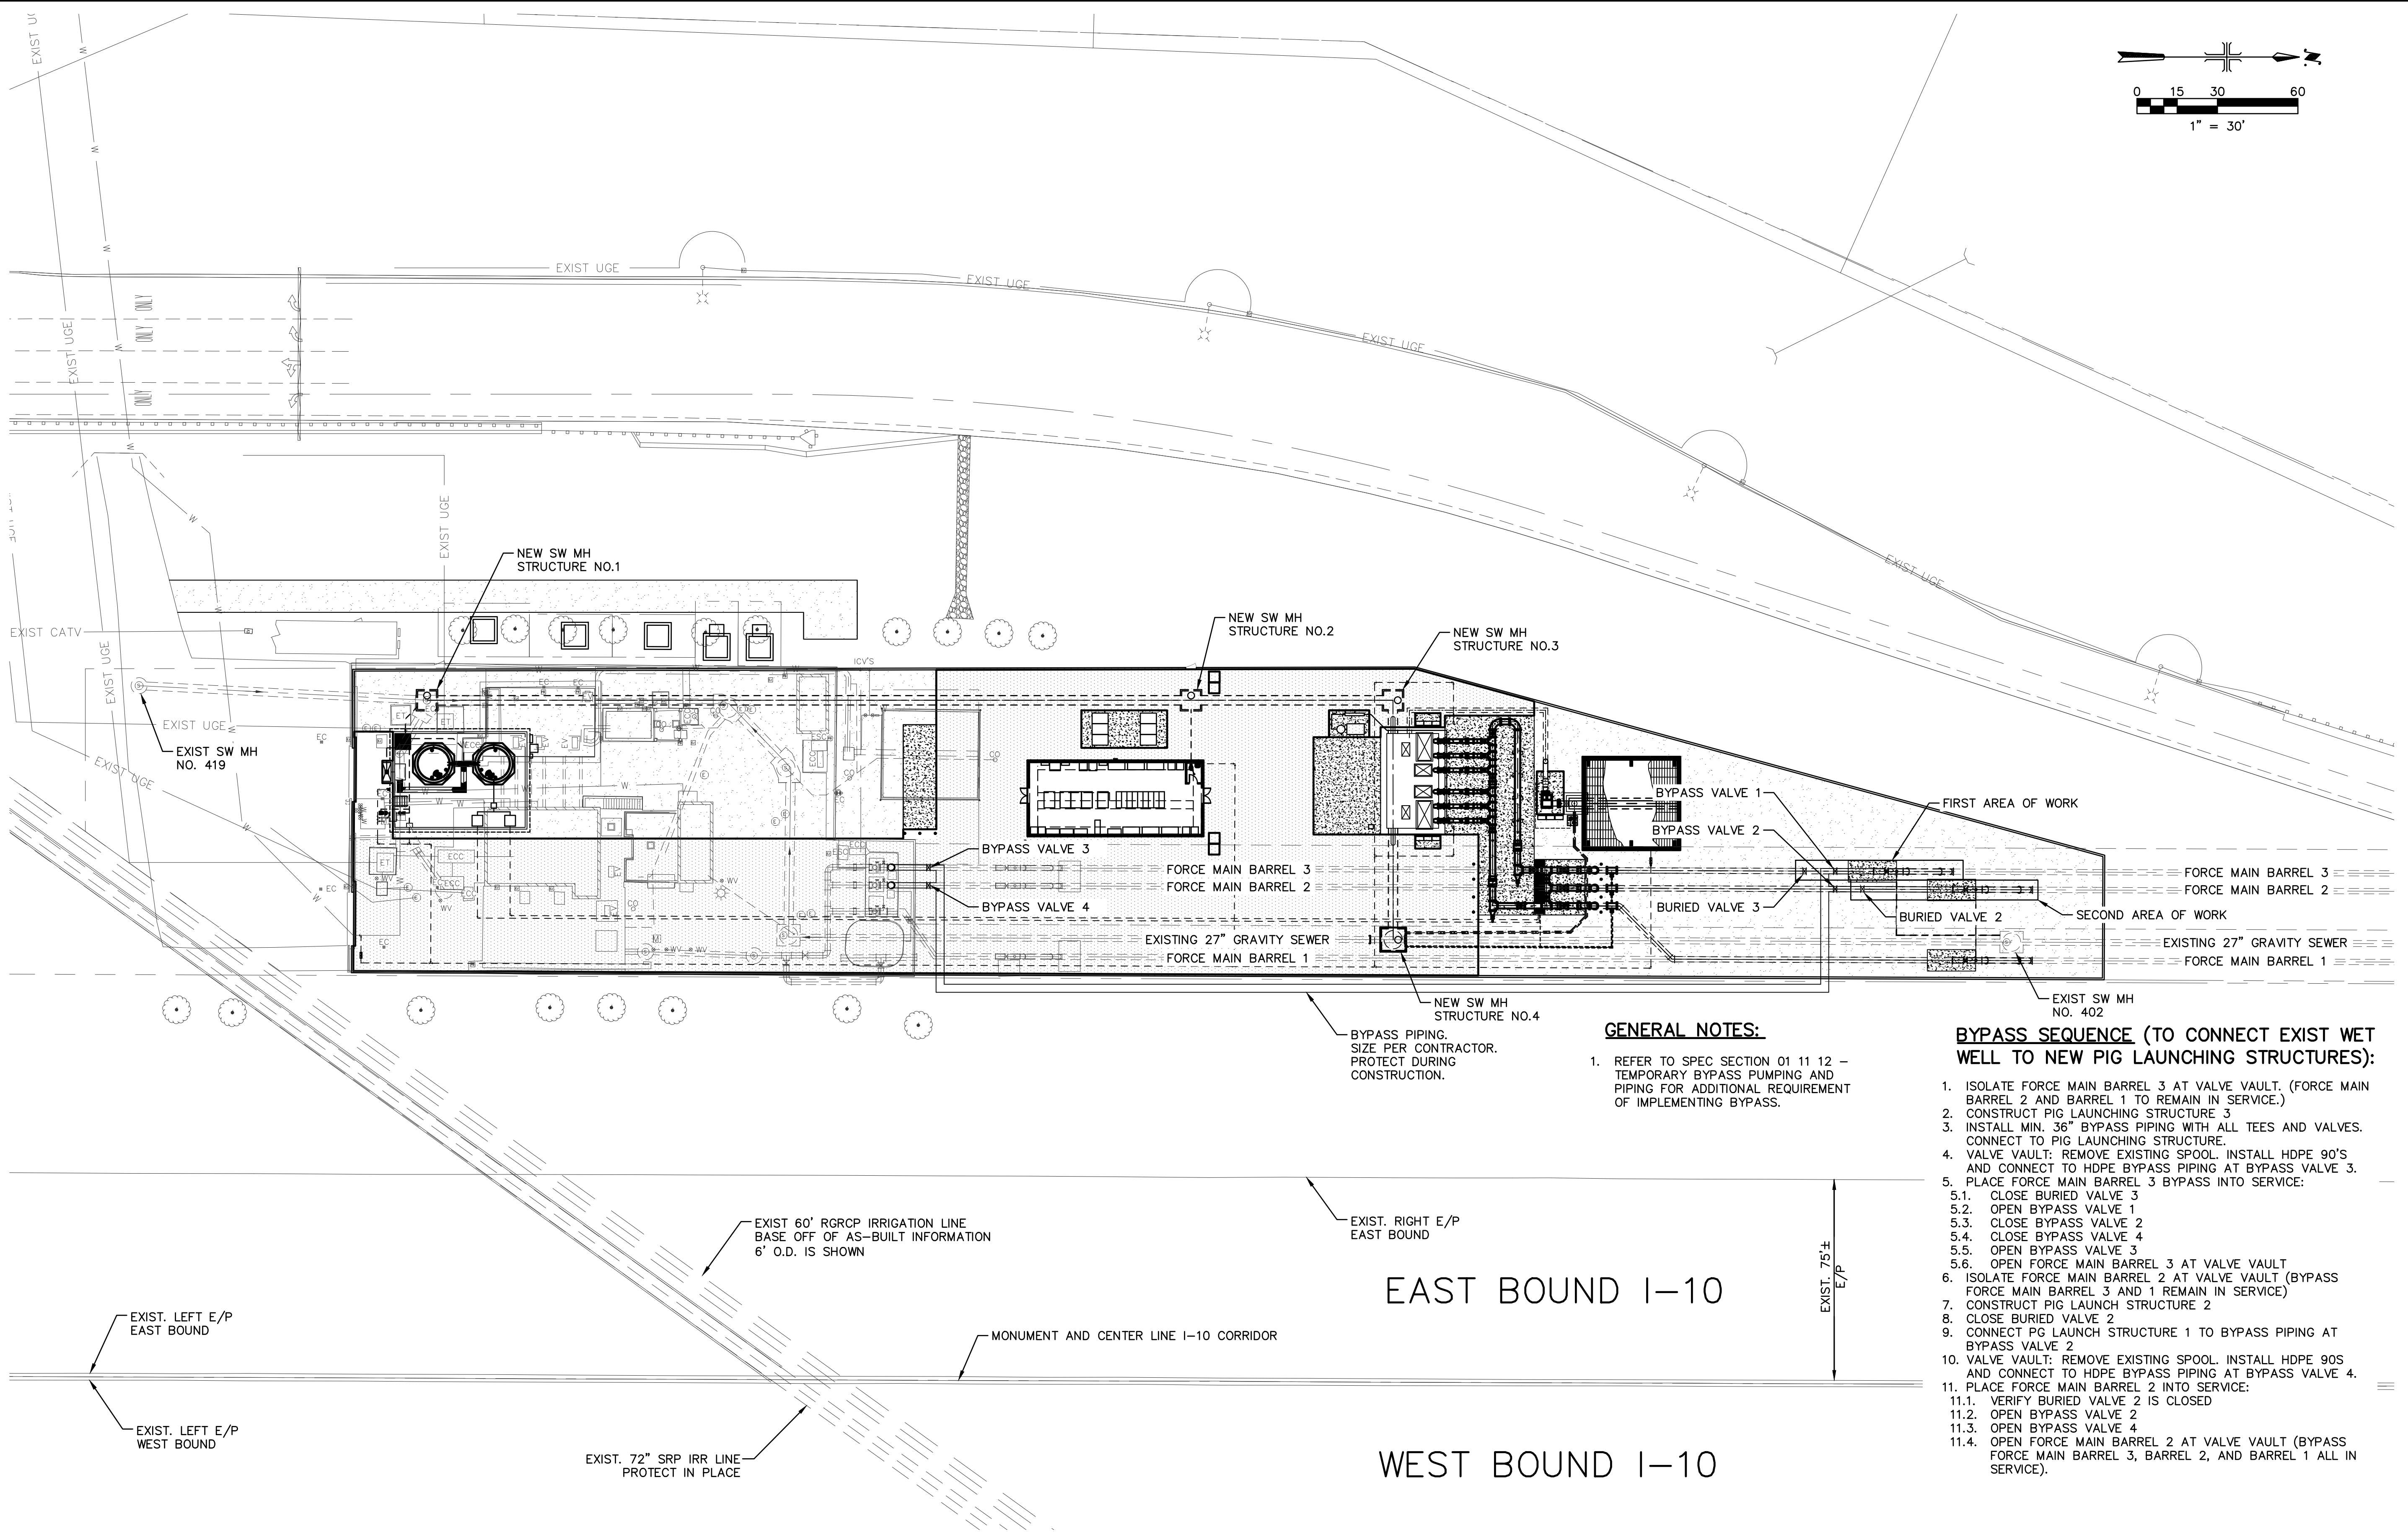

**GENERAL NOTES:**

1. REFER TO SPEC SECTION 01 11 12 - TEMPORARY BYPASS PUMPING AND PIPING FOR ADDITIONAL REQUIREMENT OF IMPLEMENTING BYPASS.

**BYPASS SEQUENCE (TO CONNECT EXIST WET WELL TO NEW PIG LAUNCHING STRUCTURES):**

1. ISOLATE FORCE MAIN BARREL 3 AT VALVE VAULT. (FORCE MAIN BARREL 2 AND BARREL 1 TO REMAIN IN SERVICE.)
2. CONSTRUCT PIG LAUNCHING STRUCTURE 3
3. INSTALL MIN. 36" BYPASS PIPING WITH ALL TEES AND VALVES. CONNECT TO PIG LAUNCHING STRUCTURE.
4. VALVE VAULT: REMOVE EXISTING SPOOL. INSTALL HDPE 90'S AND CONNECT TO HDPE BYPASS PIPING AT BYPASS VALVE 3.
5. PLACE FORCE MAIN BARREL 3 BYPASS INTO SERVICE:
  - 5.1. CLOSE BURIED VALVE 3
  - 5.2. OPEN BYPASS VALVE 1
  - 5.3. CLOSE BYPASS VALVE 2
  - 5.4. CLOSE BYPASS VALVE 4
  - 5.5. OPEN BYPASS VALVE 3
  - 5.6. OPEN FORCE MAIN BARREL 3 AT VALVE VAULT
6. ISOLATE FORCE MAIN BARREL 2 AT VALVE VAULT (BYPASS FORCE MAIN BARREL 3 AND 1 REMAIN IN SERVICE)
7. CONSTRUCT PIG LAUNCH STRUCTURE 2
8. CLOSE BURIED VALVE 2
9. CONNECT PG LAUNCH STRUCTURE 1 TO BYPASS PIPING AT BYPASS VALVE 2
10. VALVE VAULT: REMOVE EXISTING SPOOL. INSTALL HDPE 90S AND CONNECT TO HDPE BYPASS PIPING AT BYPASS VALVE 4.
11. PLACE FORCE MAIN BARREL 2 INTO SERVICE:
  - 11.1. VERIFY BURIED VALVE 2 IS CLOSED
  - 11.2. OPEN BYPASS VALVE 2
  - 11.3. OPEN BYPASS VALVE 4
  - 11.4. OPEN FORCE MAIN BARREL 2 AT VALVE VAULT (BYPASS FORCE MAIN BARREL 3, BARREL 2, AND BARREL 1 ALL IN SERVICE.)

EAST BOUND I-10

WEST BOUND I-10

REVISIONS					
NO.	BY	DATE	CKD	REMARKS	
A	RS	10/2023	JF	30% SUBMITTAL	
B	RS	01/2024	JF	90% SUBMITTAL	
C	RS	04/2024	JF	AGENCY REVIEW	
D	DFD	08/2024	JF	ISSUED FOR CONSTRUCTION	
*					
*					
*					

DES  
RS  
DWN  
RS  
CKD  
JF

**City of Phoenix**

CITY OF PHOENIX  
WATER SERVICES DEPARTMENT

LIFT STATION 40  
REFURBISHMENT

CIVIL

BYPASS PLAN 01

COPYRIGHT © 2007-JANUARY

CITY PROJECT NO. WS90400085

DATE: 08/2024

C-17 SHEET 22 OF 134

CAD FILE: CSCLS40P02.dwg

FACILITY DRAWINGS  
This drawing was supplied by a Consultant Engineer from a past project and is not intended for construction. The Contractor is responsible for verifying the information provided by the Contractor to provide the Record Drawing. The City does not warrant this drawing to be a complete and accurate portrayal of facilities as they exist in the field.



FOR CITY OF PHOENIX USE ONLY - REFERENCE CID NUMBER: #	DATE	REVISION ENGINEERING COMPANY	PROJECT NO.	PROJECT NAME	DWG NUMBER	REMARKS

USER: FDBEA5R1A0D FILE: C:\pwworking\west01\03411640\02\_CSCLS40P02.dwg DATE: 9/04/24 TIME: 03:19pm

THIS DRAWING MUST BE FIELD VERIFIED BEFORE USE  
DRAWING NOT TO SCALE UNLESS SCALE BAR IS PRESENT

**FOR CONSTRUCTION**

"PER CITY OF PHOENIX CODE CHAPTER 2, SECTION 2-2B, THESE PLANS ARE FOR OFFICIAL USE ONLY AND MAY NOT BE SHARED WITH OTHERS EXCEPT AS REQUIRED TO FULFILL THE OBLIGATIONS OF THE CONTRACTOR'S CONTRACT WITH THE CITY OF PHOENIX."  
THIS DOCUMENT MUST BE KEPT SECURE AT ALL TIMES.

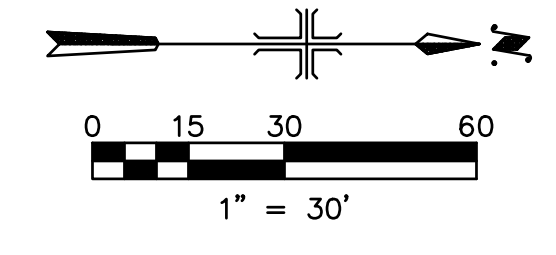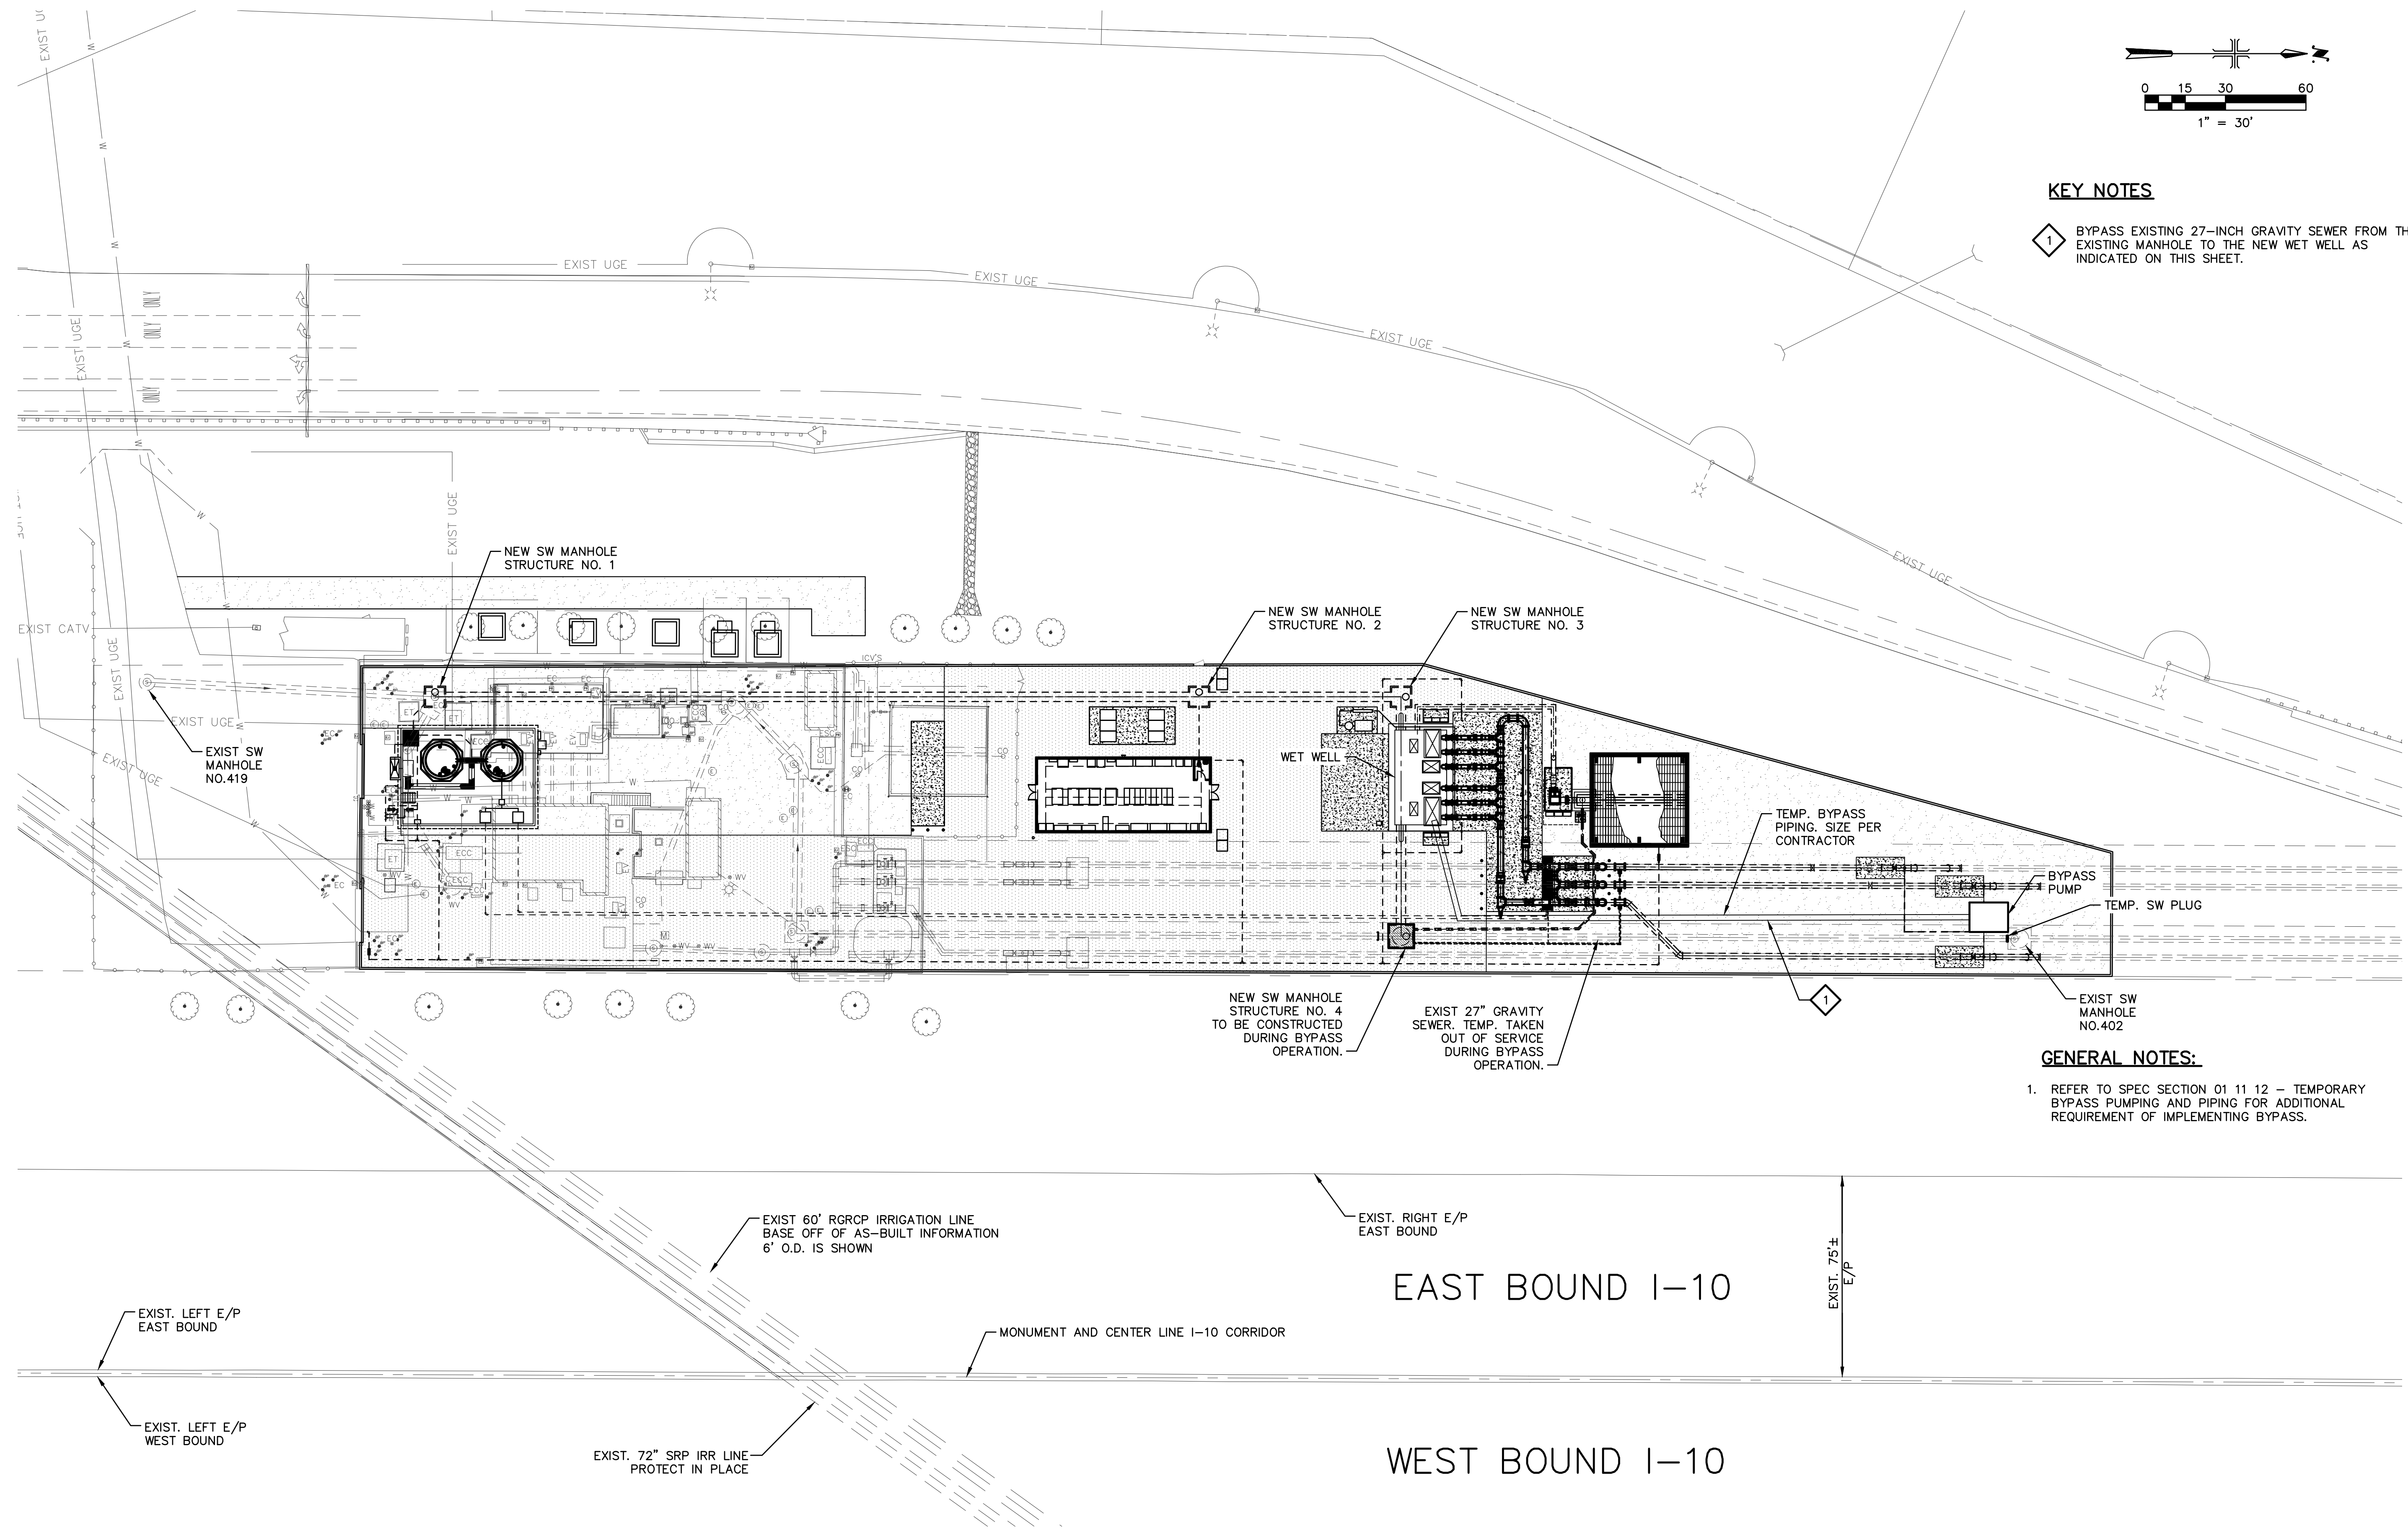

**KEY NOTES**


- 1. BYPASS EXISTING 27-INCH GRAVITY SEWER FROM THE EXISTING MANHOLE TO THE NEW WET WELL AS INDICATED ON THIS SHEET.

**GENERAL NOTES:**

- 1. REFER TO SPEC SECTION 01 11 12 - TEMPORARY BYPASS PUMPING AND PIPING FOR ADDITIONAL REQUIREMENT OF IMPLEMENTING BYPASS.


FACILITY DRAWINGS  
This drawing was supplied by a Consultant Engineer from a past construction project. The original construction drawing was modified based on information provided by the Contractor to provide the Record Drawing. The City does not warrant the accuracy and reliability of the information and accurate portrayal of facilities as they exist in the field.

REVISION #	DATE	PROJECT NO.	PROJECT NAME	REFERENCE ID NUMBER	DATE	DWG NUMBER	REMARKS

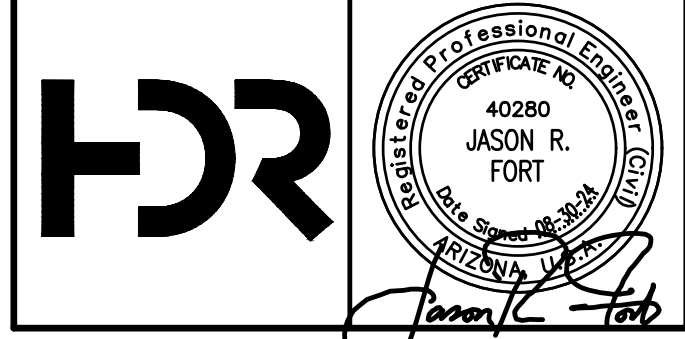

NO.	BY	DATE	CHKD	REVISIONS	REMARKS
A	RS	10/2023	JF	30% SUBMITTAL	
B	RS	01/2024	JF	90% SUBMITTAL	
C	RS	04/2024	JF	AGENCY REVIEW	
D	DFD	08/2024	JF	ISSUED FOR CONSTRUCTION	
*					
*					
*					

DES	RS
DWN	RS
CKD	JF

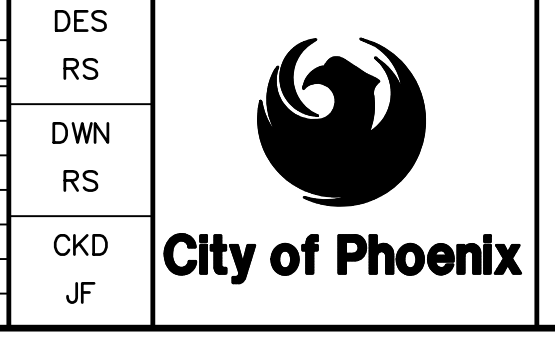

CITY OF PHOENIX  
WATER SERVICES DEPARTMENT  
  
LIFT STATION 40  
REFURBISHMENT

CIVIL  
  
BYPASS PLAN 02



COPYRIGHT © 2007-JANUARY  
CITY PROJECT NO. WS90400085  
DATE: 08/2024  
C-18 SHEET 23 OF 134  
CAD FILE: CSCLS40P03.dwg

USER: FDEPASFRAUD FILE: C:\pwworking\west01\q3411640\33\_CSCLS40P03.dwg DATE: 9/04/24 TIME: 03:19pm

**FOR CONSTRUCTION**

THIS DRAWING MUST BE FIELD VERIFIED BEFORE USE. DRAWING NOT TO SCALE UNLESS SCALE BAR IS PRESENT

"PER CITY OF PHOENIX CODE CHAPTER 2, SECTION 2-28, THESE PLANS ARE FOR OFFICIAL USE ONLY AND MAY NOT BE SHARED WITH OTHERS EXCEPT AS REQUIRED TO FULFILL THE OBLIGATIONS OF THE CONTRACTOR'S CONTRACT WITH THE CITY OF PHOENIX." THIS DOCUMENT MUST BE KEPT SECURE AT ALL TIMES.

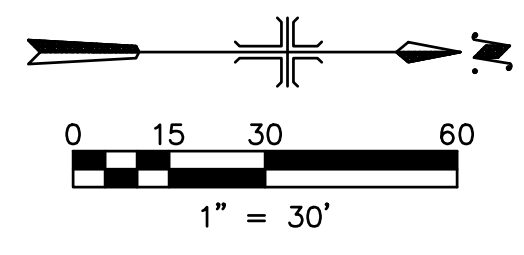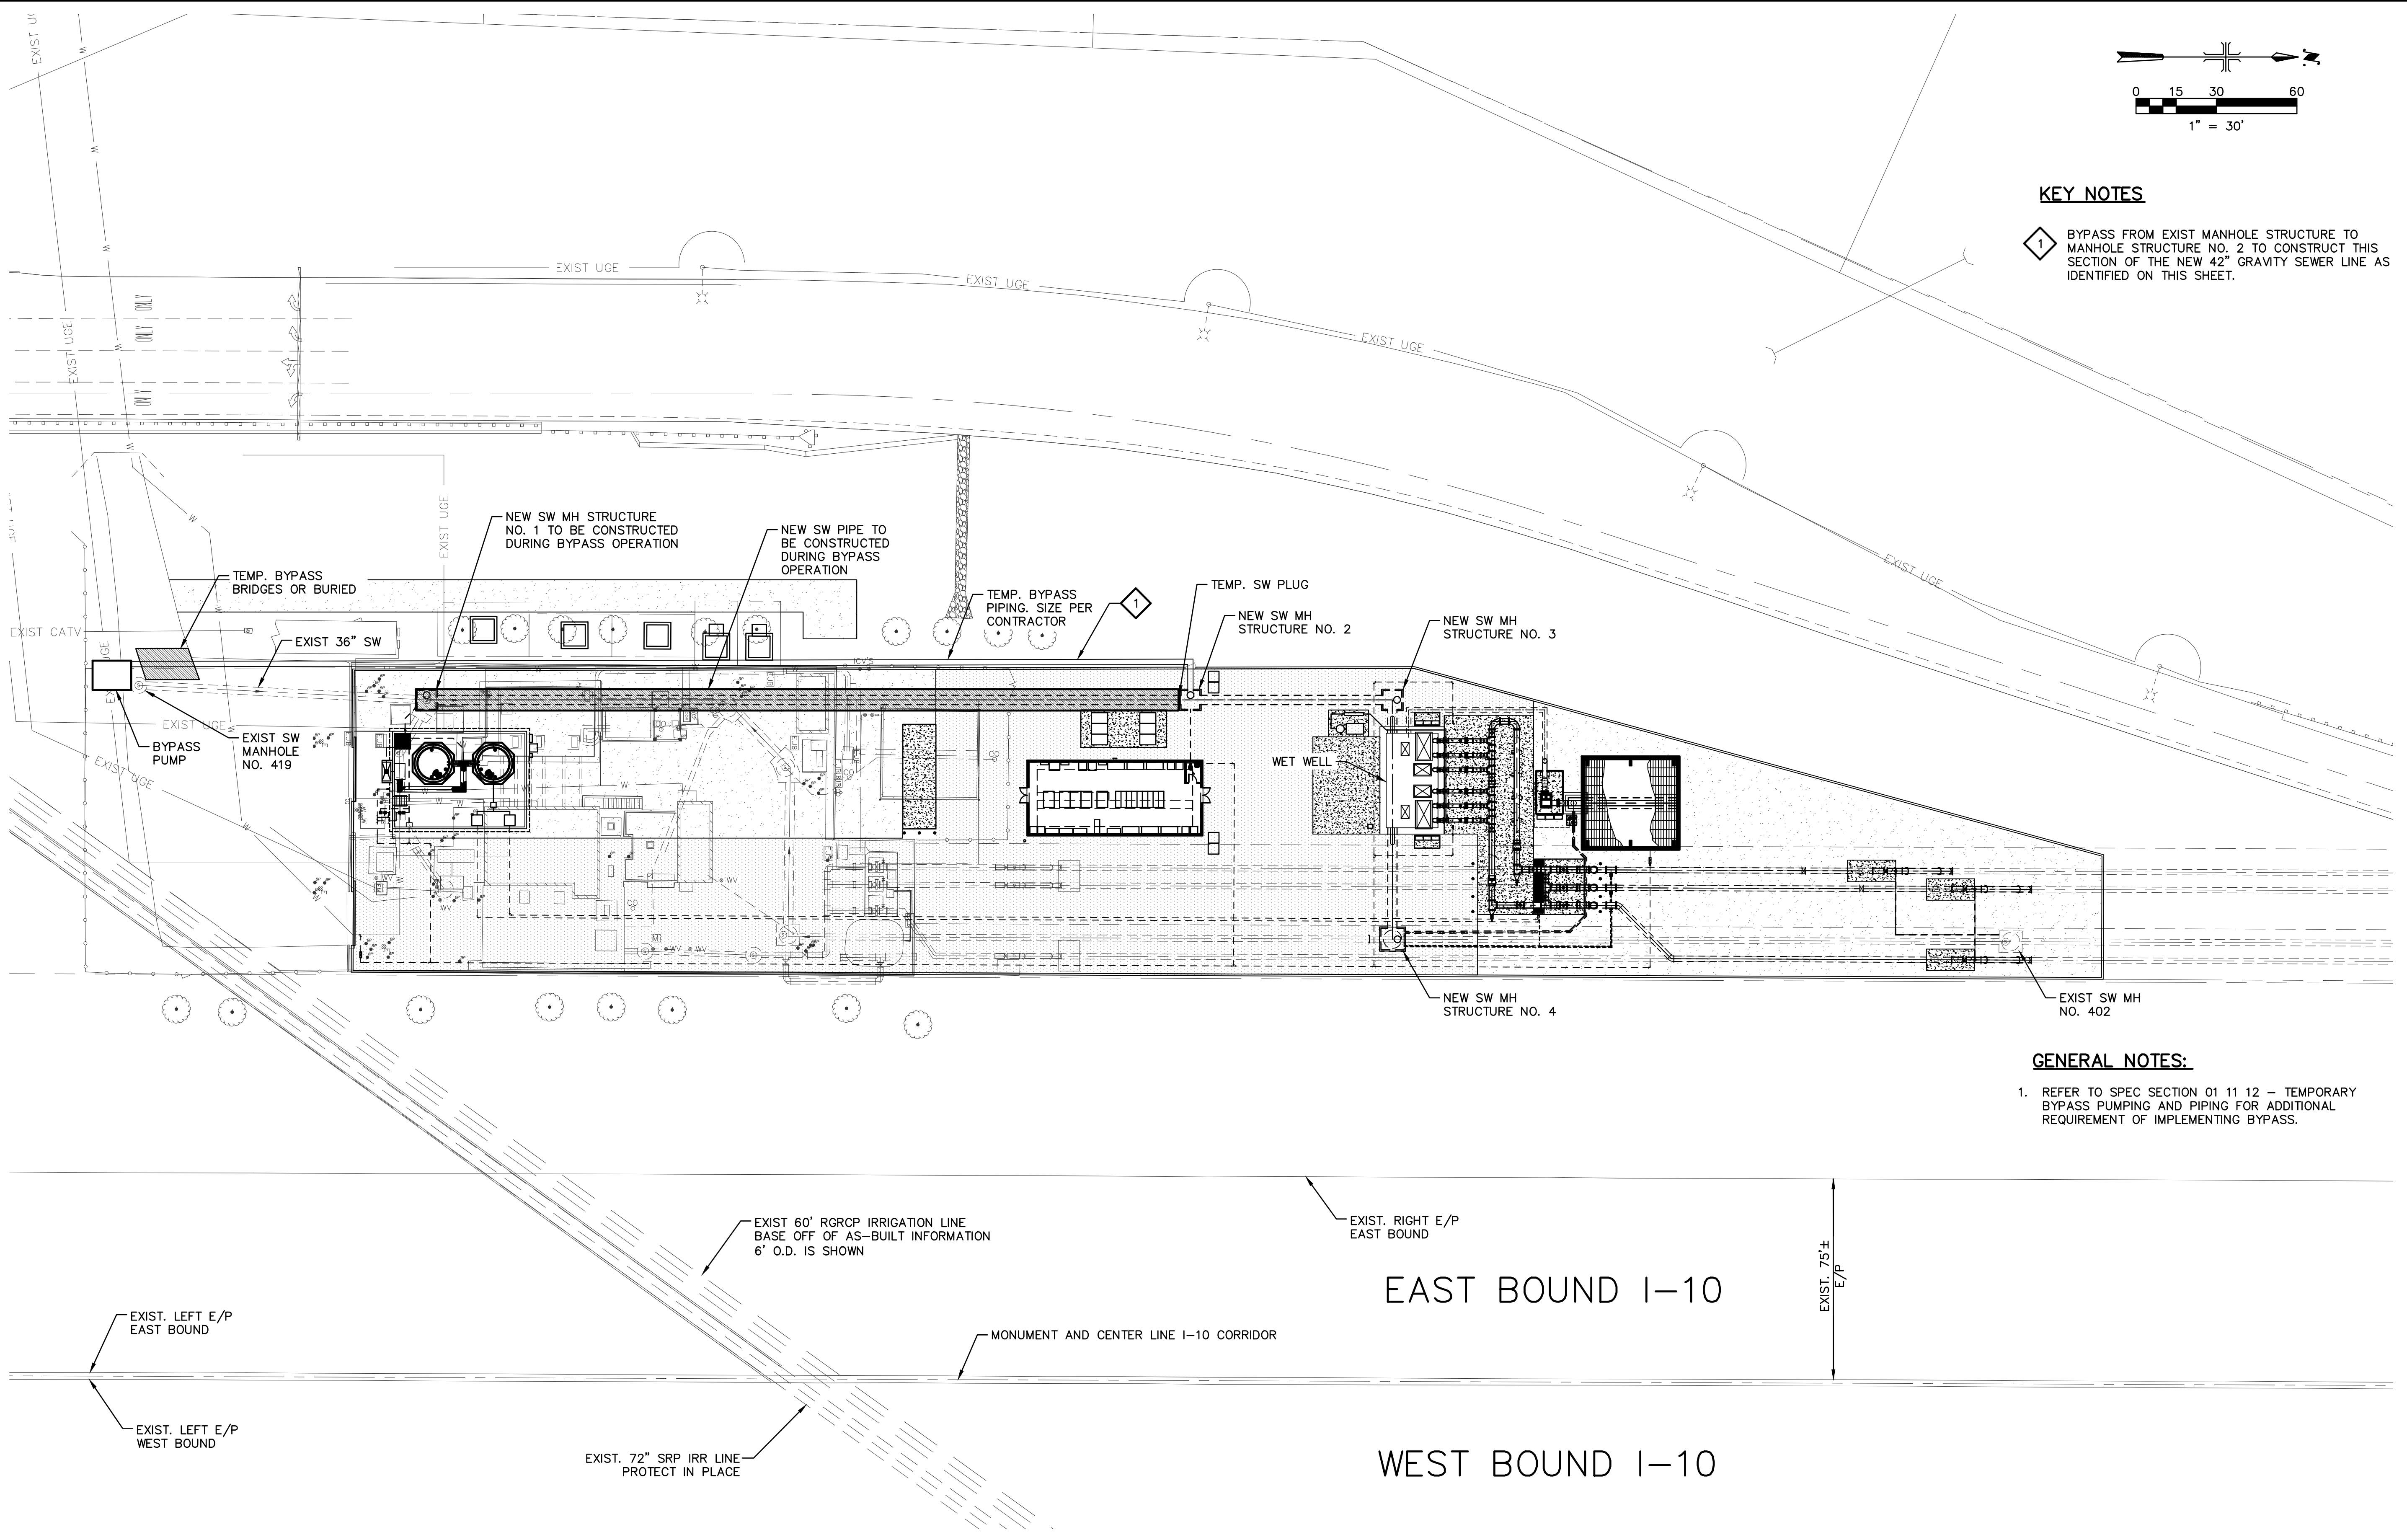


**KEY NOTES**

- 1. BYPASS FROM EXIST MANHOLE STRUCTURE TO MANHOLE STRUCTURE NO. 2 TO CONSTRUCT THIS SECTION OF THE NEW 42" GRAVITY SEWER LINE AS IDENTIFIED ON THIS SHEET.


**GENERAL NOTES:**

- 1. REFER TO SPEC SECTION 01 11 12 - TEMPORARY BYPASS PUMPING AND PIPING FOR ADDITIONAL REQUIREMENT OF IMPLEMENTING BYPASS.

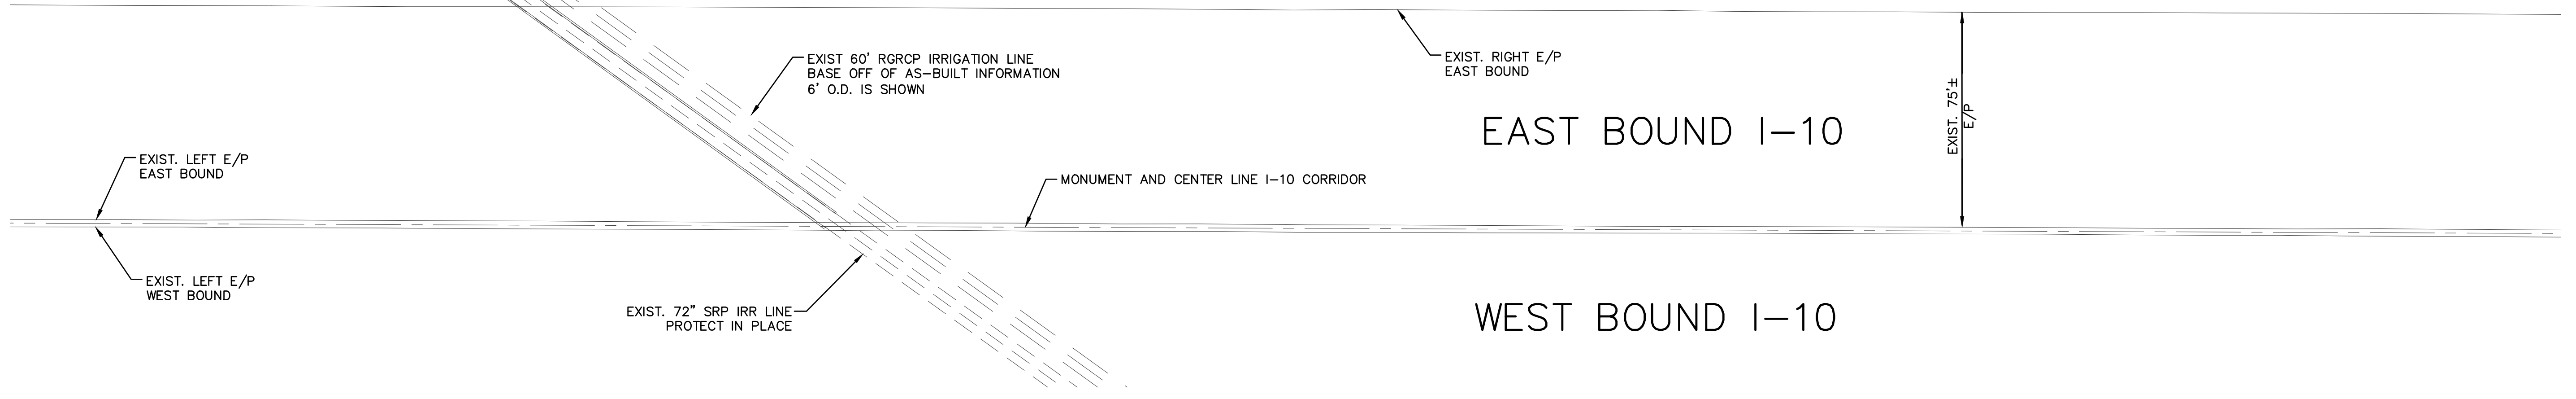


FACILITY DRAWINGS  
This drawing was supplied by a Consultant Engineer from a past project. The Consultant Engineer is not responsible for the accuracy of the information provided by the Contractor to provide the Record Drawing. The City does not warrant this drawing to be a complete and accurate portrayal of facilities as they exist in the field.

REVISION #	DATE	CAD FILE NAME	DWG NUMBER	REMARKS

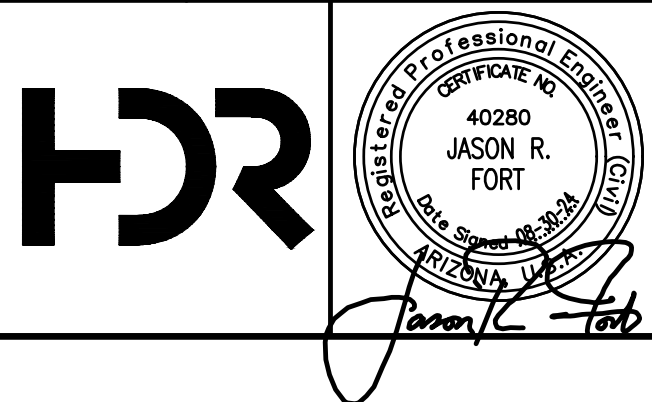

NO.	BY	DATE	CKD	REVISIONS	REMARKS
A	RS	10/2023	JF	30% SUBMITTAL	
B	RS	01/2024	JF	90% SUBMITTAL	
C	RS	04/2024	JF	AGENCY REVIEW	
D	DFD	08/2024	JF	ISSUED FOR CONSTRUCTION	
*					
*					
*					

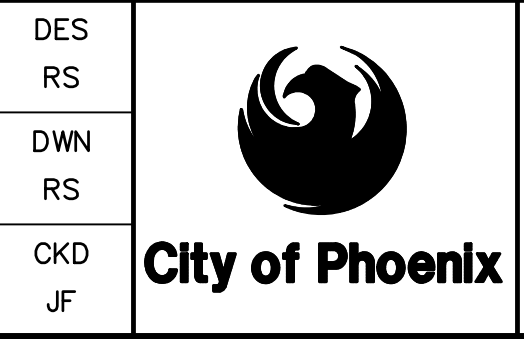

CITY OF PHOENIX  
WATER SERVICES DEPARTMENT  
  
LIFT STATION 40  
REFURBISHMENT

CIVIL  
  
BYPASS PLAN 03

COPYRIGHT © 2007-JANUARY  
CITY PROJECT NO. WS90400085  
DATE: 08/2024  
C-19 SHEET 24 OF 134  
CAD FILE: CSCLS40P04.dwg


USER: FBERASFRALUD FILE: C:\pwworking\west01\03411640\24\_CSCLS40P04.dwg DATE: 9/04/24 TIME: 03:20pm



**FOR CONSTRUCTION**

THIS DRAWING MUST BE FIELD VERIFIED BEFORE USE. DRAWING NOT TO SCALE UNLESS SCALE BAR IS PRESENT

"PER CITY OF PHOENIX CODE CHAPTER 2, SECTION 2-28, THESE PLANS ARE FOR OFFICIAL USE ONLY AND MAY NOT BE SHARED WITH OTHERS EXCEPT AS REQUIRED TO FULFILL THE OBLIGATIONS OF THE CONTRACTOR'S CONTRACT WITH THE CITY OF PHOENIX." THIS DOCUMENT MUST BE KEPT SECURE AT ALL TIMES.

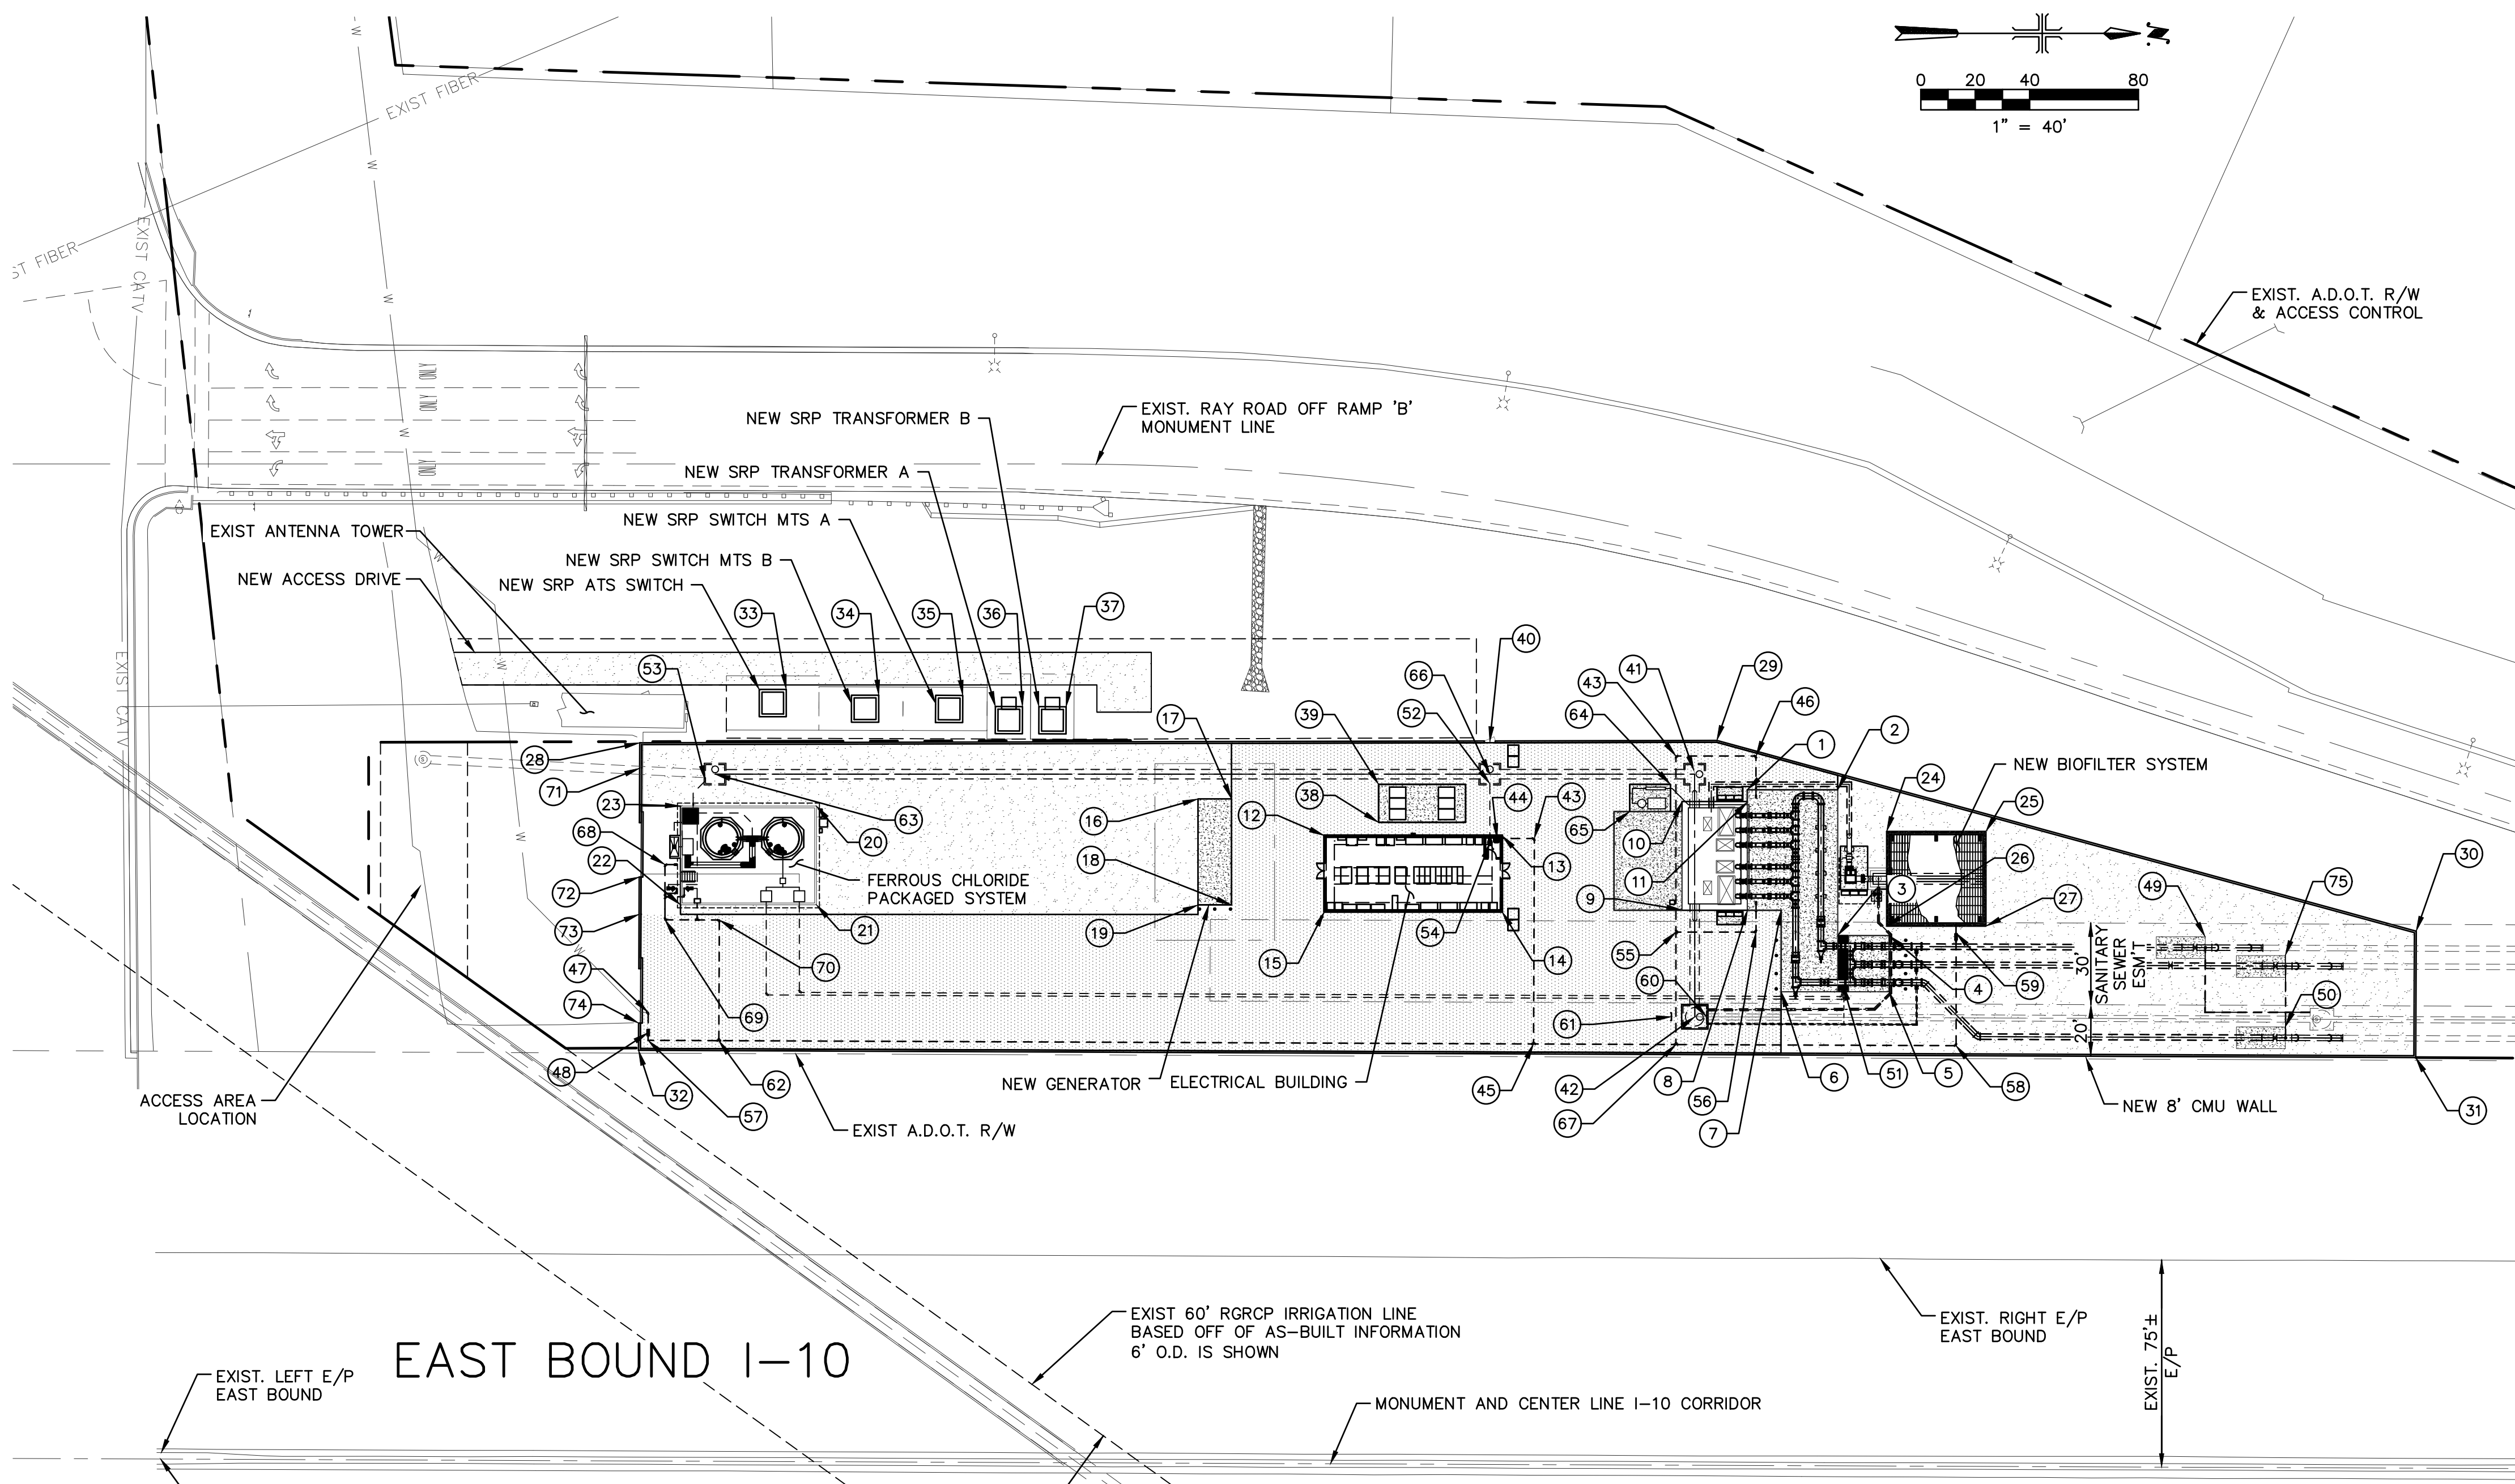

EAST BOUND I-10  
WEST BOUND I-10

**LEGEND**


- NEW AC PAVEMENT
- DECOMPOSED GRANITE
- EXISTING ADOT RIGHT OF WAY
- EXISTING CITY OF PHOENIX SANITARY SEWER EASEMENT

POINT #	NORTHING	EASTING	DESCRIPTION
73	N 844302.02	E 682928.37	End New 8" CMU Wall
74	N 844301.85	E 682968.37	Begin New 8" CMU Wall
75	N 844907.36	E 682943.55	New Launch Conc. Structure


POINT #	NORTHING	EASTING	DESCRIPTION
59	N 844786.28	E 682935.20	New 2" Back Flow Preventor
60	N 844694.55	E 682966.27	New 27" SW Plug/Cap
61	N 844681.65	E 682966.04	New 27" SW Plug/Cap
62	N 844331.35	E 682974.84	New 3"x3"x2" Water Line Tee
63	N 844329.97	E 682876.83	New Sanitary Sewer MH Structure No. 1
64	N 844681.28	E 682880.59	New Instrument Air Storage Area Corner
65	N 844666.28	E 682890.59	New Instrument Air Storage Area Corner
66	N 844614.85	E 682876.83	New Sanitary Sewer MH Structure 2
67	N 844683.28	E 682976.27	New 2" Water Line Tee
68	N 844311.54	E 682910.10	New 2" Water Line 90° Bend
69	N 844311.53	E 682930.39	New 2" Water Line Tee
70	N 844331.53	E 682930.47	New 2" Water Line 90° Bend
71	N 844302.34	E 682874.66	End New 8" CMU Wall
72	N 844302.07	E 682914.66	Begin New 8" CMU Wall

POINT #	NORTHING	EASTING	DESCRIPTION
1	N 844709.66	E 682882.56	New Piping Pad Corner
2	N 844742.77	E 682882.56	New Piping Pad Corner
3	N 844742.77	E 682936.19	New Piping Pad Corner
4	N 844761.67	E 682936.19	New Piping Pad Corner
5	N 844761.67	E 682956.84	New Piping Pad Corner
6	N 844722.00	E 682956.84	New Piping Pad Corner
7	N 844722.00	E 682926.76	New Piping Pad Corner
8	N 844709.65	E 682926.76	New Wet Well Corner/Piping Pad Corner
9	N 844685.50	E 682926.76	New Wet Well Corner
10	N 844685.50	E 682887.00	New Wet Well Corner
11	N 844709.66	E 682887.00	New Wet Well Corner/Piping Pad Corner
12	N 844554.00	E 682899.40	New Electrical Building Corner
13	N 844619.34	E 682899.40	New Electrical Building Corner
14	N 844619.34	E 682927.40	New Electrical Building Corner
15	N 844554.00	E 682927.40	New Electrical Building Corner
16	N 844507.53	E 682885.94	New Generator Slab Corner
17	N 844519.88	E 682885.94	New Generator Slab Corner
18	N 844519.88	E 682924.94	New Generator Slab Corner
19	N 844507.53	E 682924.94	New Generator Slab Corner
20	N 844367.25	E 682888.55	New FeCl <sub>2</sub> Storage Area Wall Corner
21	N 844367.25	E 682924.88	New FeCl <sub>2</sub> Storage Area Wall Corner
22	N 844317.25	E 682924.88	New FeCl <sub>2</sub> Storage Area Wall Corner
23	N 844317.25	E 682888.55	New FeCl <sub>2</sub> Storage Area Wall Corner
24	N 844760.77	E 682897.89	New Biofilter Corner
25	N 8444797.27	E 682897.89	New Biofilter Corner
26	N 844760.77	E 682932.72	New Biofilter Corner
27	N 844797.27	E 682932.72	New Biofilter Corner
28	N 844302.27	E 682865.29	New 8" CMU Wall
29	N 844698.12	E 682863.97	New 8" CMU Wall
30	N 844955.49	E 682934.60	New 8" CMU Wall
31	N 844955.31	E 682981.05	New 8" CMU Wall
32	N 844301.81	E 682978.39	New 8" CMU Wall
33	N 844356.15	E 682845.66	New SRP ATS Switch
34	N 844390.13	E 682847.78	New SRP Switch MTS B
35	N 844421.05	E 682847.88	New SRP Switch MTS A
36	N 844443.01	E 682851.98	New SRP Transformer A
37	N 844459.04	E 682852.05	New SRP Transformer B
38	N 844605.92	E 682894.57	New Service Entrance Corner
39	N 844573.94	E 682880.59	New Service Entrance Corner
40	N 844334.48	E 682865.186	New 3' Wide Man Gate
41	N 844690.13	E 682876.83	New Sanitary Sewer MH Structure No. 3
42	N 844690.22	E 682966.08	New Sanitary Sewer MH Structure No. 4
43	N 844631.22	E 682900.49	New 2" Water Line 90° Bend
44	N 844617.27	E 682900.49	New 2" Water Line Service Elect. Bldg.
45	N 844630.92	E 682976.06	New 2" Water Line Tee
46	N 844612.71	E 682870.16	New 2" Water Line Tee
47	N 844305.39	E 682864.44	New 3" Water Line 90° Bend
48	N 844305.36	E 682971.89	New 3" Back Flow Preventor
49	N 844877.88	E 682936.63	New Launch Conc. Structure
50	N 844907.36	E 682969.77	New Launch Conc. Structure
51	N 844744.77	E 682954.43	FeCl <sub>2</sub> Injection Tap
52	N 844614.85	E 682878.59	New 4" Gravity Sanitary Sewer Line
53	N 844321.92	E 682877.92	New 4" Gravity Sanitary Sewer Line
54	N 844614.84	E 682902.42	New 2" Water Line Tie in
55	N 844683.28	E 682934.93	New 2" Water Line Tee
56	N 844712.74	E 682934.93	New 2" Water Line 90° Bend
57	N 844305.35	E 682974.73	New 3" Water Line 90° Bend
58	N 844786.29	E 682976.69	New 2" Water Line 90° Bend

NO.	BY	DATE	CKD	REVISIONS	REMARKS
A	RS	10/2023	JF	30% SUBMITTAL	
B	RS	01/2024	JF	90% SUBMITTAL	
C	RS	04/2024	JF	AGENCY REVIEW	
D	DFD	08/2024	JF	ISSUED FOR CONSTRUCTION	
*					
*					
*					

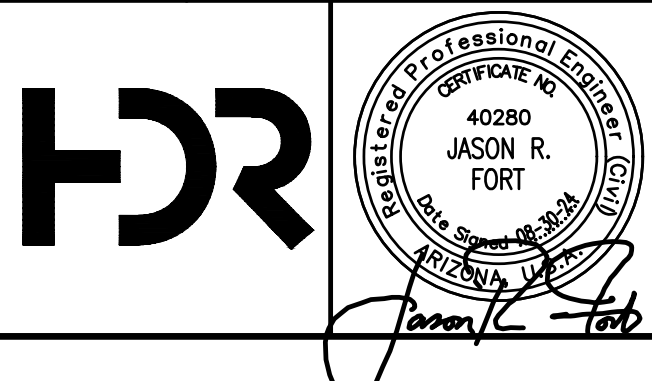

NO.	BY	DATE	CKD	REVISIONS	REMARKS
A	RS	10/2023	JF	30% SUBMITTAL	
B	RS	01/2024	JF	90% SUBMITTAL	
C	RS	04/2024	JF	AGENCY REVIEW	
D	DFD	08/2024	JF	ISSUED FOR CONSTRUCTION	
*					
*					
*					

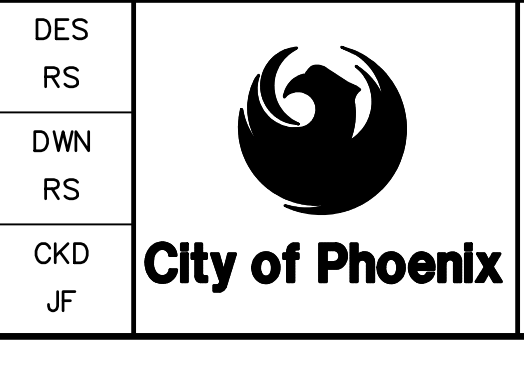

CITY OF PHOENIX  
WATER SERVICES DEPARTMENT  
  
LIFT STATION 40  
REFURBISHMENT

CIVIL  
  
SITE LAYOUT – CONTROL PLAN



COPYRIGHT © 2007–JANUARY  
CITY PROJECT NO. WS90400085  
DATE: 08/2024  
C-20 SHEET 25 OF 134  
CAD FILE: CSCLS40P05.dwg

FACILITY DRAWINGS: This drawing was supplied by a Consultant Engineer from a past project and is provided for information only. The City does not warrant the accuracy of the information provided by the Contractor to provide the Record Drawing. The City does not warrant this drawing to be a complete and accurate portrayal of facilities as they exist in the field.

THIS DRAWING MUST BE FIELD VERIFIED BEFORE USE  
DRAWING NOT TO SCALE UNLESS SCALE BAR IS PRESENT


FOR CONSTRUCTION

"PER CITY OF PHOENIX CODE CHAPTER 2, SECTION 2-2B, THESE PLANS ARE FOR OFFICIAL USE ONLY AND MAY NOT BE SHARED WITH OTHERS EXCEPT AS REQUIRED TO FULFILL THE OBLIGATIONS OF THE CONTRACTOR'S CONTRACT WITH THE CITY OF PHOENIX."  
THIS DOCUMENT MUST BE KEPT SECURE AT ALL TIMES.

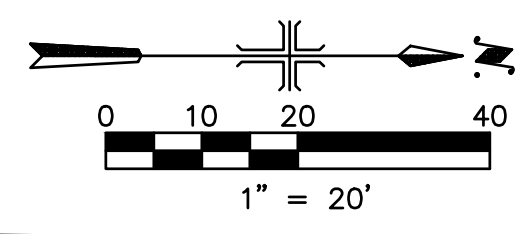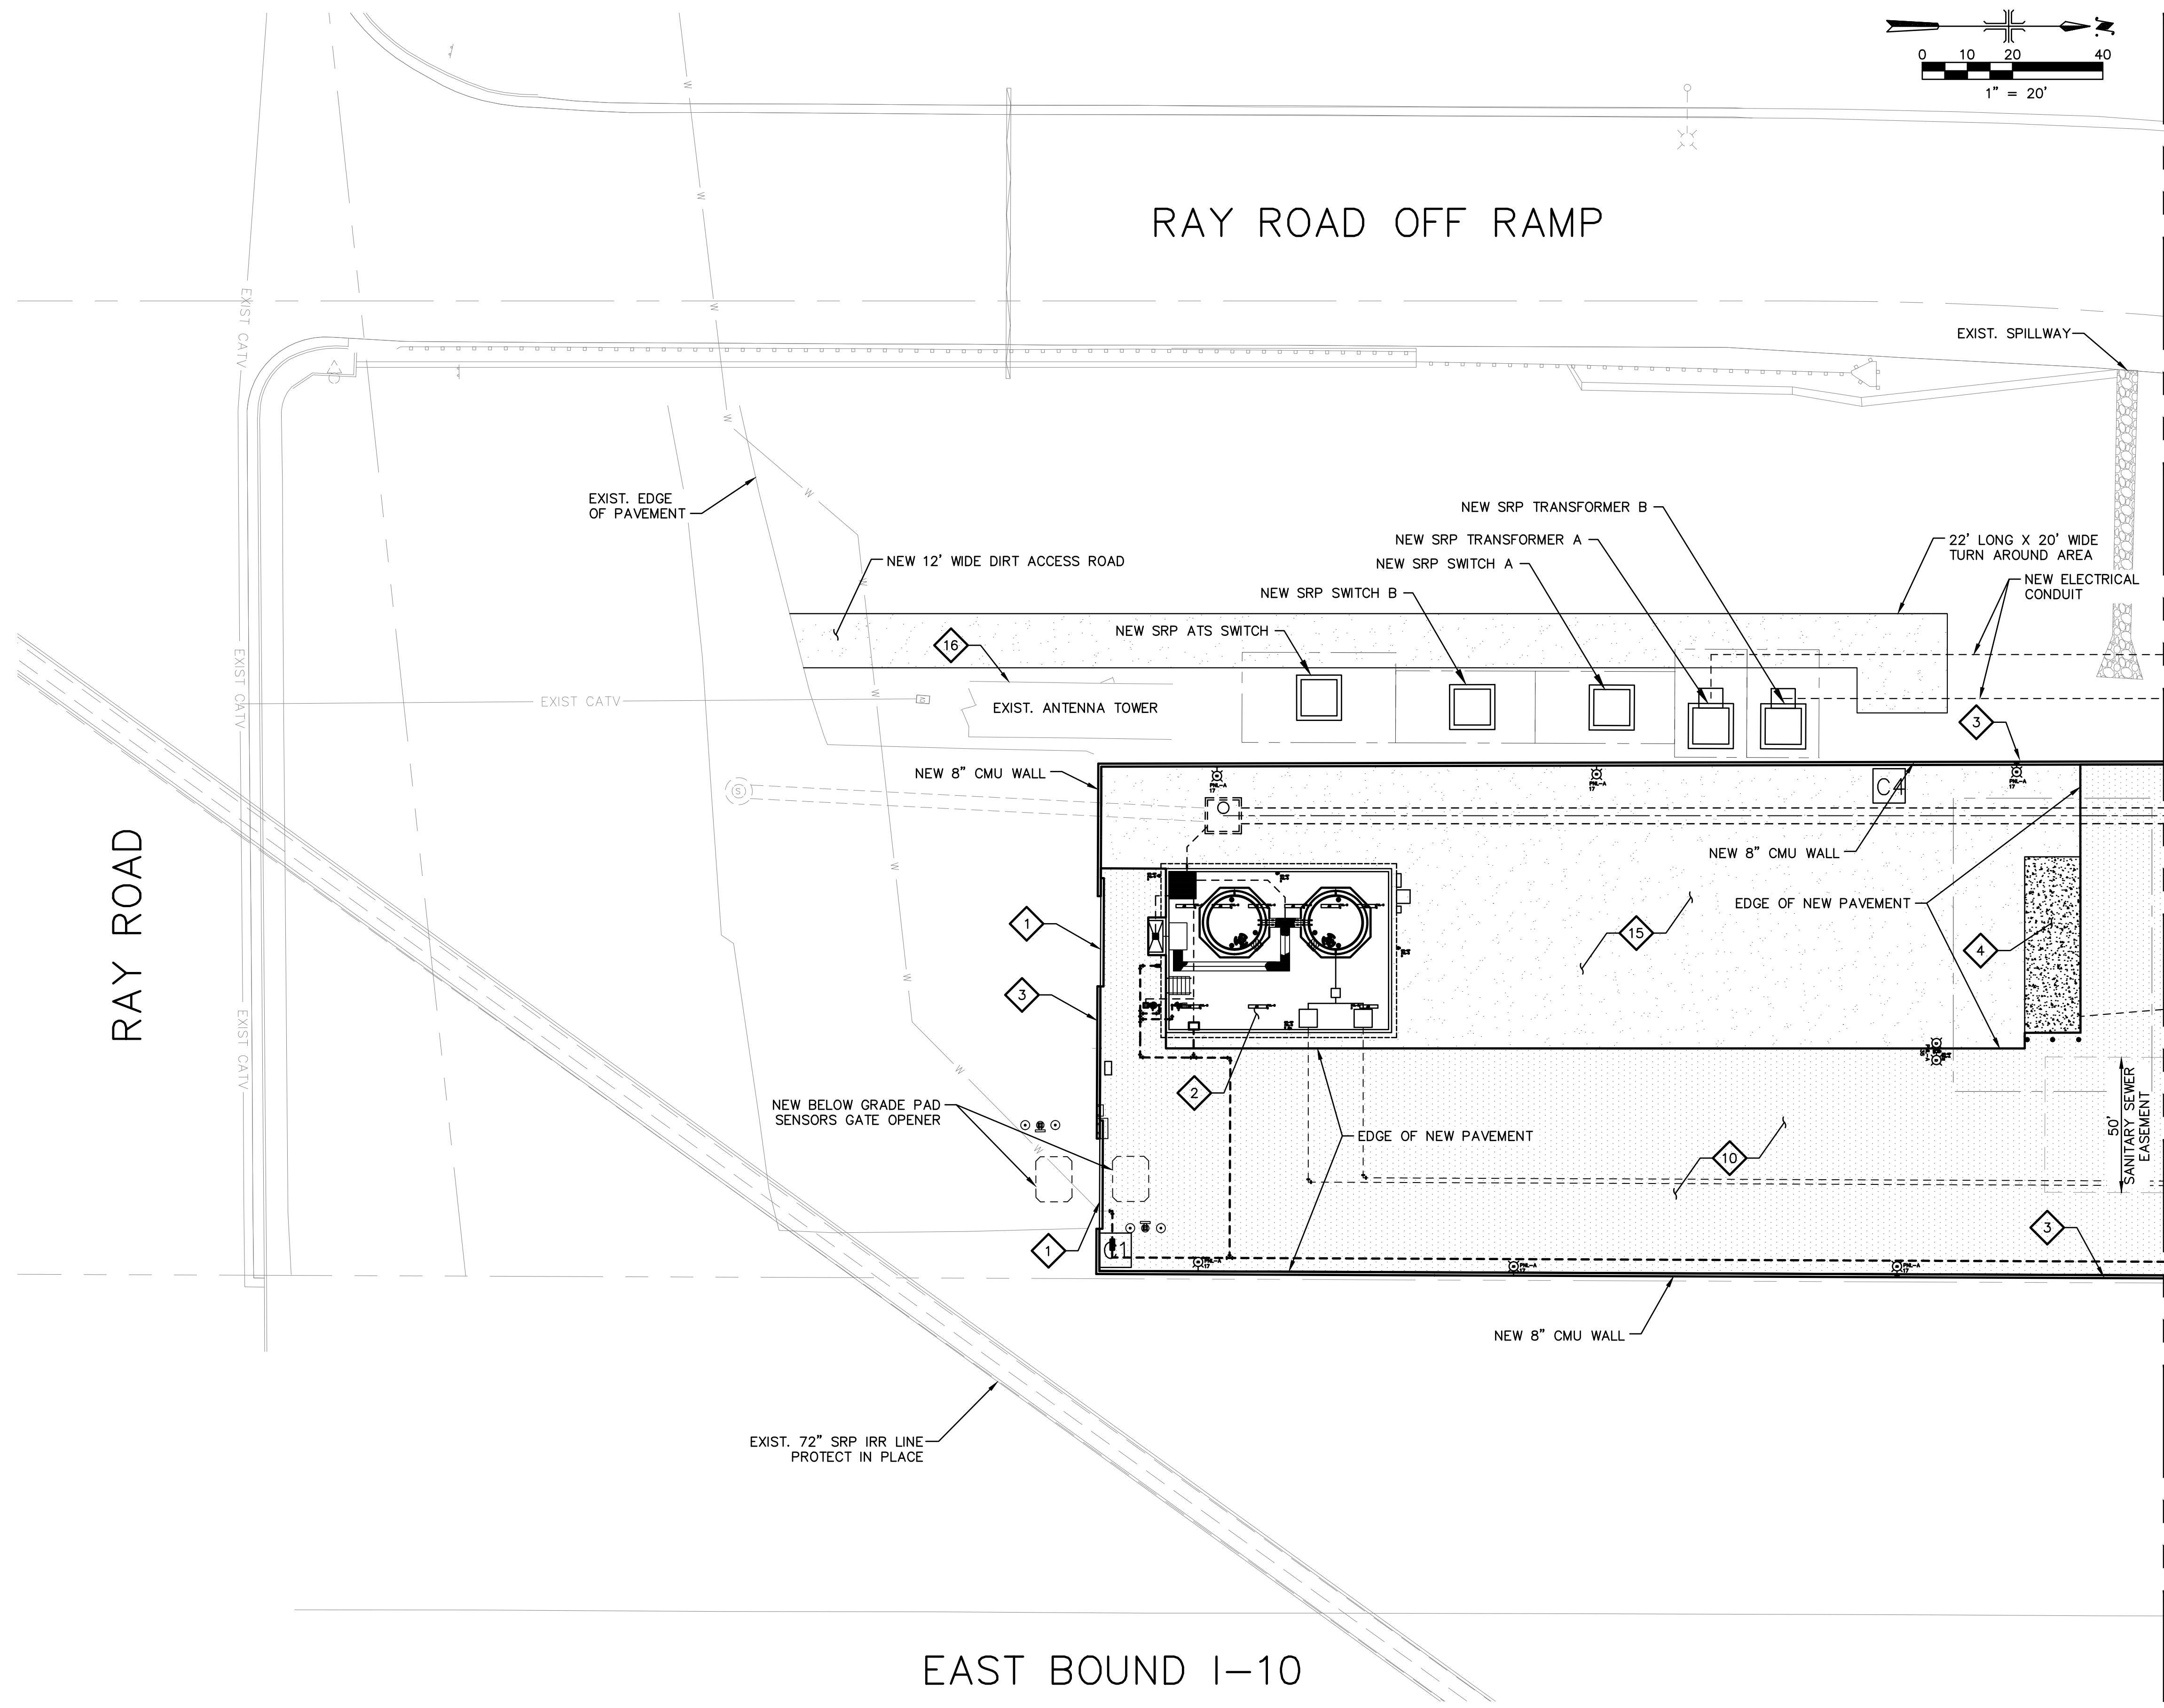

**KEY NOTES**

- 1 INSTALL NEW 20 FOOT WIDE VEHICULAR SLIDE GATE.  
SEE DETAIL 3-6  
C-21 C-03'
- 2 CONSTRUCT NEW FERROUS CHLORIDE STORAGE TANK AND CONTAINMENT. SEE FERROUS CHLORIDE SYSTEM PLAN C-23.
- 3 CONSTRUCT NEW CMU WALL SEE DETAIL 4  
C-21 S-18
- 4 NEW GENERATOR PAD. SEE ELECTRICAL PLANS. EQUIPMENT  
SEE DETAIL 1  
C-21 S-15
- 10 NEW AC PAVEMENT PER STRUCTURAL SECTION NO. 1 ON THIS SHEET.
- 15 INSTALL DECOMPOSED GRANITE.
- 16 PROTECT IN PLACE EXISTING ANTENNA TOWER. DO NOT INTERRUPT SERVICE.

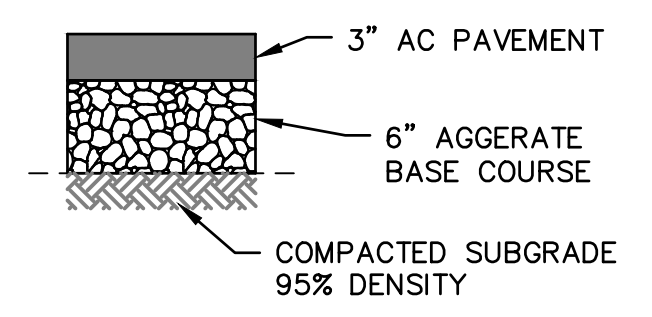

**STRUCTURAL SECTION NO. 1**  
TOTAL THICKNESS = 9"

**LEGEND**

- EQUIPMENT CLEARANCE LINES
- NEW AC PAVEMENT
- DECOMPOSED GRANITE
- NEW ELECTRICAL CONDUIT

**GENERAL NOTES**


1. ALL EXIST ELECTRICAL LINES, EQUIPMENT, CONCRETE PADS AND MANHOLES ARE SHOWN AS PART OF THE SURVEY AND THE OWNER'S UTILITY MAP. FOR ALL ELECTRICAL DEMOLITION, RELOCATION AND ABANDONMENT OF ANY AND ALL ELECTRICAL LINES, EQUIPMENT, CONCRETE PADS AND MANHOLES SEE ELECTRICAL PLANS.
2. FOR ALL NEW IMPROVEMENTS IN THE BIOFILTER AREA SEE SHEET C-29.
3. CONTRACTOR SHALL FIELD ROUTE 2" AND 3" WATER LINES. A MINIMUM 3' COVER IS REQUIRED. PROVIDED FITTINGS, AND APPURTENANCES AS REQUIRED.
4. FOR NEW UTILITIES SEE SHEET C-23 and C-24.
5. CONTRACTOR SHALL ENSURE THAT CONCRETE PADS ARE ADEQUATELY SIZED FOR EQUIPMENT.
6. CHEMICAL CONTAINMENT AREA TO BE COATED PER SPEC SECTION 09 96 17.
7. CHEMICAL UNLOADING AREA INCLUDING TRENCH DRAINS, SUMPS, AND HORIZONTAL PIPE CHASES TO BE COATED PER SPEC SECTION 09 96 16.

FACILITY DRAWINGS  
 This drawing was supplied by a Consultant Engineer from a past construction project. The original construction drawing was modified based on information provided by the Contractor to provide the Record Drawing. The City does not warrant the accuracy and reliability of the information and accurate portrayal of facilities as they exist in the field.

REVISION #	DATE	PROJECT NAME	DWG NUMBER	REMARKS

REVISIONS				
NO.	BY	DATE	CKD	REMARKS
A	RS	10/2023	JF	30% SUBMITTAL
B	RS	01/2024	JF	90% SUBMITTAL
C	RS	04/2024	JF	AGENCY REVIEW
D	FD	08/2024	JF	ISSUED FOR CONSTRUCTION

DES	FA
DWN	RS
CKD	JF

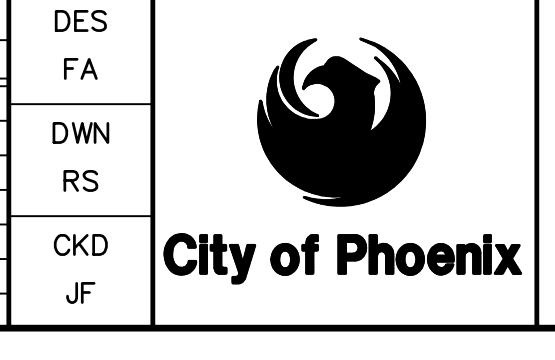

CITY OF PHOENIX  
WATER SERVICES DEPARTMENT  
  
LIFT STATION 40  
REFURBISHMENT

CIVIL

**OVERALL CIVIL SITE PLAN**  
SHEET 1 OF 2



COPYRIGHT © 2007-JANUARY  
CITY PROJECT NO. WS90400085  
DATE: 08/2024  
C-21 SHEET 26 OF 134  
CAD FILE: CSCLS40P06.dwg

USER: FDEPASFRAUD FILE: C:\pwworking\west01\3411640\236\_CSCLS40P06.dwg DATE: 9/04/24 TIME: 03:20pm

THIS DRAWING MUST BE FIELD VERIFIED BEFORE USE  
DRAWING NOT TO SCALE UNLESS SCALE BAR IS PRESENT


FOR CONSTRUCTION

"PER CITY OF PHOENIX CODE CHAPTER 2, SECTION 2-28, THESE PLANS ARE FOR OFFICIAL USE ONLY AND MAY NOT BE SHARED WITH OTHERS EXCEPT AS REQUIRED TO FULFILL THE OBLIGATIONS OF THE CONTRACTOR'S CONTRACT WITH THE CITY OF PHOENIX."  
THIS DOCUMENT MUST BE KEPT SECURE AT ALL TIMES.

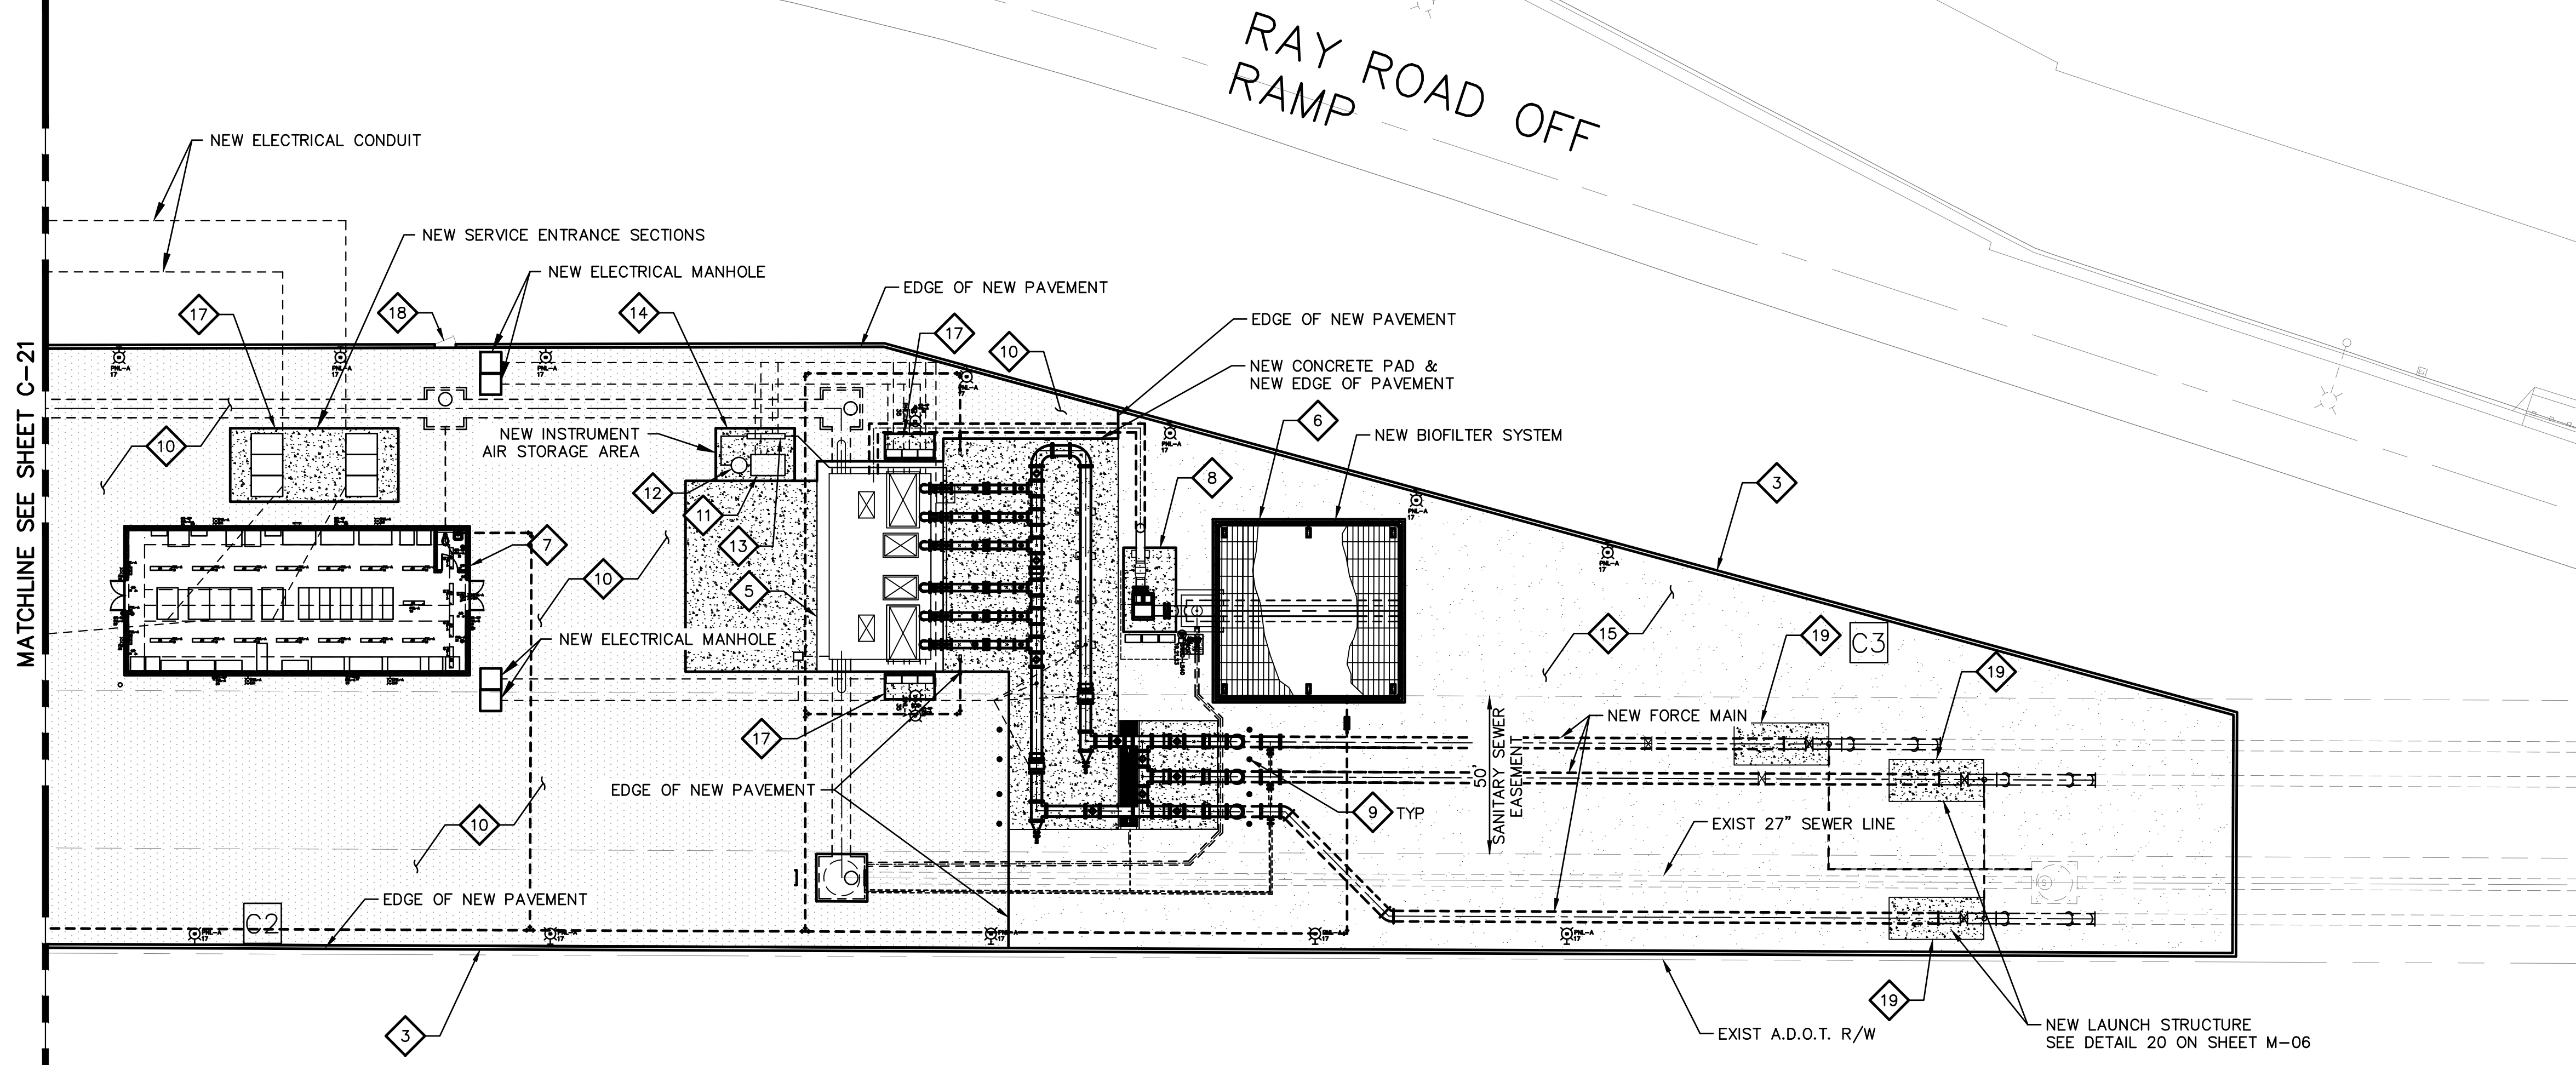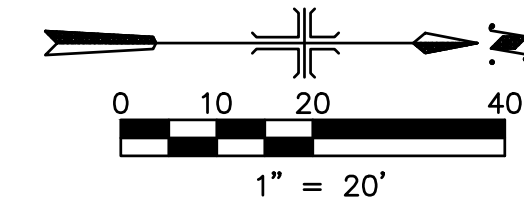

**KEY NOTES**

- 3 CONSTRUCT NEW CMU WALL SEE DETAIL 4 .  
C-22 S-18
- 5 CONSTRUCT NEW WET WELL AND YARD PIPING. SEE YARD PIPING PLAN SHEET M-8 AND WET WELL SECTION SHEET M-13 FOR DETAILS.
- 6 CONSTRUCT NEW BIOFILTER. SEE BIOFILTER ENLARGED PLANS AND SECTIONS. SEE CIVIL SHEET C-29.
- 7 CONSTRUCT NEW ELECTRICAL BUILDING. SEE ARCHITECTURAL AND STRUCTURAL PLANS.
- 8 CONSTRUCT NEW FAD SUPPORT PAD  
SEE DETAIL 1 .  
C-22 S-16
- 9 INSTALL BOLLARD PER MAG STD DET 140.
- 10 NEW AC PAVEMENT PER STRUCTURAL SECTION NO. 1 ON SHEET C-21.
- 11 INSTALL AIR COMPRESSOR SYSTEM PER SPEC SECTION 40 05 62.
- 12 INSTALL VERTICAL AIR STORAGE TANK WITH CAPACITY OF 120 GALLONS AND MAXIMUM WORKING PRESSURE OF 200 PSI. SEE SPEC SECTION 40 05 62 FOR DETAILS.
- 13 INSTALL INSTRUMENT AIR SOLENOID CABINET.  
SEE DETAIL 20 .  
C-22 M-05
- 14 INSTALL SHADE CANOPY STRUCTURE FOR AIR INSTRUMENT STORAGE AREA.
- 15 INSTALL DECOMPOSED GRANITE.
- 17 INSTALL EQUIPMENT PAD. SEE DETAIL 6 ON SHEET S-04
- 18 INSTALL MAN GATE. SEE DETAIL 13 ON SHEET C-04.
- 19 INSTALL PIG LAUNCHING PAD FOUNDATION. SEE SHEETS S-15 FOR DETAILS.

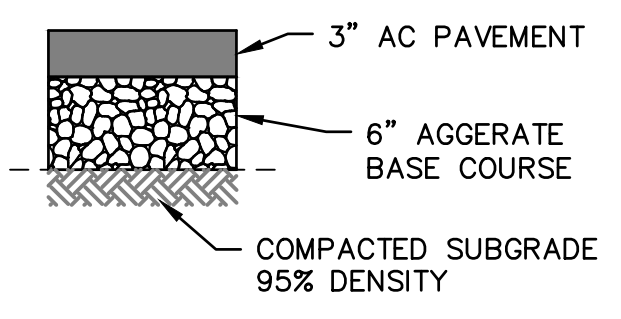


**STRUCTURAL SECTION NO. 1**  
TOTAL THICKNESS = 9"

**GENERAL NOTES**

1. ALL EXIST ELECTRICAL LINES, EQUIPMENT, CONCRETE PADS AND MANHOLES ARE SHOWN AS PART OF THE SURVEY AND THE OWNER'S UTILITY MAP. FOR ALL ELECTRICAL DEMOLITION, RELOCATION AND ABANDONMENT OF ANY AND ALL ELECTRICAL LINES, EQUIPMENT, CONCRETE PADS AND MANHOLES SEE ELECTRICAL PLANS.
2. FOR ALL NEW IMPROVEMENTS IN THE BIOFILTER AREA SEE SHEET C-29.
3. CONTRACTOR SHALL FIELD ROUTE 2" AND 3" WATER LINES. A MINIMUM 3" COVER IS REQUIRED. PROVIDED FITTINGS, AND APPURTENANCES AS REQUIRED.
4. FOR NEW UTILITIES SEE SHEETS C-23 AND C-24.
5. CONTRACTOR SHALL ENSURE THAT CONCRETE PADS ARE ADEQUATELY SIZED FOR EQUIPMENT.

FACILITY DRAWINGS  
This drawing was supplied by a Consultant Engineer from a past project. The City of Phoenix is providing this drawing for informational purposes only. The City does not warrant this drawing to be a complete and accurate portrayal of facilities as they exist in the field.

REVISION	DATE	PROJECT NAME	DWG NUMBER	REMARKS

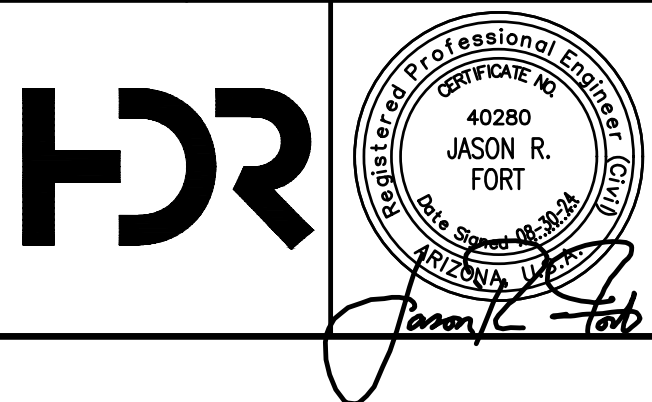

REVISIONS					
NO.	BY	DATE	CKD	REMARKS	
A	RS	10/2023	JF	30% SUBMITTAL	DES
B	RS	01/2024	JF	90% SUBMITTAL	FA
C	RS	04/2024	JF	AGENCY REVIEW	DWN
D	DFD	08/2024	JF	ISSUED FOR CONSTRUCTION	RS
*					CKD
*					JF



CITY OF PHOENIX  
WATER SERVICES DEPARTMENT  
  
LIFT STATION 40  
REFURBISHMENT

CIVIL  
  
OVERALL CIVIL SITE PLAN  
SHEET 2 OF 2


COPYRIGHT © 2007-JANUARY  
CITY PROJECT NO. WS90400085  
DATE: 08/2024  
C-22 SHEET 27 OF 134  
CAD FILE: CSCLS40P07.dwg

USER: FIDESR/ALUD FILE: C:\pwworking\west01\03411840\27\_CSCLS40P07.dwg DATE: 9/04/24 TIME: 03:20pm


FOR CONSTRUCTION

THIS DRAWING MUST BE FIELD VERIFIED BEFORE USE  
DRAWING NOT TO SCALE UNLESS SCALE BAR IS PRESENT

"PER CITY OF PHOENIX CODE CHAPTER 2, SECTION 2-28, THESE PLANS ARE FOR OFFICIAL USE ONLY AND MAY NOT BE SHARED WITH OTHERS EXCEPT AS REQUIRED TO FULFILL THE OBLIGATIONS OF THE CONTRACTOR'S CONTRACT WITH THE CITY OF PHOENIX."  
THIS DOCUMENT MUST BE KEPT SECURE AT ALL TIMES.

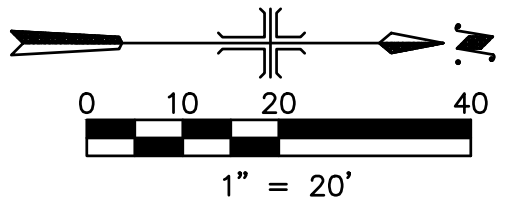

# RAY ROAD OFF RAMP

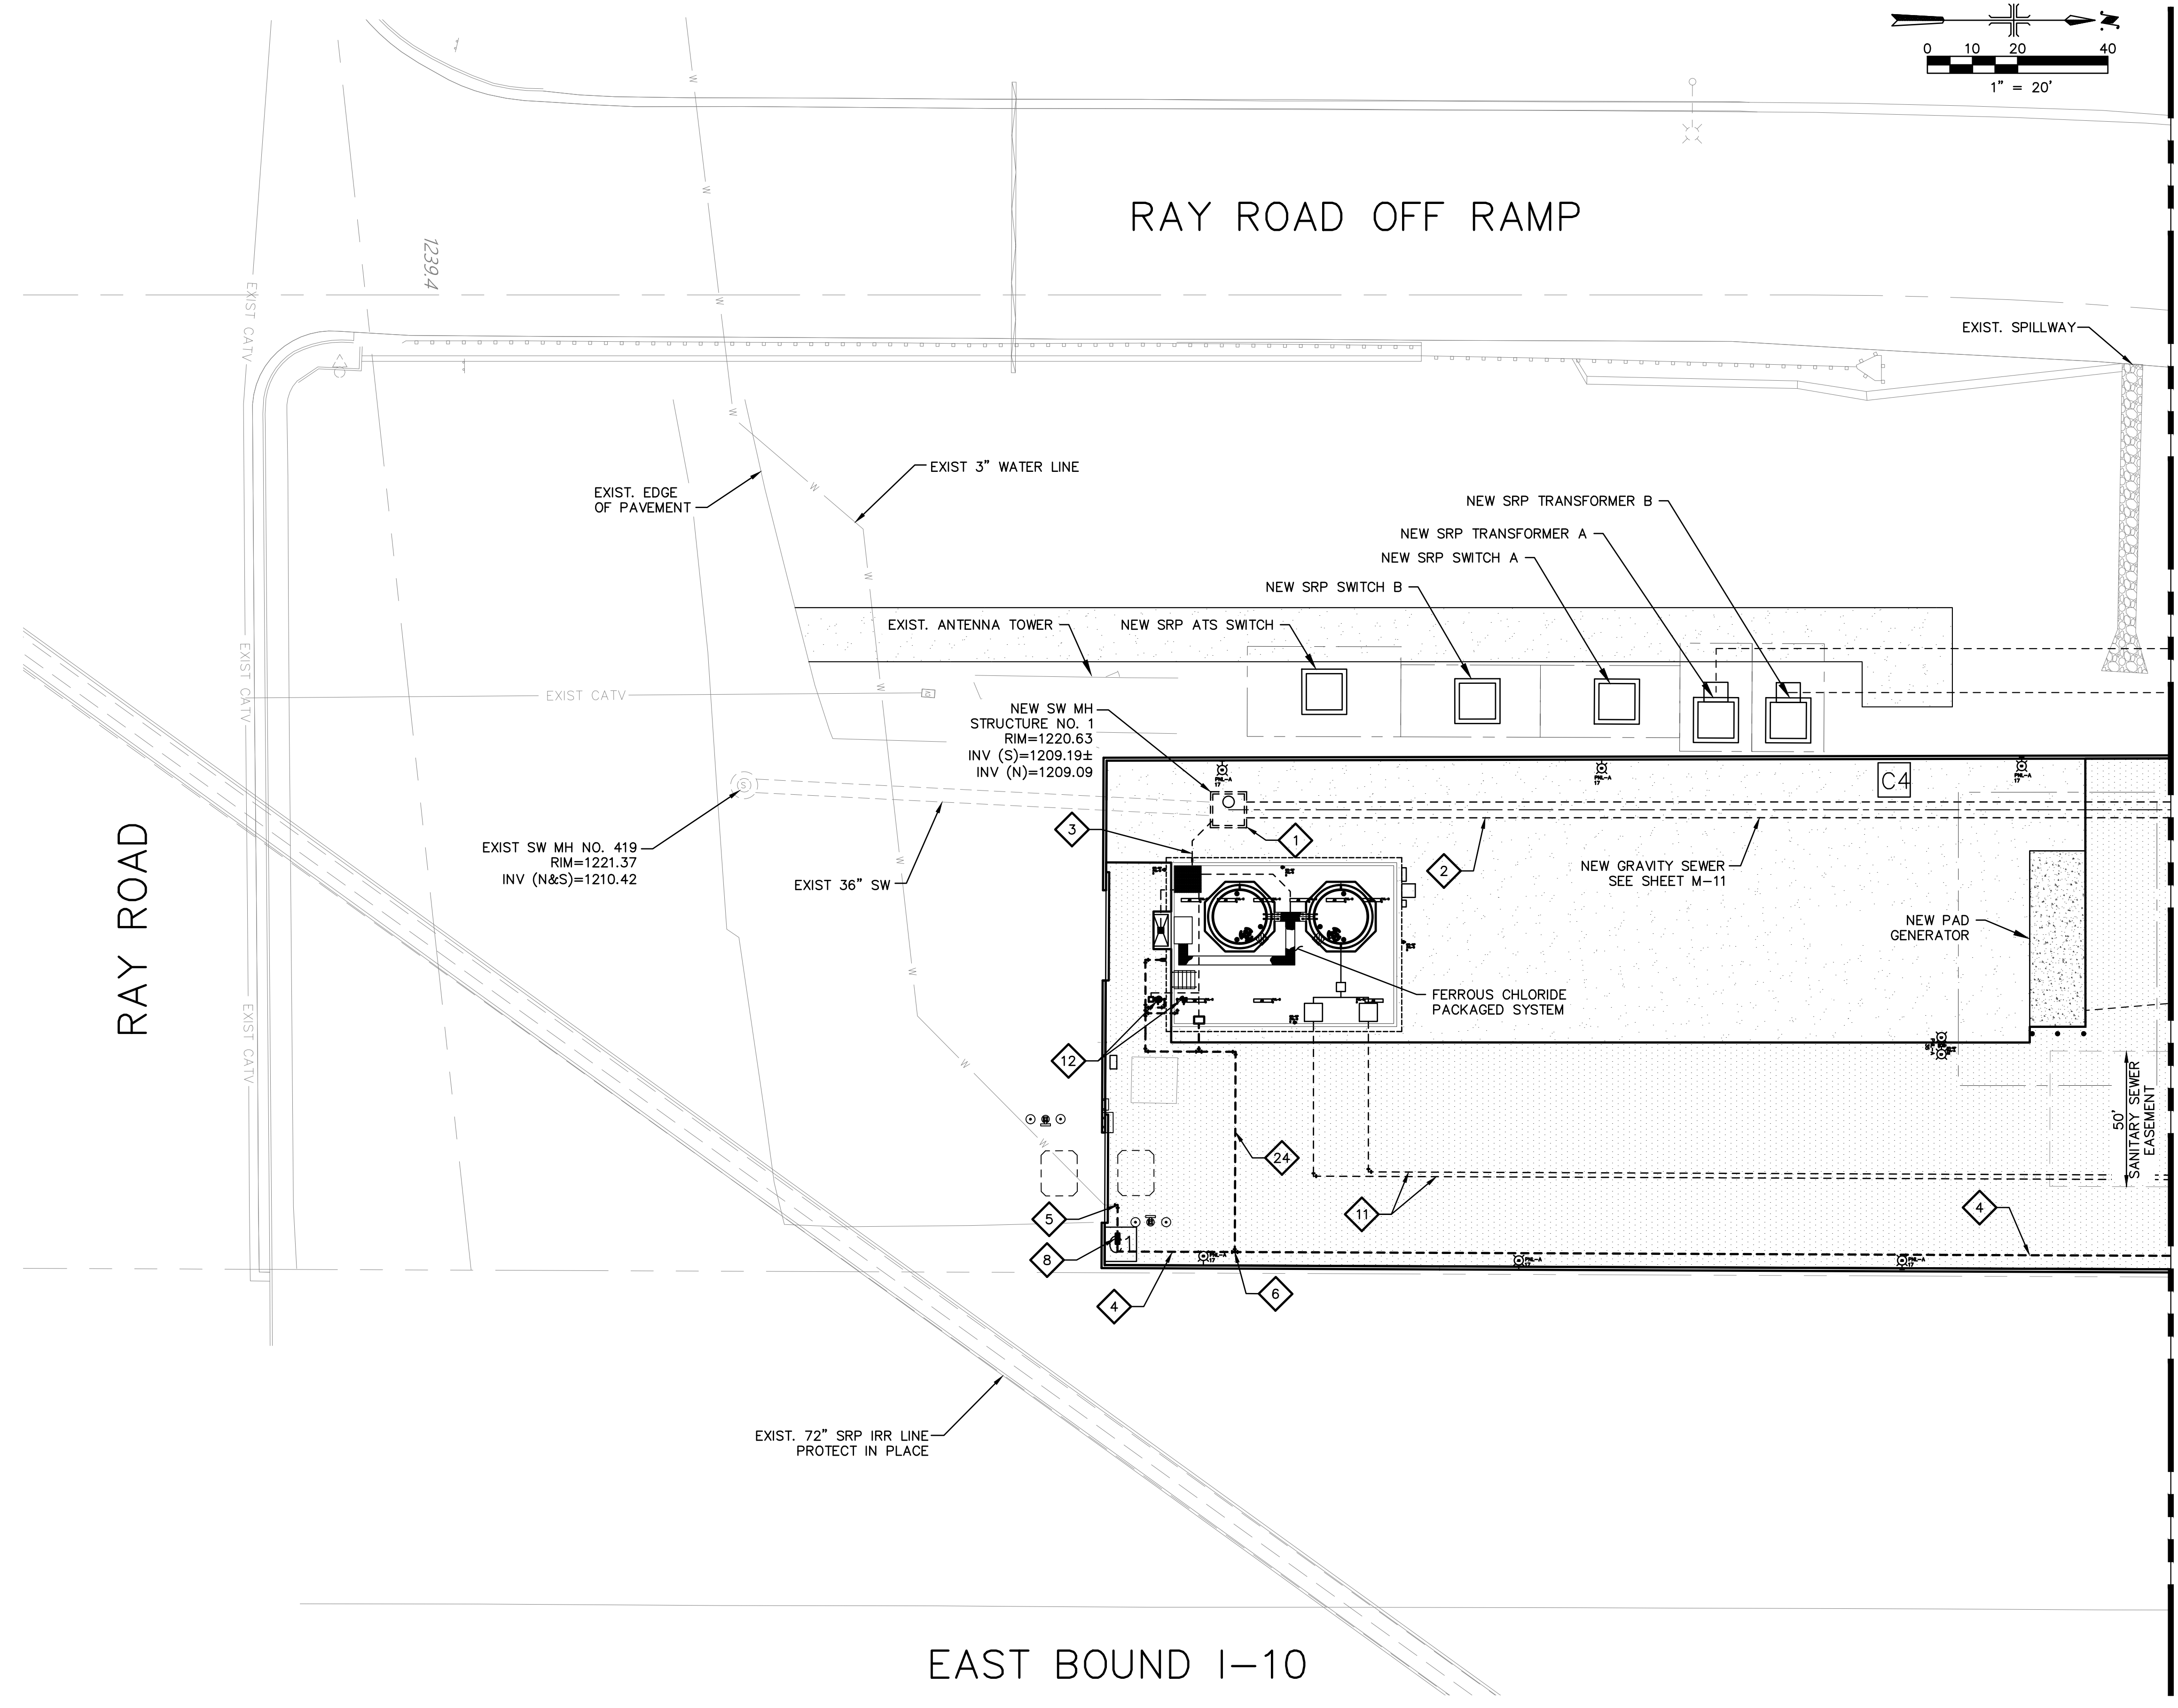

### KEY NOTES

- 1. INSTALL NEW SW MANHOLE PER PLAN VIEW AND DETAIL SECTION 1 SEE SHEET C-05.
- 2. INSTALL NEW 42" VCP GRAVITY SW LINE. SEE ENLARGED PLAN AND PROFILES. SEE SHEET M-11.
- 3. INSTALL NEW 4" PVC GRAVITY SW LINE. SEE PLAN AND PROFILES ON SEE SHEET M-11.
- 4. INSTALL NEW 3" TYPE K COPPER WATER LINE AND FITTINGS. SEE GENERAL NOTE 5.
- 5. SAWCUT AND INSTALL NEW 3" TYPE K COPPER 90° BEND.
- 6. INSTALL NEW 3"x3"x2" WATER TEE.
- 8. INSTALL DOUBLE CHECK VALVE BACKFLOW PREVENTION ASSEMBLY PER COP STD DET. P1353.
- 11. INSTALL NEW 1" DOUBLE CONTAINED SCHEDULE 80 CPVC PIPING AND FITTINGS.
- 12. INSTALL NEW EMERGENCY EYEWASH/SHOWER  
SEE DETAIL 9  
C-23 M-04
- 24. INSTALL NEW 2" TYPE K COPPER WATER LINE. SEE GENERAL NOTE 5.

### LEGEND


- EQUIPMENT CLEARANCE LINES
- NEW AC PAVEMENT
- DECOMPOSED GRANITE

### GENERAL NOTES

1. ALL EXIST ELECTRICAL LINES, EQUIPMENT, CONCRETE PADS AND MANHOLES ARE SHOWN AS PART OF THE SURVEY AND THE OWNER'S UTILITY MAP. FOR ALL ELECTRICAL DEMOLITION, RELOCATION AND ABANDONMENT OF ANY AND ALL ELECTRICAL LINES, EQUIPMENT, CONCRETE PADS AND MANHOLES SEE ELECTRICAL PLANS.
2. CONTRACTOR TO FIELD VERIFY THE LOCATION OF THE STORM DRAIN AND MOVE THE SRP EQUIPMENT ACCORDINGLY WITHOUT REDUCING THE CLEARANCE REQUIRED AS SHOWN BY THE DASHED LINE.
3. ANY DAMAGE TO SRP IRRIGATION PIPE WILL REQUIRE REPLACEMENT AT THE CONTRACTOR'S EXPENSE. FOR SRP UTILITY CROSSING OR PARALLEL TO SRP IRRIGATION PIPE.
4. FOR ALL NEW IMPROVEMENTS IN THE BIOFILTER AREA PLEASE SEE SHEET C-29.
5. CONTRACTOR SHALL FIELD ROUTE 2" AND 3" WATER LINES. A MINIMUM 3' COVER IS REQUIRED. PROVIDED FITTINGS, AND APPURTENANCES AS REQUIRED.
6. IF UNIDENTIFIED COATED/WRAPPED GAS PIPE IS LOCATED, CONTRACTOR SHALL NOTIFY SOUTHWEST GAS AND TREAT AS ASBESTOS PIPE. ALL STEEL GAS PIPE WITH UNIDENTIFIED COATING/WRAPPING MATERIALS ARE CONSIDERED AS POTENTIALLY CONTAINING ASBESTOS.
7. WET WELL AND SANITARY SEWER MANHOLES SHALL BE COATED PER SPEC SECTION 09 96 22.

FACILITY DRAWINGS  
This drawing was supplied by a Consultant Engineer from a past project. The Consultant Engineer is not responsible for the construction information provided by the Contractor to provide the Record Drawing. The City does not warrant this drawing to be a complete and accurate portrayal of facilities as they exist in the field.

FOR CITY OF PHOENIX USE ONLY	REFERENCE	CID NUMBER	#	DATE	PROJECT NAME	DWG NUMBER	REMARKS

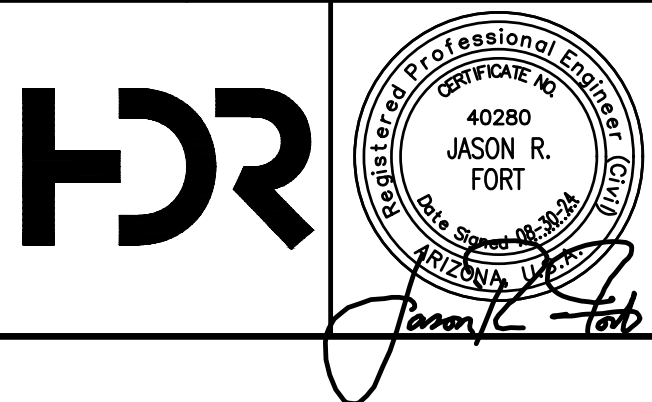

REVISIONS					
NO.	BY	DATE	CKD	REMARKS	
A	RS	10/2023	JF	30% SUBMITTAL	
B	RS	01/2024	JF	90% SUBMITTAL	
C	RS	04/2024	JF	AGENCY REVIEW	
D	DFD	08/2024	JF	ISSUED FOR CONSTRUCTION	
*					
*					
*					

DES  
FA

DWN  
RS

CKD  
JF

City of Phoenix

CITY OF PHOENIX  
WATER SERVICES DEPARTMENT

LIFT STATION 40  
REFURBISHMENT

CIVIL

OVERALL UTILITY PLAN  
SHEET 1 OF 2

COPYRIGHT © 2007-JANUARY

CITY PROJECT NO. WS90400085

DATE: 08/2024

C-23 SHEET 28 OF 134



CAD FILE: CSCLS40P08.DWG

USER: FIDES\FR\AUD FILE: C:\pwworking\west01\03411840\08\_CSCLS40P08.dwg DATE: 9/04/24 TIME: 03:21pm

THIS DRAWING MUST BE FIELD VERIFIED BEFORE USE  
DRAWING NOT TO SCALE UNLESS SCALE BAR IS PRESENT

FOR CONSTRUCTION

"PER CITY OF PHOENIX CODE CHAPTER 2, SECTION 2-28, THESE PLANS ARE FOR OFFICIAL USE ONLY AND MAY NOT BE SHARED WITH OTHERS EXCEPT AS REQUIRED TO FULFILL THE OBLIGATIONS OF THE CONTRACTOR'S CONTRACT WITH THE CITY OF PHOENIX."  
THIS DOCUMENT MUST BE KEPT SECURE AT ALL TIMES.

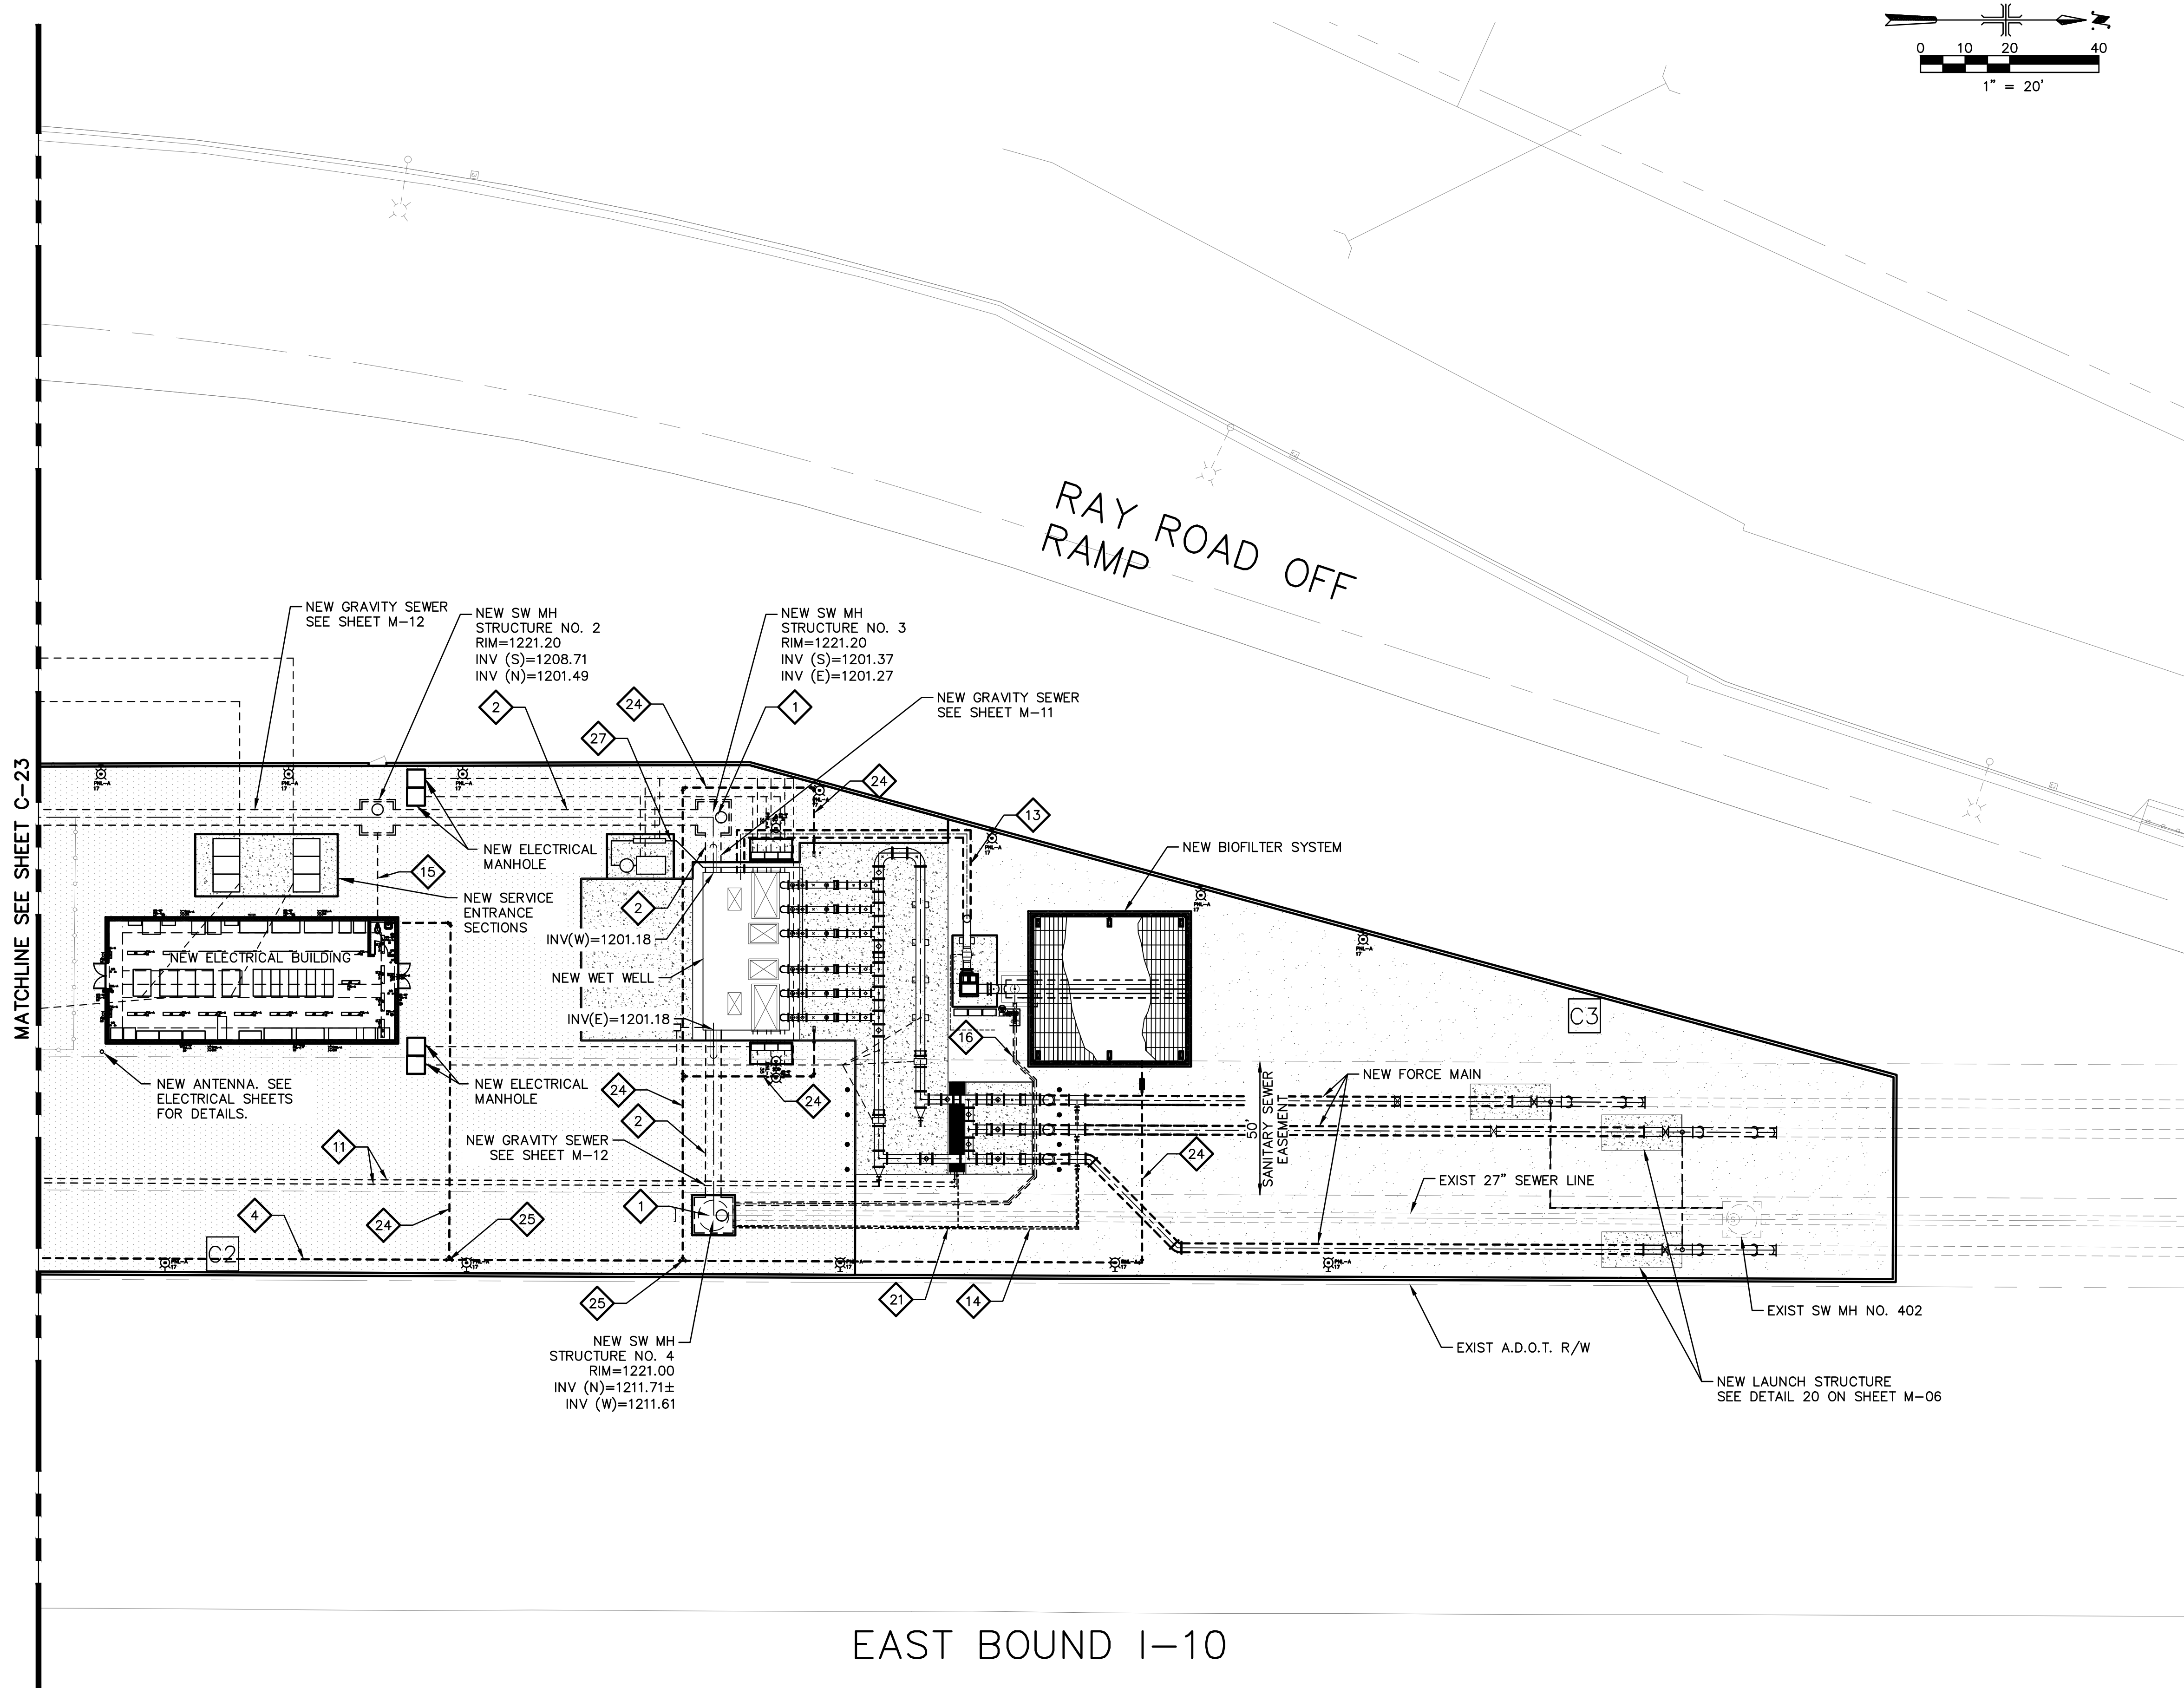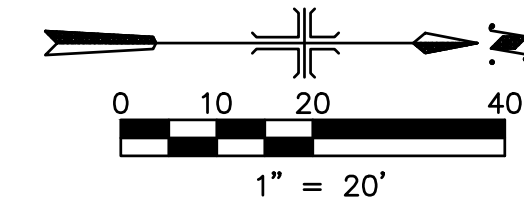

**KEY NOTES**

- 1 INSTALL NEW SW MANHOLE PER PLAN VIEW AND DETAIL SECTION 1 SEE SHEET C-07.
- 2 INSTALL NEW 42" VCP GRAVITY SW LINE. SEE ENLARGED PLAN AND PROFILES. SEE SHEET M-11.
- 4 INSTALL NEW 3" TYPE K COPPER WATER LINE AND FITTINGS. SEE GENERAL NOTE 5.
- 11 INSTALL NEW 1" DOUBLE CONTAINED SCHEDULE 80 CPVC PIPING AND FITTINGS.
- 13 INSTALL NEW 20" FRP FAD TO WET WELL.
- 14 INSTALL NEW 6" DIP DRAIN LINE FROM FORCE MAINS TO SW MANHOLE.
- 15 INSTALL NEW 4" PVC SANITARY SEWER LINE.
- 16 INSTALL NEW 8" CPVC DRAIN LINE TO SW MANHOLE.
- 21 INSTALL 6" DIP SW PIPE FROM INJECTION QUILL TRENCH TO MANHOLE STRUCTURE NO. 4.
- 24 INSTALL NEW 2" TYPE K COPPER WATER LINE. SEE GENERAL NOTE 5.
- 25 INSTALL NEW 3"x3"x2" WATER TEE.
- 27 INSTALL 3/4" TYPE K COPPER AIR SUPPLY LINE. CONTRACTOR TO COORDINATE WITH AIR COMPRESSOR AND AIR ACTUATOR MANUFACTURERS TO INSTALL VALVES AND APPURTENANCES.

**LEGEND**


- EQUIPMENT CLEARANCE LINES
- NEW AC PAVEMENT
- DECOMPOSED GRANITE

**GENERAL NOTES**


1. ALL EXIST ELECTRICAL LINES, EQUIPMENT, CONCRETE PADS AND MANHOLES ARE SHOWN AS PART OF THE SURVEY AND THE OWNER'S UTILITY MAP. FOR ALL ELECTRICAL DEMOLITION, RELOCATION AND ABANDONMENT OF ANY AND ALL ELECTRICAL LINES, EQUIPMENT, CONCRETE PADS AND MANHOLES SEE ELECTRICAL PLANS.
2. CONTRACTOR TO FIELD VERIFY THE LOCATION OF THE STORM DRAIN AND MOVE THE SRP EQUIPMENT ACCORDINGLY WITHOUT REDUCING THE CLEARANCE REQUIRED AS SHOWN BY THE DASHED LINE.
3. ANY DAMAGE TO SRP IRRIGATION PIPE WILL REQUIRE REPLACEMENT AT THE CONTRACTOR'S EXPENSE. FOR SRP UTILITY CROSSING OR PARALLEL TO SRP IRRIGATION PIPE.
4. FOR ALL NEW IMPROVEMENTS IN THE BIOFILTER AREA PLEASE SEE SHEET C-29.
5. CONTRACTOR SHALL FIELD ROUTE 2" AND 3" WATER LINES. A MINIMUM 3' COVER IS REQUIRED. PROVIDED FITTINGS, AND APPURTENANCES AS REQUIRED.
6. IF UNIDENTIFIED COATED/WRAPPED GAS PIPE IS LOCATED, CONTRACTOR SHALL NOTIFY SOUTHWEST GAS AND TREAT AS ASBESTOS PIPE. ALL STEEL GAS PIPE WITH UNIDENTIFIED COATING/WRAPPING MATERIALS ARE CONSIDERED AS POTENTIALLY CONTAINING ASBESTOS.
7. WET WELL AND SANITARY SEWER MANHOLES SHALL BE COATED PER SPEC SECTION 09 96 22.

FACILITY DRAWINGS  
 This drawing was supplied by a Consultant Engineer from a past construction project. The City of Phoenix is providing this information for informational purposes only. The City does not warrant the accuracy or completeness of the information provided in this drawing. The City does not warrant the accuracy or completeness of the information provided in this drawing. The City does not warrant the accuracy or completeness of the information provided in this drawing.

FOR CITY OF PHOENIX USE ONLY - REFERENCE CID NUMBER: #	DATE	CAD FILE NAME	DWG NUMBER	REMARKS

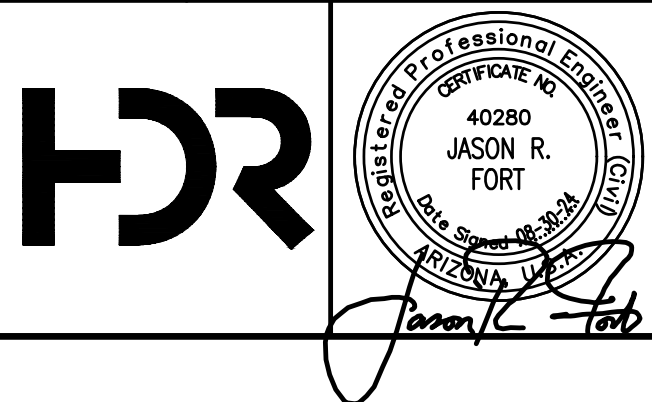

REVISIONS				
NO.	BY	DATE	CKD	REMARKS
A	RS	10/2023	JF	30% SUBMITTAL
B	RS	01/2024	JF	90% SUBMITTAL
C	RS	04/2024	JF	AGENCY REVIEW
D	DFD	08/2024	JF	ISSUED FOR CONSTRUCTION
*				
*				
*				

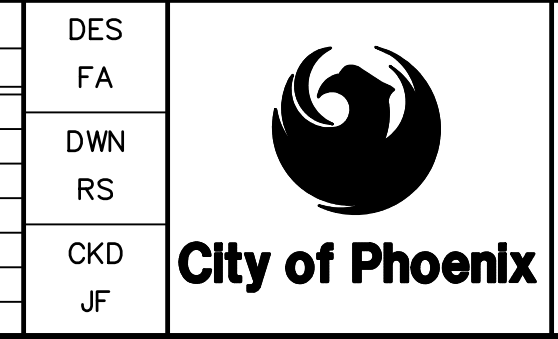

CITY OF PHOENIX  
WATER SERVICES DEPARTMENT

LIFT STATION 40  
REFURBISHMENT

CIVIL

OVERALL UTILITY PLAN  
SHEET 2 OF 2

COPYRIGHT © 2007-JANUARY

CITY PROJECT NO. WS90400085

DATE: 08/2024

C-24 SHEET 29 OF 134


CAD FILE: CSCLS40P09.dwg

USER: FIDESR/ALUD FILE: C:\pwworking\west01\33411840\39\_CSCLS40P09.dwg DATE: 9/04/24 TIME: 03:21pm

THIS DRAWING MUST BE FIELD VERIFIED BEFORE USE  
DRAWING NOT TO SCALE UNLESS SCALE BAR IS PRESENT

FOR CONSTRUCTION

"PER CITY OF PHOENIX CODE CHAPTER 2, SECTION 2-28, THESE PLANS ARE FOR OFFICIAL USE ONLY AND MAY NOT BE SHARED WITH OTHERS EXCEPT AS REQUIRED TO FULFILL THE OBLIGATIONS OF THE CONTRACTOR'S CONTRACT WITH THE CITY OF PHOENIX."  
THIS DOCUMENT MUST BE KEPT SECURE AT ALL TIMES.

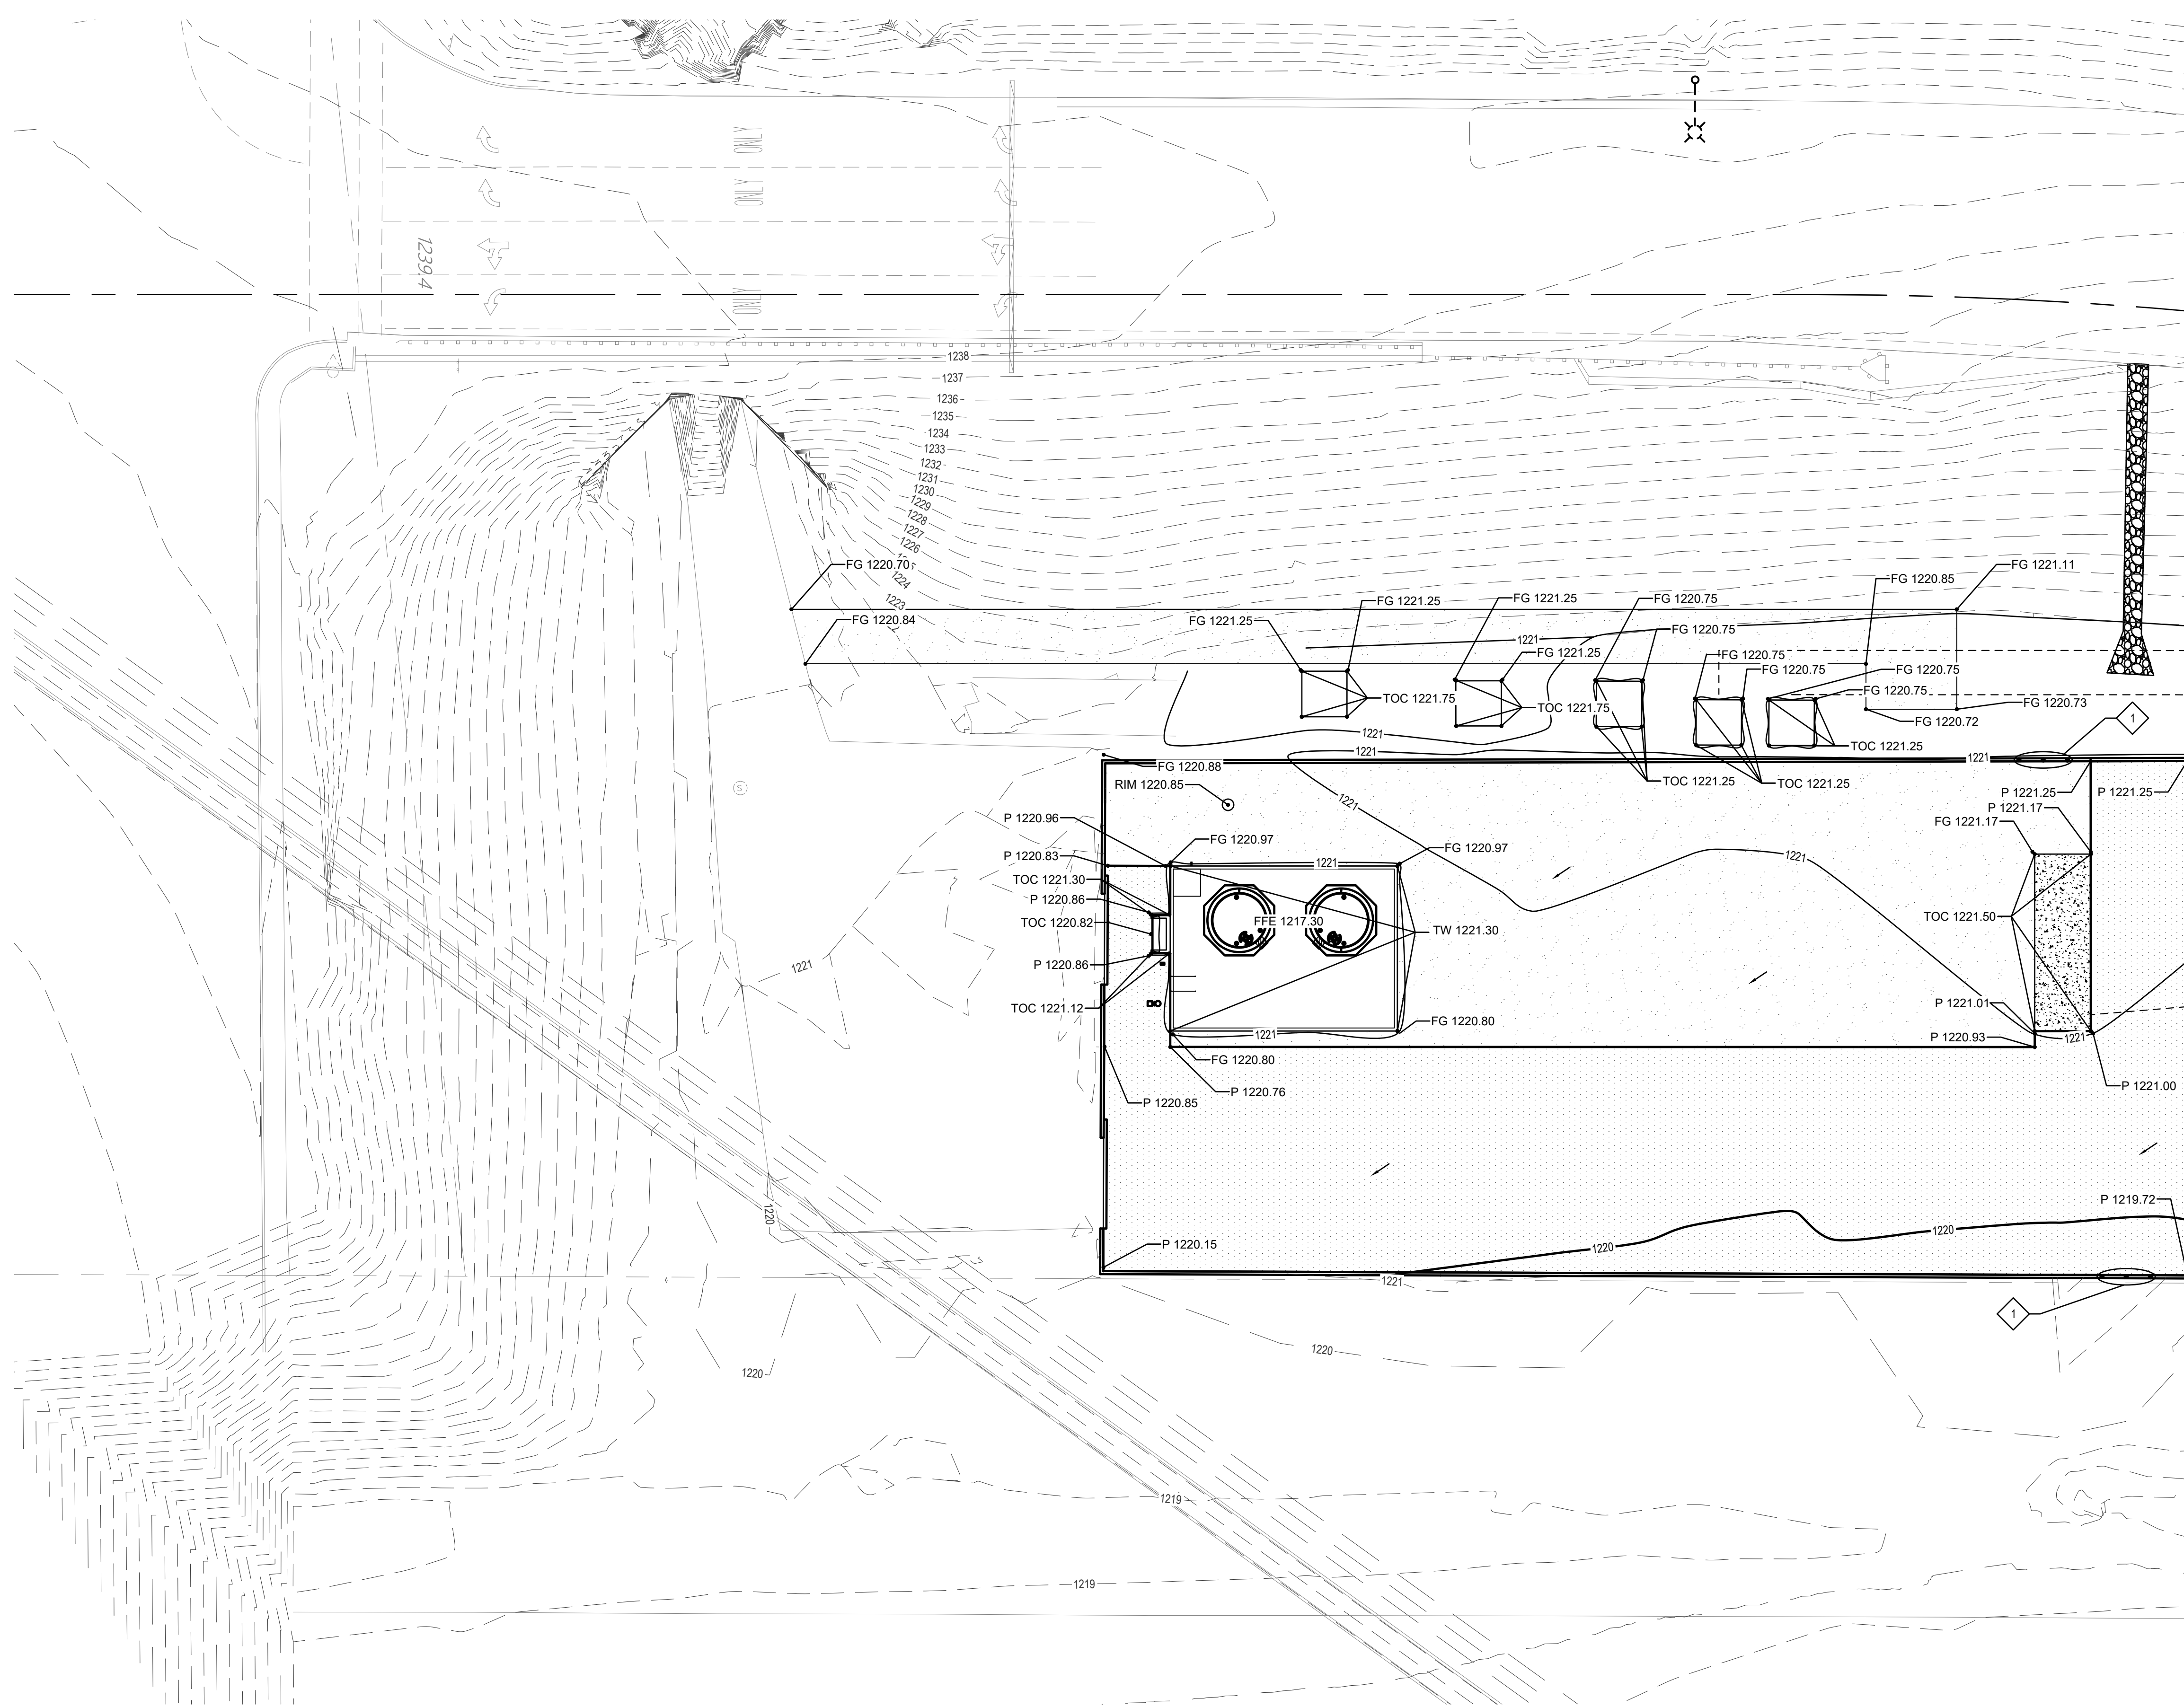


**KEY NOTES**

- 1 INSTALL DRAIN HOLES 5'-4" ± OC ALONG ENTIRE EAST AND WEST SIDE OF CMU WALL PER DETAIL


4  
C-25 S-18

FACILITY DRAWINGS  
This drawing was supplied by a Consultant Engineer from a past construction project. The Consultant Engineer is not responsible for the information provided by the Contractor to provide the Record Drawing. The City does not warrant this drawing to be a complete and accurate portrayal of facilities as they exist in the field.

FOR CITY OF PHOENIX USE ONLY - REFERENCE CID NUMBER: #	DATE	CAD FILE NAME	DWG NUMBER	REMARKS
REVISION ENGINEERING COMPANY	PROJECT NO.	PROJECT NAME		
#				
#				
#				

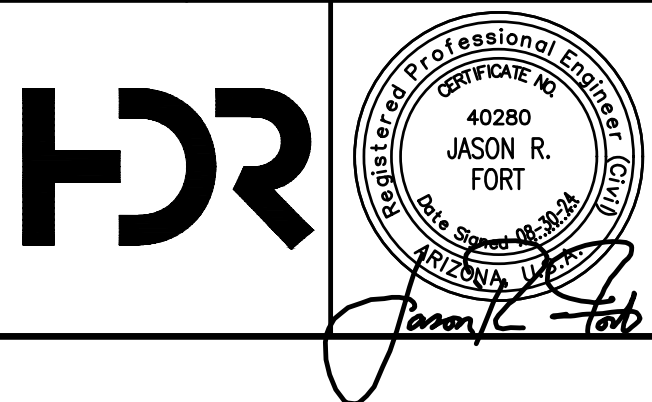

NO.	BY	DATE	CKD	REMARKS
A	RS	10/2023	JF	30% SUBMITTAL
B	RS	01/2024	JF	90% SUBMITTAL
C	RS	04/2024	JF	AGENCY REVIEW
D	DFD	08/2024	JF	ISSUED FOR CONSTRUCTION
*				
*				
*				

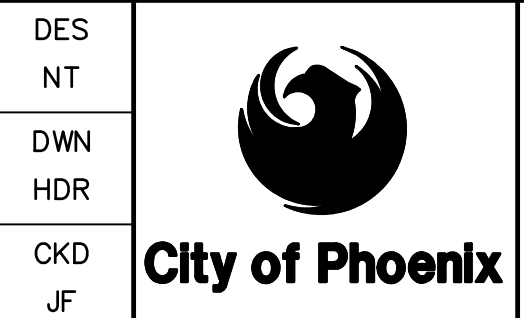

CITY OF PHOENIX  
WATER SERVICES DEPARTMENT  
  
LIFT STATION 40  
REFURBISHMENT

CIVIL  
  
GRADING AND DRAINAGE PLAN 01


COPYRIGHT © 2007-JANUARY  
CITY PROJECT NO. WS90400085  
DATE: 08/2024  
C-25 SHEET 30 OF 134  
CAD FILE: CSCLS40V01.dwg

USER: FBERASFRALD0 FILE: C:\pwworking\west01\03411840\30\_CSCLS40V01.dwg DATE: 9/04/24 TIME: 03:21pm

THIS DRAWING MUST BE FIELD VERIFIED BEFORE USE  
DRAWING NOT TO SCALE UNLESS SCALE BAR IS PRESENT

FOR CONSTRUCTION

"PER CITY OF PHOENIX CODE CHAPTER 2, SECTION 2-28, THESE PLANS ARE FOR OFFICIAL USE ONLY AND MAY NOT BE SHARED WITH OTHERS EXCEPT AS REQUIRED TO FULFILL THE OBLIGATIONS OF THE CONTRACTOR'S CONTRACT WITH THE CITY OF PHOENIX."  
THIS DOCUMENT MUST BE KEPT SECURE AT ALL TIMES.

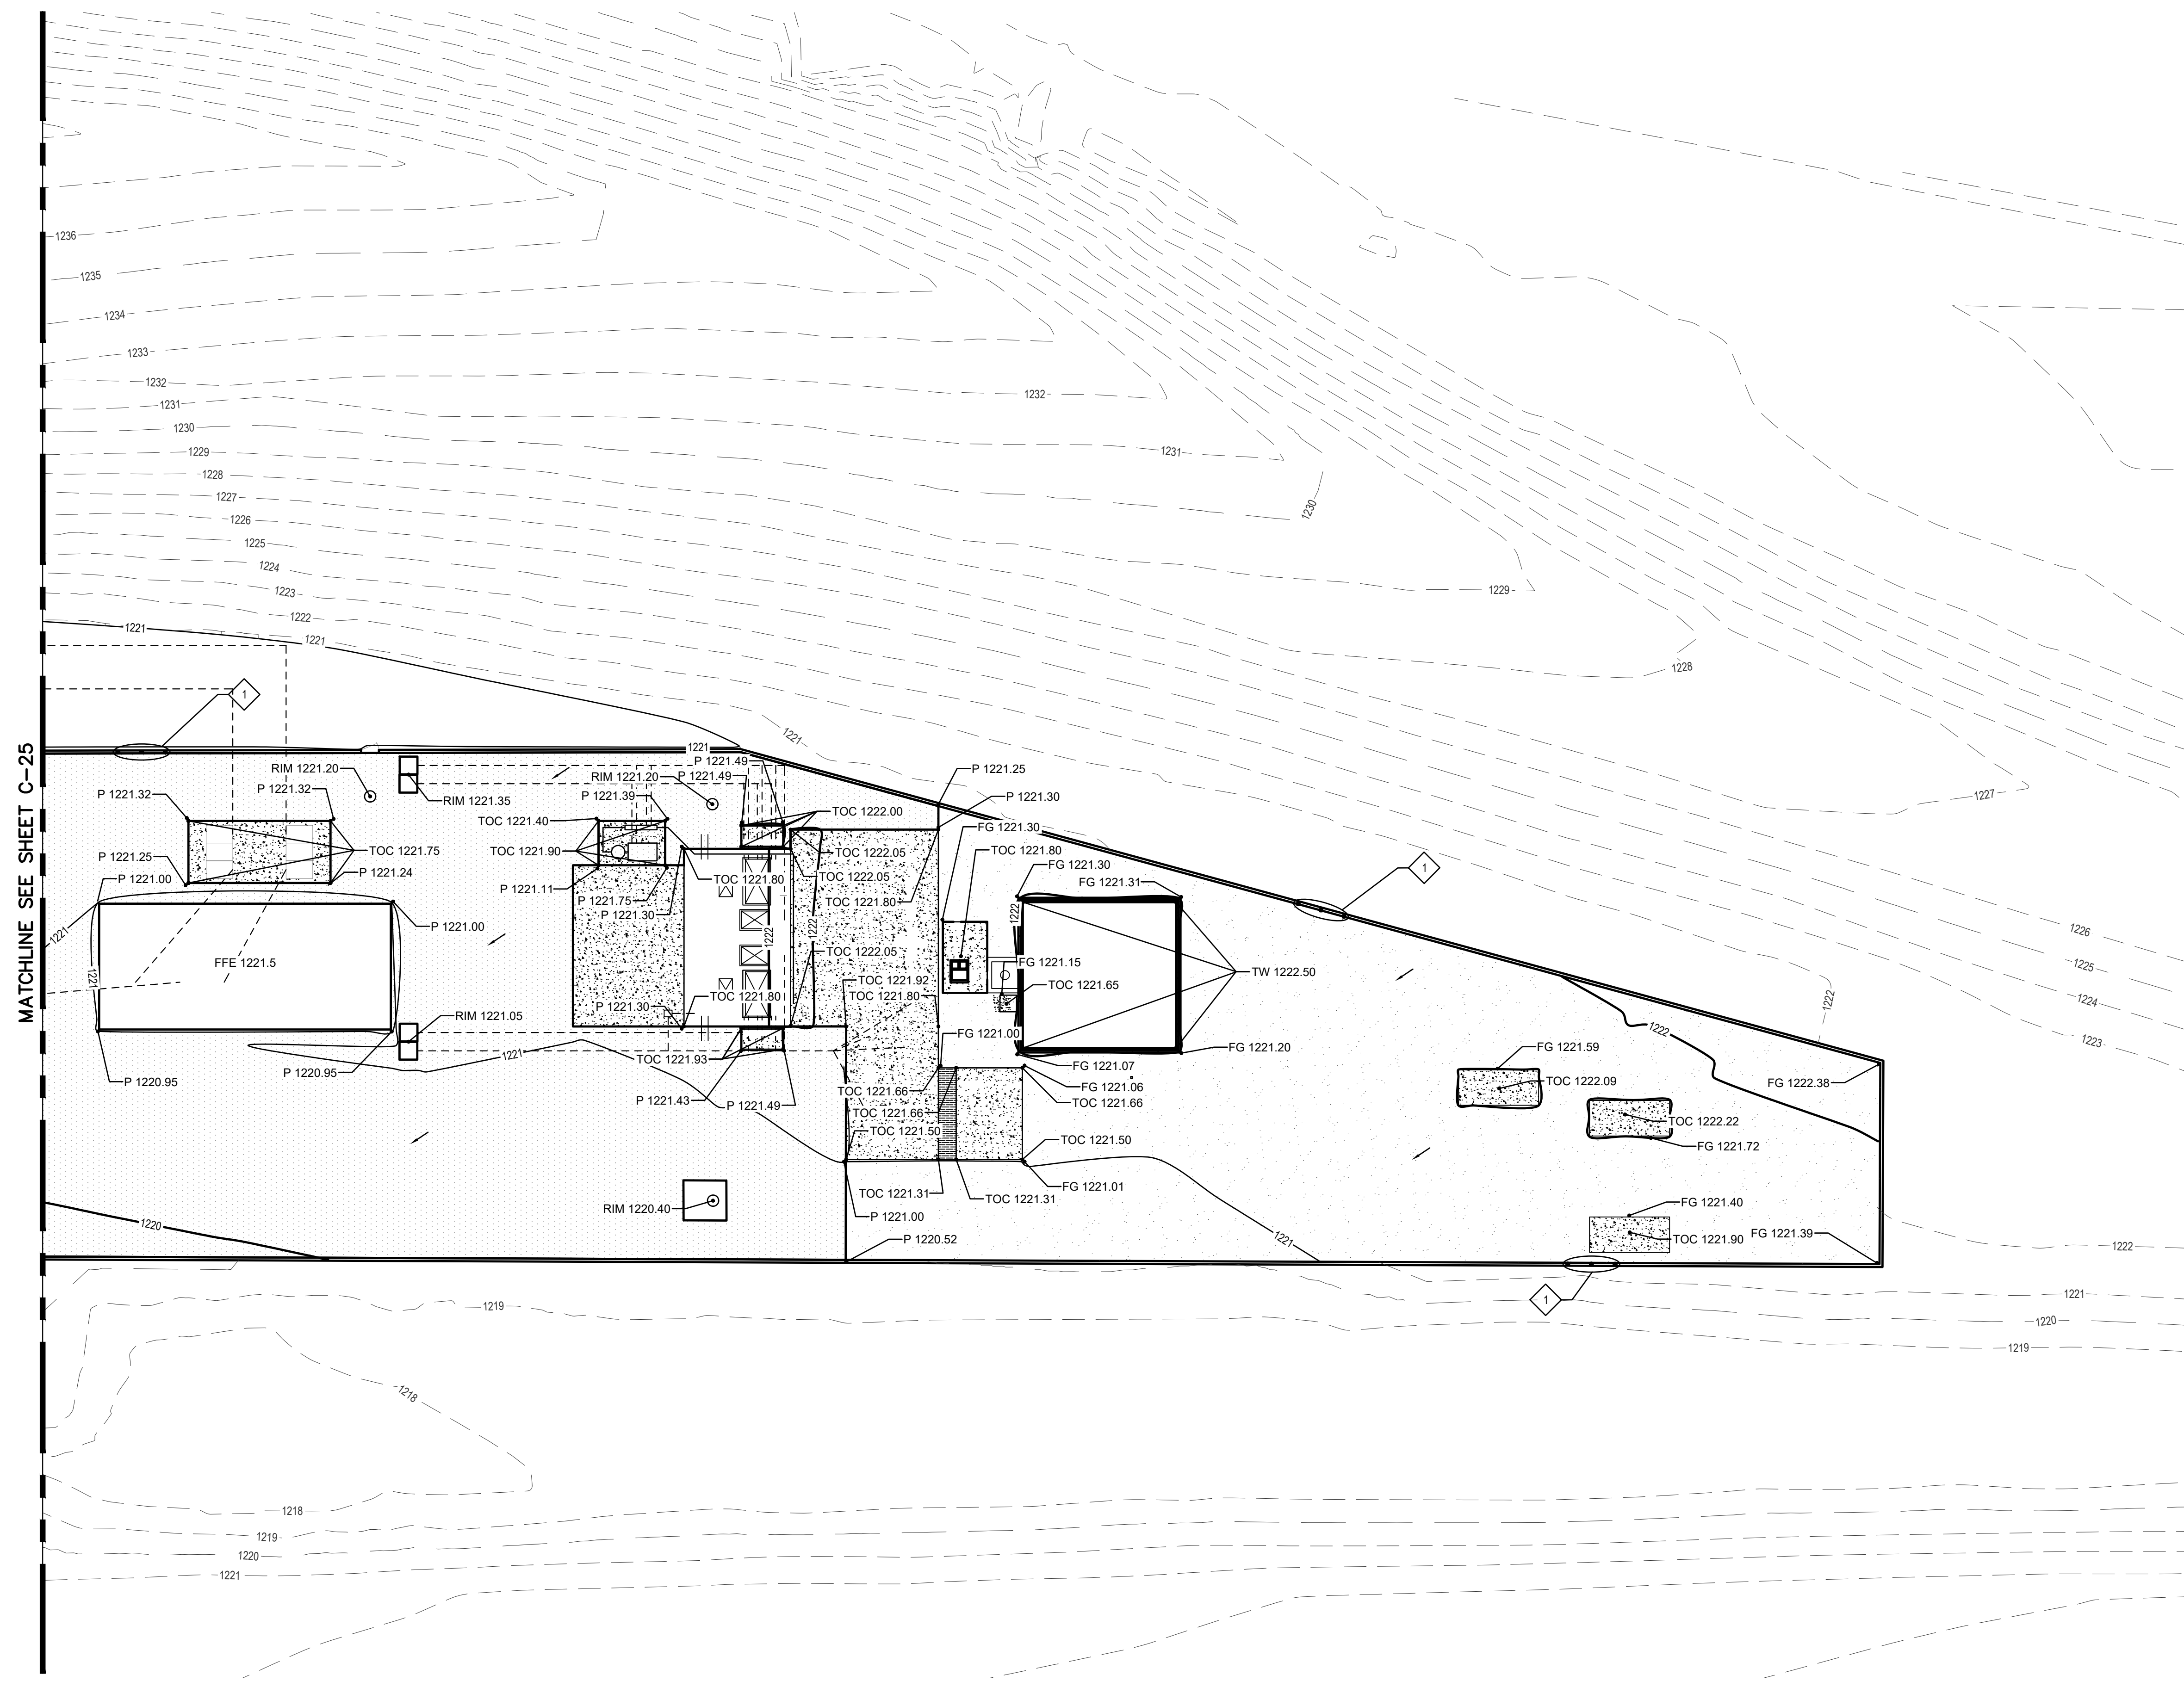


**KEY NOTES**

- 1 INSTALL DRAIN HOLES 5'-4" ± OC ALONG ENTIRE EAST AND WEST SIDE OF CMU WALL PER DETAIL

4  
C-26 S-18

FACILITY DRAWINGS  
This drawing was supplied by a Consultant Engineer from a past project. The Consultant Engineer is not responsible for the accuracy of the information provided by the Contractor to provide the Record Drawing. The City does not warrant this drawing to be a complete and accurate portrayal of facilities as they exist in the field.

FOR CITY OF PHOENIX USE ONLY - REFERENCE CID NUMBER: #	PROJECT NO.	PROJECT NAME	DATE	CAD FILE NAME	DWG NUMBER	REMARKS

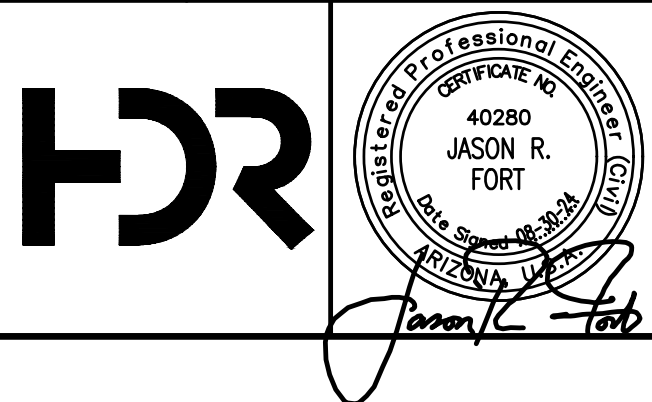

NO.	BY	DATE	CKD	REMARKS
A	RS	10/2023	JF	30% SUBMITTAL
B	RS	01/2024	JF	90% SUBMITTAL
C	RS	04/2024	JF	AGENCY REVIEW
D	DFD	08/2024	JF	ISSUED FOR CONSTRUCTION
*				
*				
*				

DES NT  
DWN HDR  
CKD JF

City of Phoenix

CITY OF PHOENIX  
WATER SERVICES DEPARTMENT

LIFT STATION 40  
REFURBISHMENT

CIVIL

GRADING AND DRAINAGE PLAN 02

COPYRIGHT © 2007-JANUARY

CITY PROJECT NO. WS90400085

DATE: 08/2024

C-26 SHEET 31 OF 134


CAD FILE: CSCLS40V02.dwg

USER:FBERASR\AUD FILE: C:\pwworking\west01\31\_CSCLS40V02.dwg DATE: 9/04/24 TIME: 03:22pm

FOR CONSTRUCTION

THIS DRAWING MUST BE FIELD VERIFIED BEFORE USE. DRAWING NOT TO SCALE UNLESS SCALE BAR IS PRESENT

\*PER CITY OF PHOENIX CODE CHAPTER 2, SECTION 2-28, THESE PLANS ARE FOR OFFICIAL USE ONLY AND MAY NOT BE SHARED WITH OTHERS EXCEPT AS REQUIRED TO FULFILL THE OBLIGATIONS OF THE CONTRACTOR'S CONTRACT WITH THE CITY OF PHOENIX. THIS DOCUMENT MUST BE KEPT SECURE AT ALL TIMES.

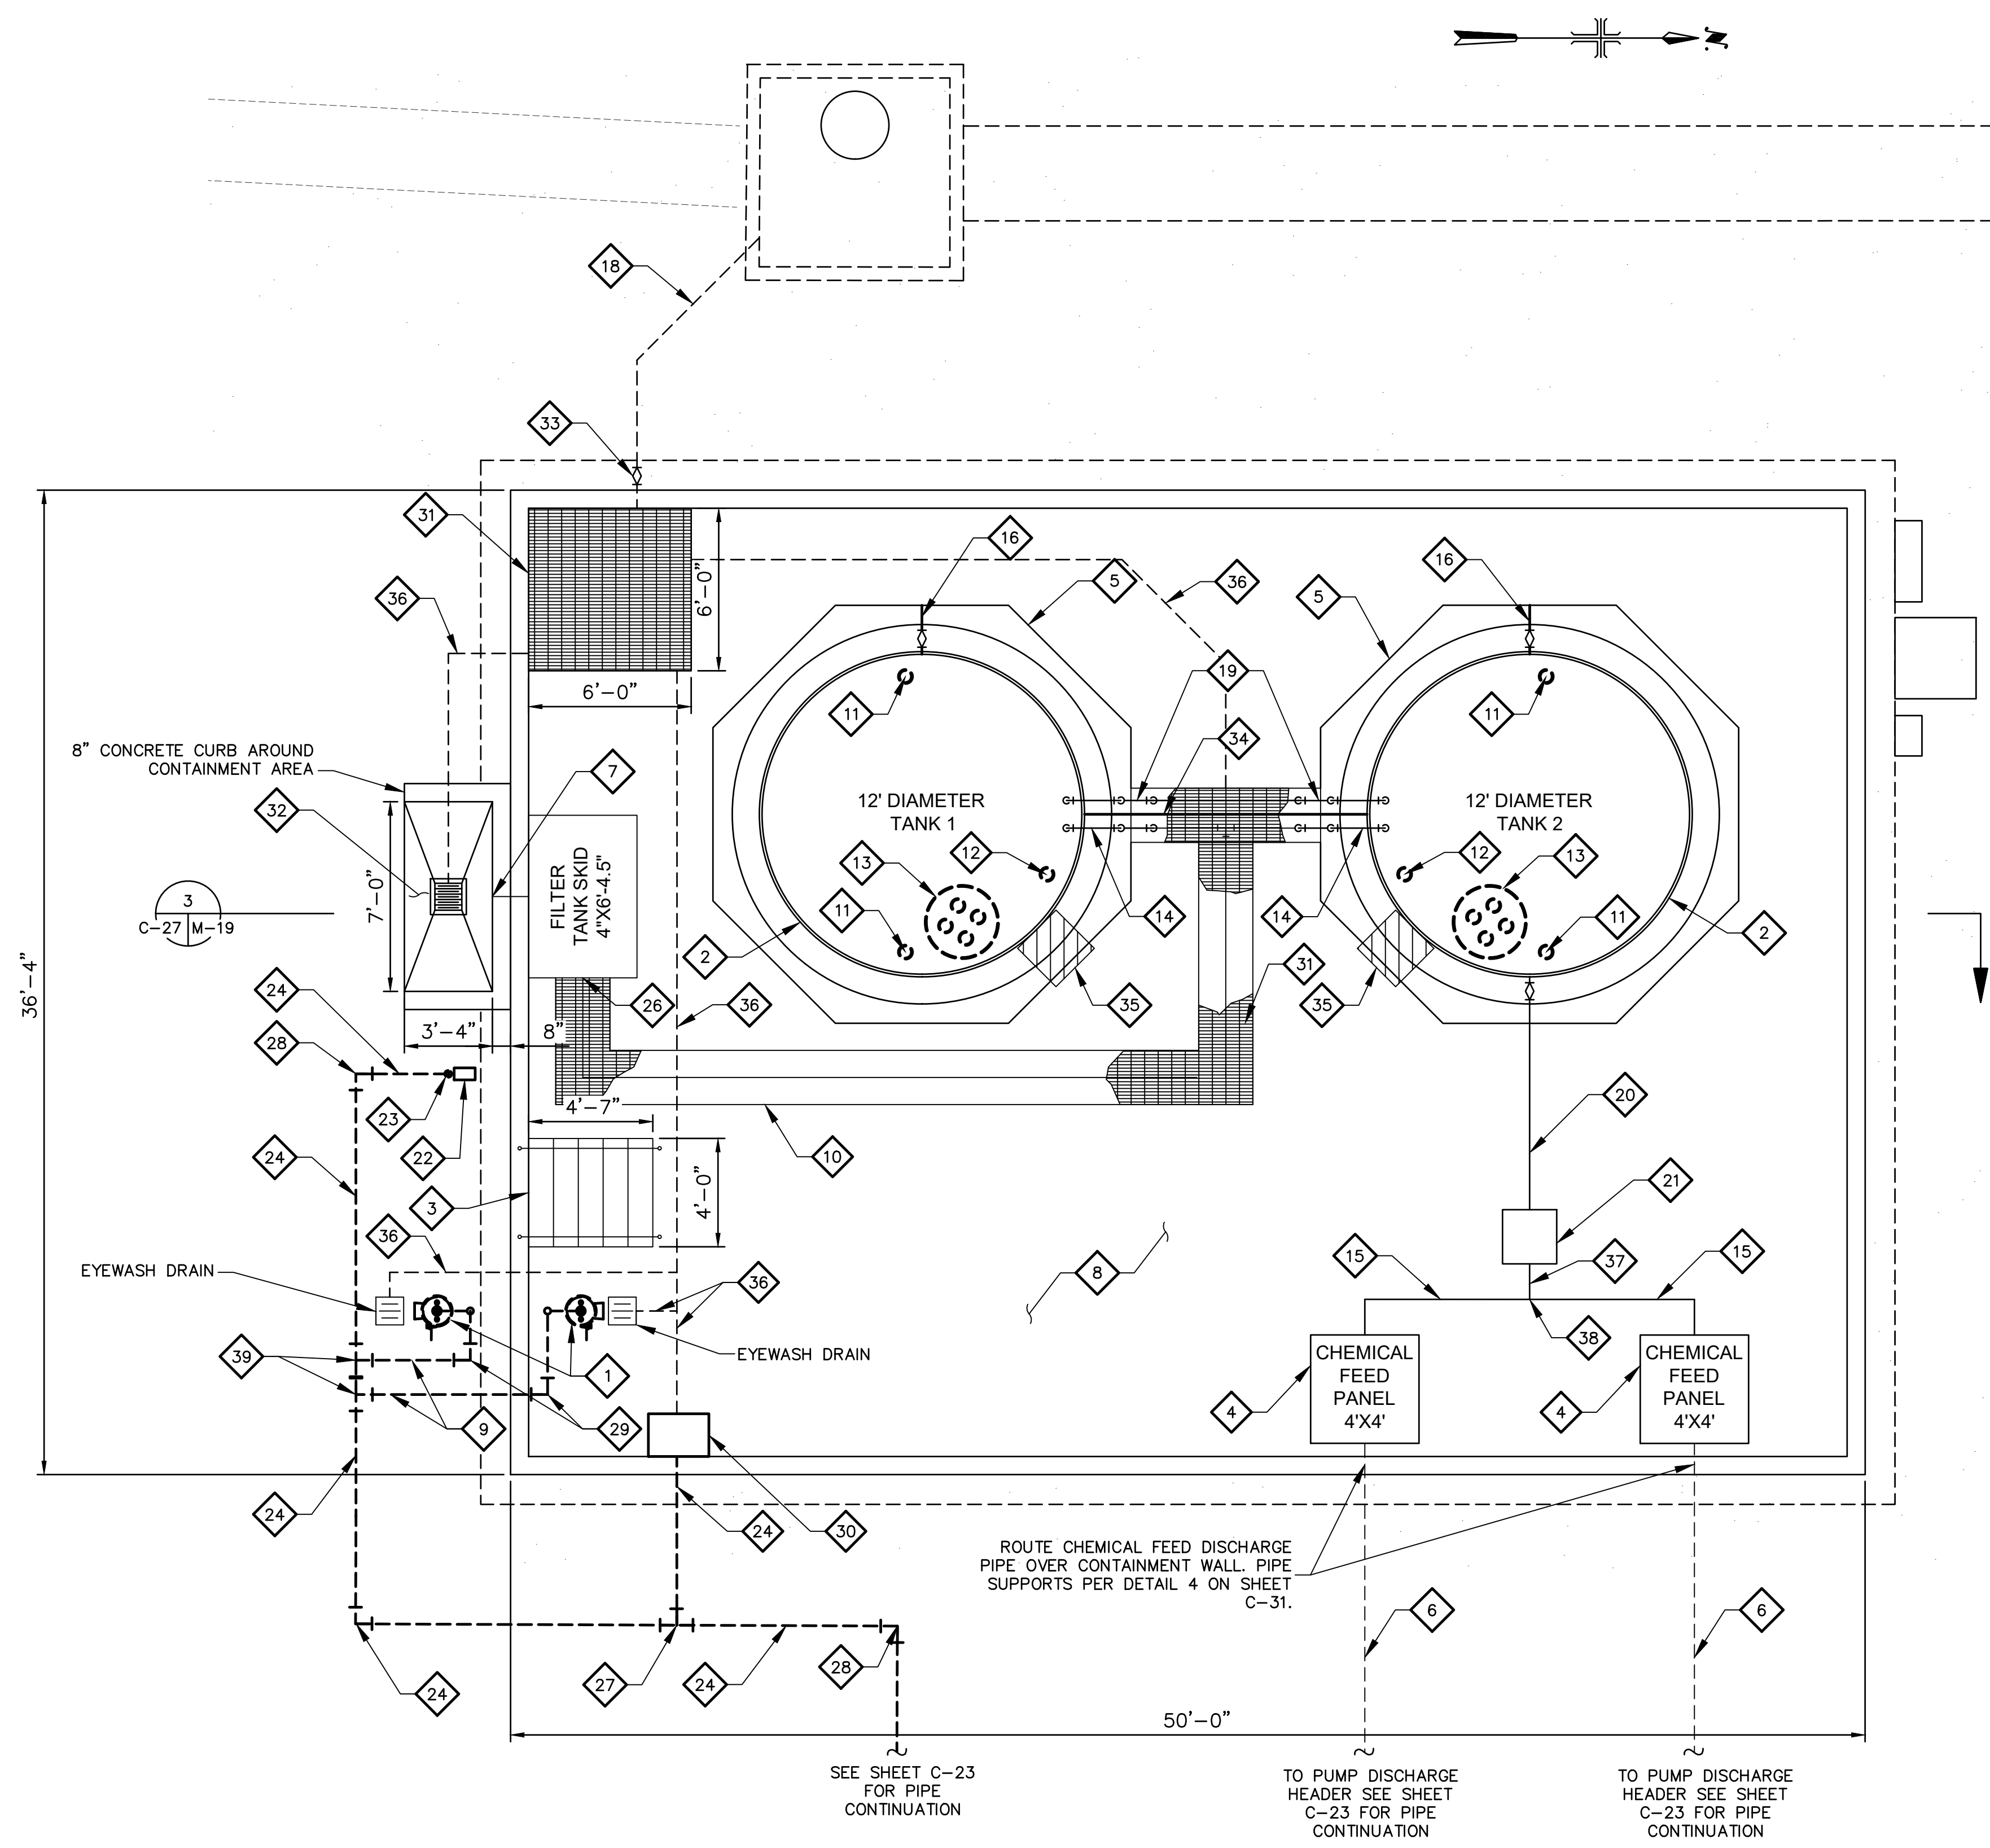

**KEY NOTES CON'T.**

- 31 CONTAINMENT SUMP WITH FRP GRATING.
- 32 FILL STATION SPILL CONTAINMENT AREA (WITH FRP GRATING).
- 33 INSTALL 4" TYPE K COPPER ISOLATION BALL VALVE.
- 34 INSTALL 2" TANK EQUALIZER PIPE.
- 35 TANK ACCESS LADDER.
- 36 INSTALL 2" DRAIN LINE. ROUTE TO CONTAINMENT SUMP.
- 37 INSTALL NEW 2" SCHEDULE 80 PVC LINE.
- 38 INSTALL 2"x1"x1" TYPE K COPPER TEE.
- 39 INSTALL 2"x2"x1-1/2" TYPE K COPPER TEE.

**KEY NOTES**

- 1 INSTALL EMERGENCY EYEWASH/SHOWER. SEE DETAIL 9 C-27 M-04.
- 2 INSTALL NEW 7800 GALLON HDPE FERROUS CHLORIDE STORAGE TANKS.
- 3 INSTALL NEW CONCRETE STAIRS. SEE STRUCTURAL SHEETS FOR DETAILS.
- 4 INSTALL VENDOR PUMP SKID AND CONTROL PANEL.
- 5 INSTALL NEW CHEMICAL STORAGE TANK PAD. SEE STRUCTURAL SHEETS FOR DETAILS.
- 6 INSTALL NEW 1" DOUBLE CONTAINED SCHEDULE 80 PVC PIPING AND FITTINGS.
- 7 INSTALL NEW 3" CAMLOCK MALE END QUICK COUPLING WITH DUST CAP.
- 8 EPOXY COAT CONTAINMENT AREA INTERIOR PER SPECIFICATION 09 96 17.
- 9 INSTALL NEW 1-1/2" WATER LINE.
- 10 CHEMICAL PIPE TRENCH. PLACE NEW CHEMICAL PIPING IN SHALLOW TRENCH PER STRUCTURAL DRAWINGS.
- 11 INSTALL NEW 2" VENT CAP.
- 12 INSTALL NEW 2" LEVEL SENSOR HALF COUPLING WITH PLUG.
- 13 INSTALL NEW 24" MANWAY WITH PRESSURE RELIEF VENT.
- 14 INSTALL NEW 2" SCHEDULE 80 PVC FILL TANK LINE.
- 15 INSTALL NEW 1" SCHEDULE 80 PVC LINE.
- 16 INSTALL NEW 2" TANK DRAIN LINE AND BALL VALVE WITH CAM LOCK.
- 18 INSTALL NEW 4" PVC DRAIN LINE. ROUTE TO SEWER JUNCTION STRUCTURE.
- 19 INSTALL NEW 3" SCHEDULE 80 PVC TANK OVERFLOW LINE.
- 20 INSTALL NEW 2" SCHEDULE 80 PVC OUTLET WITH BALL VALVE. CONTRACTOR TO ROUTE TO VENDOR PUMP SKID.
- 21 INSTALL VENDOR FILTER ASSEMBLY FOR TANK DISCHARGE LINE.
- 22 INSTALL HEAVY DUTY HOSE RACK SEE DETAIL 14 C-27 M-04.
- 23 INSTALL HOSE BIB. SEE DETAIL 13 C-27 M-04.
- 24 INSTALL 2" TYPE K COPPER WATER LINE.
- 26 INSTALL VENDOR INLET FILTER TANK SKID.
- 27 INSTALL 2"x 2"x 2" TYPE K COPPER TEE.
- 28 INSTALL 2" TYPE K COPPER 90° BEND.
- 29 INSTALL 1-1/2" TYPE K COPPER 90° BEND.
- 30 INSTALL PLASTIC SINK.



**GENERAL NOTES**

1. THE FERROUS CHLORIDE TANKS, ACCESSORIES, FEED SYSTEM INCLUDING PUMPS, VALVES, ETC. SHALL BE PROVIDED AS A PACKAGED SYSTEM AND BY A SINGLE VENDOR (USP TECHNOLOGIES OR APPROVED EQUAL).
2. CONTRACTOR TO COORDINATE ALL REQUIRED SUPPORTS FOR CONDUITS AND PIPING.
3. TANK ANCHORING SYSTEM SHALL BE PER MANUFACTURER.
4. NOT ALL VALVES AND ACCESSORIES ARE SHOWN. CONTRACTOR SHALL REFER TO P&ID PLANS FOR IDENTIFICATION.
5. CHEMICAL CONTAINMENT AREA TO BE COATED PER SPEC SECTION 09 96 17.
6. CHEMICAL UNLOADING AREA INCLUDING TRENCH DRAINS, SUMPS, AND HORIZONTAL PIPE CHASES TO BE COATED PER SPEC SECTION 09 96 16.

**CONTAINMENT AREA CALCULATIONS:**


LENGTH OF CONTAINMENT AREA	50 FT
WIDTH OF CONTAINMENT AREA	35 FT
HEIGHT OF CONTAINMENT AREA	3.5 FT
VOLUME OF CONTAINMENT AREA	6125 FT <sup>3</sup>
VOLUME OF SUMP	72 FT <sup>3</sup>
VOLUME OF CONCRETE STAIRS	27 FT <sup>3</sup>
VOLUME OF CONCRETE PAD	348 FT <sup>3</sup>
VOLUME OF CHEMICAL FEED PANELS	192 FT <sup>3</sup>
VOLUME AVAILABLE	5630 FT <sup>3</sup>

CHEMICAL STORAGE TANK VOLUME	2086 FT <sup>3</sup>
INCHES OF RAIN (100-YEAR, 24-HOUR STORM EVENT)	3.83 IN
VOLUME OF RAIN	184 FT <sup>3</sup>
REQUIRED CONTAINMENT VOLUME	2274 FT <sup>3</sup>

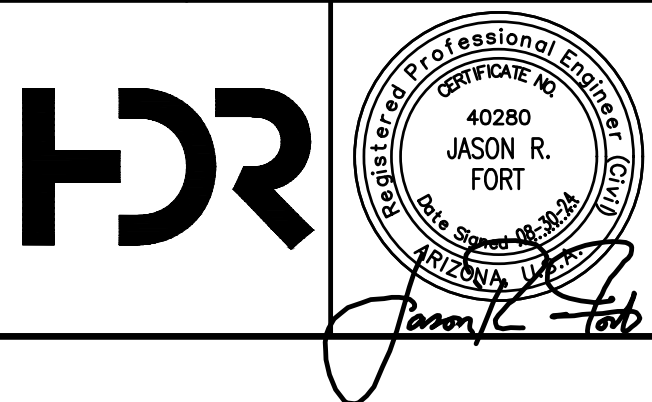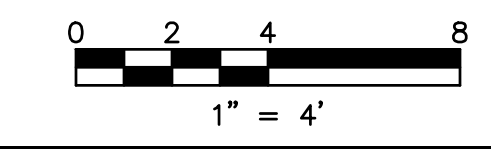

NO.	BY	DATE	CKD	REVISIONS	REMARKS
A	RS	10/2023	JF	30% SUBMITTAL	
B	RS	01/2024	JF	90% SUBMITTAL	
C	RS	04/2024	JF	AGENCY REVIEW	
D	DFD	08/2024	JF	ISSUED FOR CONSTRUCTION	
*					
*					
*					

DES	REVISIONS	REMARKS
FS		
DWN		
RS		
CKD		
JF		

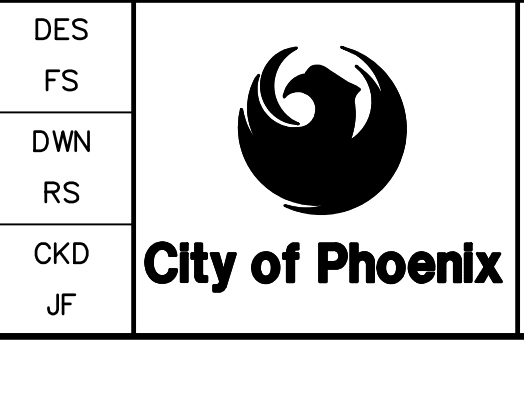

CITY OF PHOENIX  
WATER SERVICES DEPARTMENT  
  
LIFT STATION 40  
REFURBISHMENT

CIVIL  
  
FERROUS CHLORIDE SYSTEM  
SITE PLAN

COPYRIGHT © 2007-JANUARY  
CITY PROJECT NO. WS90400085  
DATE: 08/2024  
C-27 SHEET 32 OF 134  
CAD FILE: CSCLS40P10.dwg

FACILITY DRAWINGS  
This drawing was supplied by a Consultant Engineer from a past project. The Consultant Engineer is not responsible for the construction information provided by the Contractor to provide the Record Drawing. The City does not warrant this drawing to be a complete and accurate portrayal of facilities as they exist in the field.

REVISION	DATE	PROJECT NAME	DWG NUMBER	REMARKS


FOR CITY OF PHOENIX USE ONLY - REFERENCE CID NUMBER: #  
REVISION ENGINEERING COMPANY PROJECT NO. PROJECT NAME DATE: 08/24/24 TIME: 03:23pm  
# # # # #



THIS DRAWING MUST BE FIELD VERIFIED BEFORE USE  
DRAWING NOT TO SCALE UNLESS SCALE BAR IS PRESENT

**FOR CONSTRUCTION**


"PER CITY OF PHOENIX CODE CHAPTER 2, SECTION 2-28, THESE PLANS ARE FOR OFFICIAL USE ONLY AND MAY NOT BE SHARED WITH OTHERS EXCEPT AS REQUIRED TO FULFILL THE OBLIGATIONS OF THE CONTRACTOR'S CONTRACT WITH THE CITY OF PHOENIX."  
THIS DOCUMENT MUST BE KEPT SECURE AT ALL TIMES.

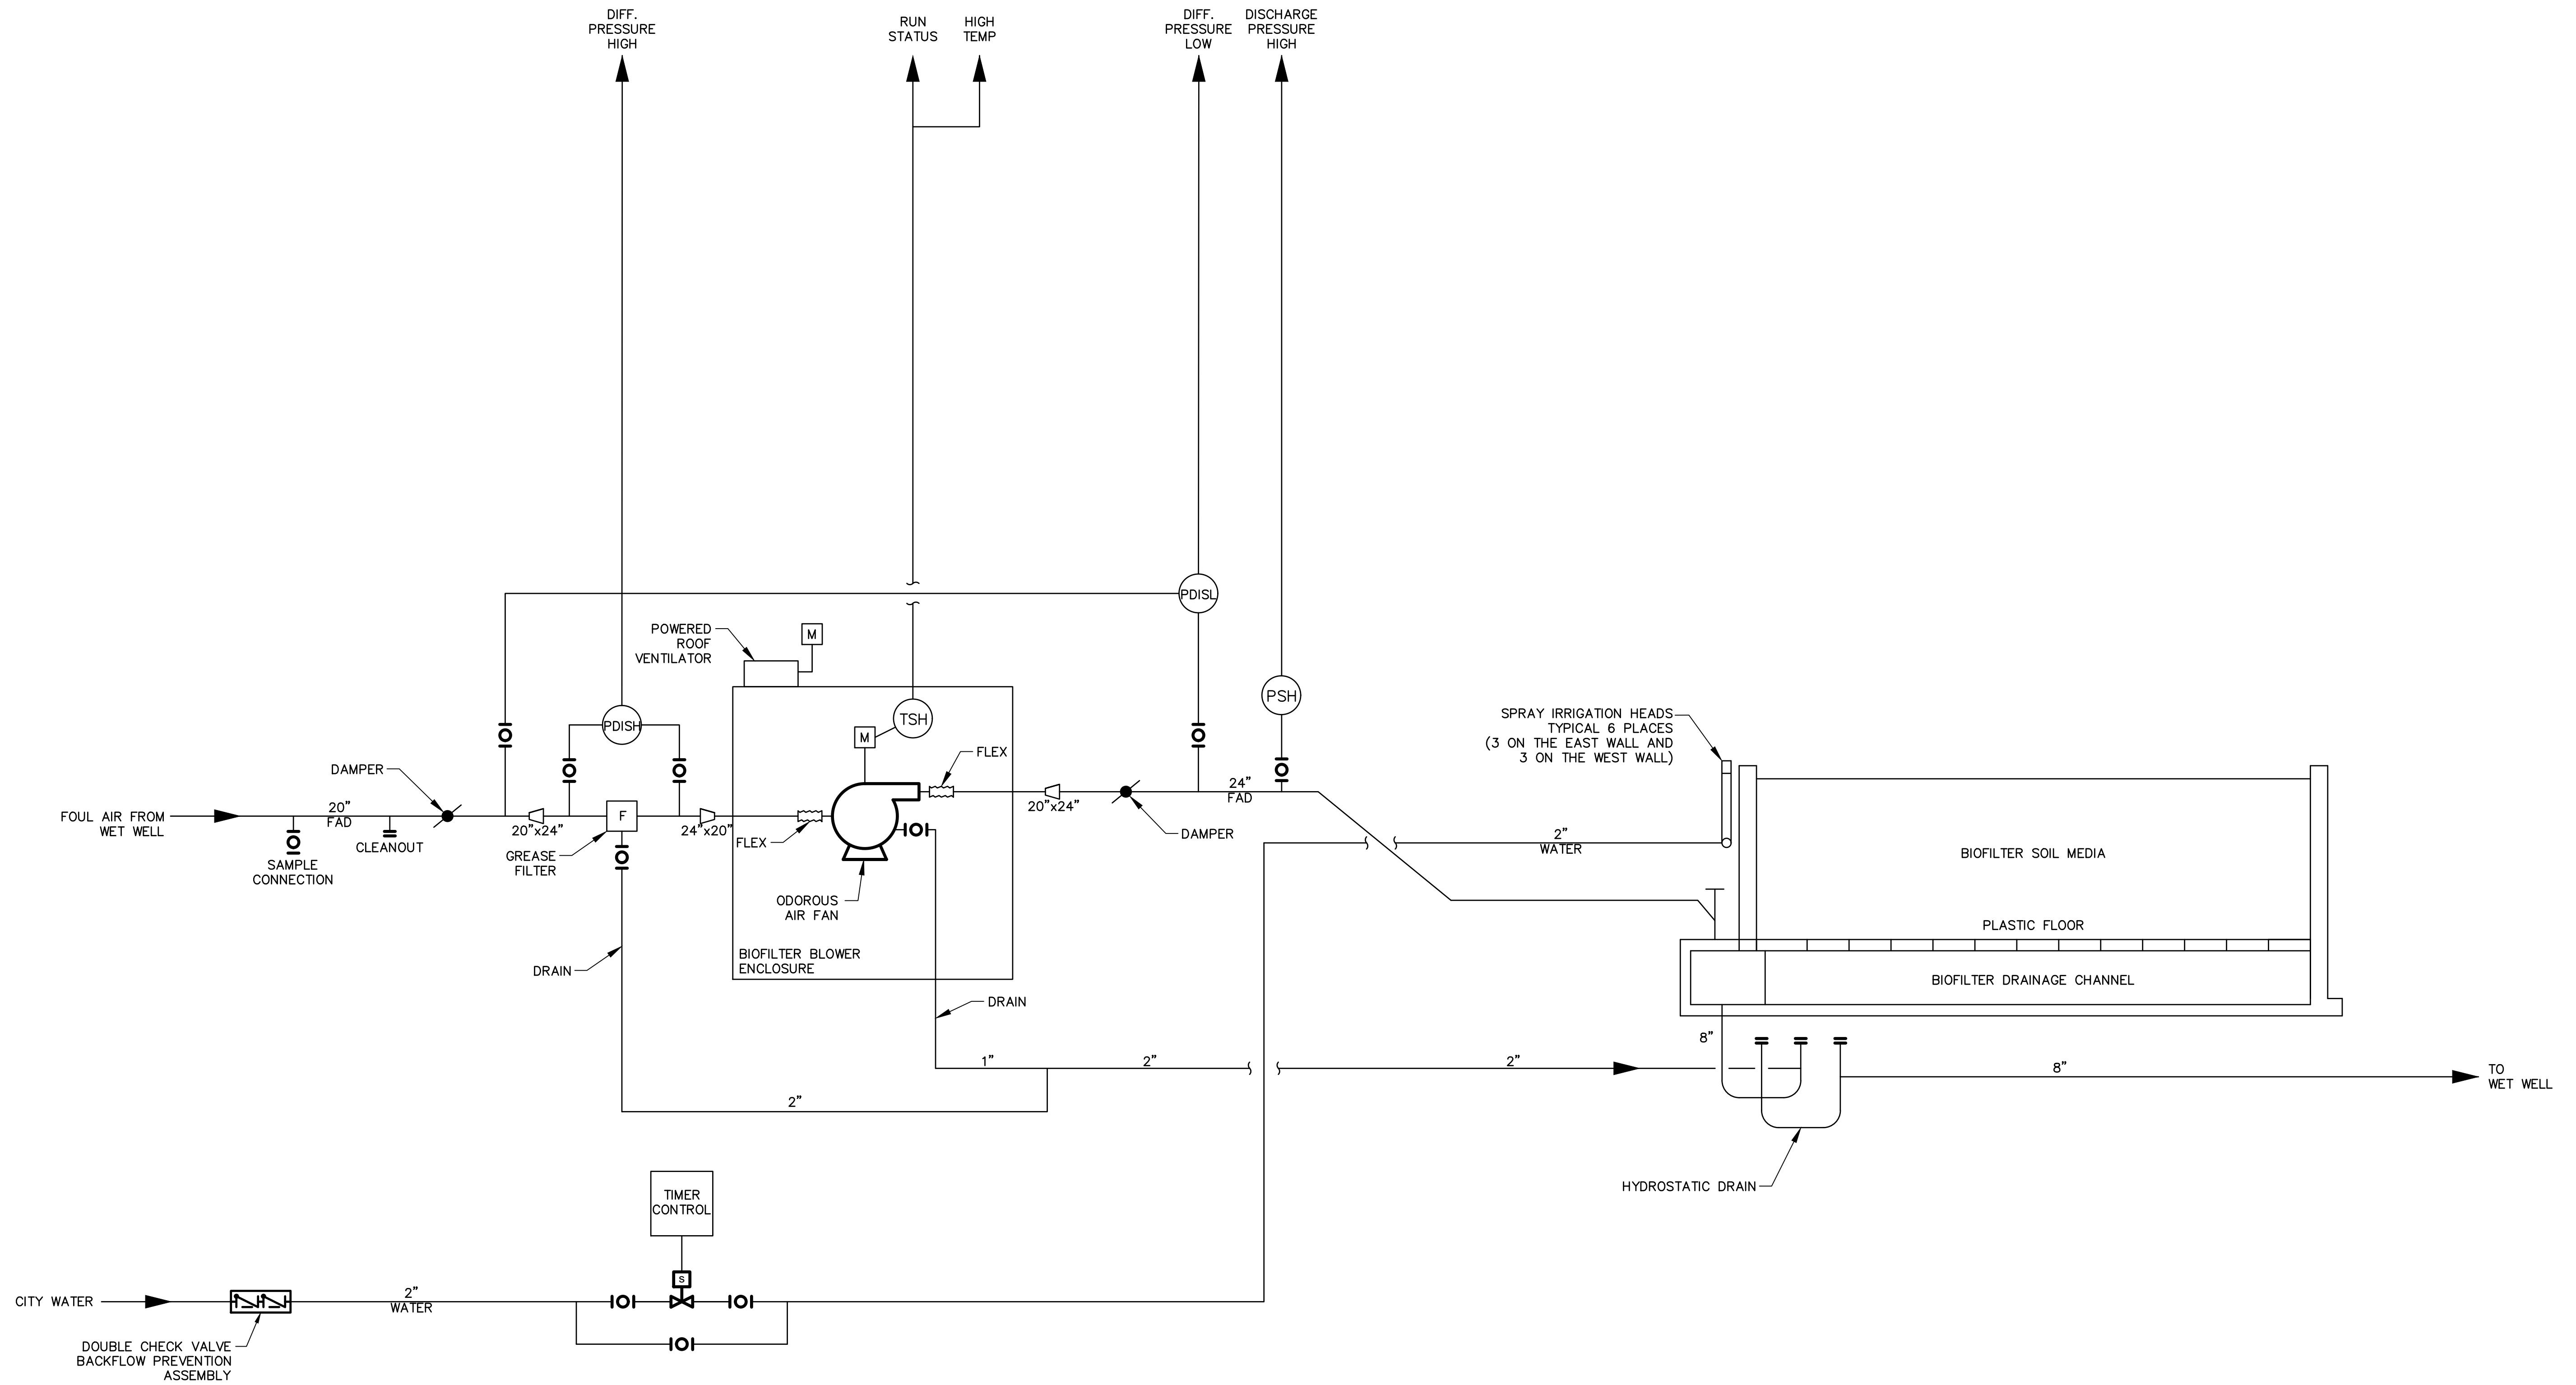


FACILITY DRAWINGS  
This drawing was supplied by a Consultant Engineer from a past project. The Consultant Engineer is not responsible for the accuracy of information provided by the Contractor to provide the Record Drawing. The City does not warrant this drawing to be a complete and accurate portrayal of facilities as they exist in the field.

FOR CITY OF PHOENIX USE ONLY - REFERENCE CID NUMBER: #	PROJECT NO.	PROJECT NAME	DATE	CAD FILE NAME	DWG NUMBER	REMARKS

USER: FBEAS\FRALD FILE: C:\pwworking\west01\33411640\33\_CSCLS40P11.dwg DATE: 9/04/24 TIME: 03:22pm

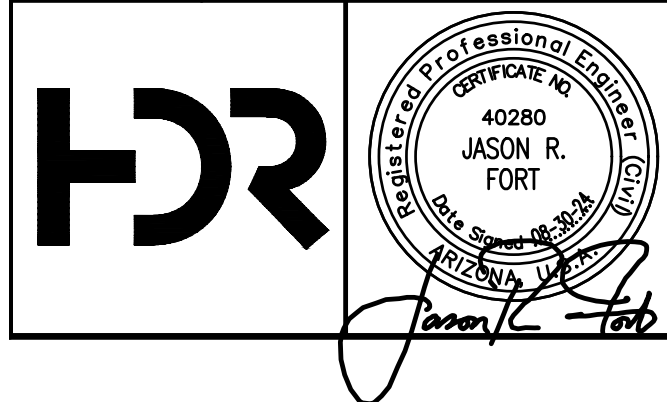

NO.	BY	DATE	CKD	REVISIONS	REMARKS
A	RS	10/2023	JF	30% SUBMITTAL	
B	RS	01/2024	JF	90% SUBMITTAL	
C	RS	04/2024	JF	AGENCY REVIEW	
D	FD	08/2024	JF	ISSUED FOR CONSTRUCTION	
*					
*					
*					

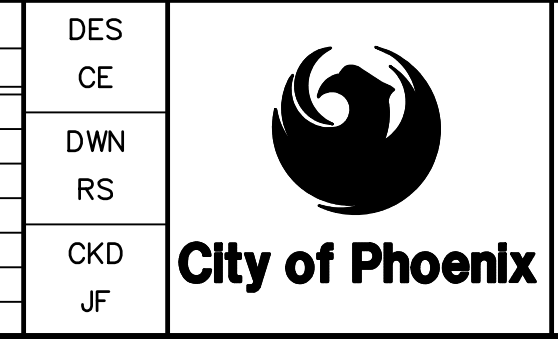

CITY OF PHOENIX  
WATER SERVICES DEPARTMENT  
  
LIFT STATION 40  
REFURBISHMENT


CIVIL  
  
BIOFILTER SCHEMATIC

COPYRIGHT © 2007-JANUARY  
CITY PROJECT NO. WS90400085  
DATE: 08/2024  
C-28 SHEET 33 OF 134  
CAD FILE: CSCLS40P11.dwg


FOR CONSTRUCTION

THIS DRAWING MUST BE FIELD VERIFIED BEFORE USE. DRAWING NOT TO SCALE UNLESS SCALE BAR IS PRESENT

"PER CITY OF PHOENIX CODE CHAPTER 2, SECTION 2-28, THESE PLANS ARE FOR OFFICIAL USE ONLY AND MAY NOT BE SHARED WITH OTHERS EXCEPT AS REQUIRED TO FULFILL THE OBLIGATIONS OF THE CONTRACTOR'S CONTRACT WITH THE CITY OF PHOENIX." THIS DOCUMENT MUST BE KEPT SECURE AT ALL TIMES.

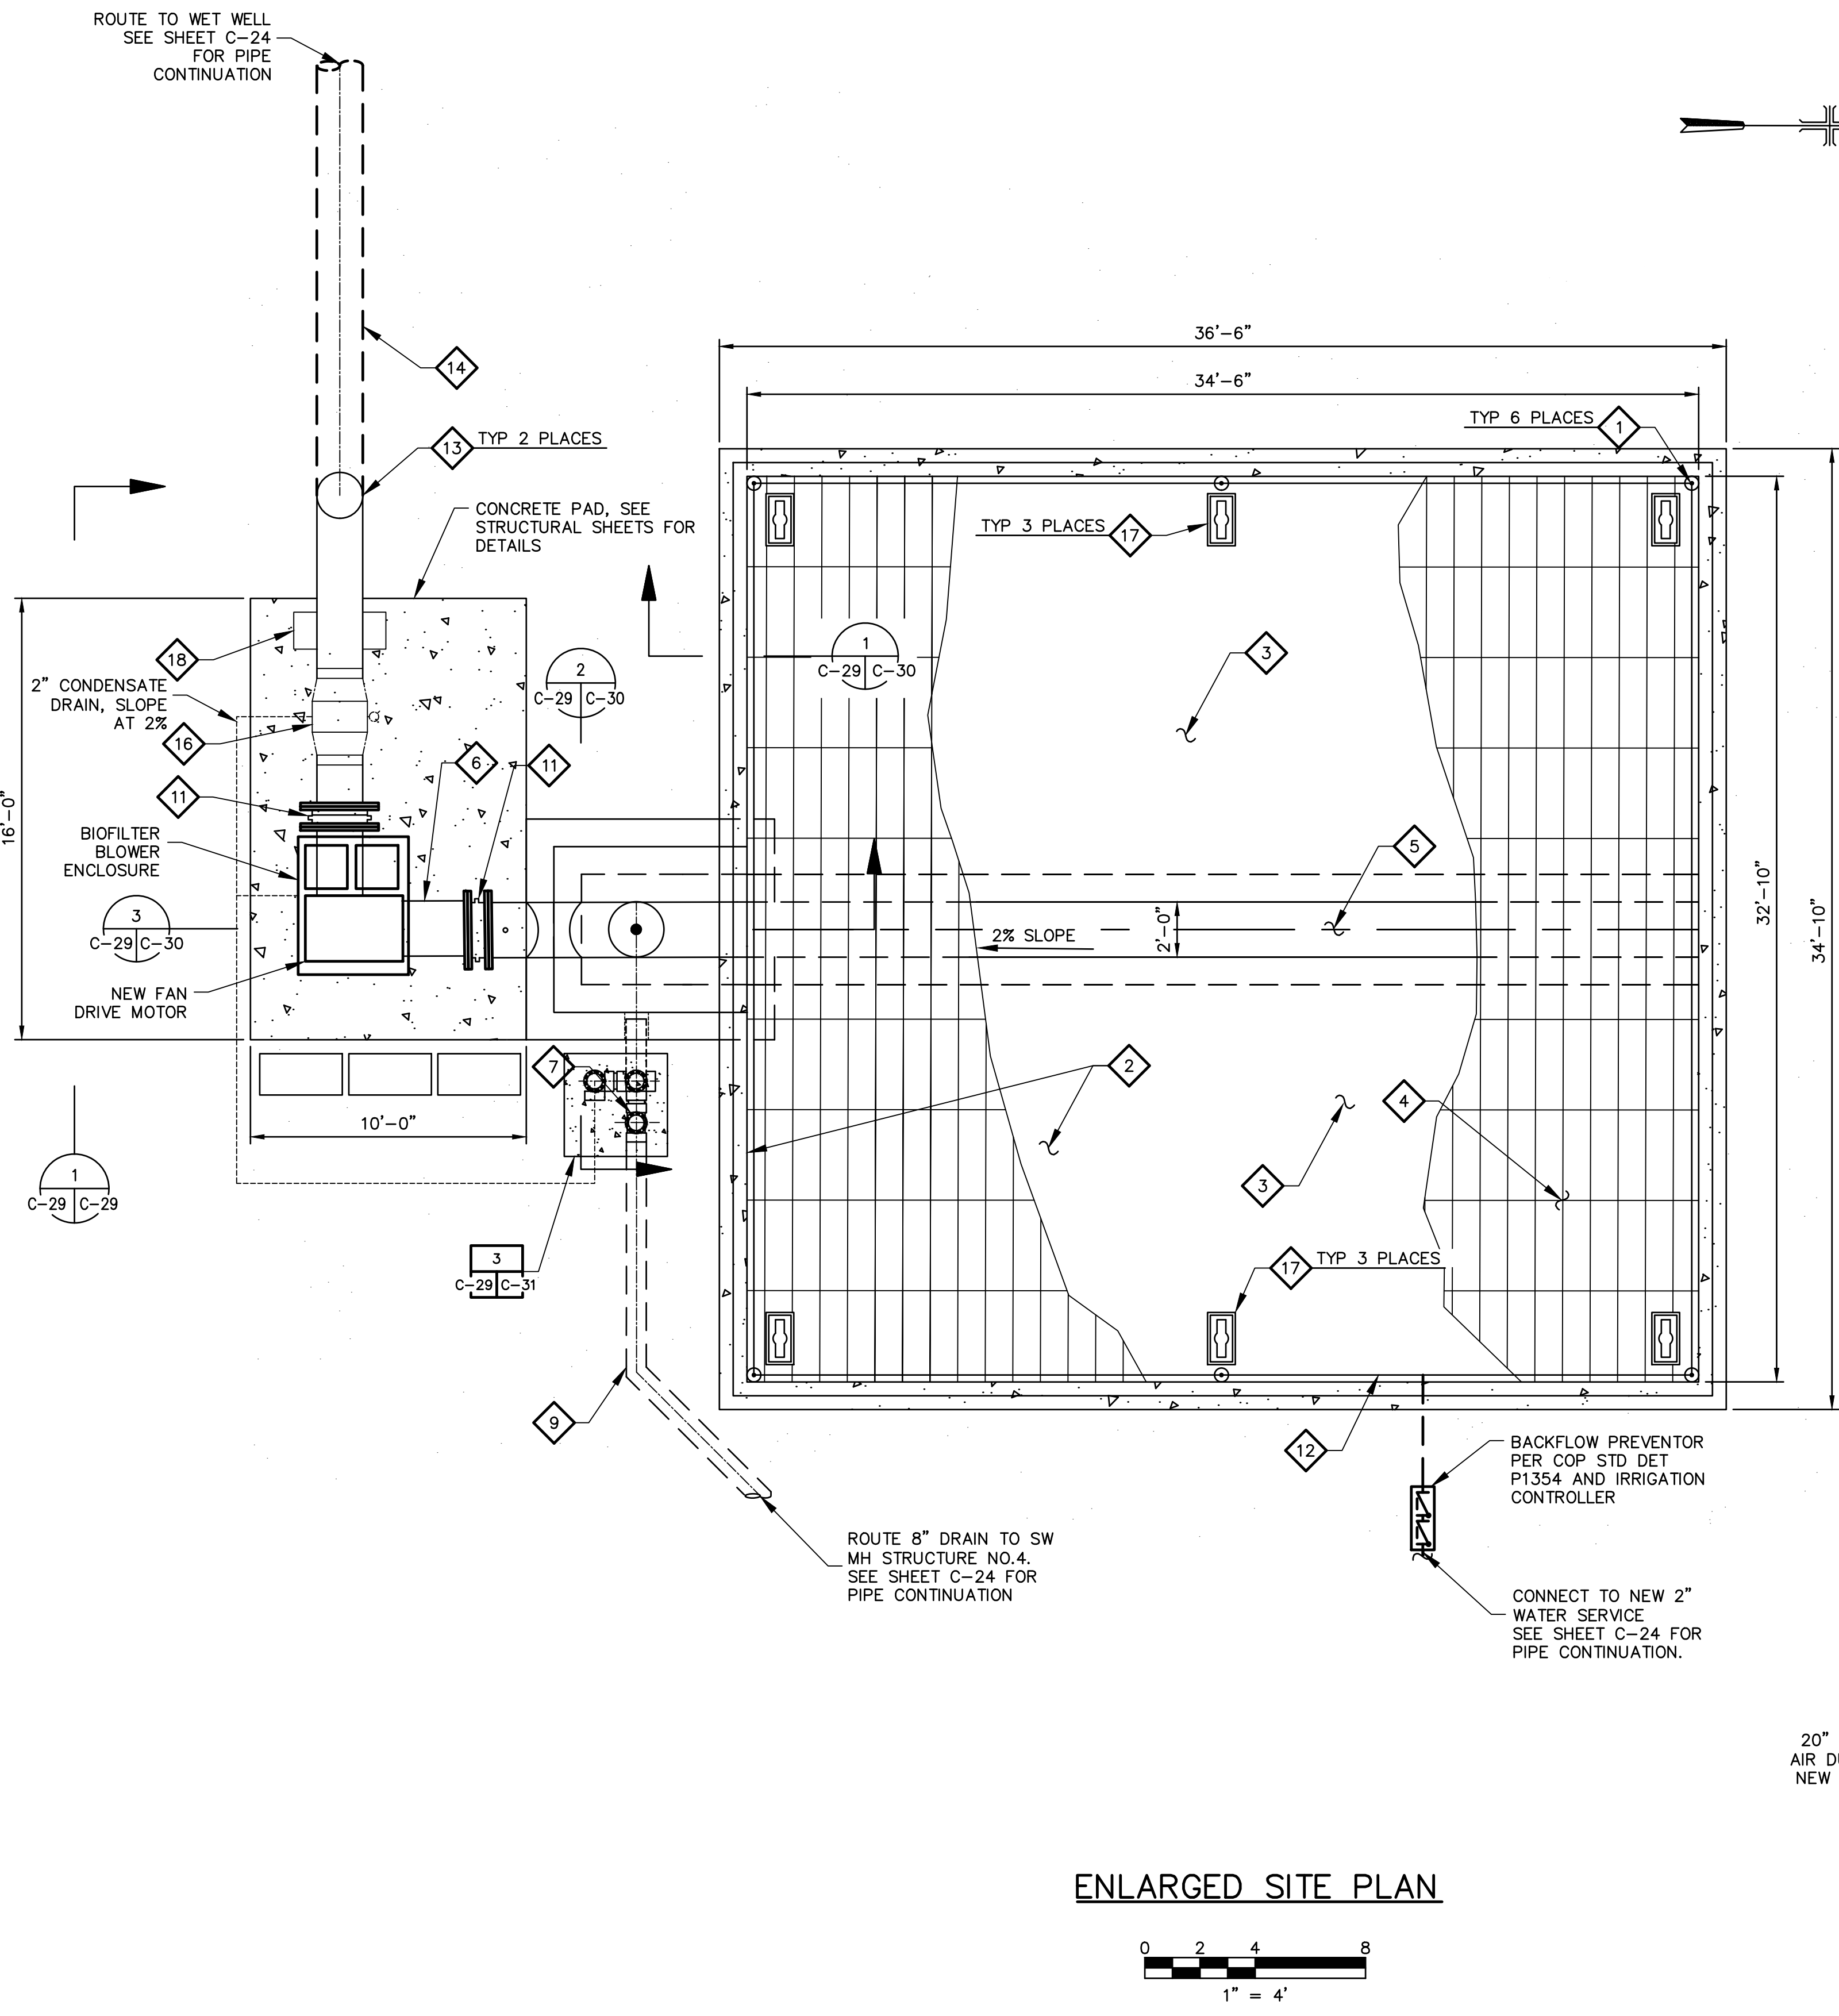

ENLARGED SITE PLAN

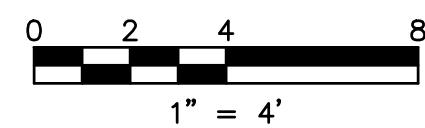

**KEY NOTES (CON'T)**


- 16 INSTALL 2" CPVC GREASE FILTER DRAIN LINE WITH BALL VALVE. ROUTE TO 8" DRAIN LINE
- 17 INSTALL BIOFILTER CLEANOUT ASSEMBLY SEE DETAIL 1 C-29 C-30
- 18 INSTALL ADJUSTABLE PIPE SUPPORT. SEE DETAIL 1 C-29 M-02

**GENERAL NOTE:**


1. BIOFILTER SUPPLIER TO PROVIDE SOIL MEDIA, FOUL AIR FAN, CONCRETE VAULT LINER, RAISED FLOORING AIR DISTRIBUTION SYSTEM, GRAVEL AND BEDDING MATERIAL AND AUTOMATED SPRINKLER-TYPE IRRIGATION SYSTEM.

**KEY NOTES**

- 1 INSTALL SPRINKLER HEADS AND ASSOCIATED PIPING. REPLACE IRRIGATION CONTROL BOX IN-KIND. TIE-IN IRRIGATION PIPING TO THE CONTROLLER.
- 2 BIOFILTER CONCRETE FLOOR AND WALL. SEE STRUCTURAL SHEETS FOR DETAILS.
- 3 CONCRETE SURFACES SHALL BE PROTECTED PER SPECIFICATION SECTION 44 31 21.23.
- 4 HAHN RAISED FLOORING SYSTEM. CONTRACTOR TO SUBMIT DRAWINGS TO SHOW HOW THE PROPOSED FLOORING SYSTEM WILL FIT THE CONCRETE STRUCTURE. SEE SPECIFICATION SECTION 44 31 21.23 FOR ADDITIONAL DETAILS.
- 5 24" DRAINAGE CHANNEL.
- 6 24" FRP FOUL AIR DUCT.
- 7 8" HYDROSTATIC LOCK DRAIN. SEE DETAIL 3 C-29 C-31
- 8 FAN CONTROL PANEL AND DISCONNECT SWITCH. SEE ELECTRICAL PLANS FOR ADDITIONAL DETAILS.
- 9 8" CPVC OR C900 DRAIN ROUTED TO SW MANHOLE STRUCTURE NO. 4. SEE SHEET C-24 FOR CONTINUATION.
- 11 FLEX COUPLING SEE SPECIFICATIONS SECTION 40 10 15 FOR DETAILS.
- 12 2" PVC WATER SUPPLY FOR SPRINKLER HEADER LINE.
- 13 90° FRP BEND WITH 8" CLEANOUT AND BLIND FLANGE.
- 14 20" FRP FOUL AIR DUCT. SEE SHEET C-24 FOR FAD CONTINUATION.

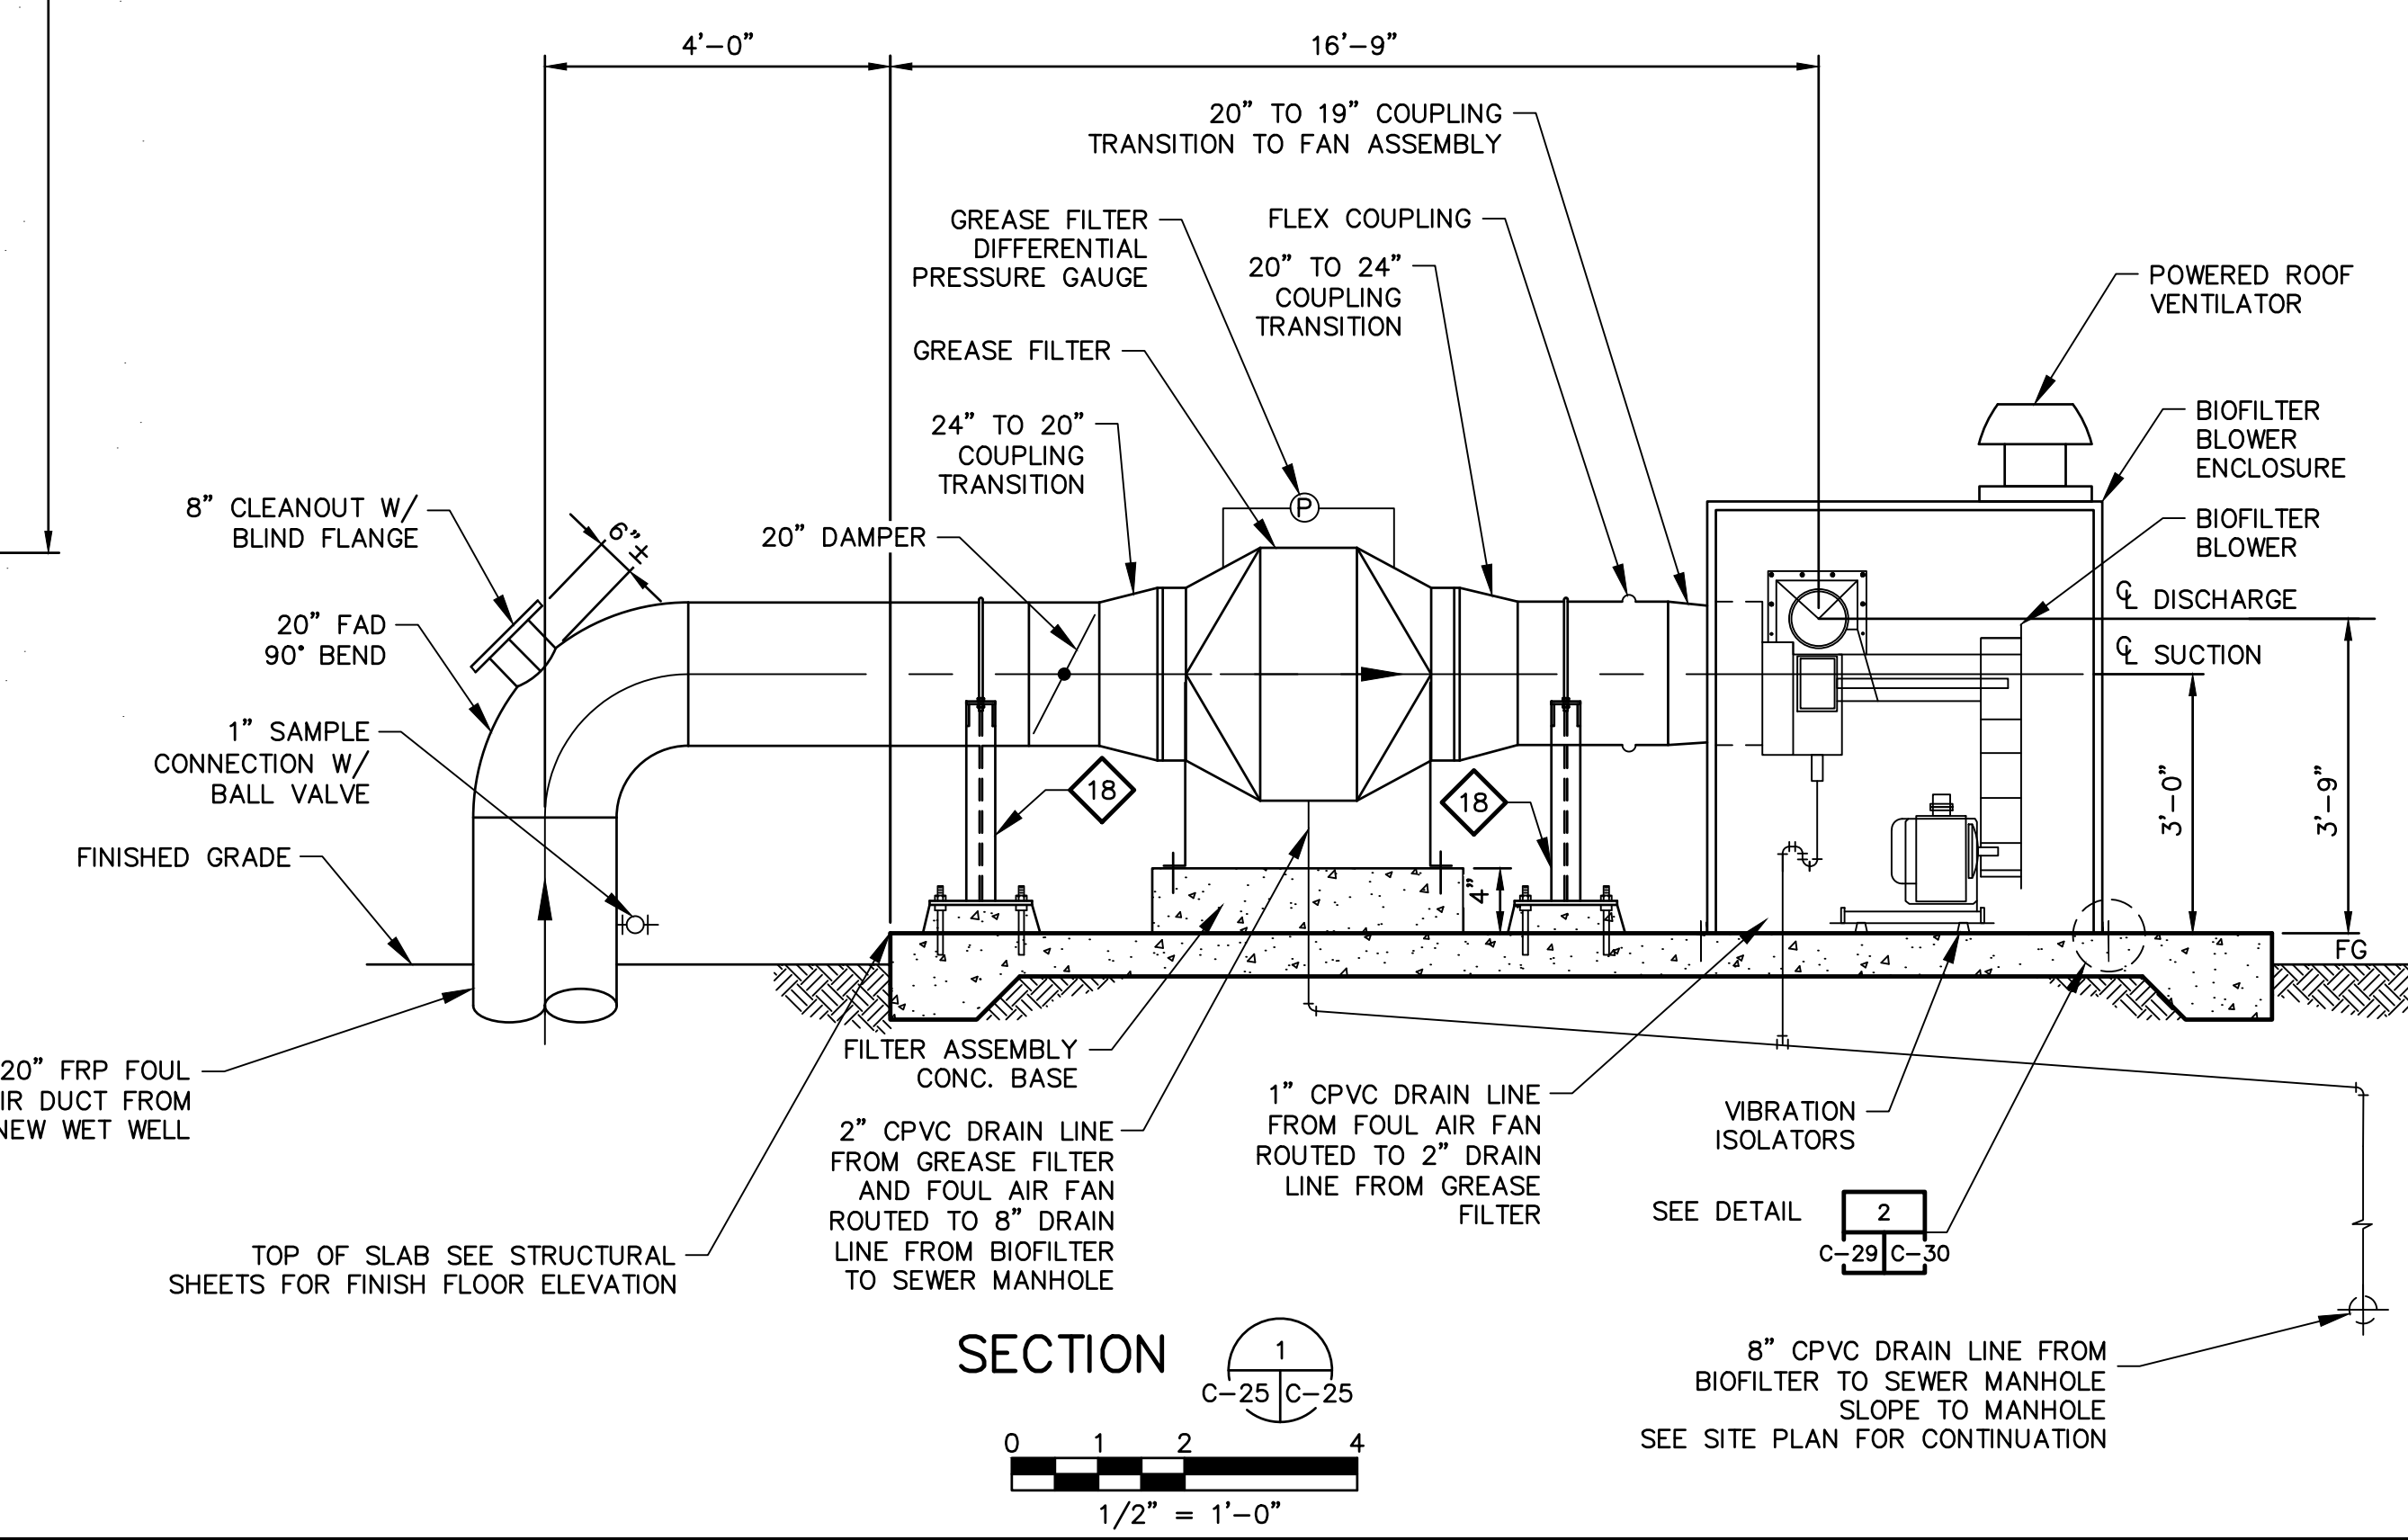


SECTION 1

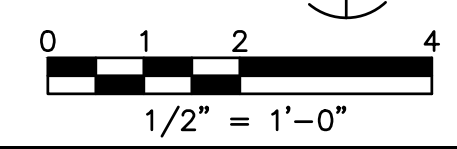


FACILITY DRAWINGS  
This drawing was supplied by a Consultant Engineer from a past project. The Consultant Engineer is not responsible for the construction information provided by the Contractor to provide a complete and accurate portrayal of facilities as they exist in the field.  
The City does not warrant this drawing to be a complete and accurate portrayal of facilities as they exist in the field.

REVISION	DATE	PROJECT NAME	DWG NUMBER	REMARKS

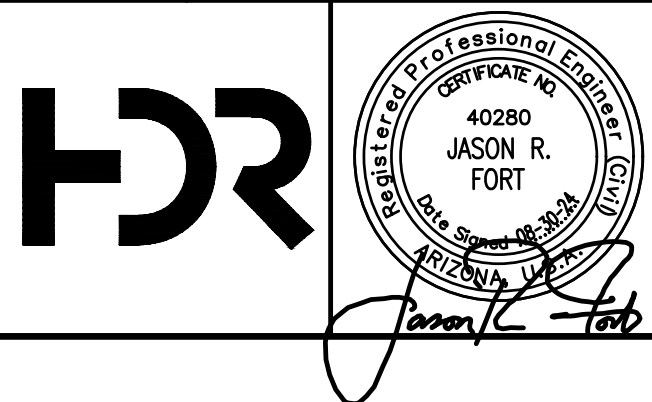

NO.	BY	DATE	CKD	REMARKS
A	RS	10/2023	JF	30% SUBMITTAL
B	RS	01/2024	JF	90% SUBMITTAL
C	RS	04/2024	JF	AGENCY REVIEW
D	DFD	08/2024	JF	ISSUED FOR CONSTRUCTION

DES	CE	DWN	RS	CKD	FS

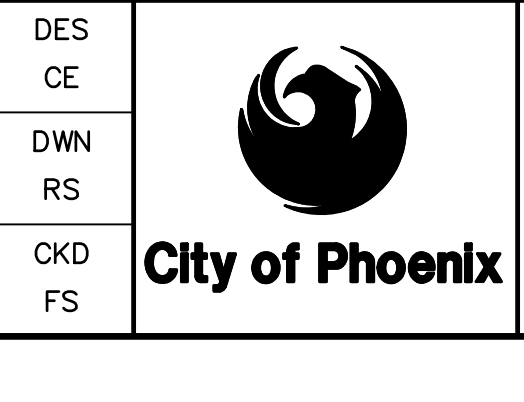

CITY OF PHOENIX  
WATER SERVICES DEPARTMENT  
  
LIFT STATION 40  
REFURBISHMENT


CIVIL  
  
BIOFILTER ENLARGED SITE PLAN

COPYRIGHT © 2007-JANUARY  
CITY PROJECT NO. WS90400085  
DATE: 08/2024  
C-29 SHEET 34 OF 134  
CAD FILE: CSCLS40P12.dwg


FOR CONSTRUCTION

THIS DRAWING MUST BE FIELD VERIFIED BEFORE USE  
DRAWING NOT TO SCALE UNLESS SCALE BAR IS PRESENT


"PER CITY OF PHOENIX CODE CHAPTER 2, SECTION 2-28, THESE PLANS ARE FOR OFFICIAL USE ONLY AND MAY NOT BE SHARED WITH OTHERS EXCEPT AS REQUIRED TO FULFILL THE OBLIGATIONS OF THE CONTRACTOR'S CONTRACT WITH THE CITY OF PHOENIX."  
THIS DOCUMENT MUST BE KEPT SECURE AT ALL TIMES.

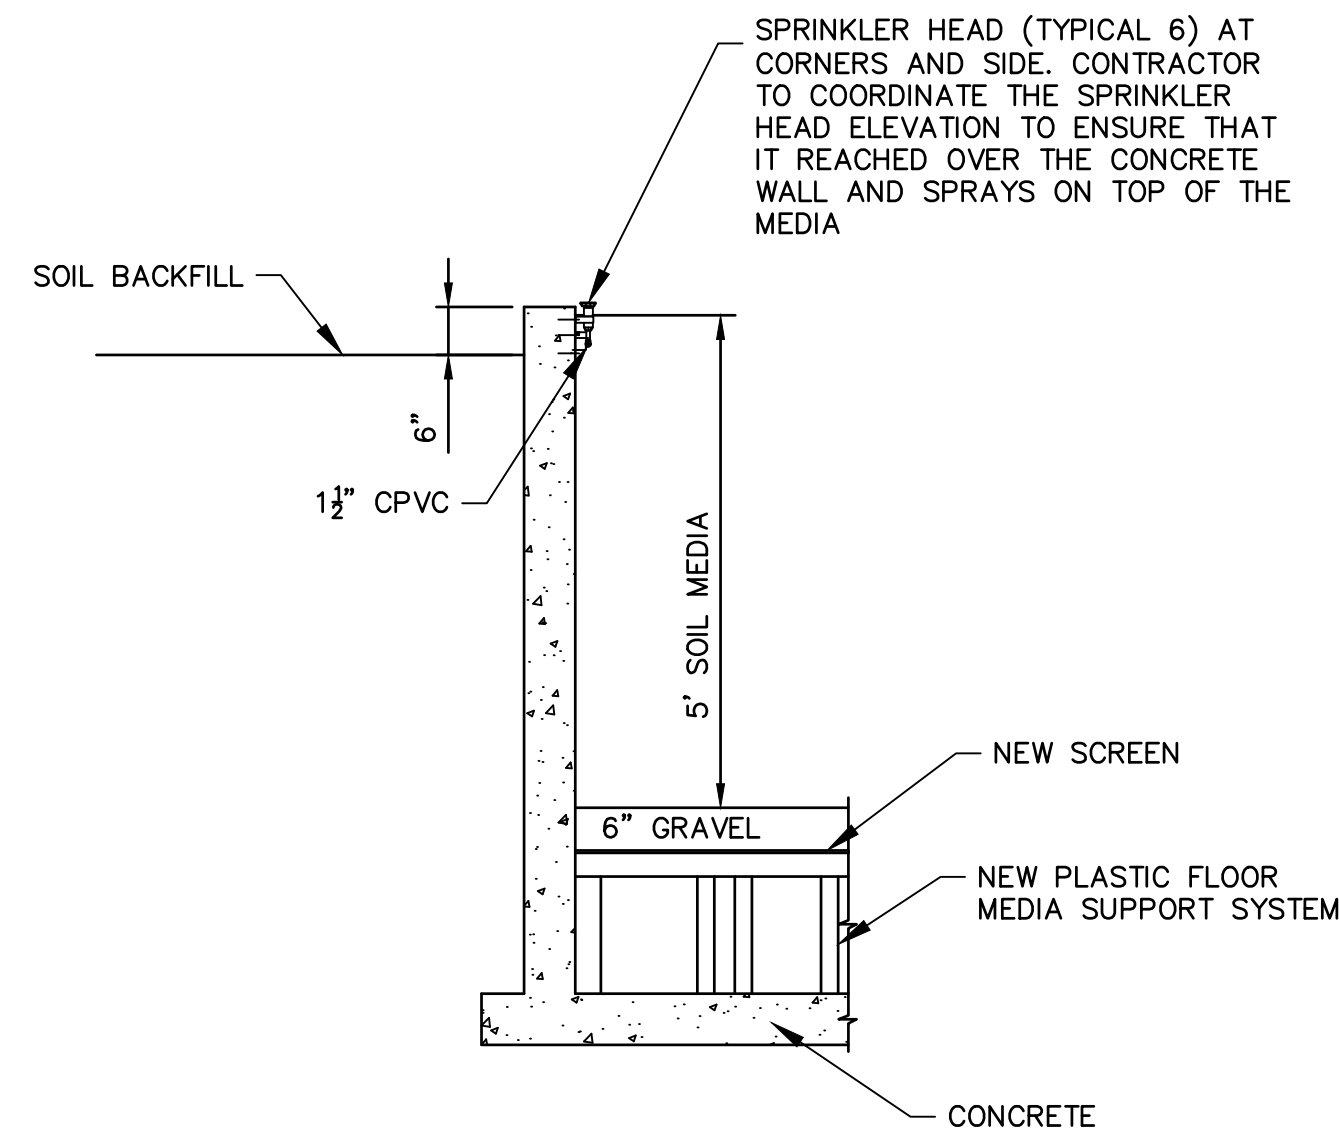


SECTION 1  
C-29 | C-30  
1/2" = 1'-0"

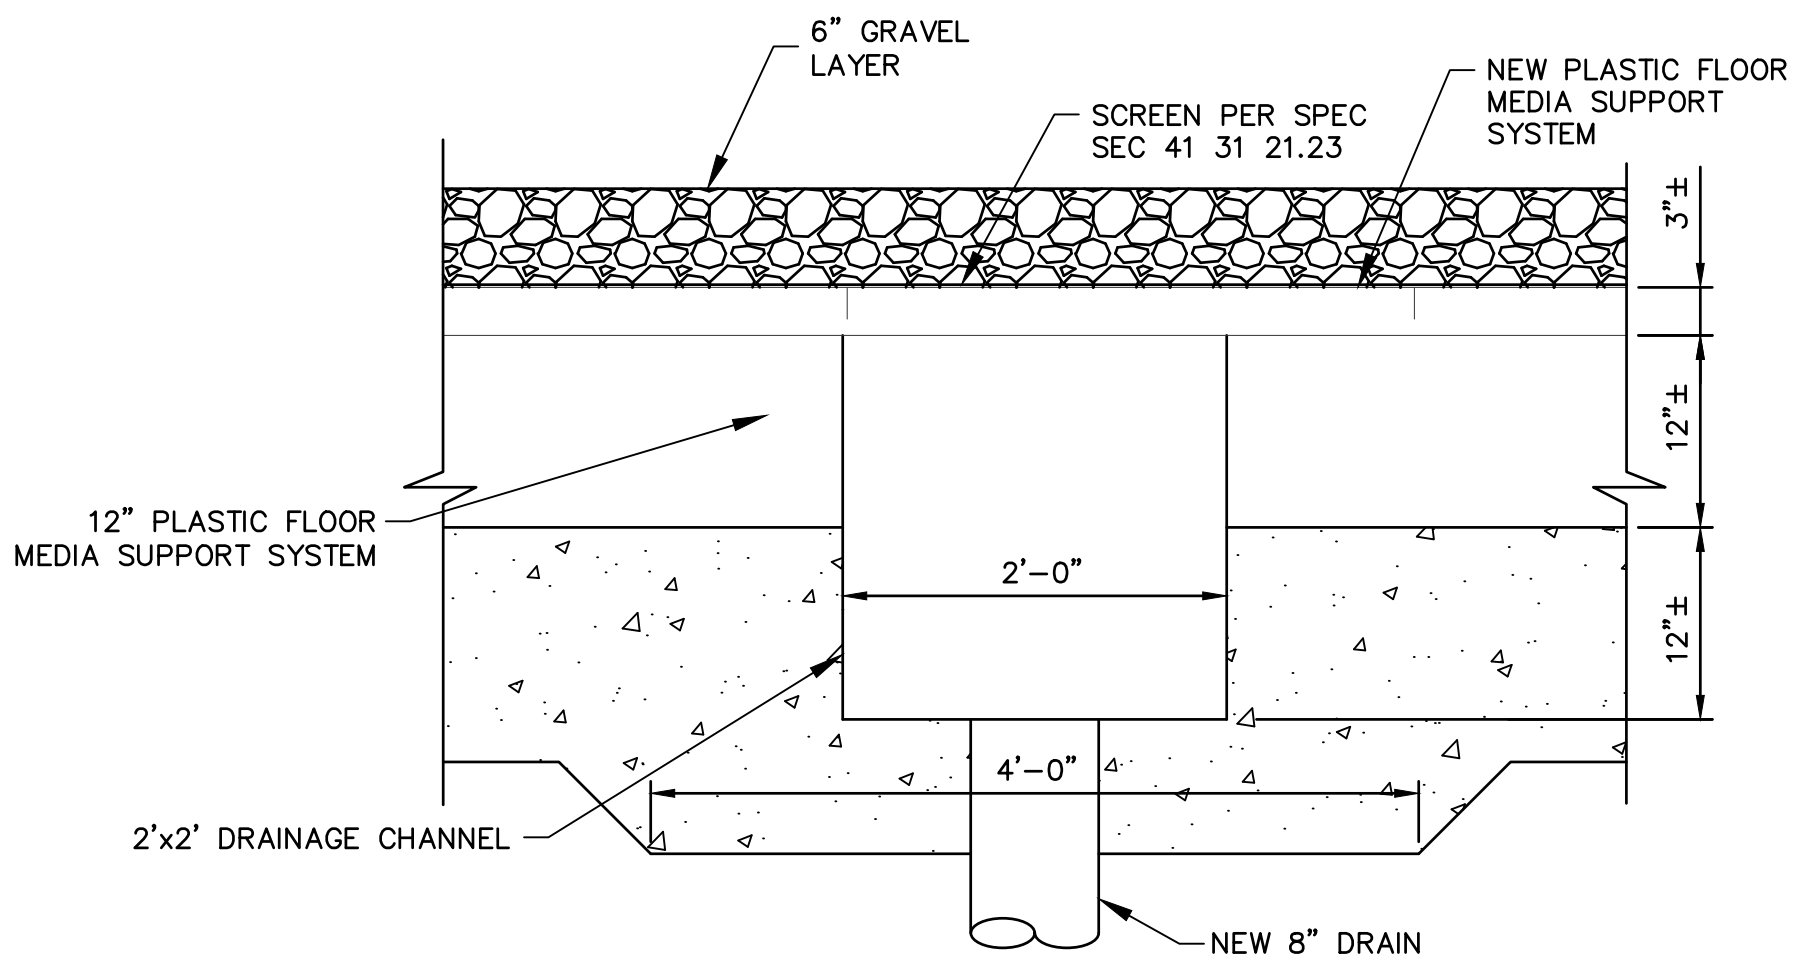

SECTION 2  
C-29 | C-30  
1" = 1'-0"

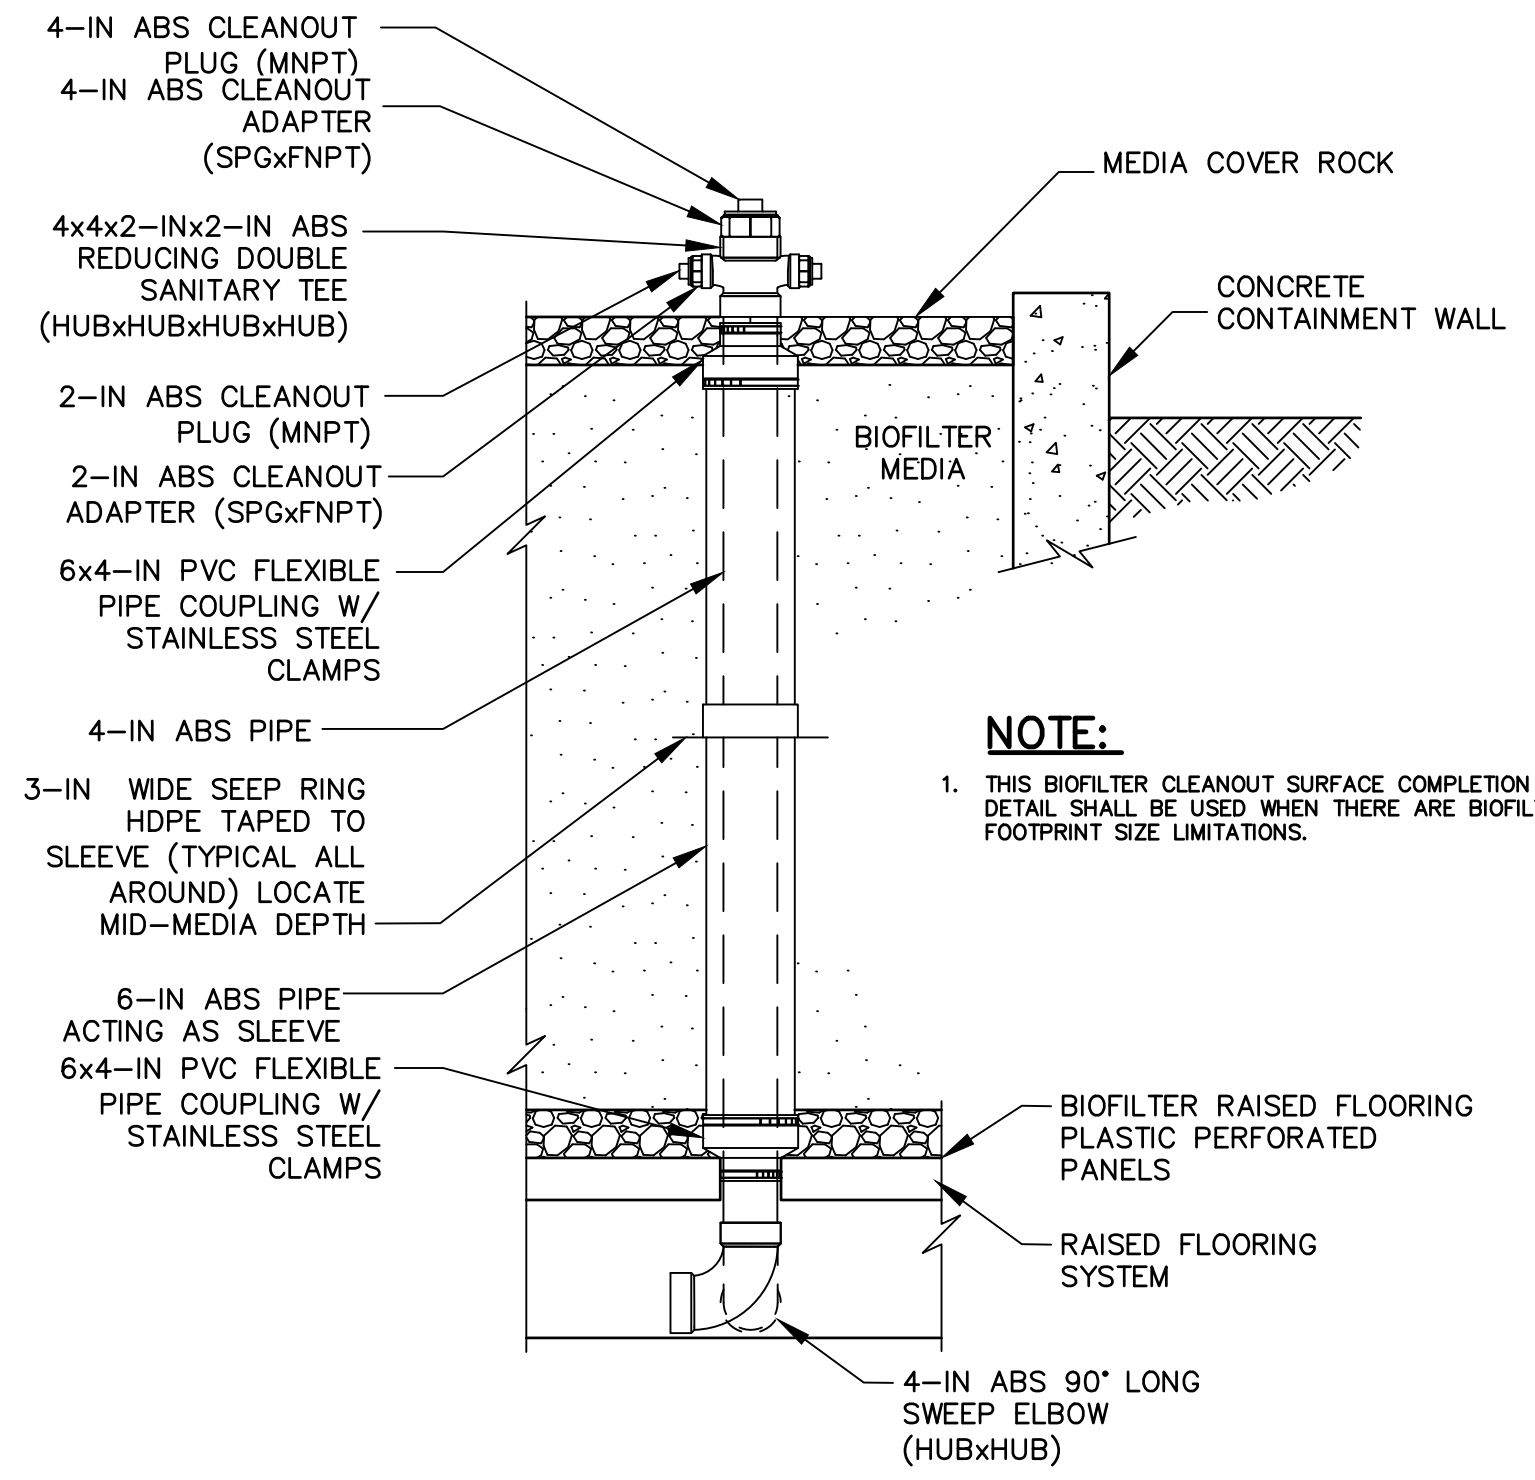


BIOFILTER CLEANOUT DETAIL  
DETAIL 1  
C-29 | C-30  
NOT TO SCALE

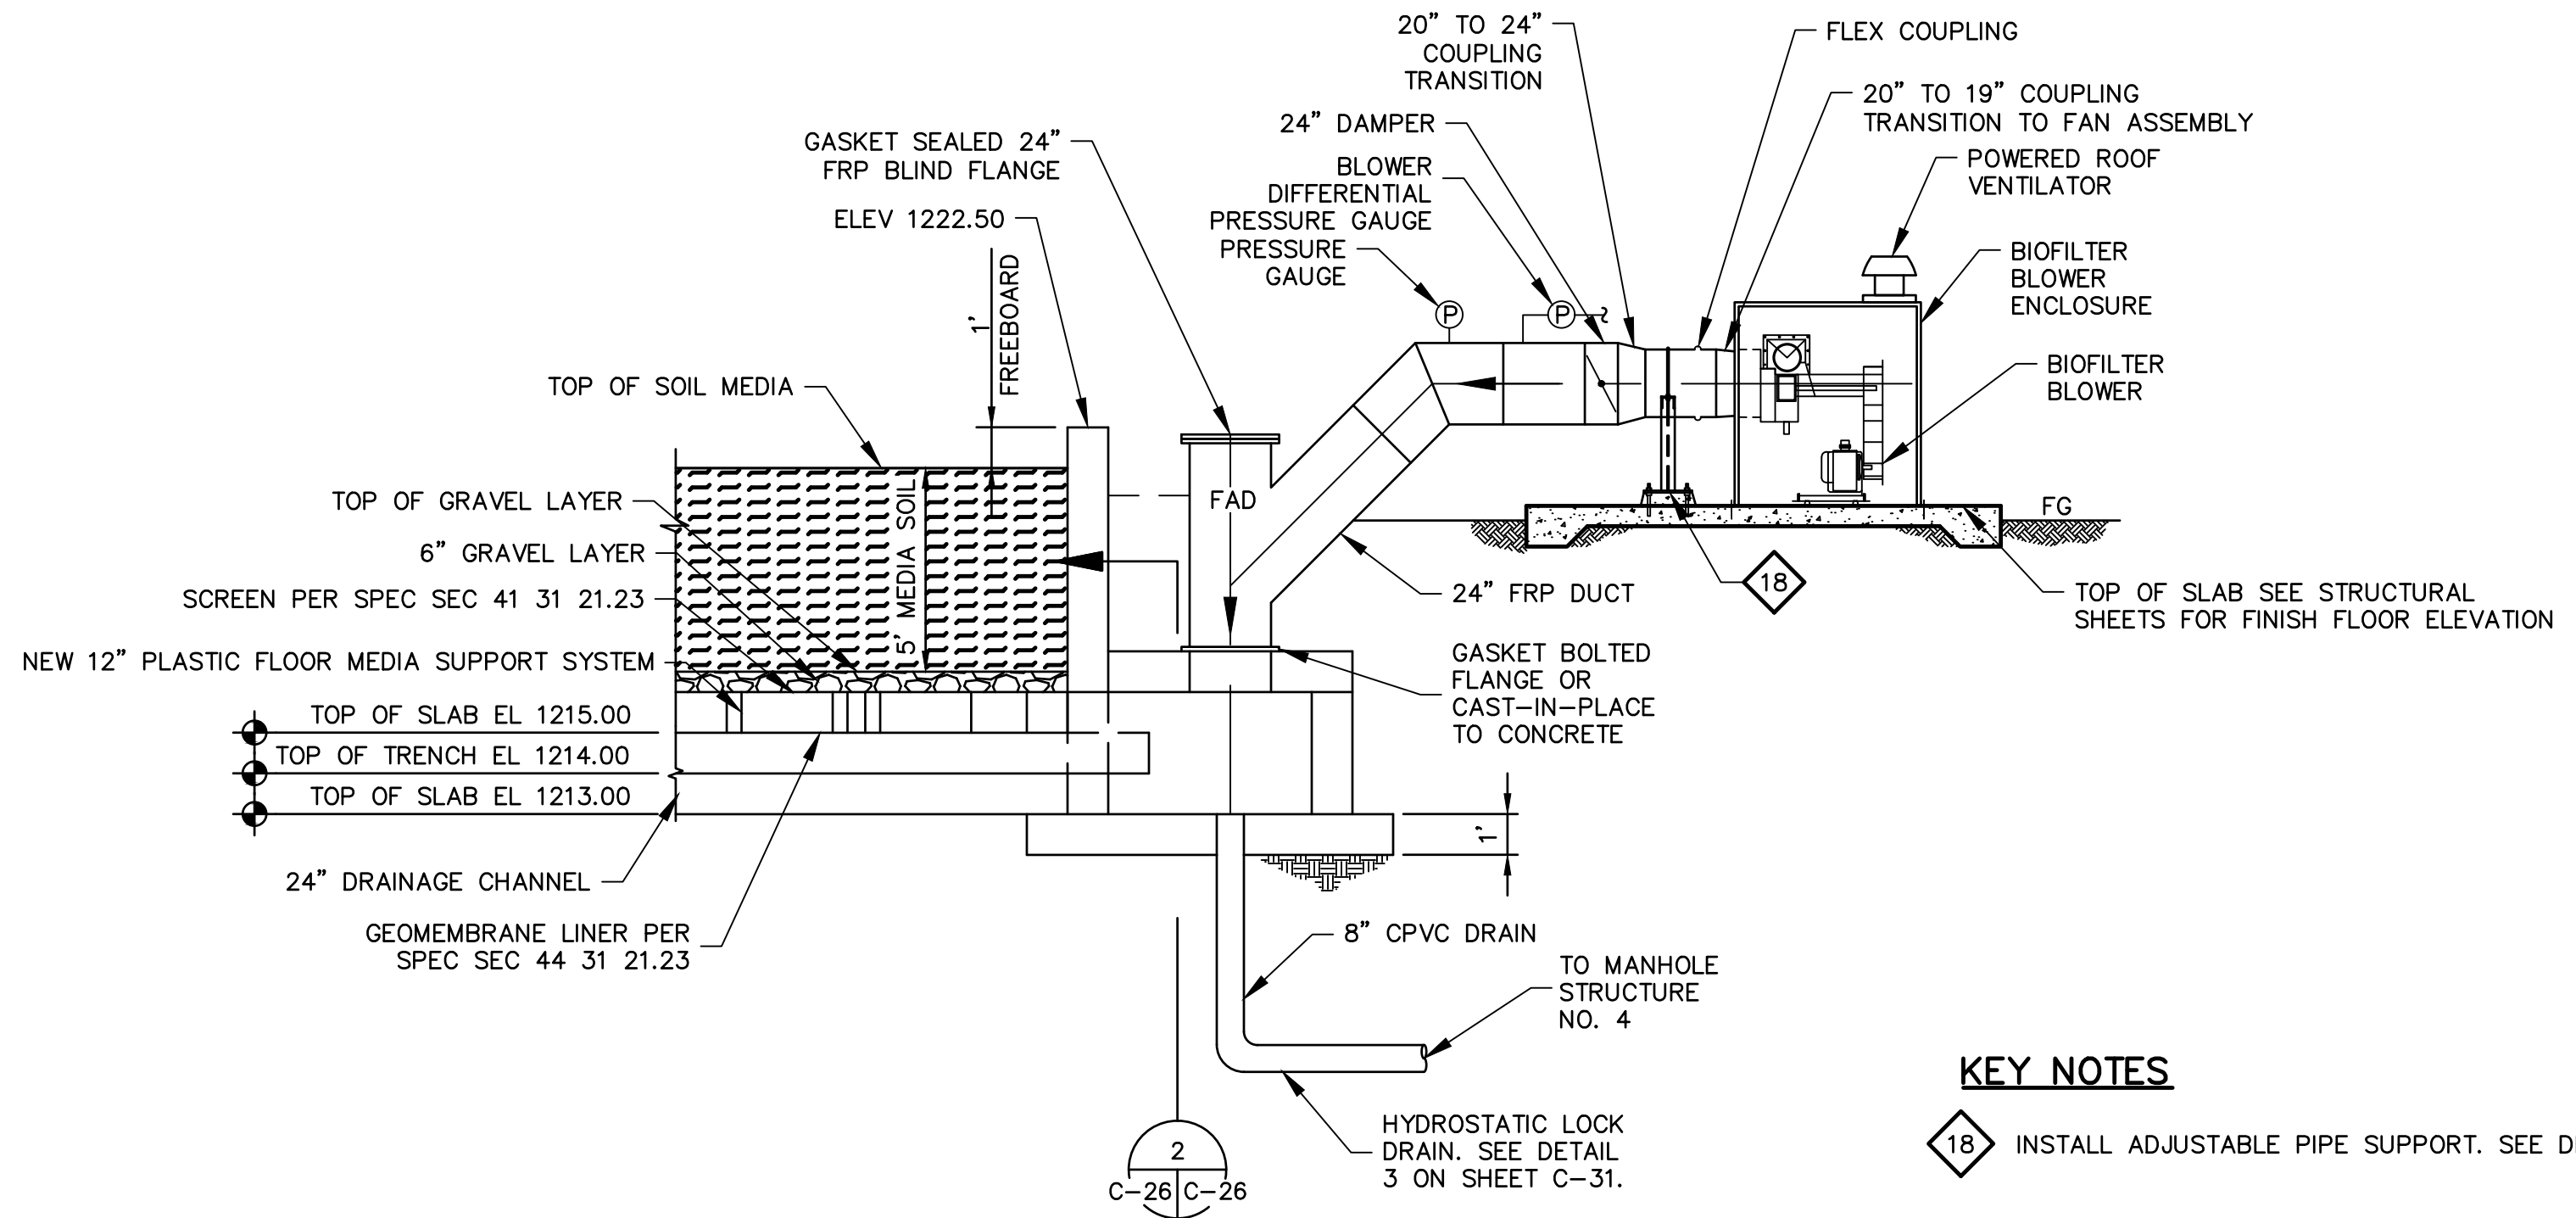

SECTION 3  
C-29 | C-30  
1/4" = 1'-0"


**KEY NOTES**  
18 INSTALL ADJUSTABLE PIPE SUPPORT. SEE DETAIL 1 C-30 M-02

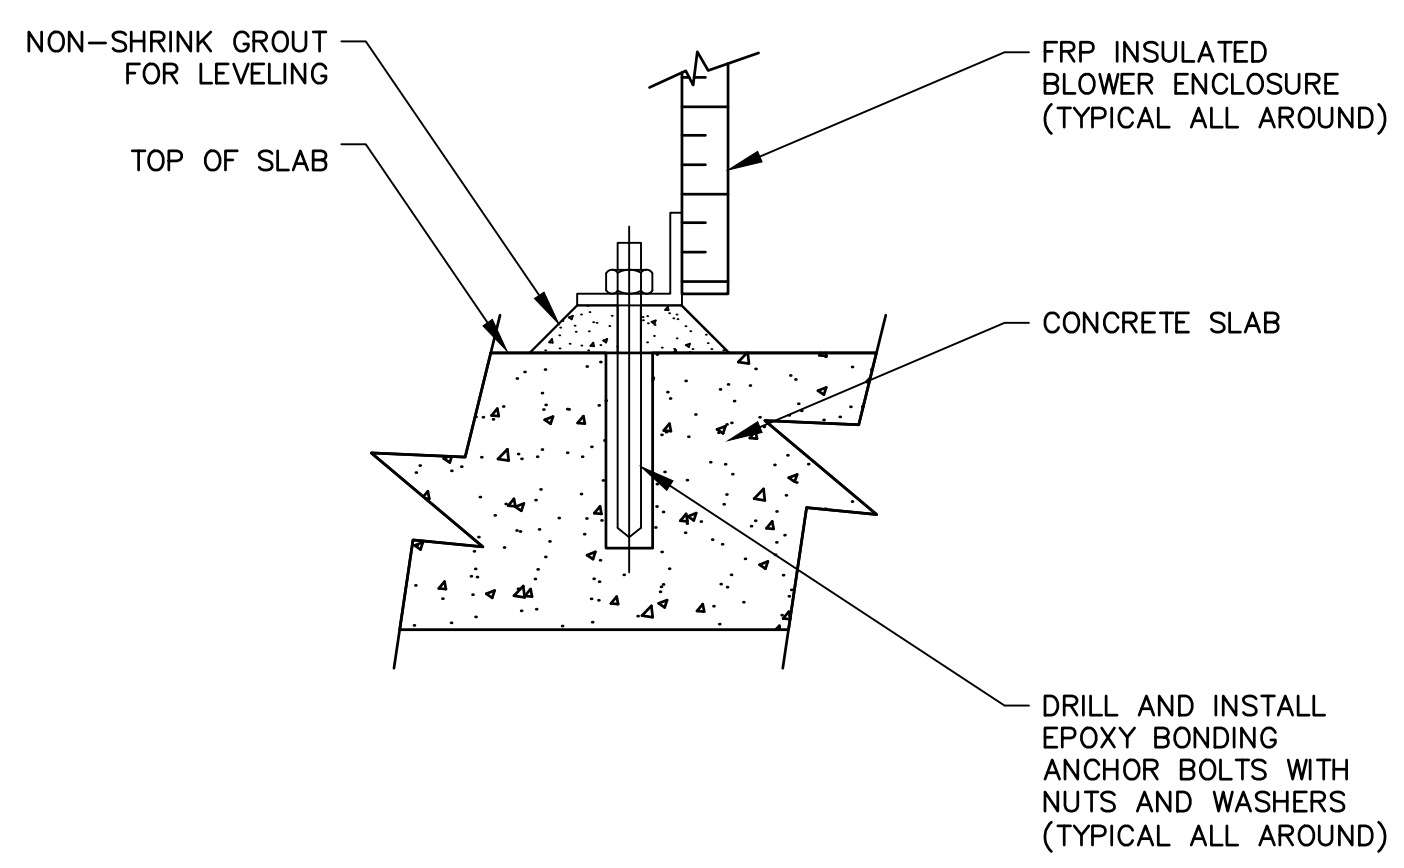


ENCLOSURE ANCHORING DETAIL  
DETAIL 2  
C-29 | C-30  
3" = 1'-0"

FACILITY DRAWINGS  
This drawing was supplied by a Consultant Engineer from a past project. The Consultant Engineer is not responsible for the construction information provided by the Contractor to provide the Record Drawing. The City does not warrant this drawing to be a complete and accurate portrayal of facilities as they exist in the field.

REVISION	DATE	PROJECT NAME	PROJECT NO.	REFERENCE CID NUMBER	DWG NUMBER	REMARKS

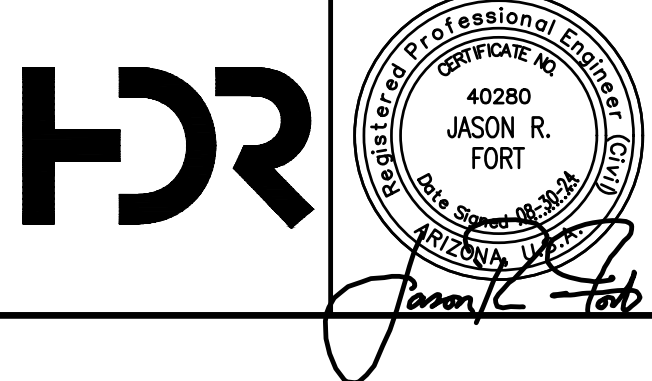

NO.	BY	DATE	CKD	REVISIONS	REMARKS
A	RS	10/2023	JF	30% SUBMITTAL	
B	RS	01/2024	JF	90% SUBMITTAL	
C	RS	04/2024	JF	AGENCY REVIEW	
D	DFD	08/2024	JF	ISSUED FOR CONSTRUCTION	
*					
*					
*					

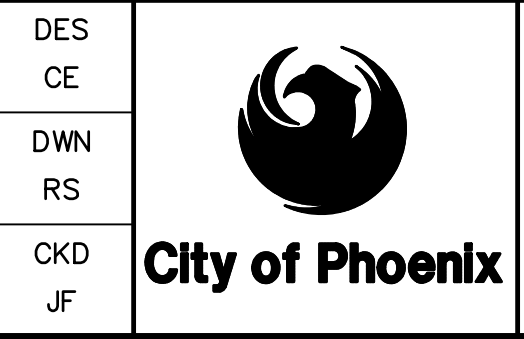

CITY OF PHOENIX  
WATER SERVICES DEPARTMENT  
  
LIFT STATION 40  
REFURBISHMENT

CIVIL  
  
BIOFILTER SECTIONS AND DETAILS


COPYRIGHT © 2007-JANUARY  
CITY PROJECT NO. WS90400085  
DATE: 08/2024  
C-30 SHEET 35 OF 134  
CAD FILE: CSCLS40P13.dwg

USER: FIDES\FR\AUDI FILE: C:\pwworking\west01\03411640\35\_CSCLS40P13.dwg DATE: 09/04/24 TIME: 03:23pm


**FOR CONSTRUCTION**

THIS DRAWING MUST BE FIELD VERIFIED BEFORE USE. DRAWING NOT TO SCALE UNLESS SCALE BAR IS PRESENT

"PER CITY OF PHOENIX CODE CHAPTER 2, SECTION 2-28, THESE PLANS ARE FOR OFFICIAL USE ONLY AND MAY NOT BE SHARED WITH OTHERS EXCEPT AS REQUIRED TO FULFILL THE OBLIGATIONS OF THE CONTRACTOR'S CONTRACT WITH THE CITY OF PHOENIX." THIS DOCUMENT MUST BE KEPT SECURE AT ALL TIMES.

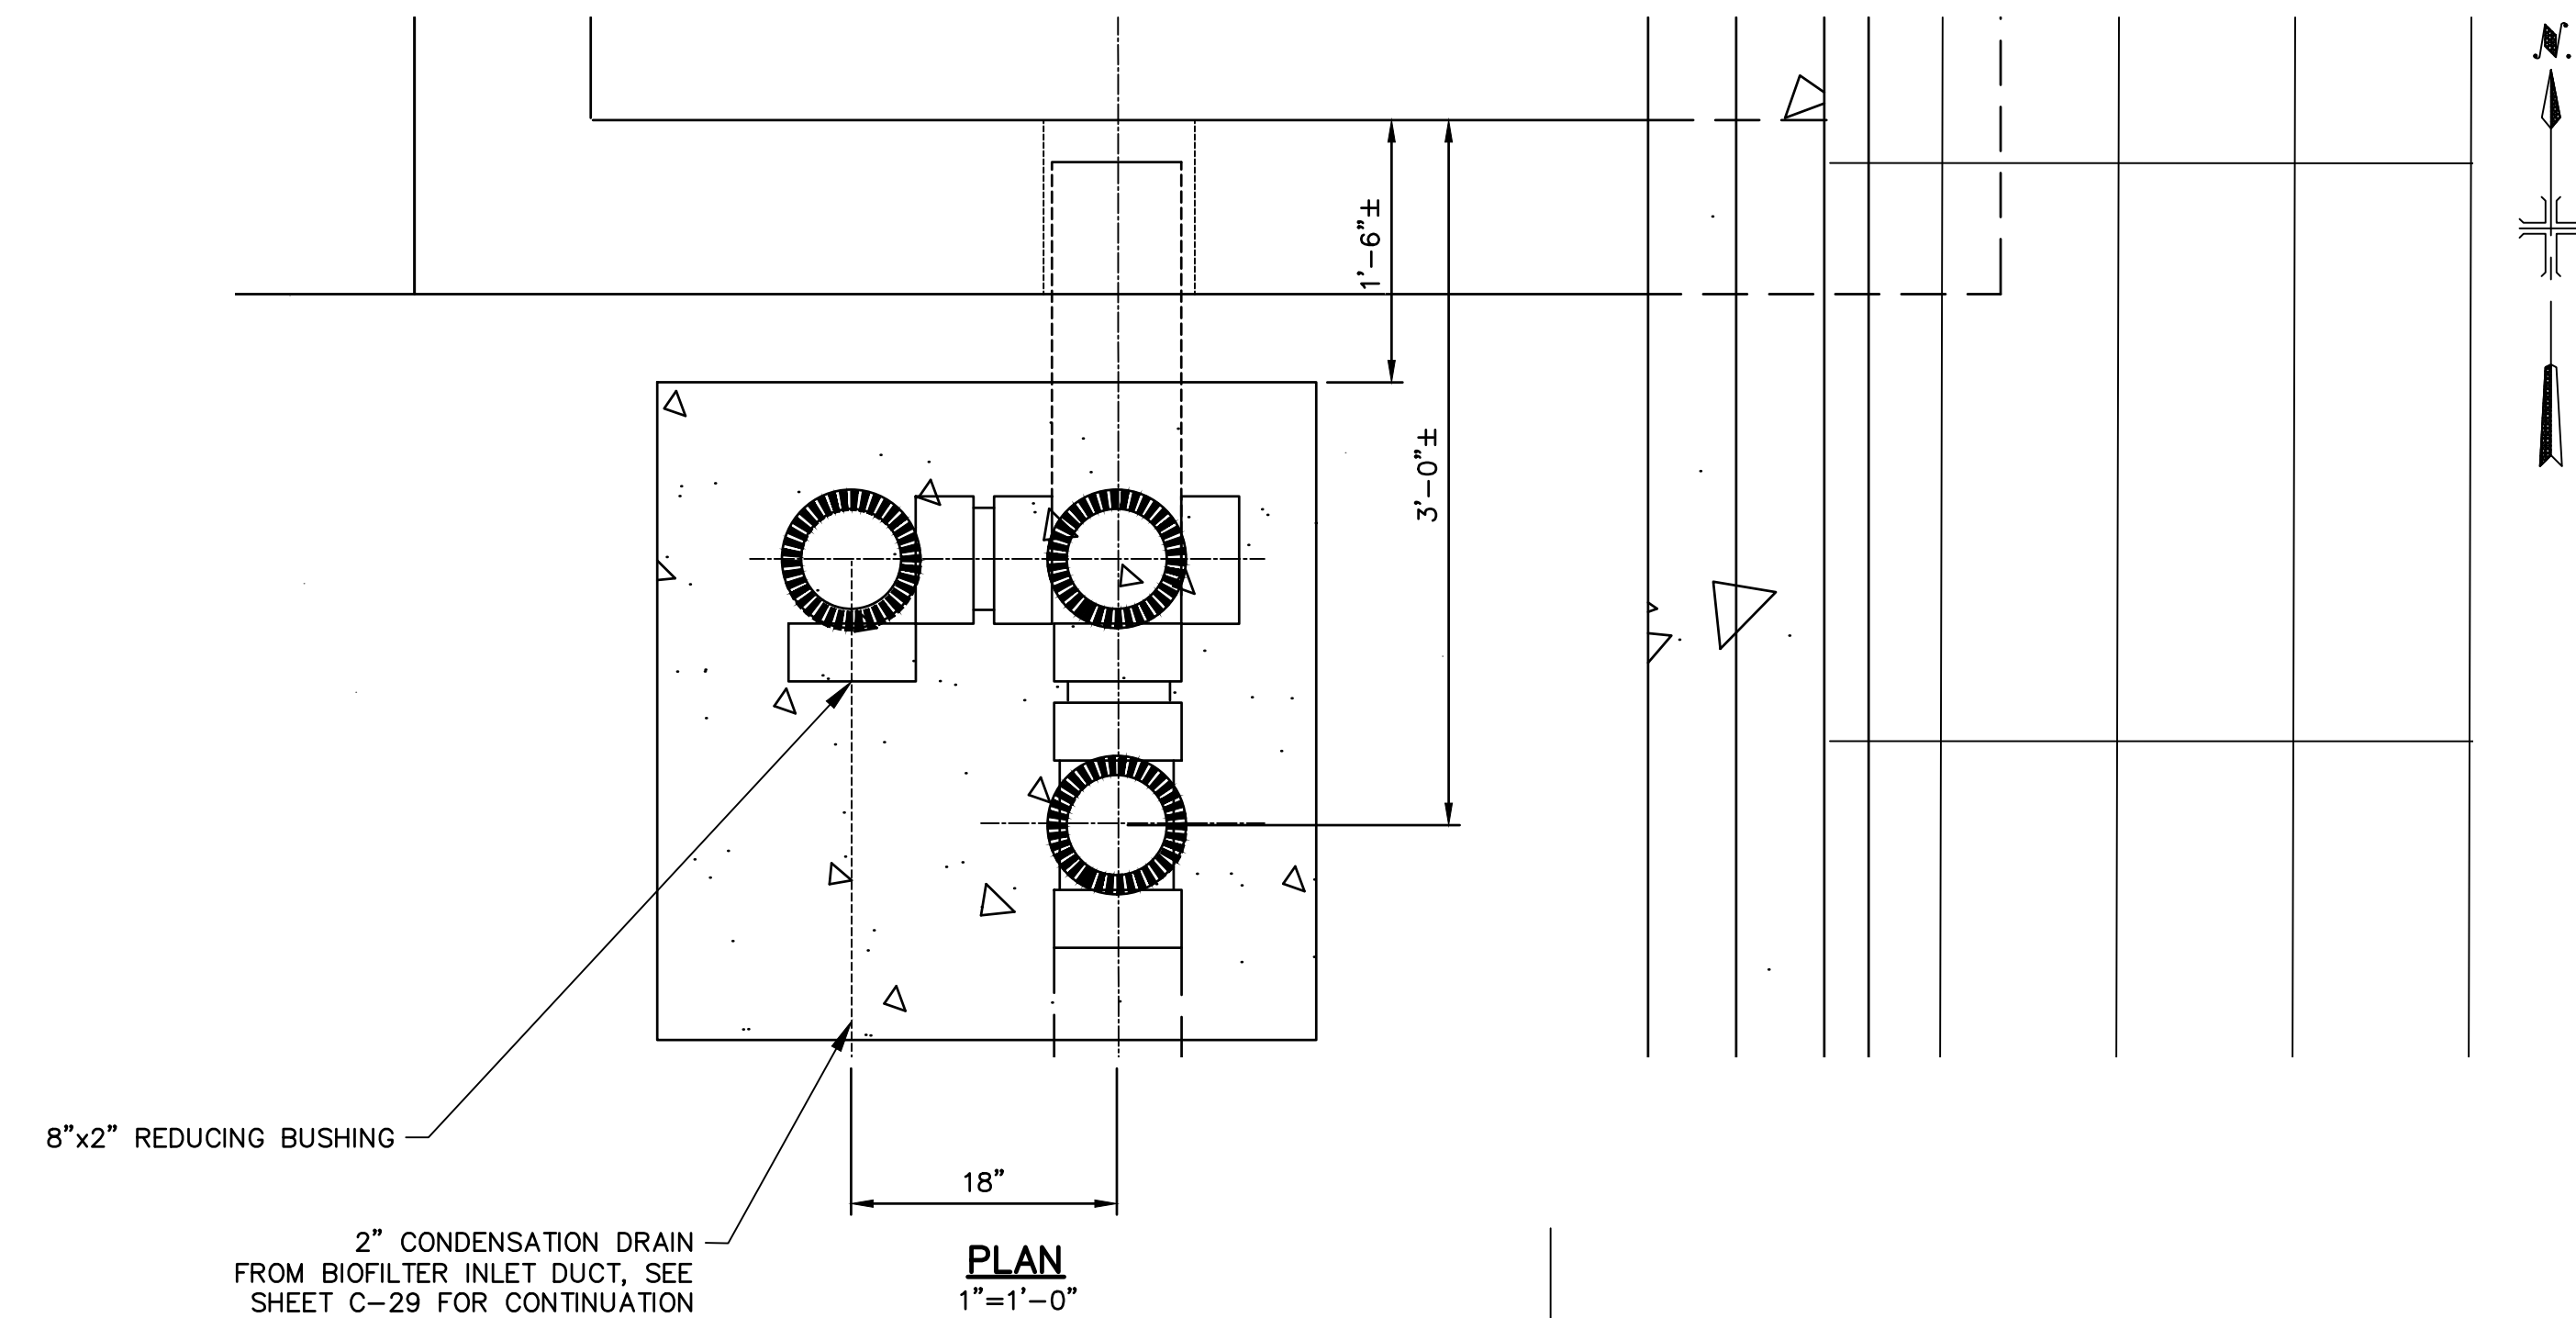


**PLAN**  
1"=1'-0"

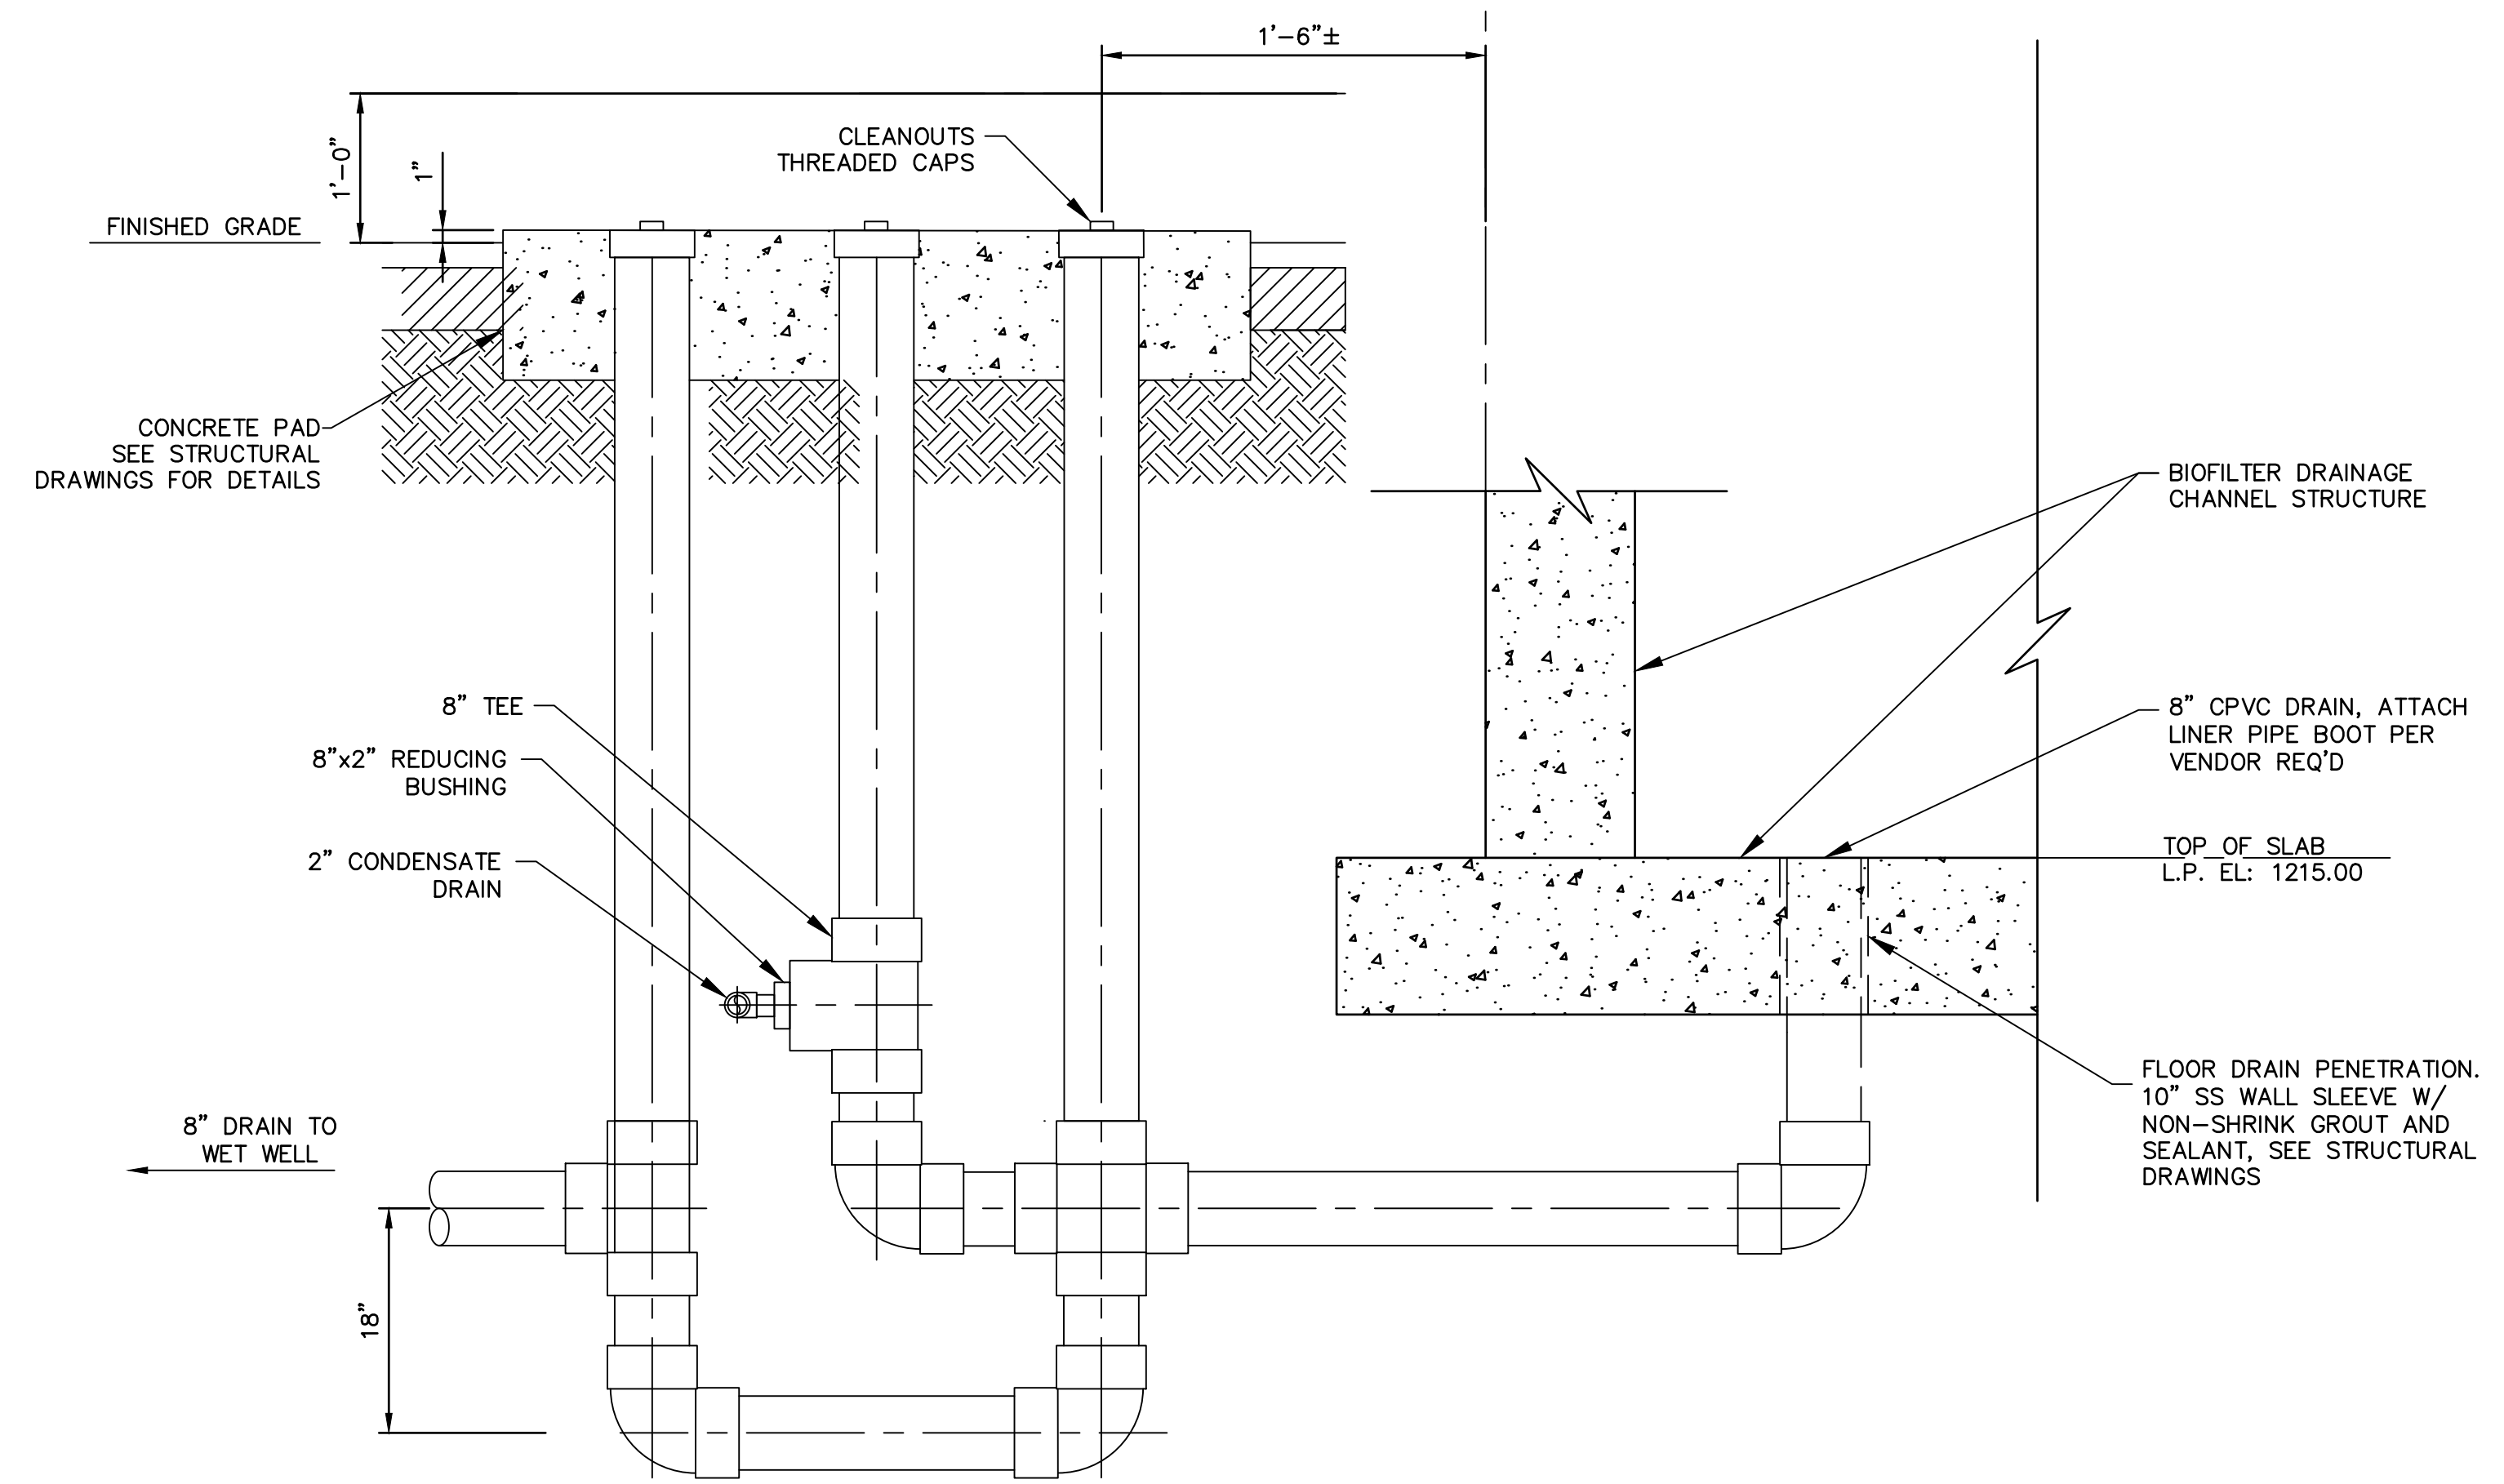

**SECTION**  
**HYDROSTATIC LOCK DRAIN DETAIL**

**DETAIL** 3  
C-29 C-31  
1"=1'-0"

**NOTE:**  
THE CLEANOUTS SHOWN OUT OF SECTION, SEE PLAN VIEW ON SHEET C-25 FOR CORRECT ORIENTATION

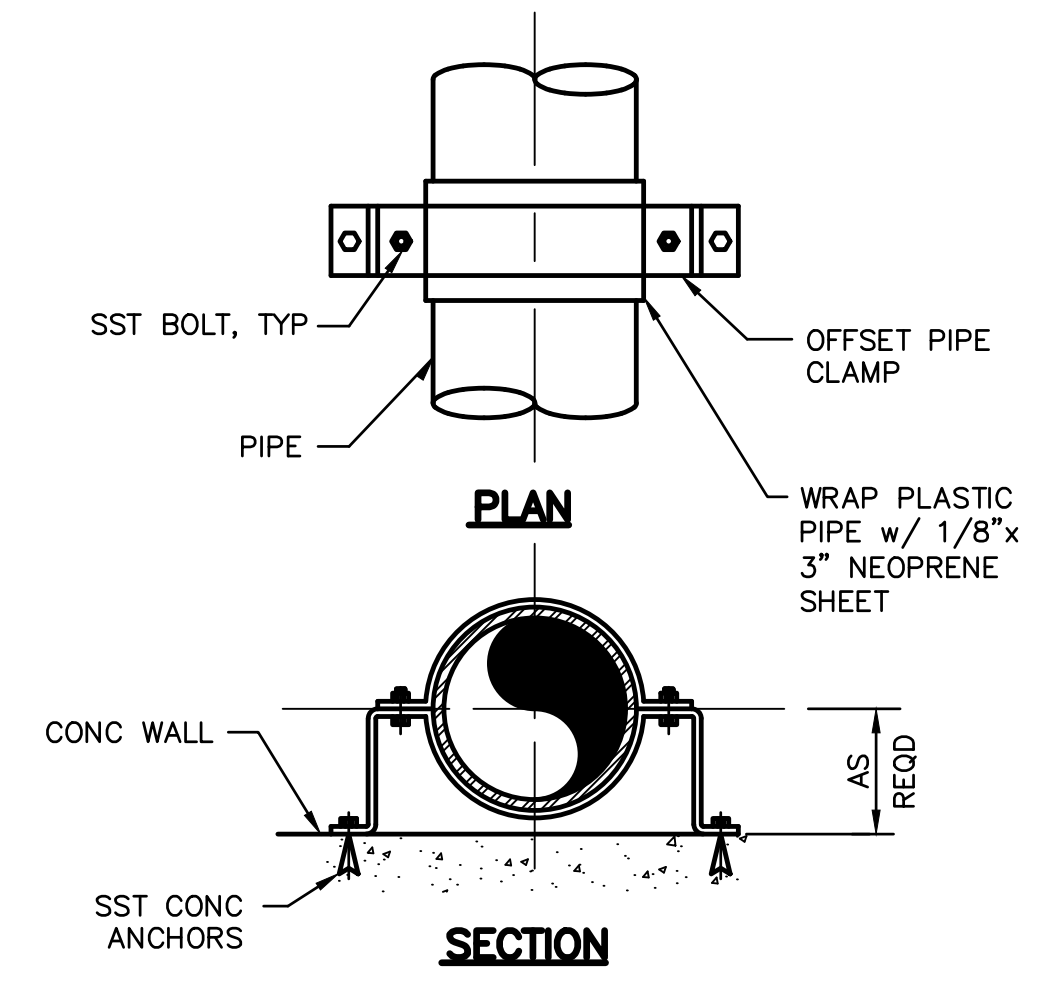


**SPRINKLER PIPE SUPPORT**  
**DETAIL** 4  
C-31 C-31  
NOT TO SCALE


- NOTE:**
- MATERIAL FOR ALL COMPONENTS SHALL BE HOT DIPPED GALVANIZED AFTER FABRICATION UNLESS NOTED OTHERWISE.
  - MATERIAL FOR ALL COMPONENTS OF THE PIPE SUPPORT USED FOR SUPPORTING CPVC CHEMICAL PIPING SHALL BE FRP.

FACILITY DRAWINGS  
This drawing was supplied by a Consultant Engineer from a past construction project. The Consultant Engineer is not responsible for construction information provided by the Contractor to provide the Record Drawing. The City does not warranty this drawing to be a complete and accurate portrayal of facilities as they exist in the field.

REVISION	DWG NUMBER	CAD FILE NAME	DATE	PROJECT NAME	PROJECT NO.	REFERENCE CID NUMBER: #	REMARKS
#							
#							
#							

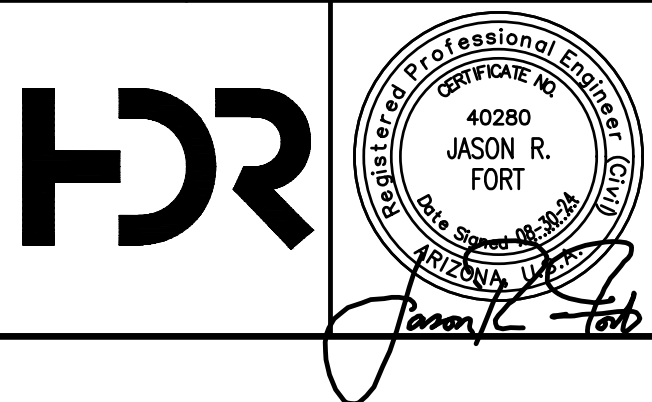

NO.	BY	DATE	CKD	REVISIONS	REMARKS
A	RS	10/2023	JF	30% SUBMITTAL	
B	RS	01/2024	JF	90% SUBMITTAL	
C	RS	04/2024	JF	AGENCY REVIEW	
D	DFD	08/2024	JF	ISSUED FOR CONSTRUCTION	
*					
*					
*					

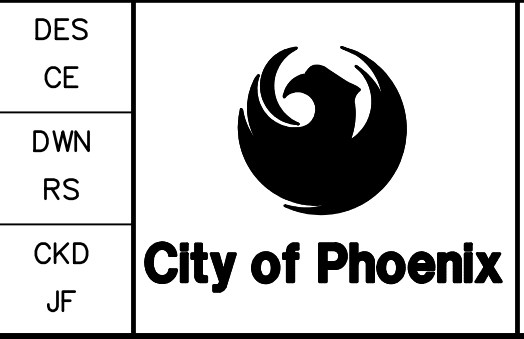

CITY OF PHOENIX  
WATER SERVICES DEPARTMENT  
  
LIFT STATION 40  
REFURBISHMENT

CIVIL  
  
BIOFILTER DETAILS

COPYRIGHT © 2007-JANUARY  
CITY PROJECT NO. WS90400085  
DATE: 08/2024  
C-31 SHEET 36 OF 134  
CAD FILE: CSCLS40P14.dwg

USER: FIDES\FR\AUD FILE: C:\pwworking\west01\03411840\36\_CSCLS40P14.dwg DATE: 9/14/24 TIME: 03:23pm

**FOR CONSTRUCTION**



"PER CITY OF PHOENIX CODE CHAPTER 2, SECTION 2-28, THESE PLANS ARE FOR OFFICIAL USE ONLY AND MAY NOT BE SHARED WITH OTHERS EXCEPT AS REQUIRED TO FULFILL THE OBLIGATIONS OF THE CONTRACTOR'S CONTRACT WITH THE CITY OF PHOENIX." THIS DOCUMENT MUST BE KEPT SECURE AT ALL TIMES.

THIS DRAWING MUST BE FIELD VERIFIED BEFORE USE DRAWING NOT TO SCALE UNLESS SCALE BAR IS PRESENT

**PIPE FITTING SYMBOLS**


**DOUBLE LINE**

**SINGLE LINE**

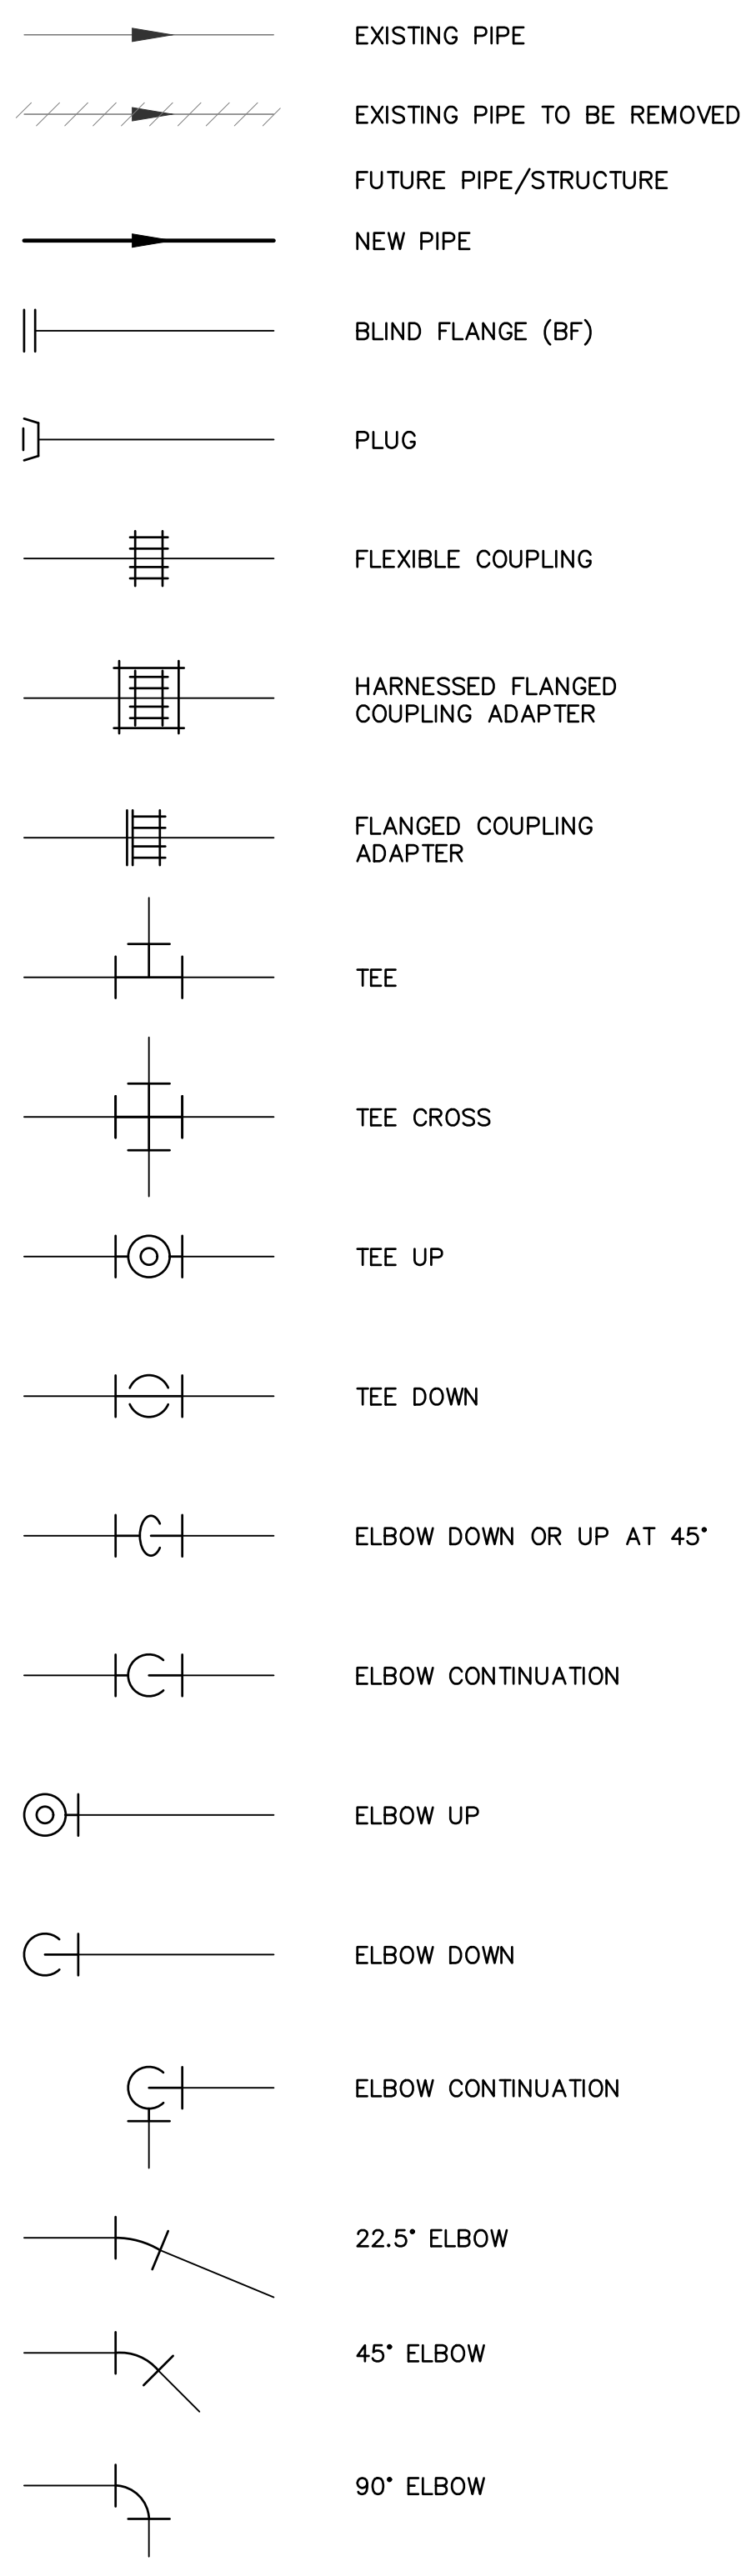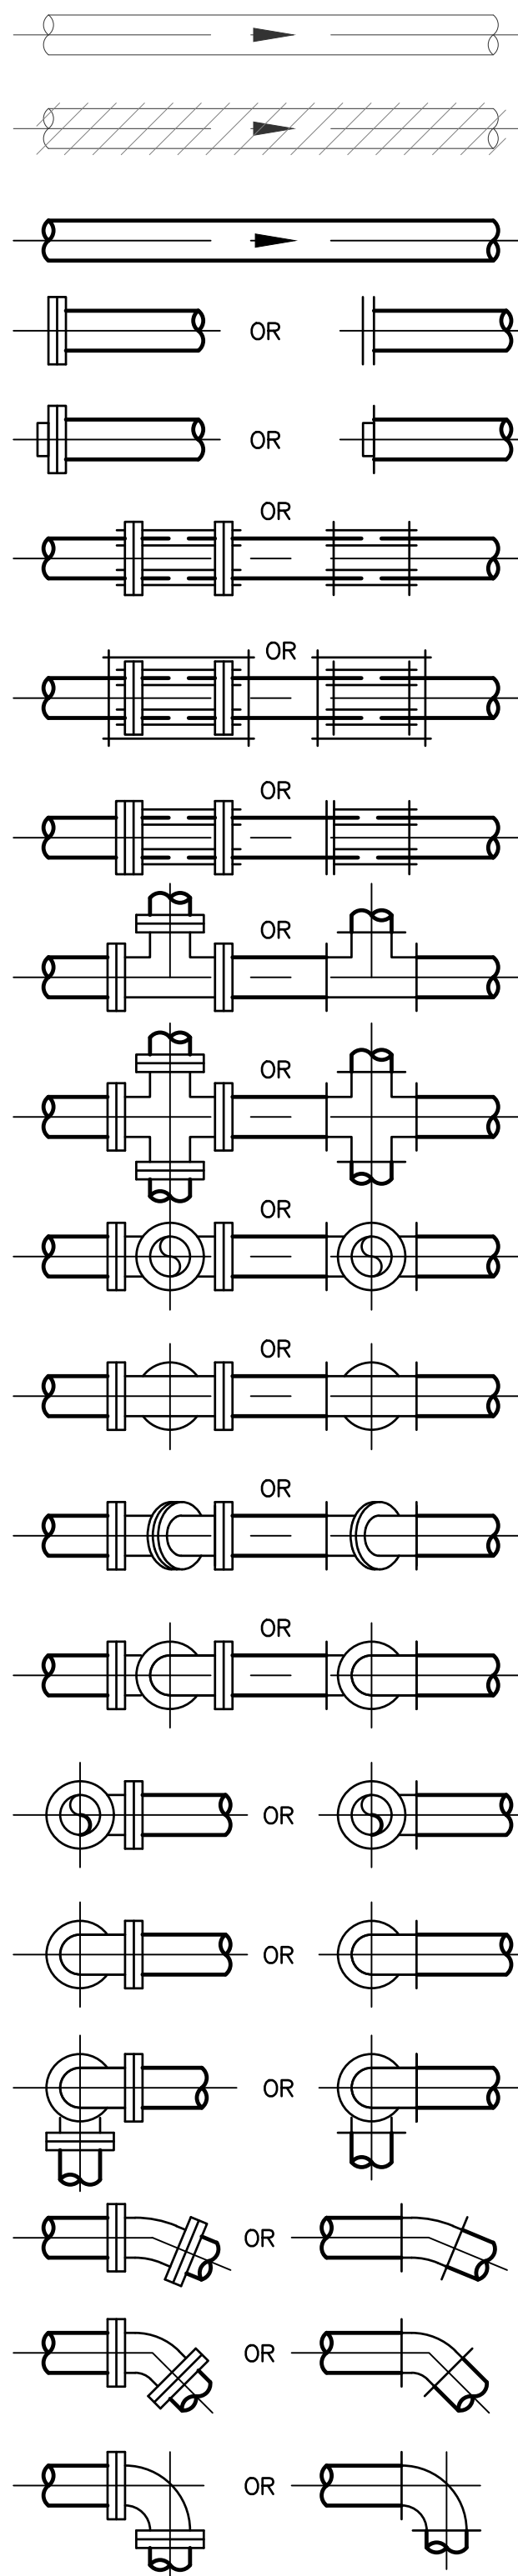

**PIPE VALVE SYMBOLS**



**DOUBLE LINE**

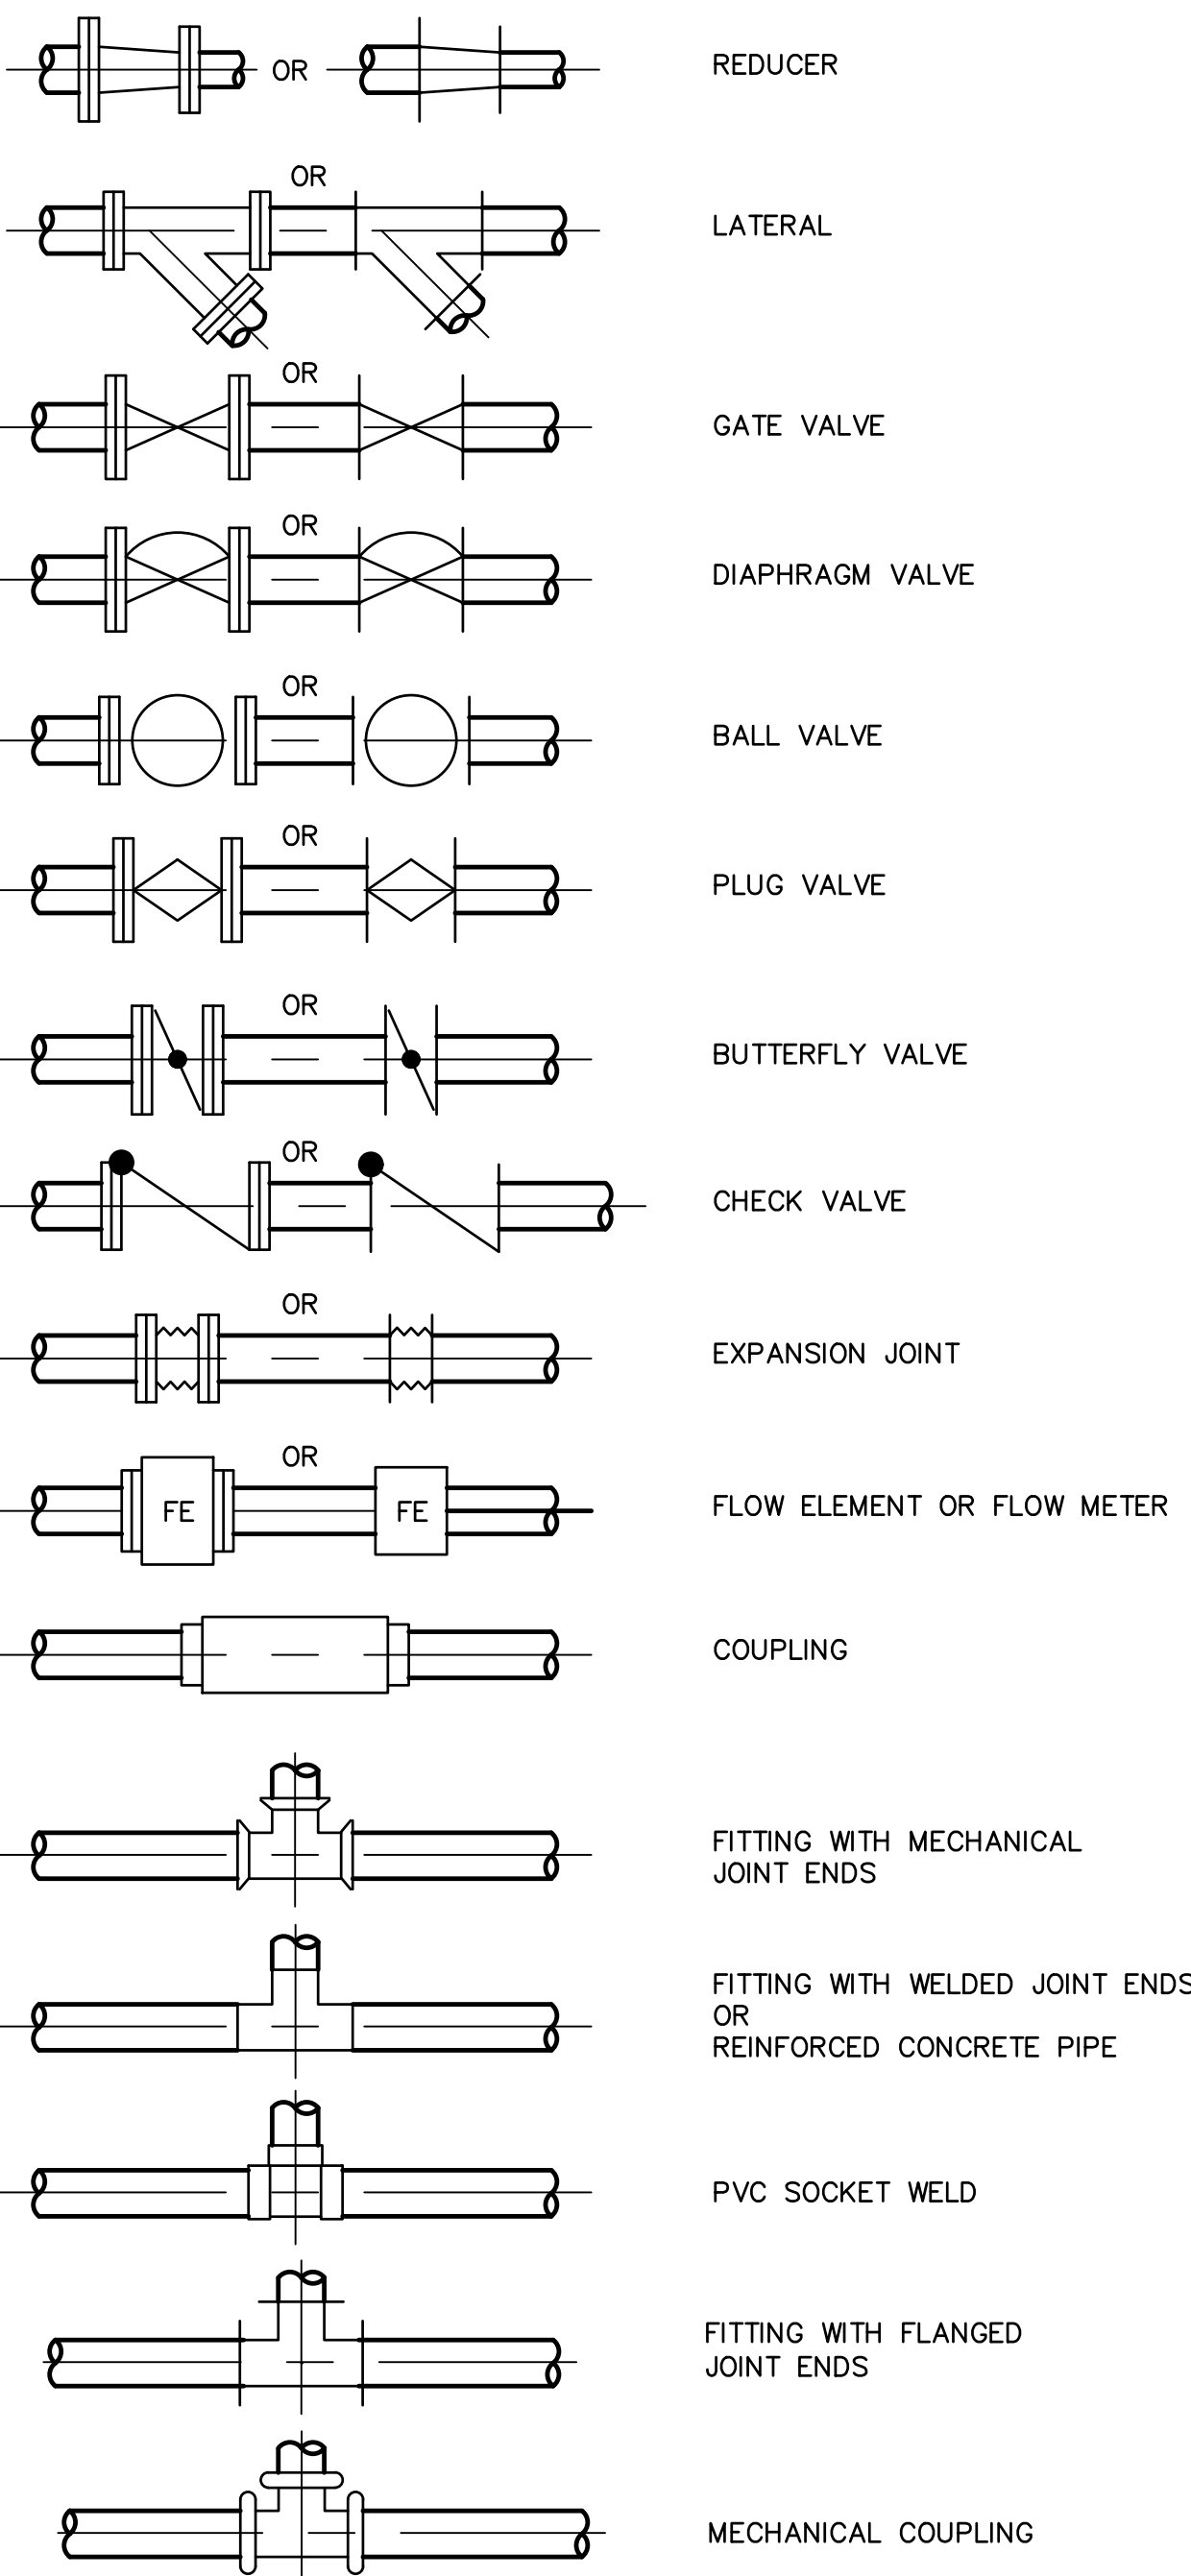

**NOTES:**  
 1. SOLID FILLED VALVES INDICATE NORMALLY CLOSED (NC) POSITION.  
 2. SINGLE LINE PIPE SHOWN DOES NOT DEPICT FITTING TYPES. SEE SPECIFICATIONS FOR MATERIALS AND FITTINGS TO BE USED.


**PIPE FITTINGS, VALVE SYMBOLS AND EQUIPMENT**

**SINGLE LINE**

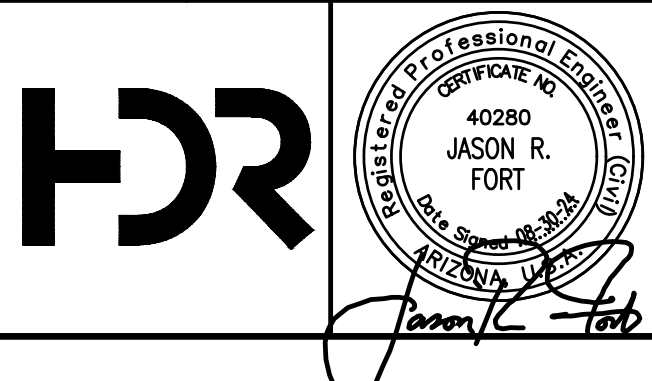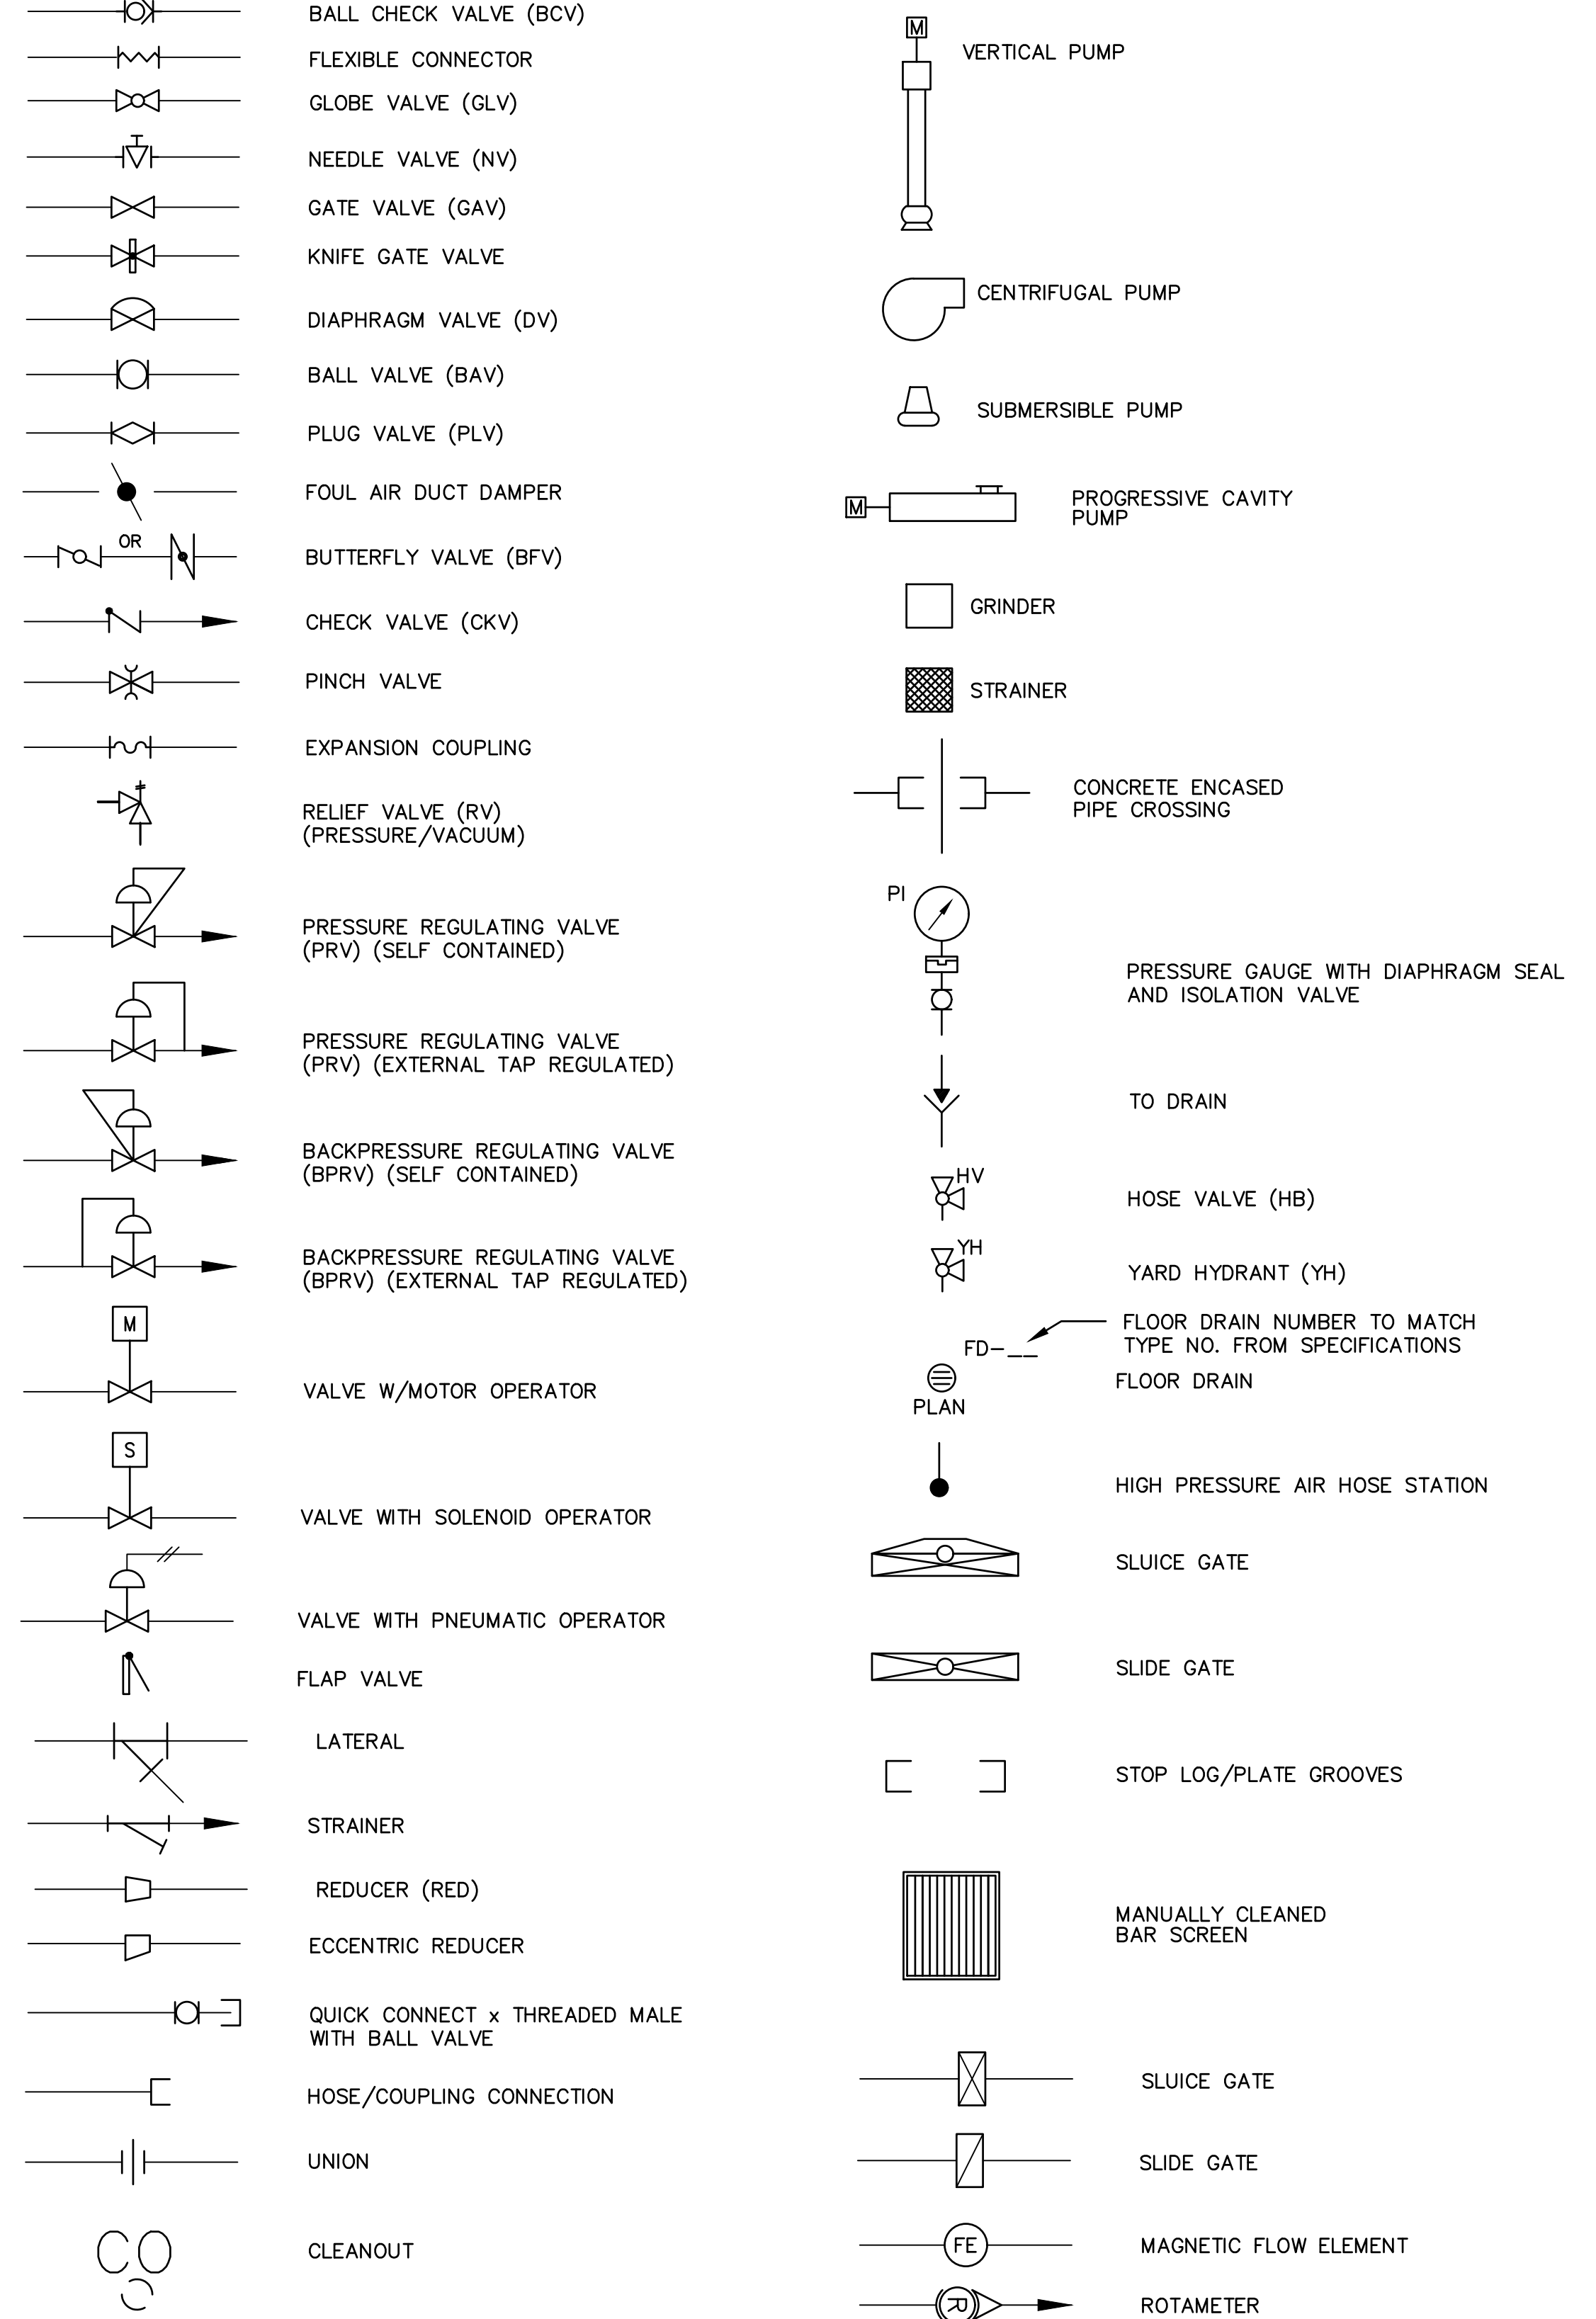

NO.	BY	DATE	CKD	REMARKS
A	RS	10/2023	JF	30% SUBMITTAL
B	RS	01/2024	JF	90% SUBMITTAL
C	RS	04/2024	JF	AGENCY REVIEW
D	DFD	08/2024	JF	ISSUED FOR CONSTRUCTION
*				
*				
*				

DES	FS	DWN	RS	CKD	JF

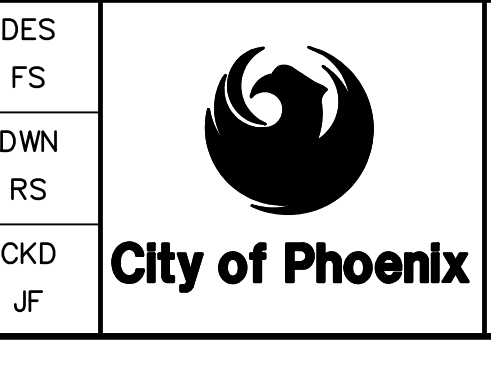

CITY OF PHOENIX  
 WATER SERVICES DEPARTMENT  
**LIFT STATION 40  
 REFURBISHMENT**

MECHANICAL  
**MECHANICAL LEGEND & SYMBOLS**

COPYRIGHT © 2007--JANUARY  
 CITY PROJECT NO. WS90400085  
 DATE: 08/2024  
**M-01** SHEET 37 OF 134  
 CAD FILE: CSMLS40A01.DWG


FOR CITY OF PHOENIX USE ONLY - REFERENCE CID NUMBER: #	PROJECT NAME	DATE	CAD FILE NAME	DWG NUMBER	REMARKS
REVISION ENGINEERING COMPANY	PROJECT NO.				

FACILITY DRAWINGS This drawing was supplied by a Consultant Engineer from a pipe construction project. The information provided by the Contractor to provide the Record Drawing. The City does not warranty this drawing to be a complete and accurate portrayal of facilities as they exist in the field.

FOR CONSTRUCTION

"PER CITY OF PHOENIX CODE CHAPTER 2, SECTION 2-28, THESE PLANS ARE FOR OFFICIAL USE ONLY AND MAY NOT BE SHARED WITH OTHERS EXCEPT AS REQUIRED TO FULFILL THE OBLIGATIONS OF THE CONTRACTOR'S CONTRACT WITH THE CITY OF PHOENIX." THIS DOCUMENT MUST BE KEPT SECURE AT ALL TIMES.


THIS DRAWING MUST BE FIELD VERIFIED BEFORE USE. DRAWING NOT TO SCALE UNLESS SCALE BAR IS PRESENT

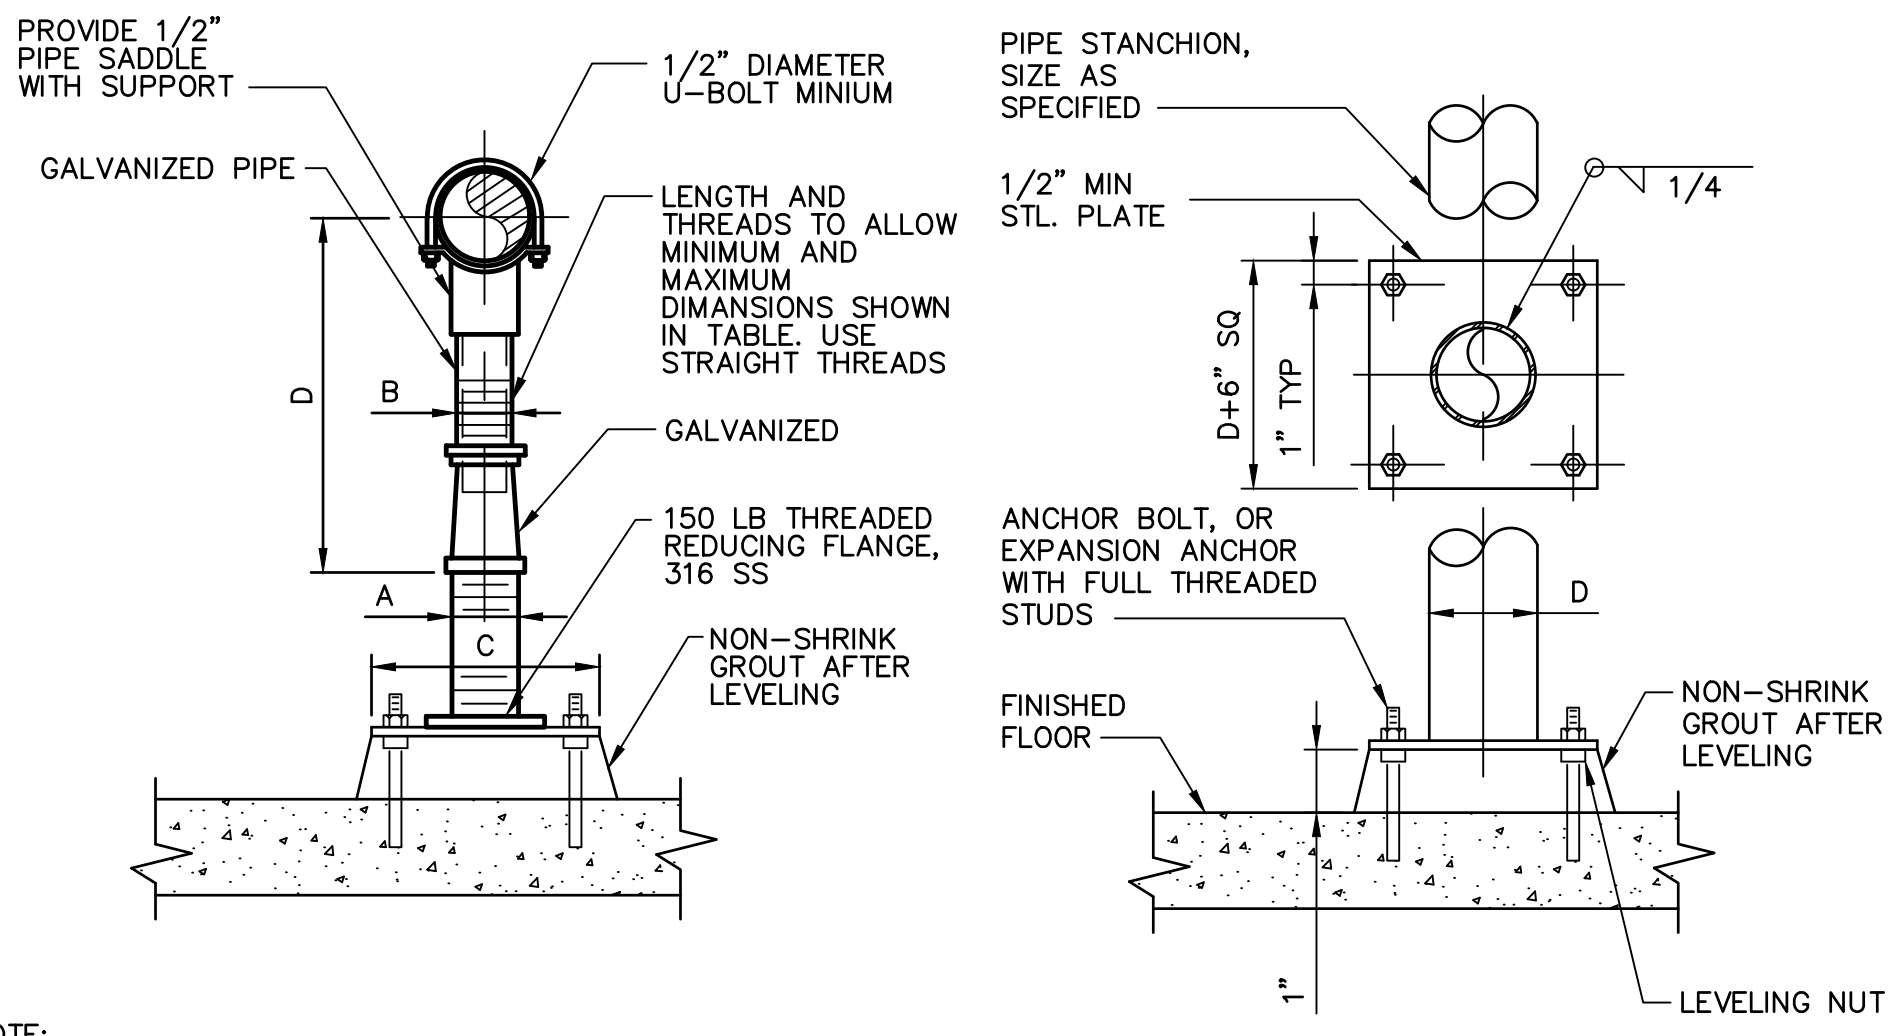

NOTE:  
1. REFER TO ADJUSTABLE PIPE SUPPORT TABLE FOR DIMENSIONS.

ADJUSTABLE PIPE SUPPORT (DIMENSIONS IN INCHES)							
PIPE SIZE	A	B	C	D MINIMUM	D MAXIMUM	ANCHORS (DIA)	ANCHORS (EMBED)
2 1/2	2 1/2	1 1/2	9	8	11 1/2	1/2	5
3	2 1/2	1 1/2	9	8 1/4	11 3/4	1/2	5
3 1/2	2 1/2	1 1/2	9	8 1/2	12	1/2	5
4	3	2 1/2	9	10 1/4	14	1/2	5
6	3	2 1/2	9	11 5/8	15 1/4	1/2	5
8	3	2 1/2	9	13 5/8	16 1/2	1/2	5
10	4	3	11	14 5/8	18 1/4	1/2	5
12	4	3	11	15 5/8	19 3/4	1/2	5
14	4	3	11	18 7/8	20 3/4	5/8	6 5/8
16	4	3	11	19 7/8	22 1/4	5/8	6 5/8
18	6	3 1/2	13 1/2	21 1/4	24	5/8	6 5/8
20	6	3 1/2	13 1/2	23 1/4	25 1/2	5/8	6 5/8
24	6	4	13 1/2	26 1/2	28 1/4	5/8	6 5/8
30	6	4	13 1/2	29 5/8	31 1/2	5/8	6 5/8
32	6	4	13 1/2	30 5/8	32 3/4	5/8	6 5/8
36	6	4	13 1/2	32 5/8	34 3/4	5/8	6 5/8


ADJUSTABLE PIPE SUPPORT  
DETAIL 1  
M-02 M-02  
NOT TO SCALE

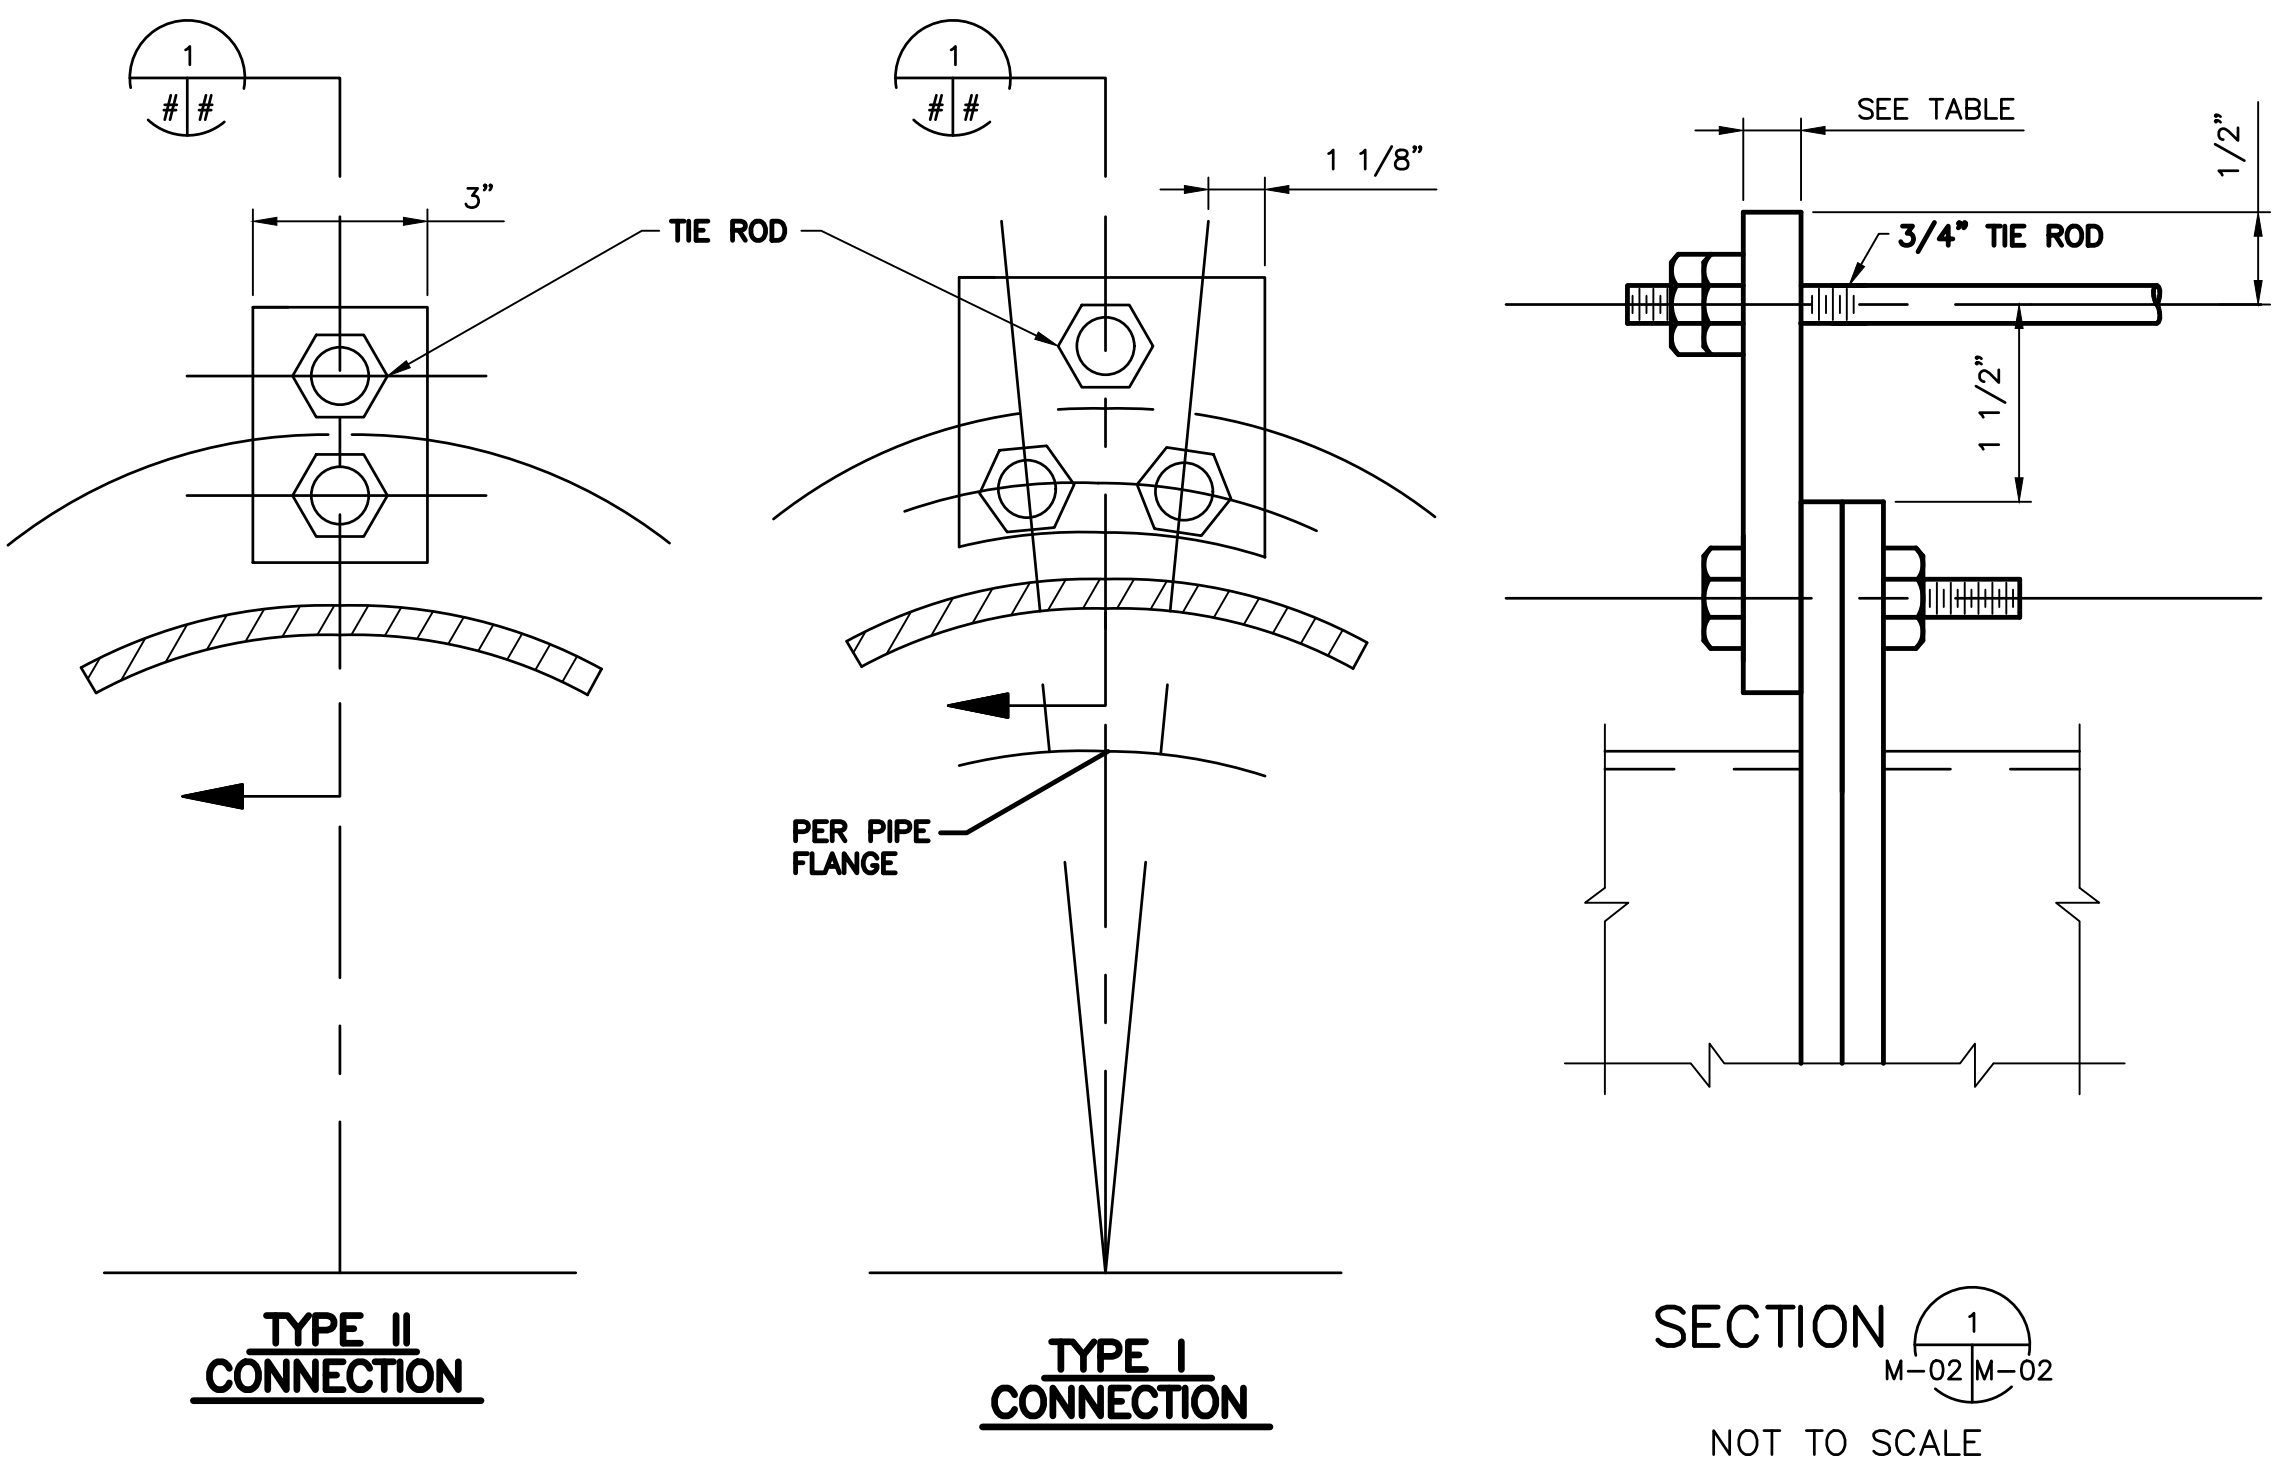

NOTES:

- ALL EXPOSED FLEXIBLE COUPLINGS SHALL HAVE TIE RODS UNLESS SPECIFICALLY INDICATED OTHERWISE ON THE DRAWINGS.
- PIPE THRUST SHALL BE BASED ON TEST PRESSURE.
- PIPE THRUST =  $0.7854 \times D^2 \times$  TEST PRESSURE, WHERE D IS PIPE OD.
- CONTRACTOR MAY USE ONE INCH DIAMETER ROD FOR THRUSTS GREATER THAN 30,000 POUNDS. NUMBER OF 1" RODS = NUMBER OF 3/4" RODS X 0.5625. ROUND UP TO THE NEXT LARGER NUMBER.
- ALL ROD CONNECTIONS SHALL BE TYPE I FOR THRUSTS GREATER THAN 6,000 POUNDS.
- TIE RODS SHALL CONFORM TO ASTM A193, GRADE B7.
- NUTS SHALL CONFORM TO ASTM A194, GRADE 2H.
- LUG PLATE SHALL CONFORM TO ASTM A283, GRADE D OR ASTM A36.
- GRIND ALL CORNERS SMOOTH.

FLEXIBLE COUPLING - TIE DOWN CONNECTION  
DETAIL 3  
M-02 M-02  
NOT TO SCALE

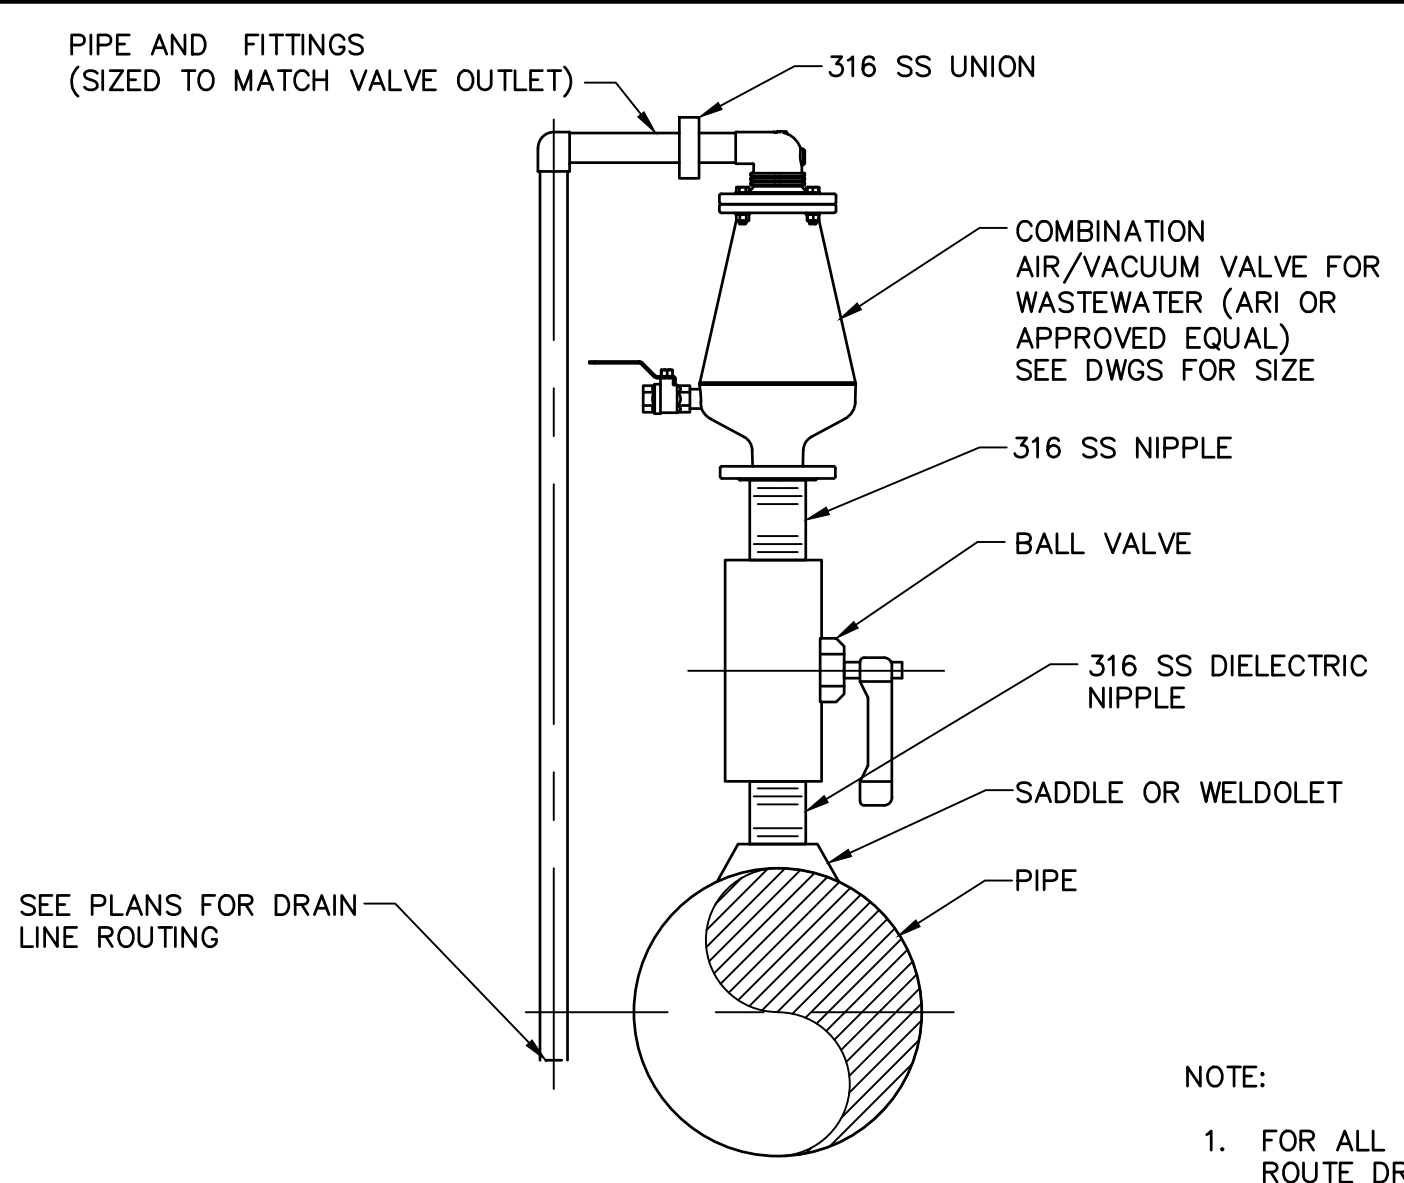


NOTES:

- USE FLANGED PIPES AND GATE VALVE FOR 3" AND LARGER AIR VALVES.
- ALL FITTINGS SHALL BE STAINLESS STEEL.
- PROVIDE SUPPORT FOR THE DRAIN LINES.
- VENT DRAIN PIPE SHALL BE STAINLESS STEEL ABOVE GRADE OR CPVC BELOW GRADE.
- PROVIDE A DIELECTRIC NIPPLE AT THE CONNECTION OF THE STEEL PIPE AND VALVE ASSEMBLY.
- FOR AIR/ARVS 2" AND SMALLER, DIELECTRIC COUPLINGS, STAINLESS STEEL NIPPLES, AND BALL VALVE SHALL BE THREADED

NOTE:  
1. FOR ALL THE ARVS ON DISCHARGE LINE, ROUTE DRAIN LINES TO WET WELL. FOR ARVS ON FORCE MAINS, ROUTE DRAIN LINE TO THE NEAREST MANHOLE.

COMBINATION AIR AND VACUUM RELEASE VALVE  
DETAIL 2  
M-02 M-02  
NOT TO SCALE

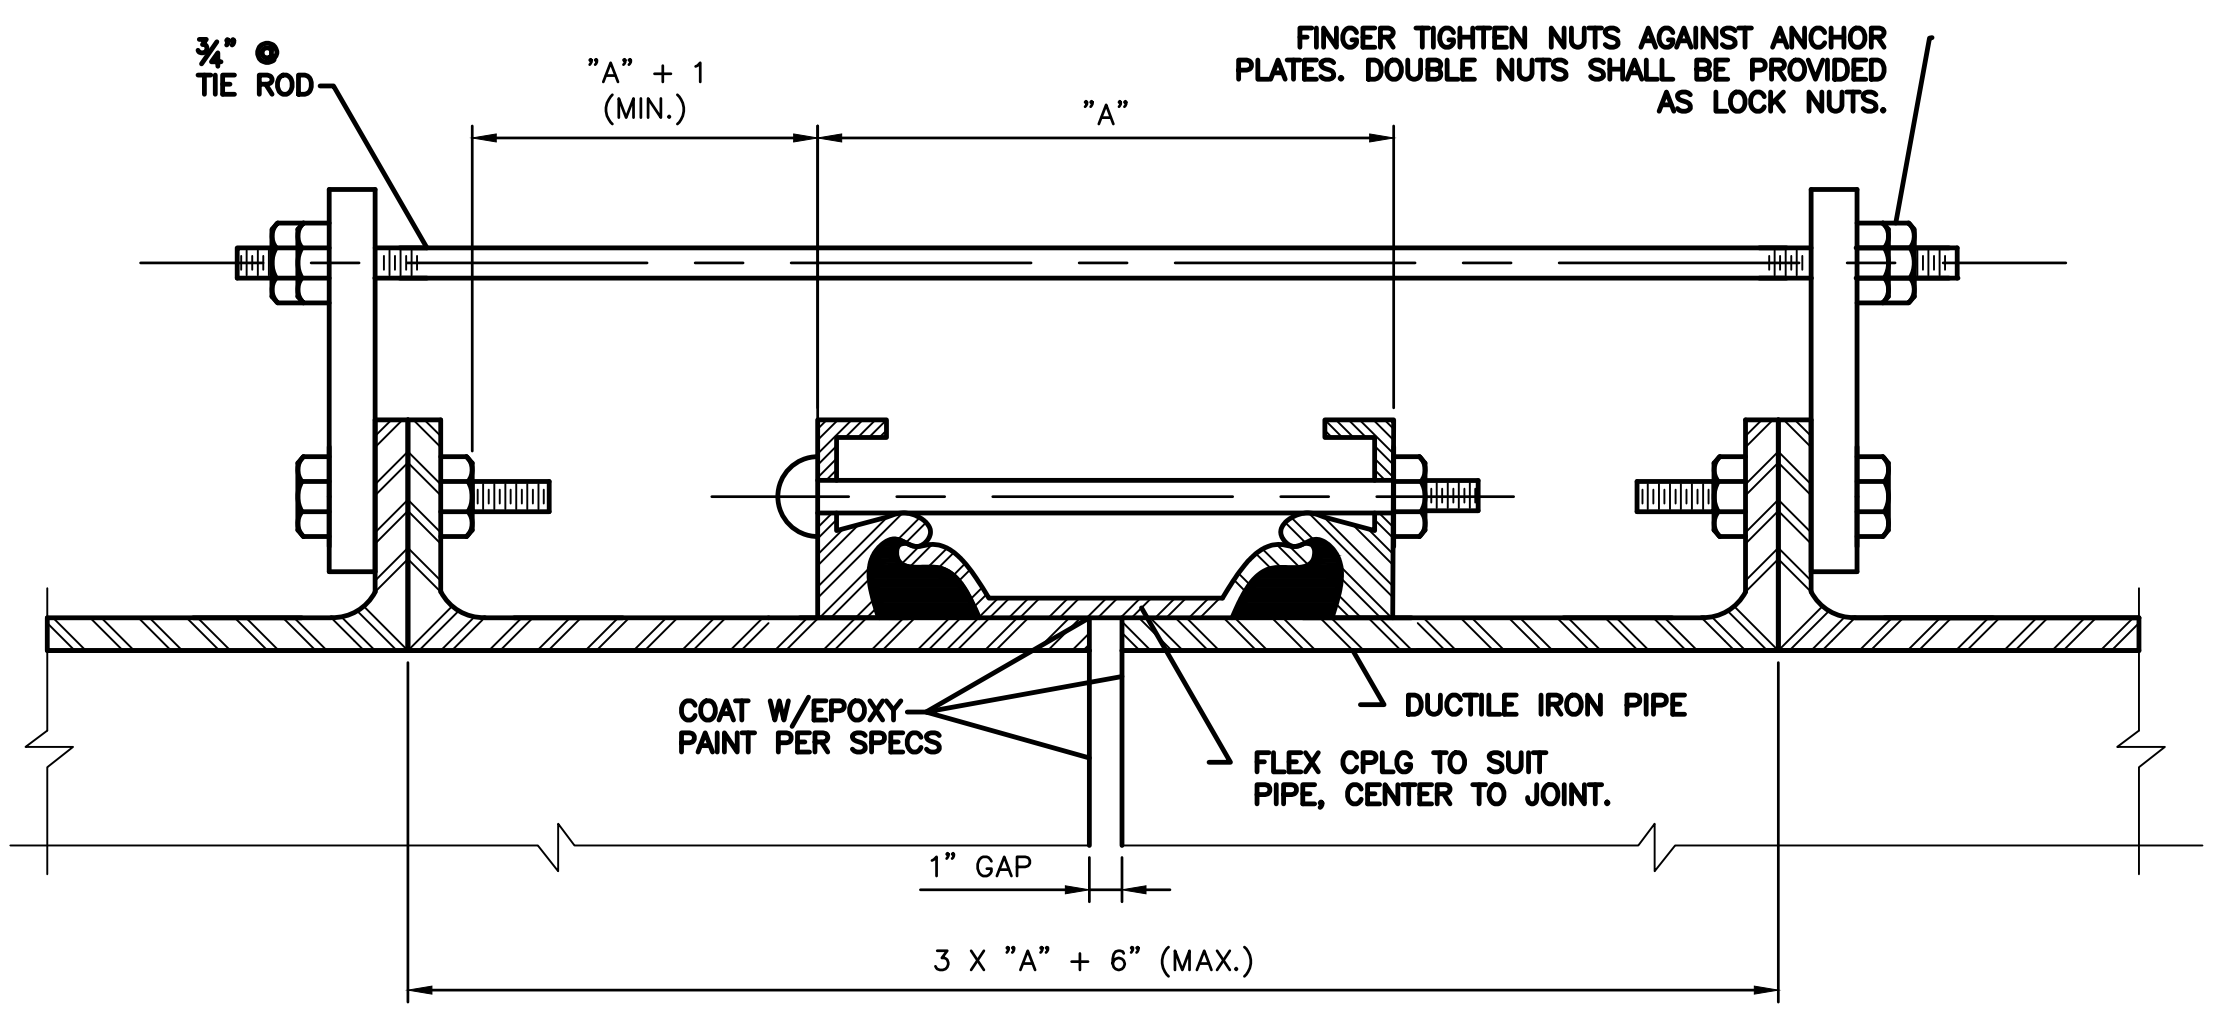


ROD SCHEDULE FOR DIP		
PIPE THRUST *	TYPE OF CONNECTION *	NO. OF 3/4" TIE RODS
0-6,000#	II	2
6,000 - 12,000#	I	2
12,001 - 18,000#	I	3
18,001 - 24,000#	I	4
24,001 - 30,000#	I	5


TYPICAL HARNESSED FLEXIBLE RESTRAINED COUPLING FOR DIP PIPE  
DETAIL 4  
M-02 M-02  
NOT TO SCALE

FACILITY DRAWINGS  
This drawing was supplied by a Consultant Engineer from a permit construction project. The Consultant Engineer is not responsible for the construction information provided by the Contractor to provide the Record Drawing. The City does not warrant this drawing to be a complete and accurate portrayal of facilities as they exist in the field.

REVISION	DATE	BY	DESCRIPTION

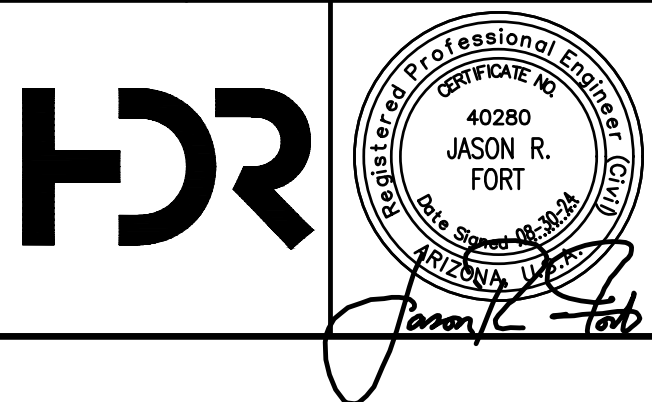

REVISIONS				
NO.	BY	DATE	CKD	REMARKS
A	RS	10/2023	JF	30% SUBMITTAL
B	RS	01/2024	JF	90% SUBMITTAL
C	RS	04/2024	JF	AGENCY REVIEW
D	DFD	08/2024	JF	ISSUED FOR CONSTRUCTION
*				
*				
*				

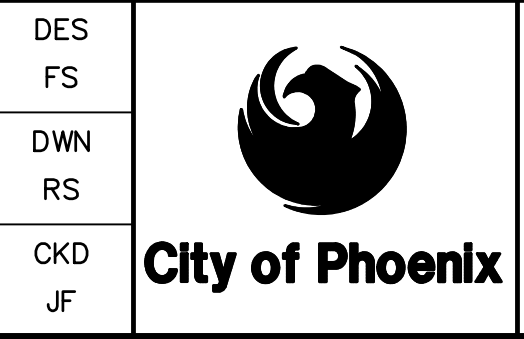

CITY OF PHOENIX  
WATER SERVICES DEPARTMENT

LIFT STATION 40  
REFURBISHMENT

MECHANICAL

GENERAL DETAILS 1

COPYRIGHT © 2007-JANUARY

CITY PROJECT NO. WS90400085

DATE: 08/2024


M-02 SHEET 38 OF 134

CAD FILE: CSMLS40D01.DWG

FOR CONSTRUCTION

THIS DRAWING MUST BE FIELD VERIFIED BEFORE USE. DRAWING NOT TO SCALE UNLESS SCALE BAR IS PRESENT

"PER CITY OF PHOENIX CODE CHAPTER 2, SECTION 2-28, THESE PLANS ARE FOR OFFICIAL USE ONLY AND MAY NOT BE SHARED WITH OTHERS EXCEPT AS REQUIRED TO FULFILL THE OBLIGATIONS OF THE CONTRACTOR'S CONTRACT WITH THE CITY OF PHOENIX." THIS DOCUMENT MUST BE KEPT SECURE AT ALL TIMES.

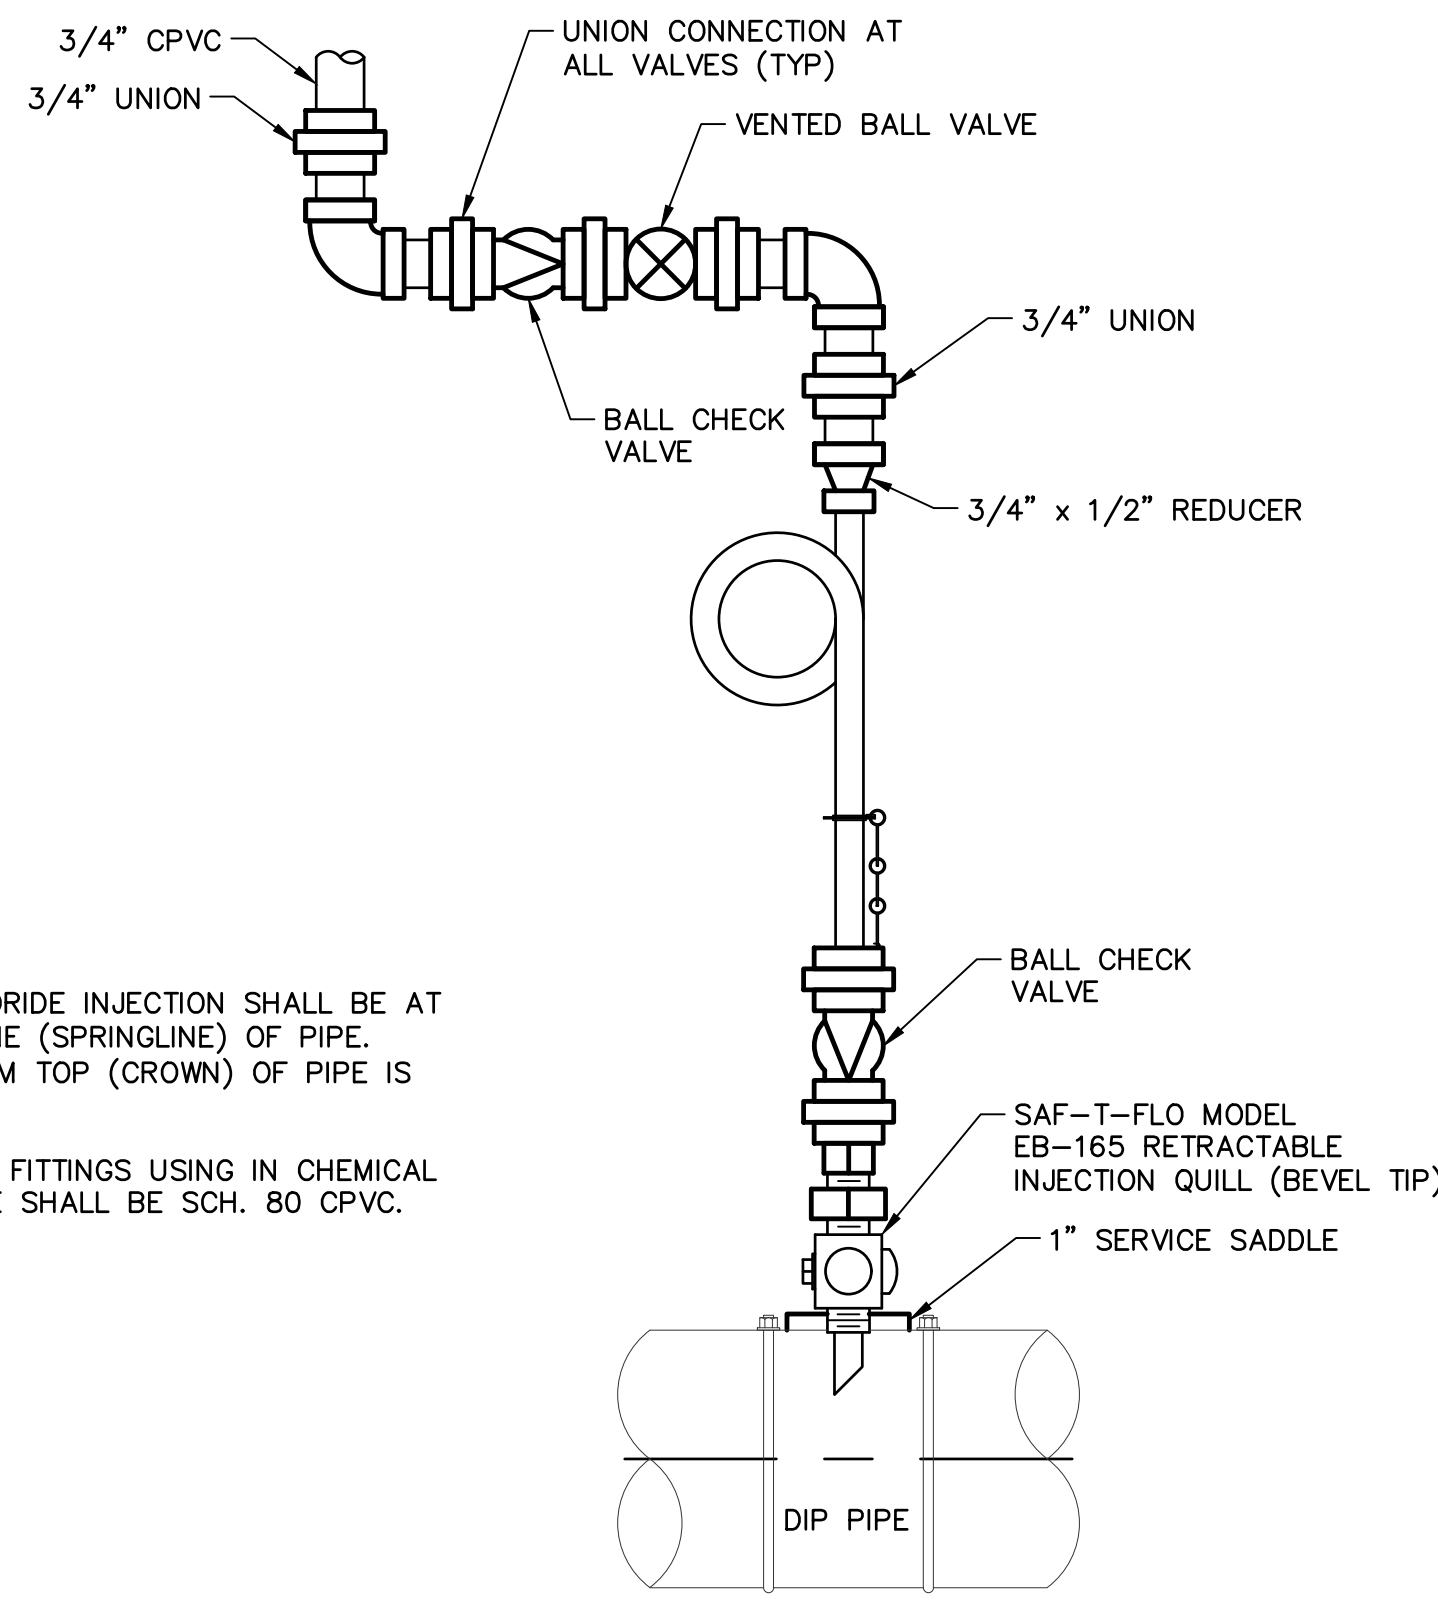


PLAN VIEW

**NOTE:**


1. FERROUS CHLORIDE INJECTION SHALL BE AT THE CENTERLINE (SPRINGLINE) OF PIPE. INJECTION FROM TOP (CROWN) OF PIPE IS NOT ALLOWED.
2. ALL PIPE AND FITTINGS USING IN CHEMICAL INJECTION PIPE SHALL BE SCH. 80 CPVC.

**FERROUS CHLORIDE INJECTION SCHEMATIC DETAIL**

DETAIL 5  
M-03 M-03  
NOT TO SCALE

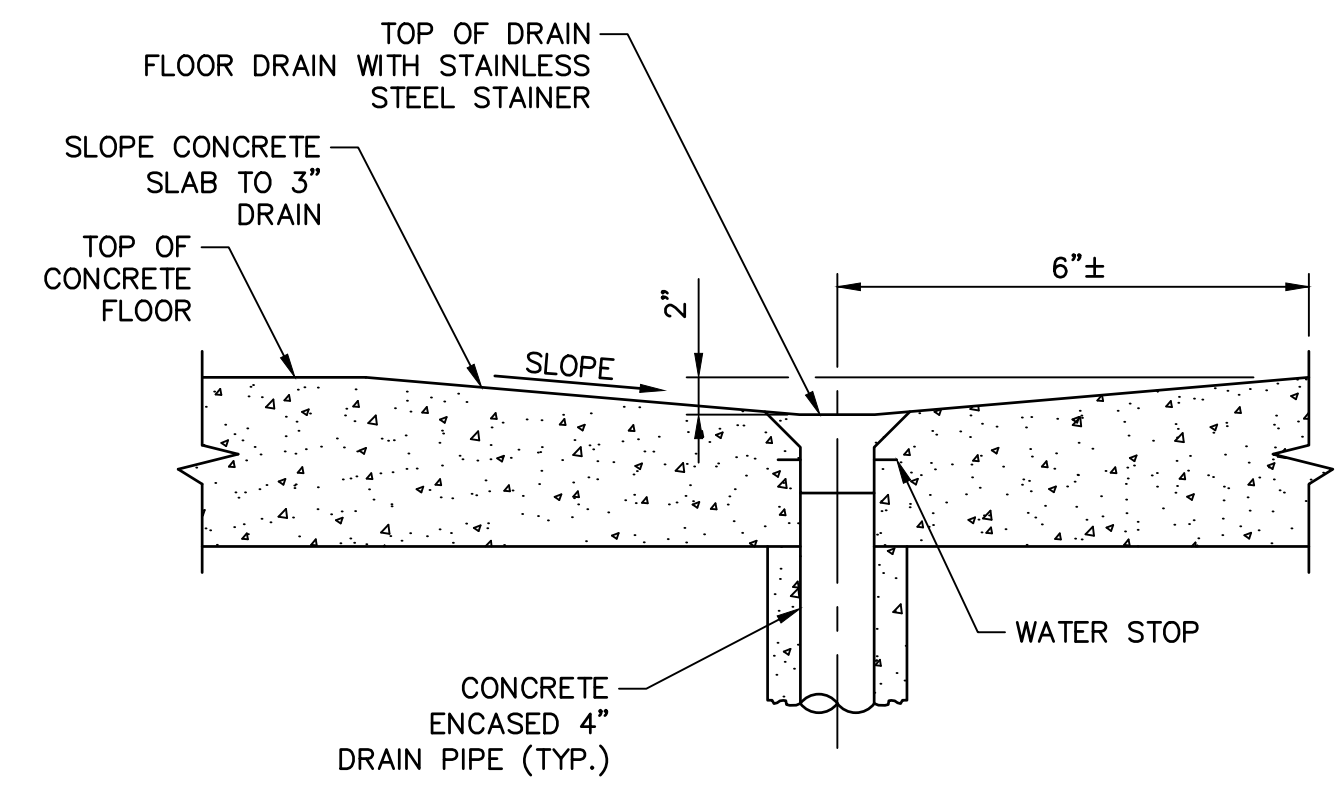


FLOOR DRAIN  
DETAIL 7  
M-03 M-03  
NOT TO SCALE

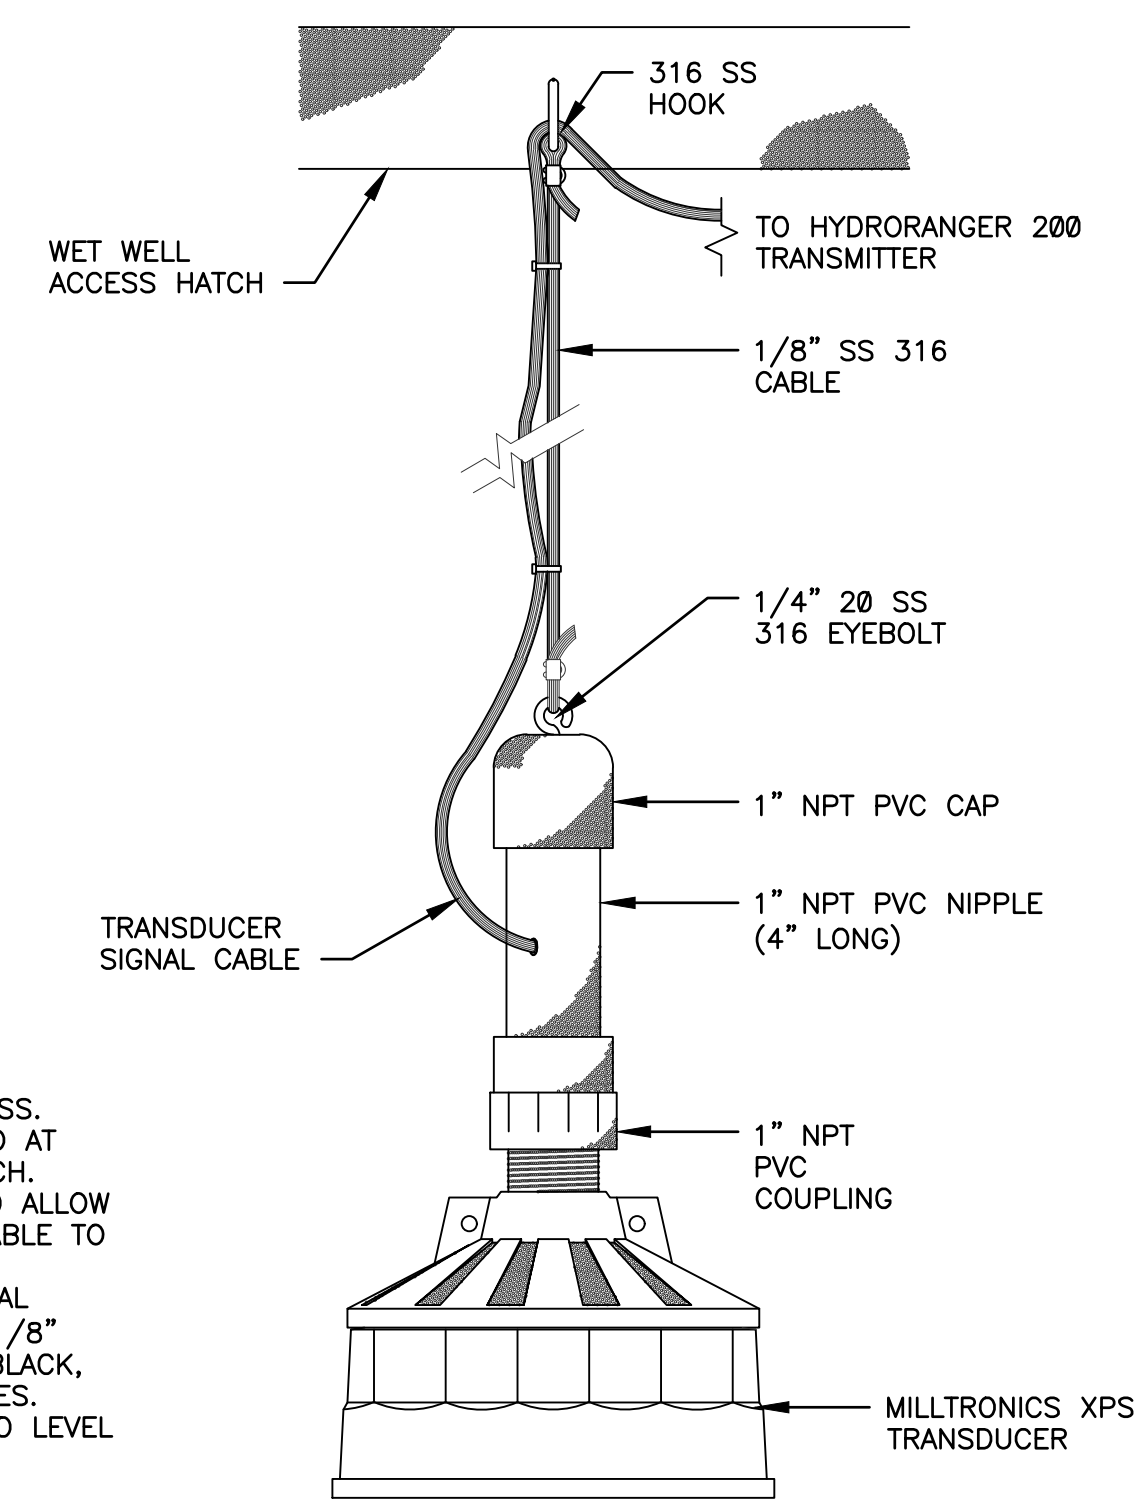

**NOTES:**

1. CABLE AND MOUNTING HARDWARE TO BE 316 SS.
2. 316 SS HOOK MOUNTED AT WET WELL ACCESS HATCH.
3. PVC NIPPLE DRILLED TO ALLOW TRANSDUCER SIGNAL CABLE TO PASS THROUGH.
4. BIND TRANSDUCER SIGNAL CABLE TO LENGTH OF 1/8" 316 SS CABLE USING BLACK, UV RESISTANT CABLE TIES.
5. DETAIL TYPICAL FOR TWO LEVEL TRANSDUCERS.

LEVEL ELEMENT INSTALLATION  
DETAIL 8  
M-03 M-03  
NOT TO SCALE

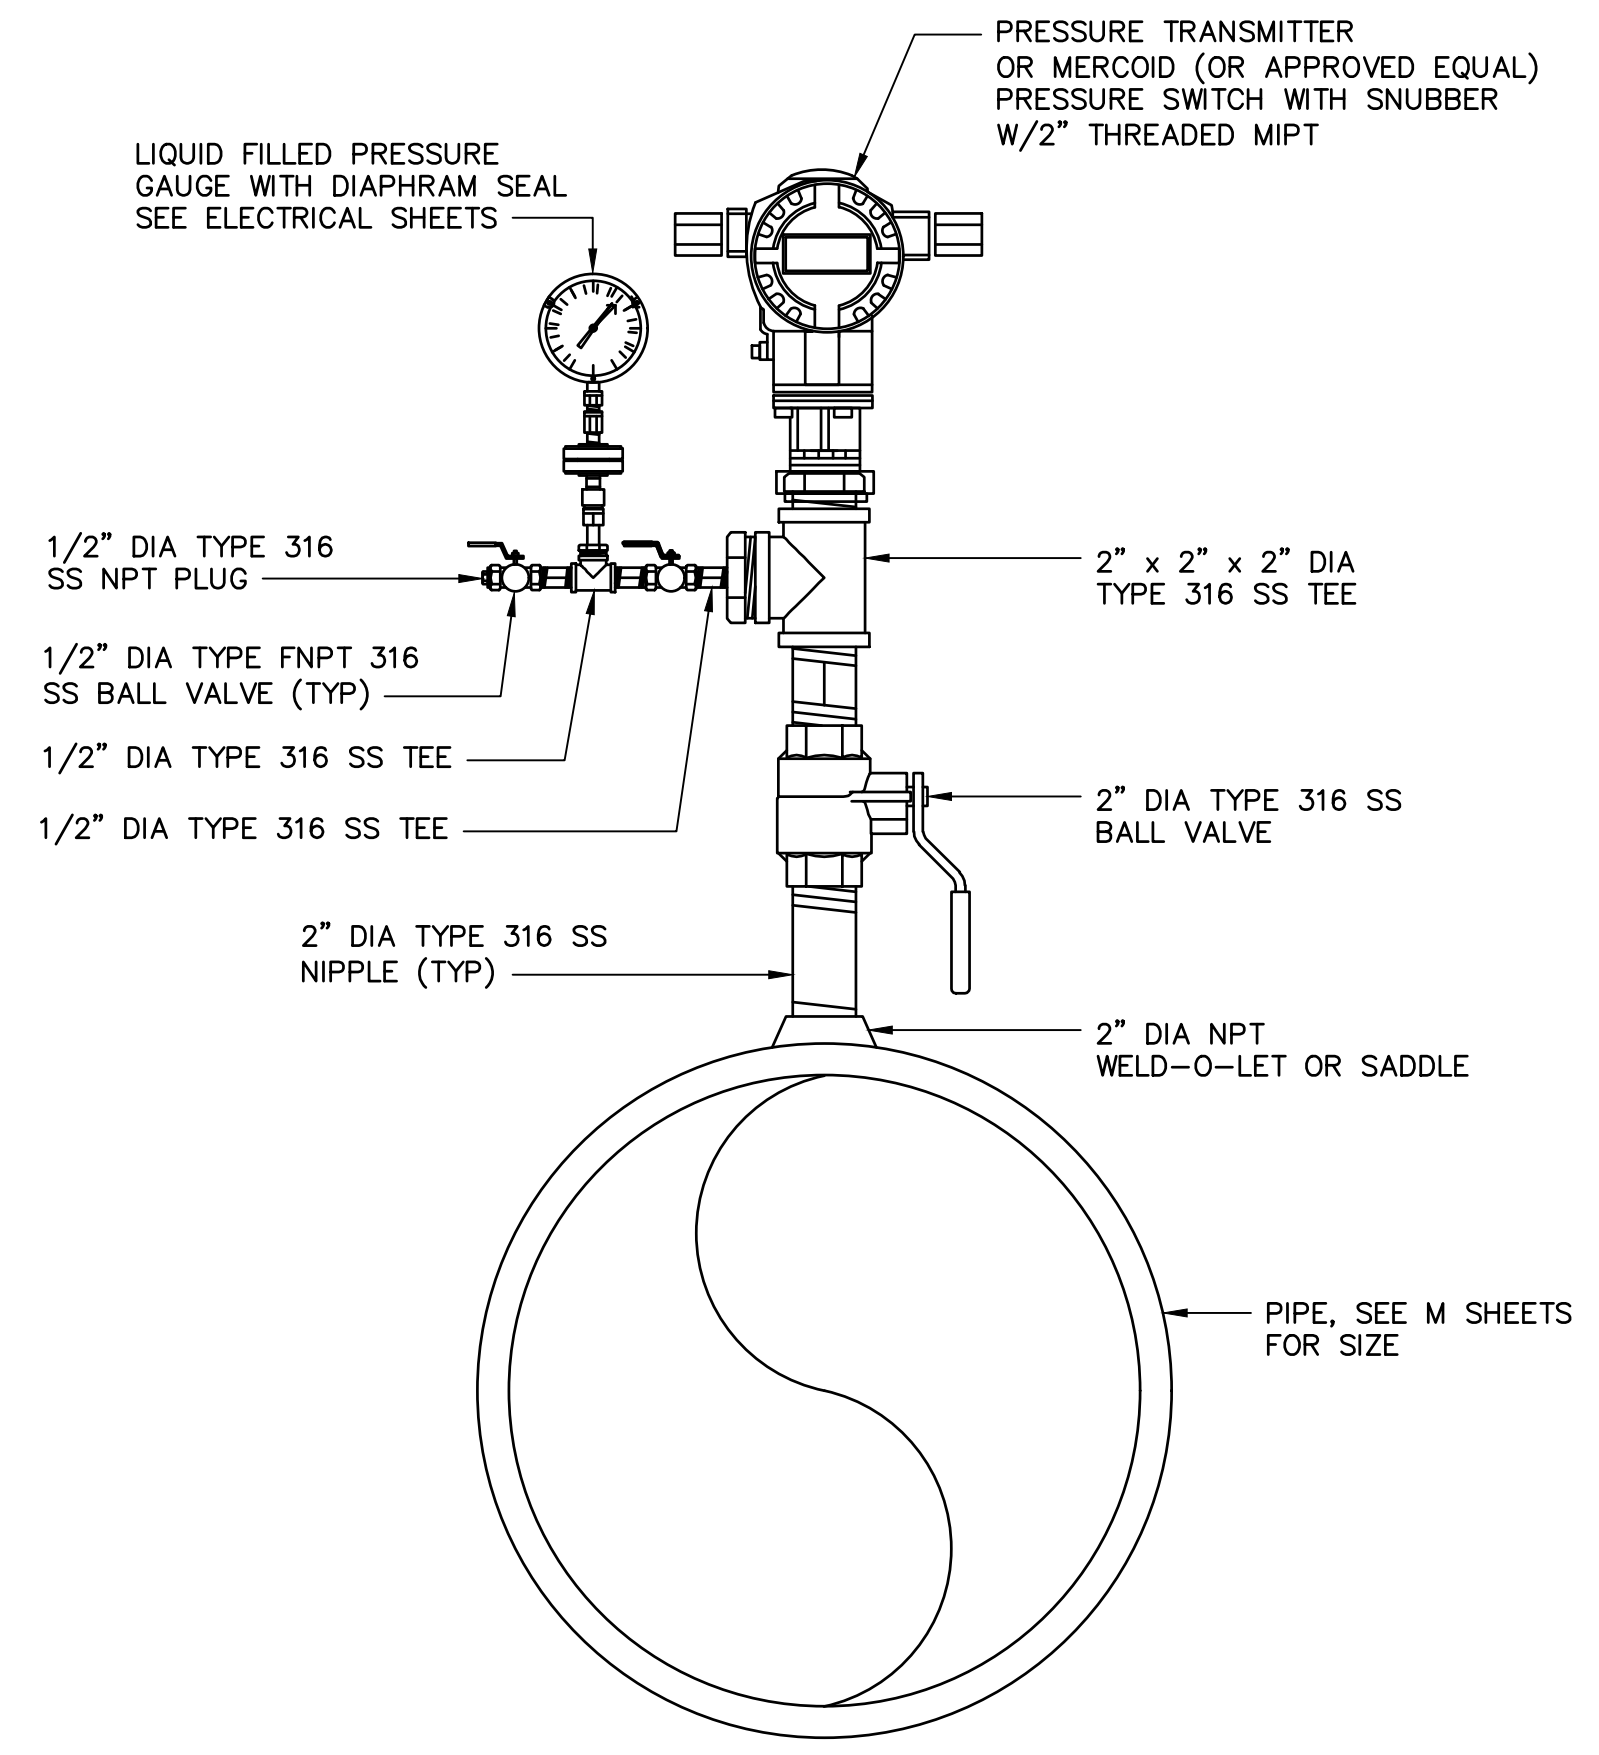

**NOTES:**


1. VALVE SIZE SHALL BE AS INDICATED ON THE PLANS.
2. NPT SIZE SHALL MATCH VALVE INLET SIZE, SEE PLANS.
3. NIPPLE(S), FITTINGS AND VALVES SHALL BE TYPE 316 SS.
4. ISOLATE DISSIMILAR METALS.

**PRESSURE GAUGE & TRANSMITTER DETAIL**


DETAIL 6  
M-03 M-03  
NOT TO SCALE

FACILITY DRAWINGS  
This drawing was supplied by a Consultant Engineer from a past construction project. The Consultant Engineer is not responsible for the construction information provided by the Contractor to provide the Record Drawing. The City does not warrant this drawing to be a complete and accurate portrayal of facilities as they exist in the field.

REVISION	DATE	CAD FILE NAME	DWG NUMBER	REMARKS

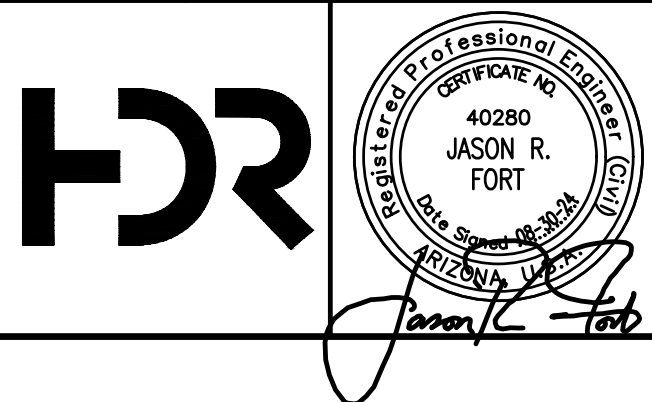

REVISIONS				
NO.	BY	DATE	CKD	REMARKS
A	RS	10/2023	JF	30% SUBMITTAL
B	RS	01/2024	JF	90% SUBMITTAL
C	RS	04/2024	JF	AGENCY REVIEW
D	FDF	08/2024	JF	ISSUED FOR CONSTRUCTION

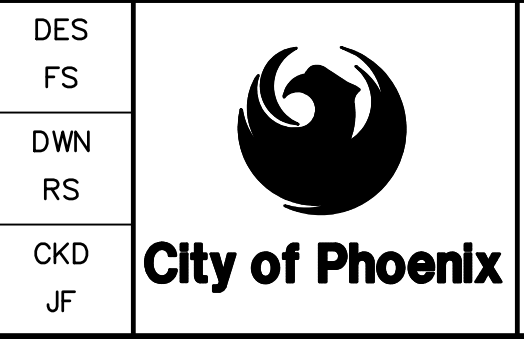

CITY OF PHOENIX  
WATER SERVICES DEPARTMENT  
  
LIFT STATION 40  
REFURBISHMENT

MECHANICAL  
  
GENERAL DETAILS 2

COPYRIGHT © 2007-JANUARY  
CITY PROJECT NO. WS90400085  
DATE: 08/2024  
M-03 SHEET 39 OF 134  
CAD FILE: DSM4AB9D02.DWG

USER: FBERASFRALD0 FILE: C:\pwworking\west01\03411829\39\_CSM\540002.dwg DATE: 9/04/24 TIME: 03:23pm


FOR CONSTRUCTION

"PER CITY OF PHOENIX CODE CHAPTER 2, SECTION 2-28, THESE PLANS ARE FOR OFFICIAL USE ONLY AND MAY NOT BE SHARED WITH OTHERS EXCEPT AS REQUIRED TO FULFILL THE OBLIGATIONS OF THE CONTRACTOR'S CONTRACT WITH THE CITY OF PHOENIX." THIS DOCUMENT MUST BE KEPT SECURE AT ALL TIMES.


THIS DRAWING MUST BE FIELD VERIFIED BEFORE USE. DRAWING NOT TO SCALE UNLESS SCALE BAR IS PRESENT

**KEY NOTES**

- 1 EYEWASH/SHOWER STATION: HAWS #B300-8309 THE EYE/FACE WASH HEAD ASSEMBLY (SP65SS)
- 2 SS SHOWER HEAD: HAWS #SP829SS
- 3 FOOT CONTROL ASSEMBLY: #SP220
- 4 1 1/2" BACK FLOW PREVENTER PER COP STD. DTL. PE-352-1
- 5 1 1/2" BALL VALVE
- 6 SCALD PROTECTION BLEED VALVE: HAWS #SP157A
- 7 FLOW SWITCH: HAWS #SP154DPDT, SEE FOR DETAILS.
- 8 PROVIDE INSULATION PER SPEC.

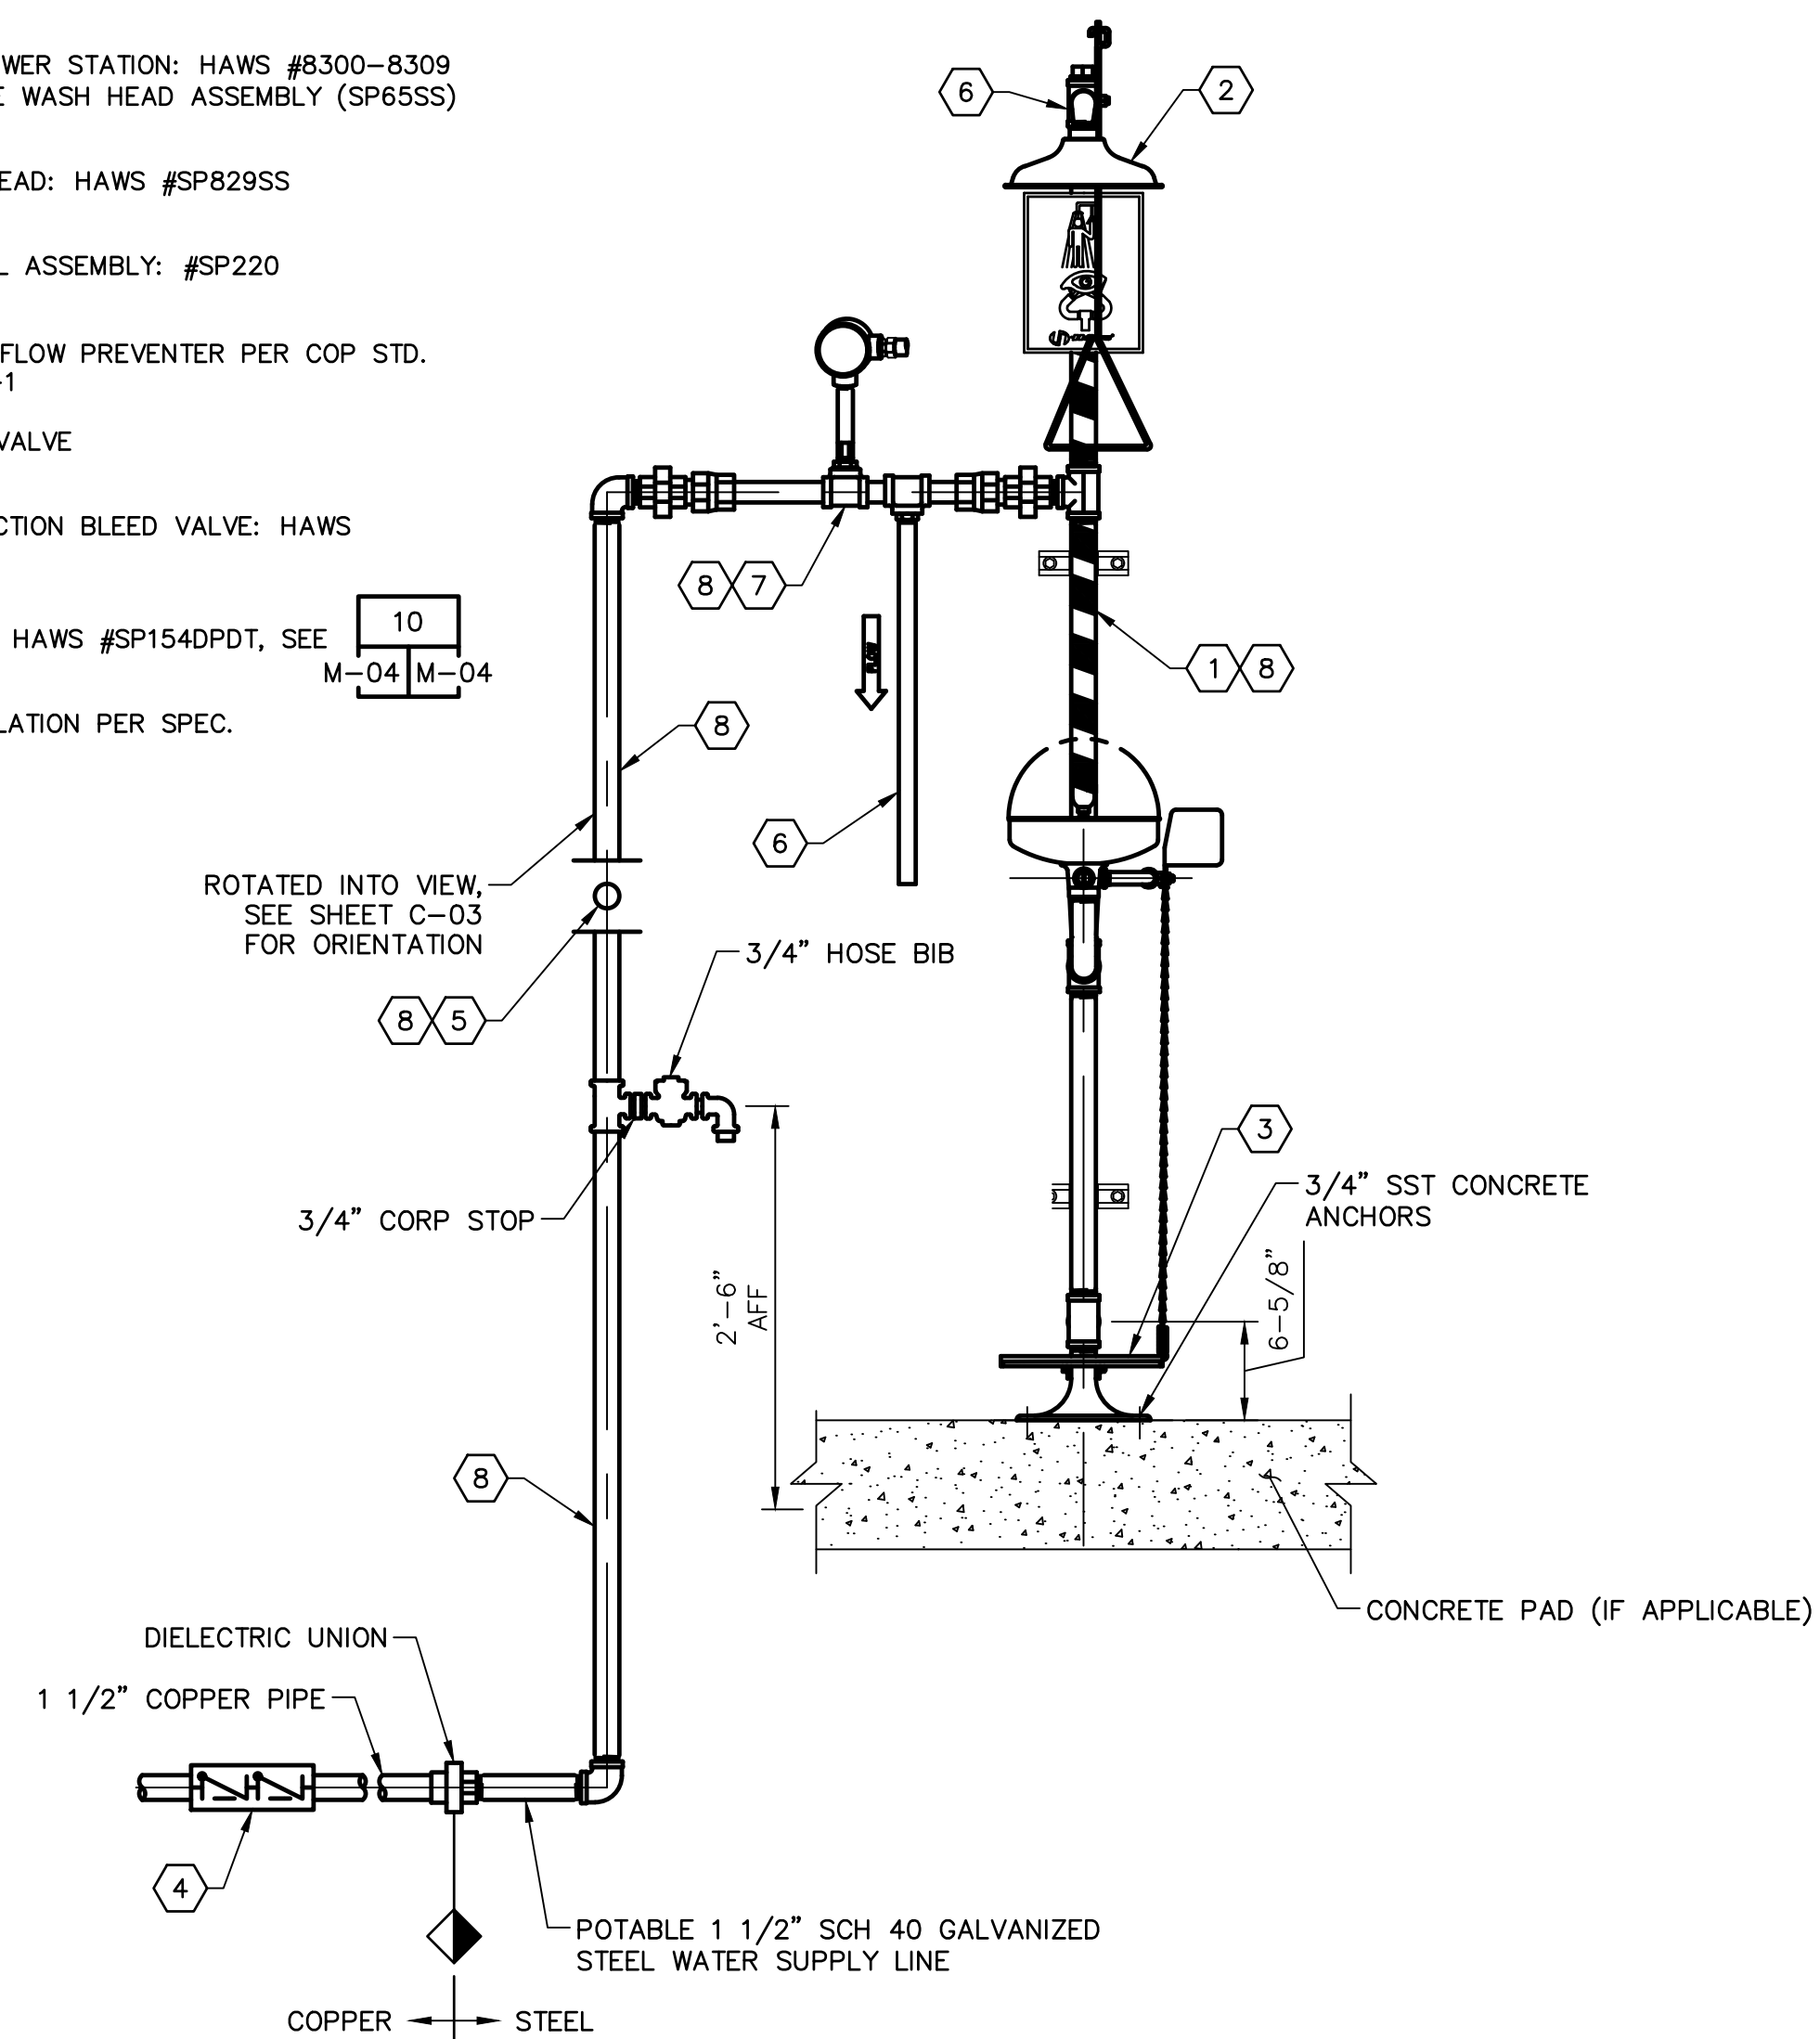


**EYEWASH/SHOWER  
DETAIL 9**  
M-04 M-04  
NOT TO SCALE

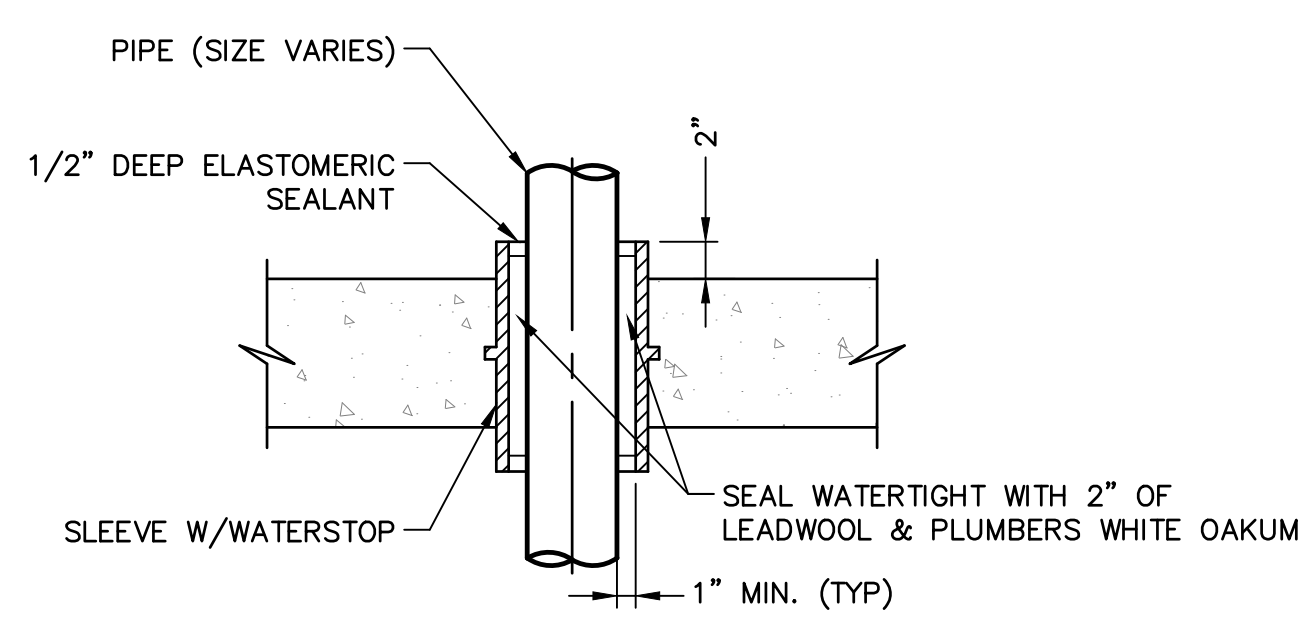


- NOTES:**
- SLEEVES SHALL BE CAST INTO WALL. KNOCKOUTS AND SUBSEQUENT GROUTING IN SLEEVES WILL NOT BE PERMITTED UNLESS A KEYPED WATERSTOP JOINT IS PROVIDED.
  - 6" Ø SLEEVES AND SMALLER SHALL BE SCH 40 STL PIPE.
  - SLEEVES LARGER THAN 6" Ø SHALL BE 1/4" THICK STEEL PIPE.
  - LINK SEAL SHALL BE INSTALLED AT BOTH ENDS OF WALL SLEEVE. SLEEVE SHALL BE PER LINK SEAL MANUFACTURER'S RECOMMENDATION.
  - SLEEVE SHALL BE HOT-DIP GALVANIZED AFTER FABRICATION.
  - PROVIDE 6" STUBOUT MIN WITH CAP ON BOTH SIDES OF WALL FOR ALL FUTURE PIPING.
  - PIPE SHALL BE FULLY SUPPORTED PRIOR TO MODULAR SEAL INSTALLATION AND FINAL TIGHTENING.

**SLEEVE INSTALLATION THROUGH FLOOR SLABS  
DETAIL 11**  
M-04 M-04  
NOT TO SCALE

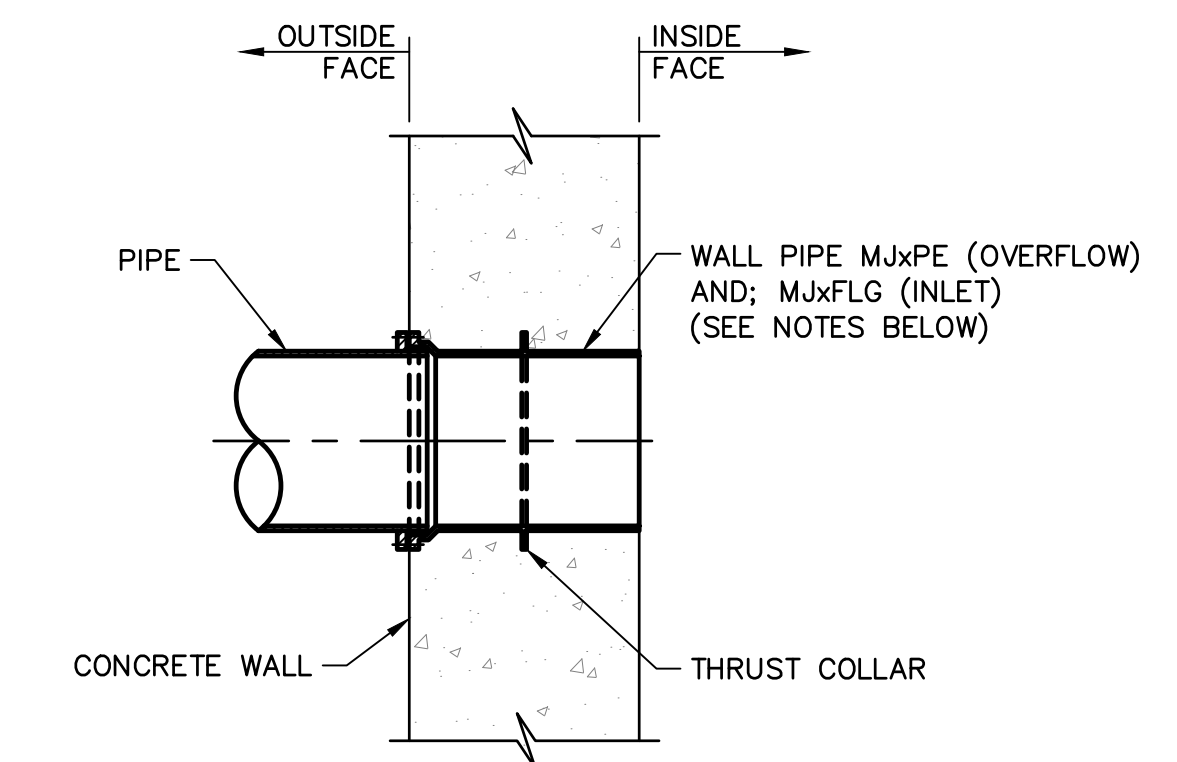


- NOTES:**
- WALL PIPE CAN BE MJxFLG, FLGxFLG, MJxPE (SHOWN ABOVE).
  - WALL PIPE IS TO SET FLUSH WITH WALL UNLESS OTHERWISE NOTED.
  - FLANGES AND MJ SHOULD BE DRILLED AND TAPPED FOR STUDS.
  - WALL PIPE SHALL BE THRUST COLLAR WALL PIPE FABRICATED FROM CENTRIFUGALLY CAST DUCTILE IRON AS MANUFACTURED BY AMERICAN DUCTILE IRON PIPE COMPANY, OR EQUAL.
  - FOR STRUCTURAL REINFORCEMENT AROUND PIPING SEE STRUCTURAL SHEETS.
  - MAKE ALL PIPING RESTRAINED JOINTS.

**PIPE PENETRATION THROUGH WALL OR ROOF  
DETAIL 12**  
M-04 M-04  
NOT TO SCALE

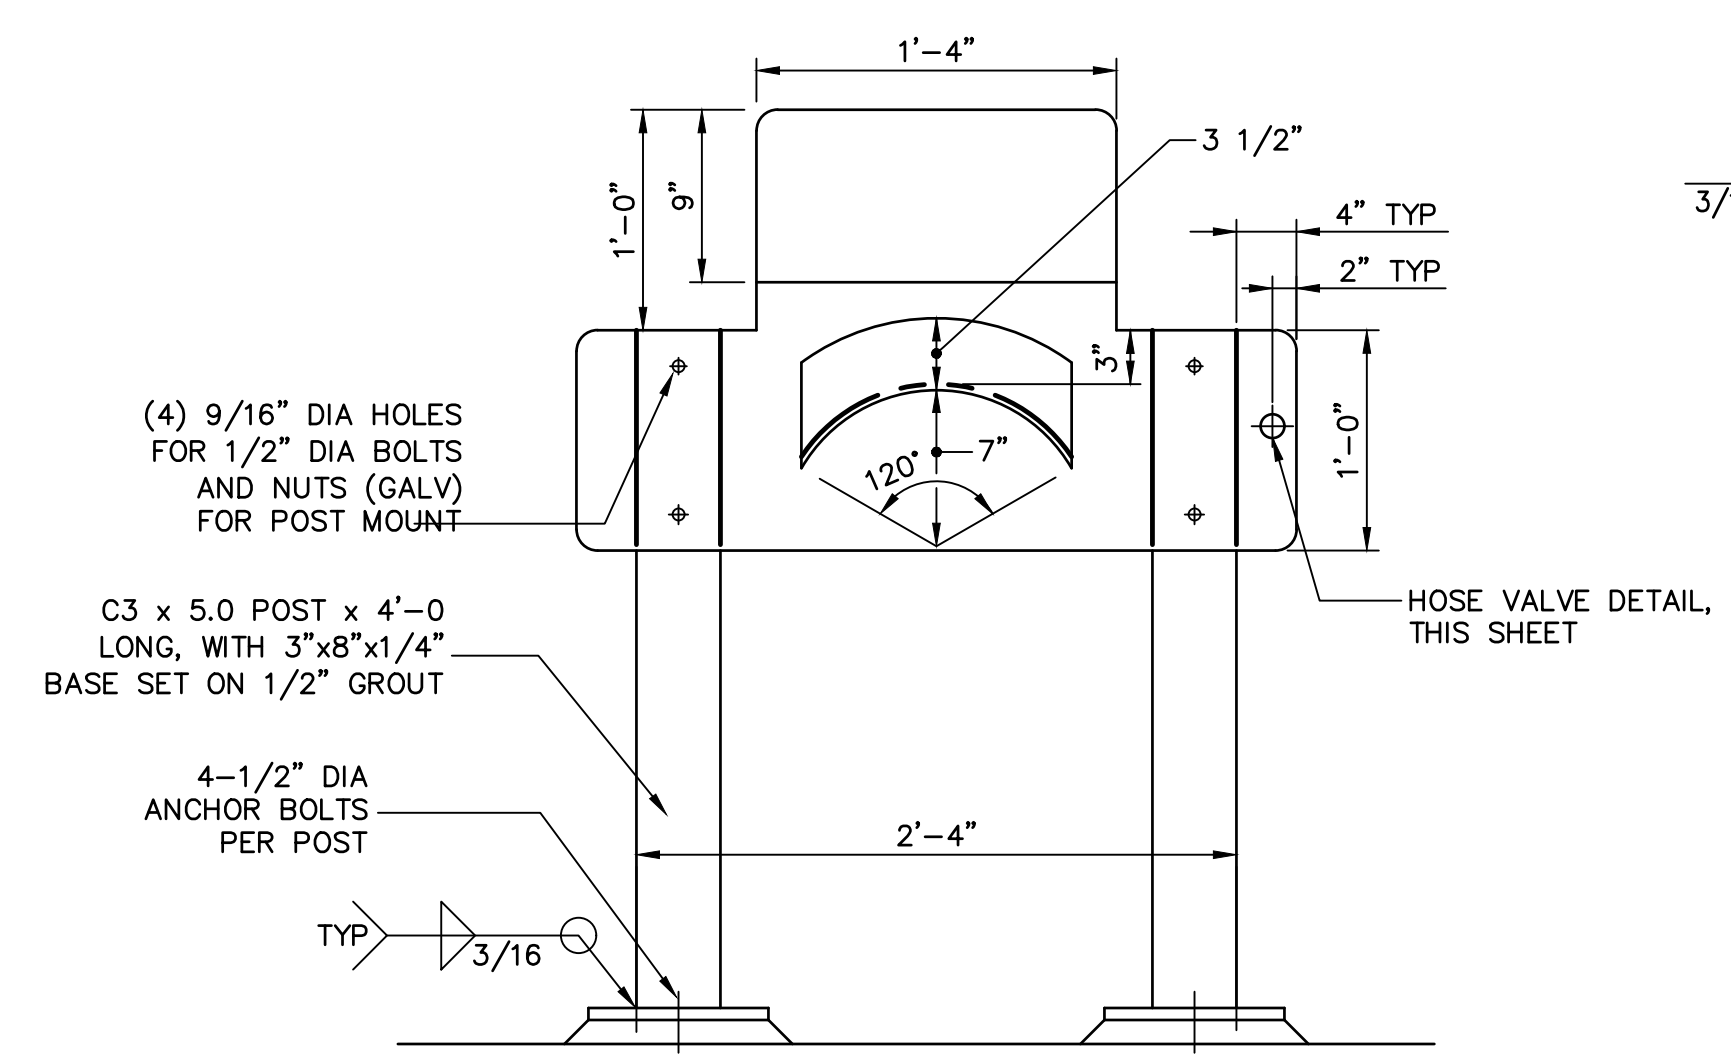


- NOTES:**
- HOSE RACK AND MOUNTING SHALL BE WELDED CONSTRUCTION. MATERIAL MIN 3/16" STEEL PLATE HOT DIP GALVANIZED AFTER FABRICATION. ALL BOLTS AND NUTS SHALL BE GALVANIZED.
  - ROUND ALL CORNERS (3/4" RADIUS).

**POST MOUNTED UTILITY STATION AND HOSE VALVE  
DETAIL 13**  
M-04 M-04  
NOT TO SCALE

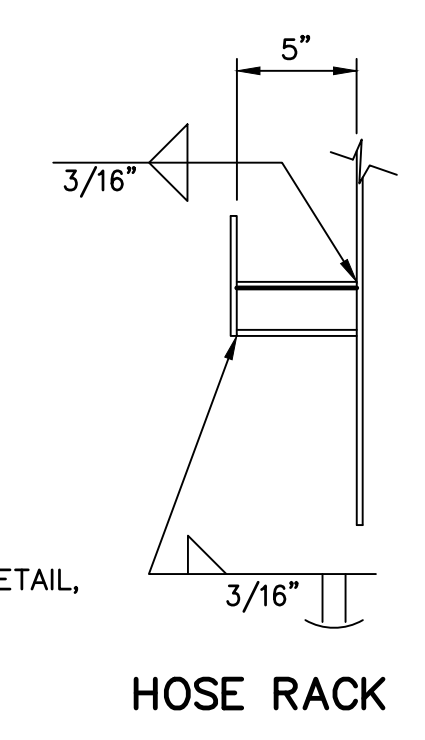


**HOSE RACK**

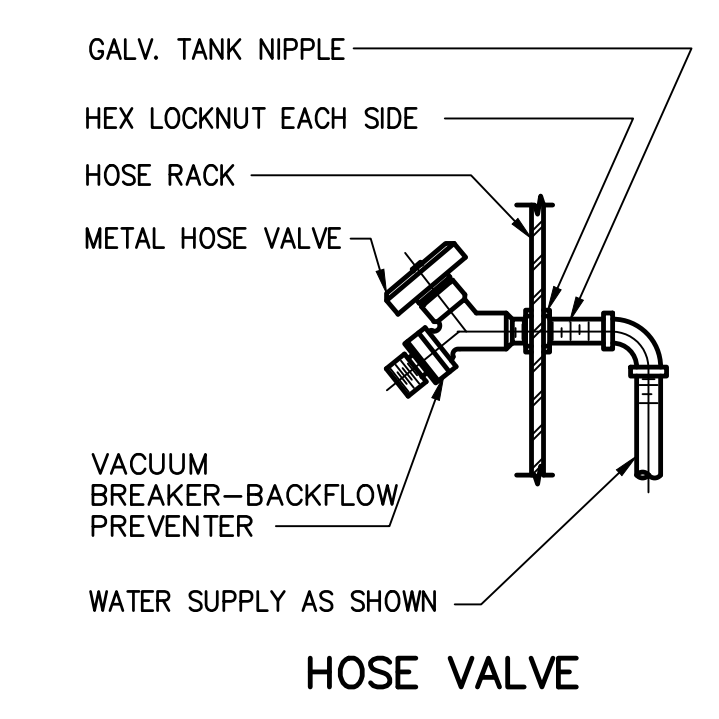


**HOSE VALVE**

- NOTES:**
- ALL HOSE VALVES TO BE CONTROLLED BY INDIVIDUAL SHUT-OFF VALVES (BALL VALVES), EXCEPT WHERE INDIVIDUALLY CONTROLLED BRANCH MAIN SERVES HOSE VALVES ONLY.
  - FOR LOCATION SEE DRAWINGS.
  - LOCATE HOSE BIBS 3'-6" ABOVE FINISHED FLOOR OR GRADE.

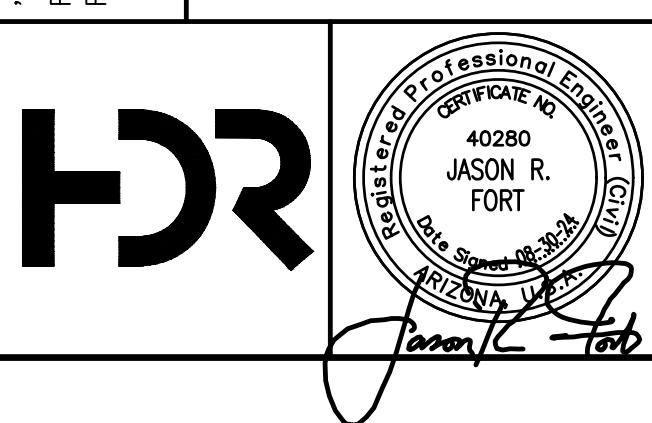

NO.	BY	DATE	CKD	REVISIONS	REMARKS
A	RS	10/2023	JF	30% SUBMITTAL	
B	RS	01/2024	JF	90% SUBMITTAL	
C	RS	04/2024	JF	AGENCY REVIEW	
D	DFD	08/2024	JF	ISSUED FOR CONSTRUCTION	
*					
*					
*					

DES	FS
DWN	RS
CKD	JF

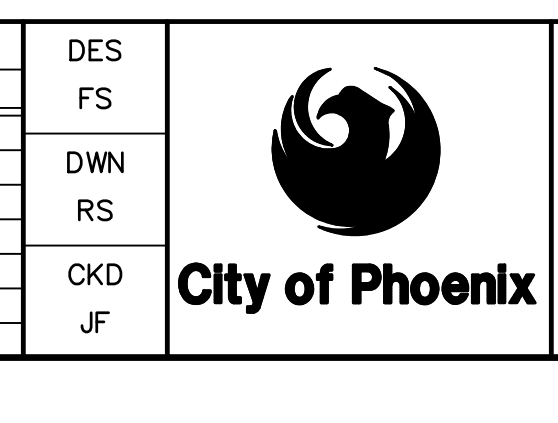

CITY OF PHOENIX  
WATER SERVICES DEPARTMENT  
  
LIFT STATION 40  
REFURBISHMENT

MECHANICAL  
  
GENERAL DETAILS 3

COPYRIGHT © 2007-JANUARY  
CITY PROJECT NO. WS90400085  
DATE: 08/2024  
M-04 SHEET 40 OF 134  
CAD FILE: CSMLS40D03.DWG

FACILITY DRAWINGS  
This drawing was supplied by a Consultant Engineer from a permit construction project. The Consultant Engineer is not responsible for the construction information provided by the Contractor to provide the Record Drawing. The City does not warrant this drawing to be a complete and accurate portrayal of facilities as they exist in the field.

FOR CITY OF PHOENIX USE ONLY - REFERENCE CID NUMBER: #	DATE	CAD FILE NAME	DWG NUMBER	REMARKS
REVISION ENGINEERING COMPANY				
PROJECT NO.				
PROJECT NAME				


USER: FBERASFRALD0 FILE: C:\pwworking\west01\03411629\40\_CSMLS40D03.dwg DATE: 9/04/24 TIME: 03:23pm



THIS DRAWING MUST BE FIELD VERIFIED BEFORE USE. DRAWING NOT TO SCALE UNLESS SCALE BAR IS PRESENT.

FOR CONSTRUCTION


"PER CITY OF PHOENIX CODE CHAPTER 2, SECTION 2-28, THESE PLANS ARE FOR OFFICIAL USE ONLY AND MAY NOT BE SHARED WITH OTHERS EXCEPT AS REQUIRED TO FULFILL THE OBLIGATIONS OF THE CONTRACTOR'S CONTRACT WITH THE CITY OF PHOENIX." THIS DOCUMENT MUST BE KEPT SECURE AT ALL TIMES.

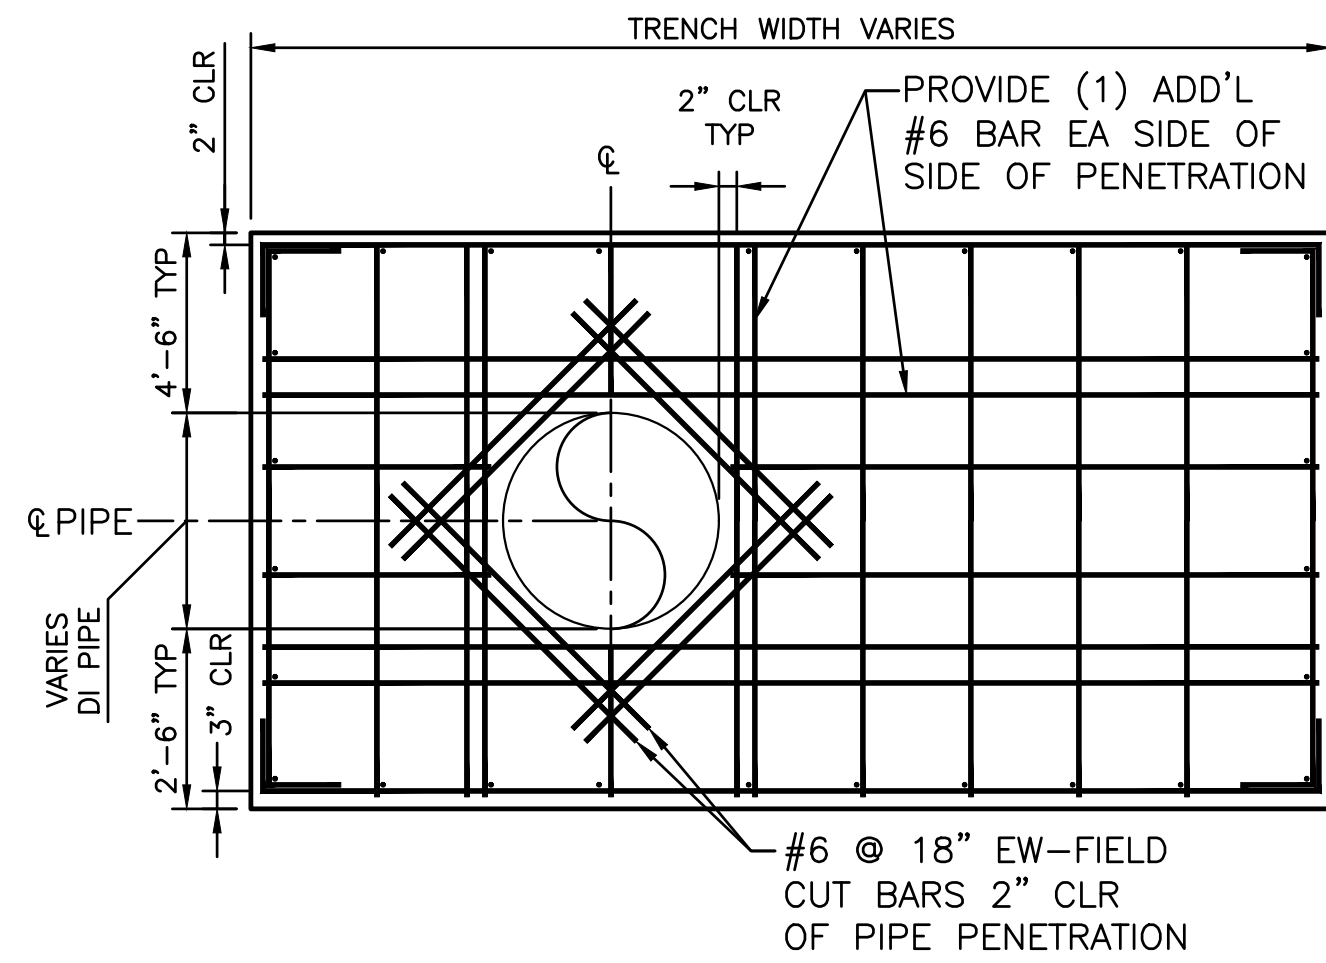

**GENERAL NOTES:**



- SINGLE THRUST BLOCK DIMENSIONS:  
WIDTH = 15'-0"  
HT = LENGTH
- FOR 24" DI PIPE  
HT = LENGTH = 8'-0"
- THIS DETAIL IS FOR EACH FACE;  
DIAGONAL REINFORCING BARS ARE REQUIRED ONLY AT PIPE PENETRATIONS.
- THE CROSS SECTIONAL AREA OF THE THRUST BLOCK MUST BE 72 SQUARE FEET MIN. WIDTH (ALONG THE PIPE) WILL VARY. FITTING SHOULD BE POURED IN THE CENTER OF THE THRUST BLOCK.
- THRUST BLOCKS 8.5FT X 8.5FT OR 72 SQUARE FEET OF BEARING AREA PERPENDICULAR TO THE FM CENTERLINE. ACTUAL DEPTH AND /OR WIDTH MAY VARY DEPENDING UPON FIELD CONDITIONS. KEYWAY MAY BE REQUIRED UNDER FM TO ACHIEVE THE REQUIRED BEARING AREA. THIRD DIMENSION, PARALLEL TO FM CENTERLINE, SHALL BE 8FT;

**THRUST BLOCK  
DETAIL 18**  
M-05 M-05  
NOT TO SCALE

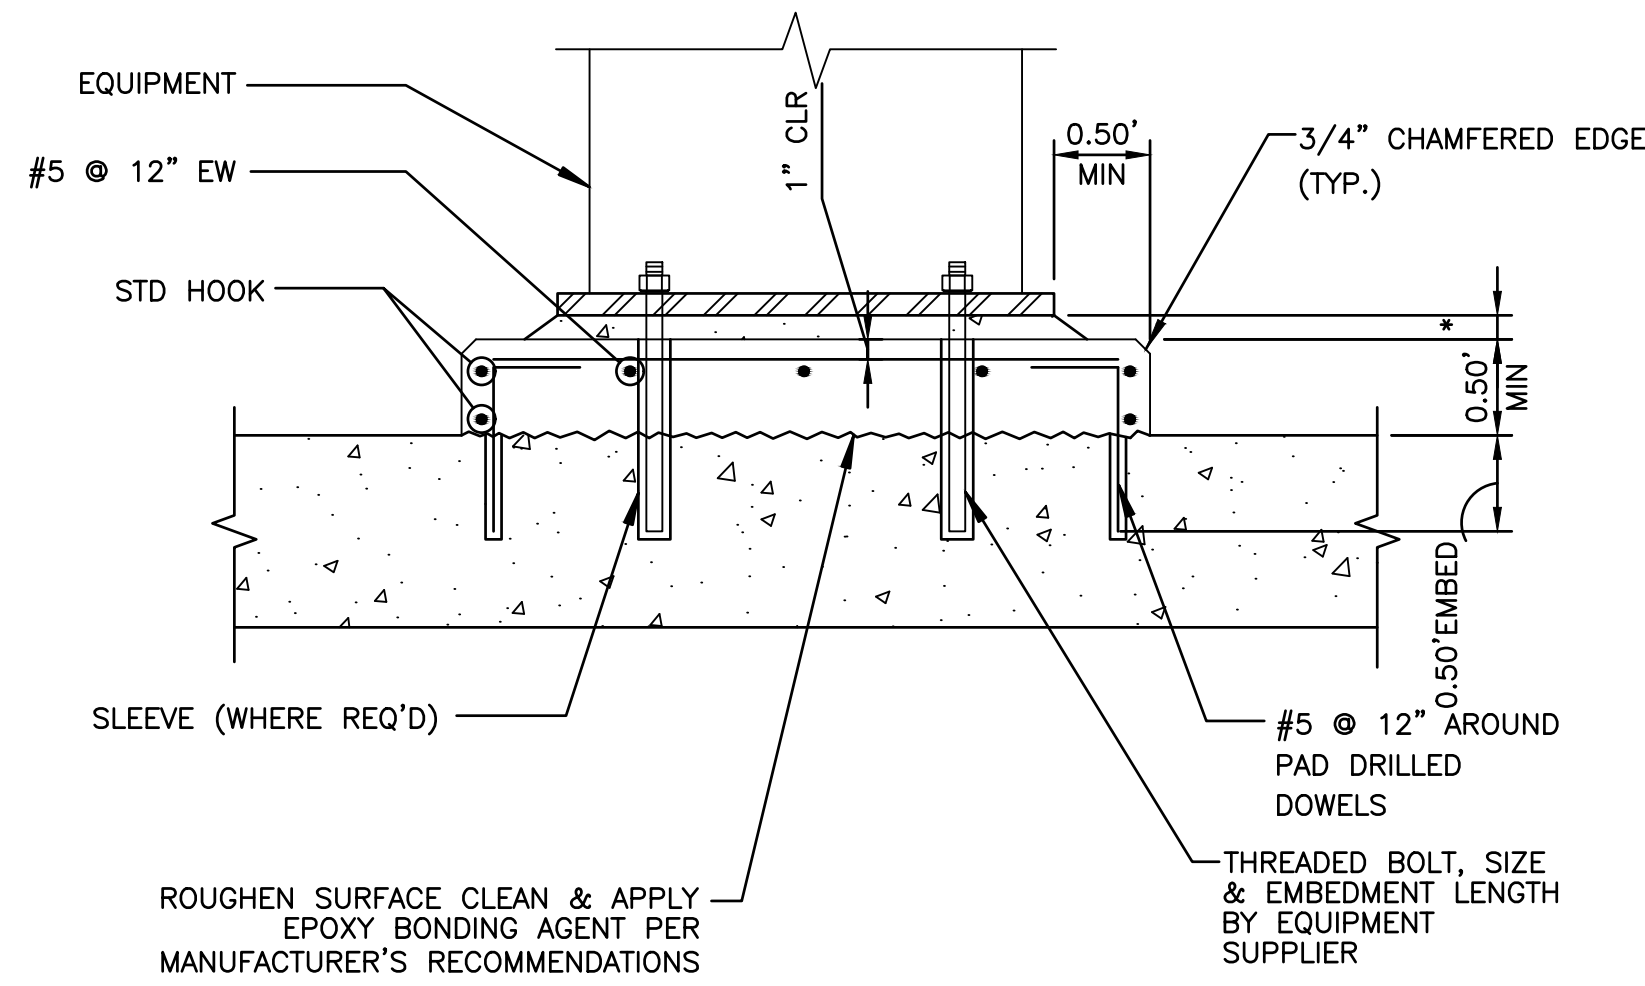


NOTE:  
SEE ELECTRICAL DRAWINGS AND EQUIPMENT REQUIREMENTS.  
CONTRACTOR TO MEET ALL CODE REQUIREMENTS.

**EQUIPMENT SUPPORT PAD WITH DRILLED ANCHORS  
DETAIL 14**  
M-05 M-05  
NOT TO SCALE

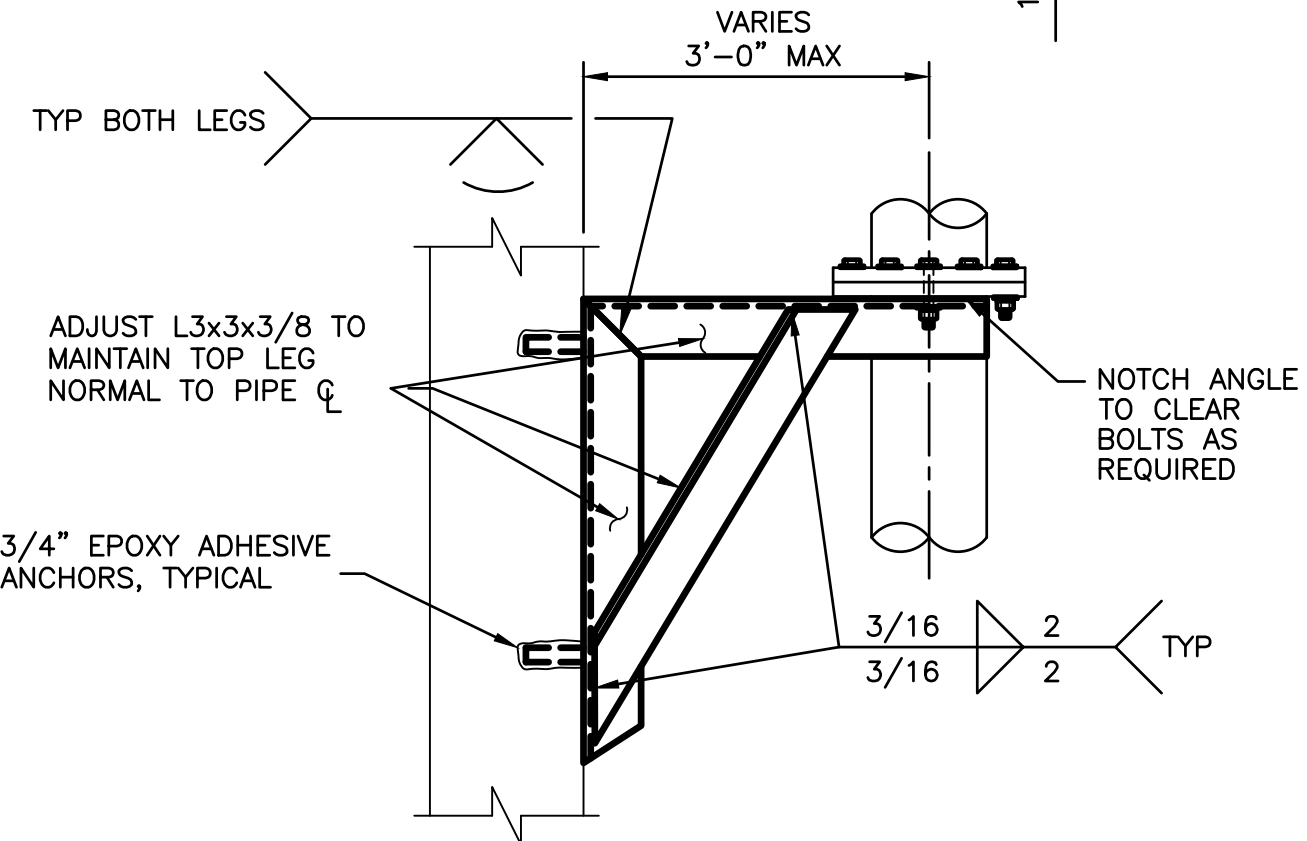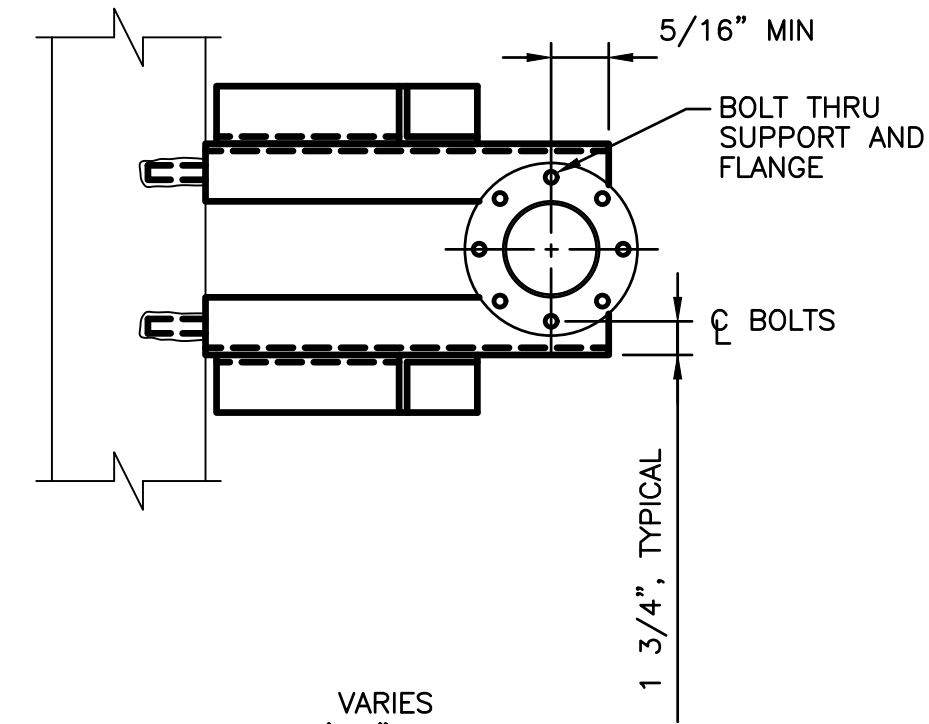

NOTE:  
MATERIAL FOR ALL COMPONENTS SHALL BE HOT DIPPED GALVANIZED AFTER FABRICATION UNLESS NOTED OTHERWISE, REFERENCE SPECIFICATION SECTION 40 05 07.

**DISCHARGE PIPE SUPPORT  
DETAIL 15**  
M-05 M-05  
NOT TO SCALE

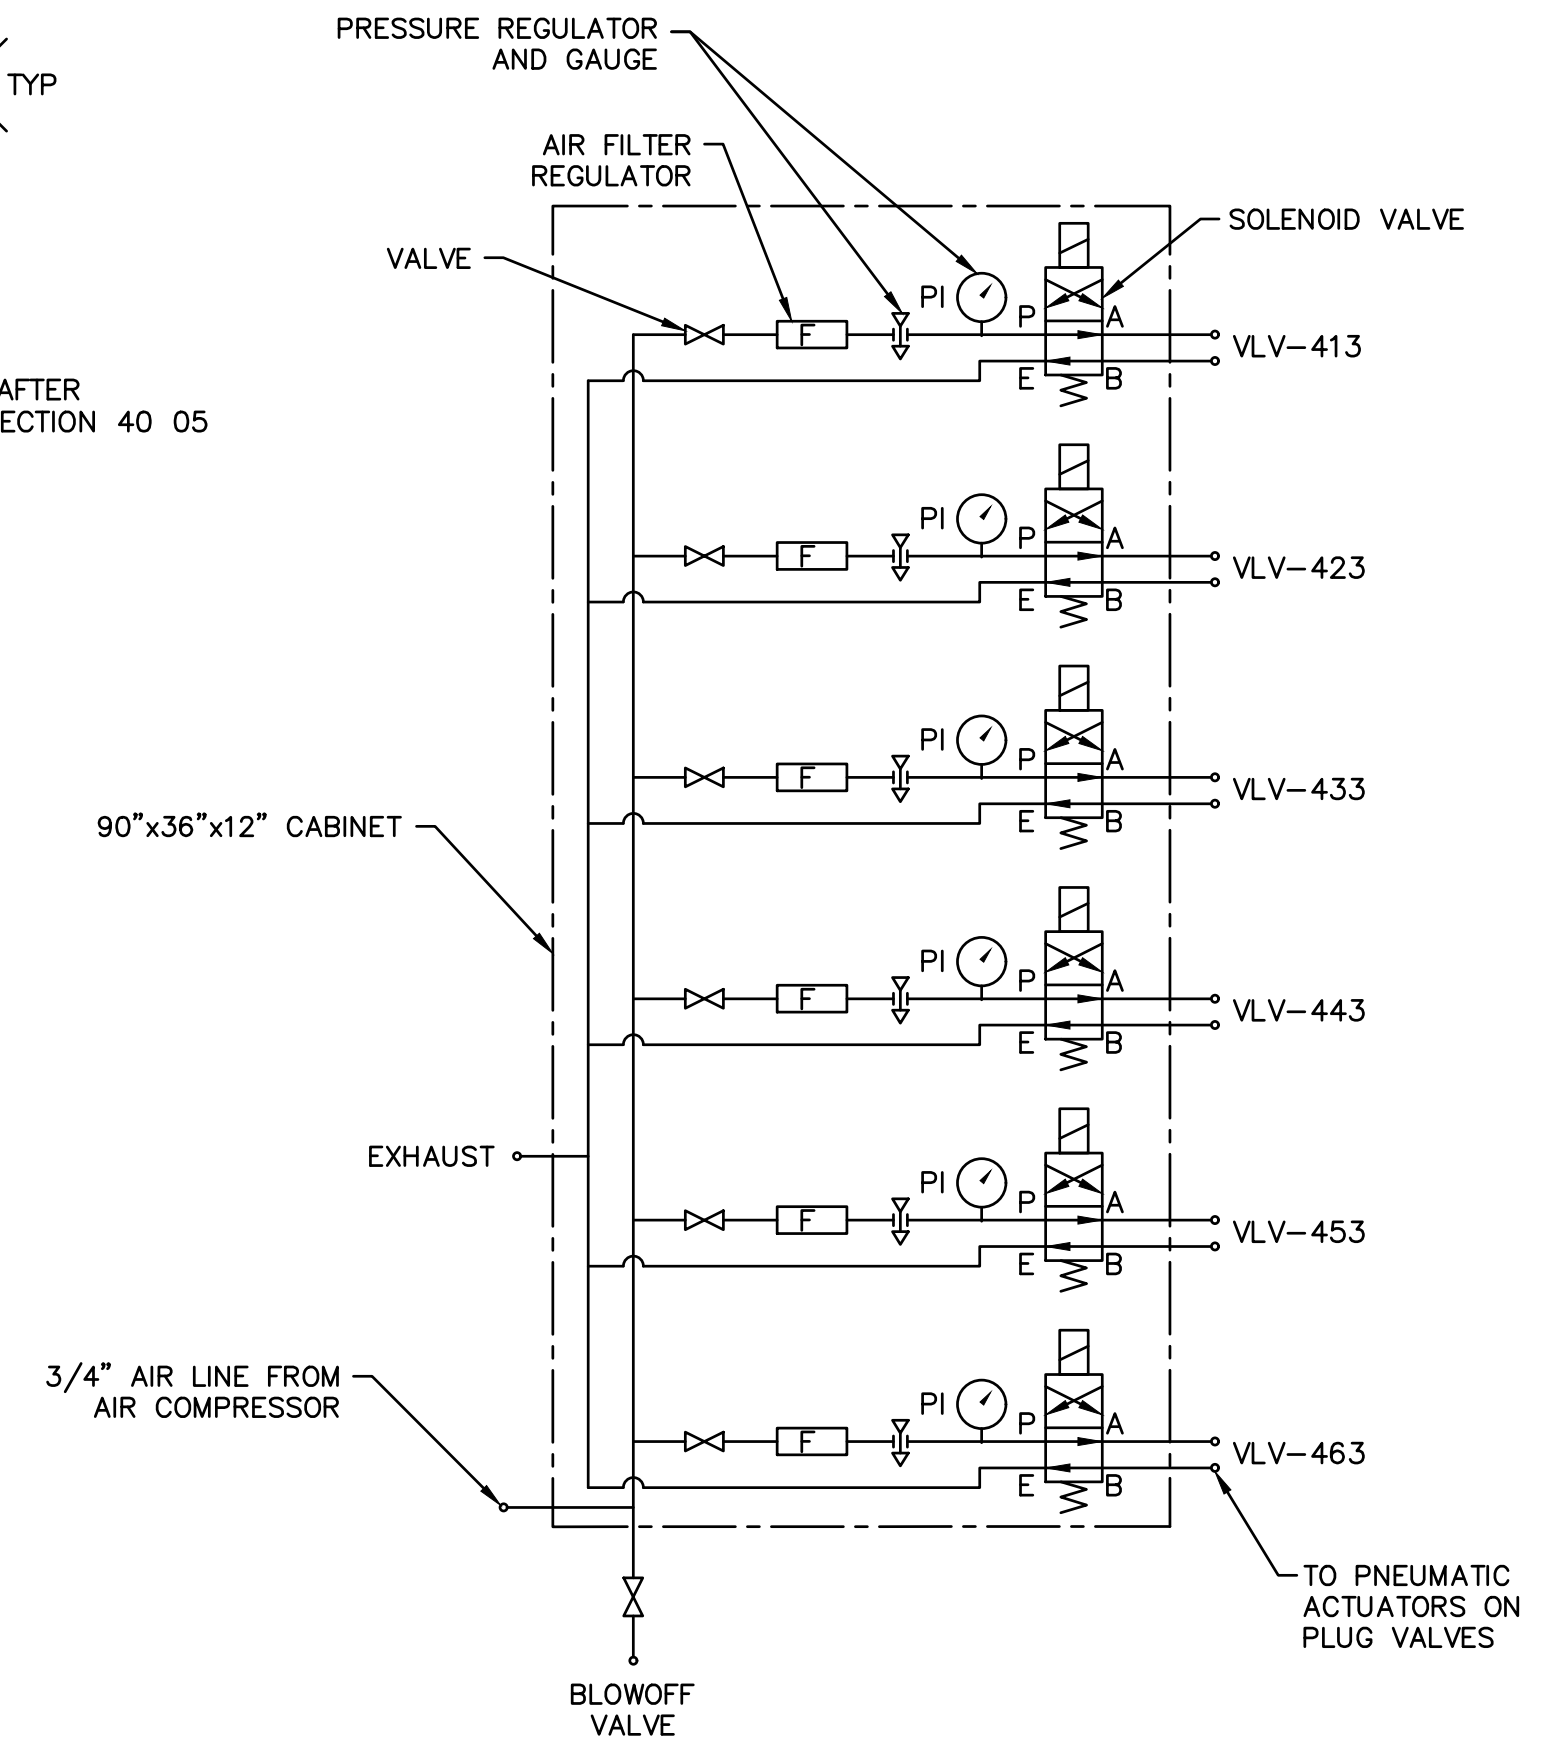


NOTE:  
CONTRACTOR TO COORDINATE WITH AIR COMPRESSOR AND AIR ACTUATOR MANUFACTURERS TO INSTALL VALVES AND APPURTENANCES.


**INSTRUMENT AIR SOLENOID CABINET PIPING DIAGRAM  
DETAIL 20**  
M-05 M-05  
NOT TO SCALE

FACILITY DRAWINGS  
This drawing was supplied by a Consultant Engineer from a past construction project. The Consultant Engineer is not responsible for the information provided by the Contractor to provide the Record Drawing. The City does not warranty this drawing to be a complete and accurate portrayal of facilities as they exist in the field.

FOR CITY OF PHOENIX USE ONLY - REFERENCE CID NUMBER: #	PROJECT NO.	PROJECT NAME	DATE	CAD FILE NAME	DWG NUMBER	REMARKS

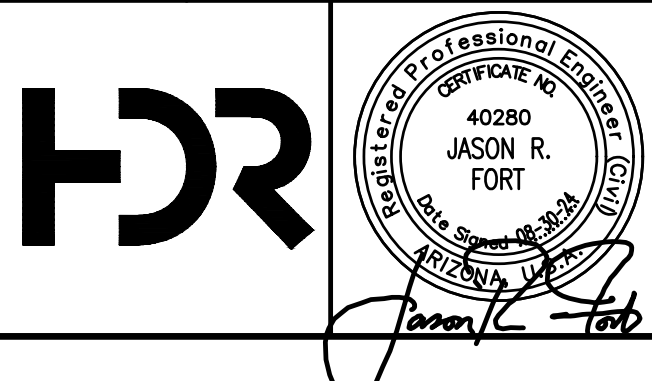

REVISIONS					
NO.	BY	DATE	CKD	REMARKS	
A	RS	10/2023	JF	30% SUBMITTAL	
B	RS	01/2024	JF	90% SUBMITTAL	
C	RS	04/2024	JF	AGENCY REVIEW	
D	DFD	08/2024	JF	ISSUED FOR CONSTRUCTION	
*					
*					
*					

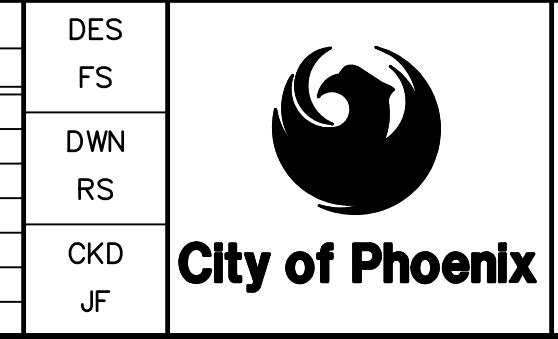

CITY OF PHOENIX  
WATER SERVICES DEPARTMENT

LIFT STATION 40  
REFURBISHMENT

MECHANICAL

GENERAL DETAILS 4

COPYRIGHT © 2007-JANUARY

CITY PROJECT NO. WS90400085

DATE: 08/2024

M-05 SHEET 41 OF 134


CAD FILE: CSMLS40D04.DWG

USER: FBERASFRALD0 FILE: C:\pwworking\west01\35411629\41\_CSMLS40D04.dwg DATE: 9/24/24 TIME: 03:23pm


THIS DRAWING MUST BE FIELD VERIFIED BEFORE USE  
DRAWING NOT TO SCALE UNLESS SCALE BAR IS PRESENT

FOR CONSTRUCTION

"PER CITY OF PHOENIX CODE CHAPTER 2, SECTION 2-28, THESE PLANS ARE FOR OFFICIAL USE ONLY AND MAY NOT BE SHARED WITH OTHERS EXCEPT AS REQUIRED TO FULFILL THE OBLIGATIONS OF THE CONTRACTOR'S CONTRACT WITH THE CITY OF PHOENIX."  
THIS DOCUMENT MUST BE KEPT SECURE AT ALL TIMES.

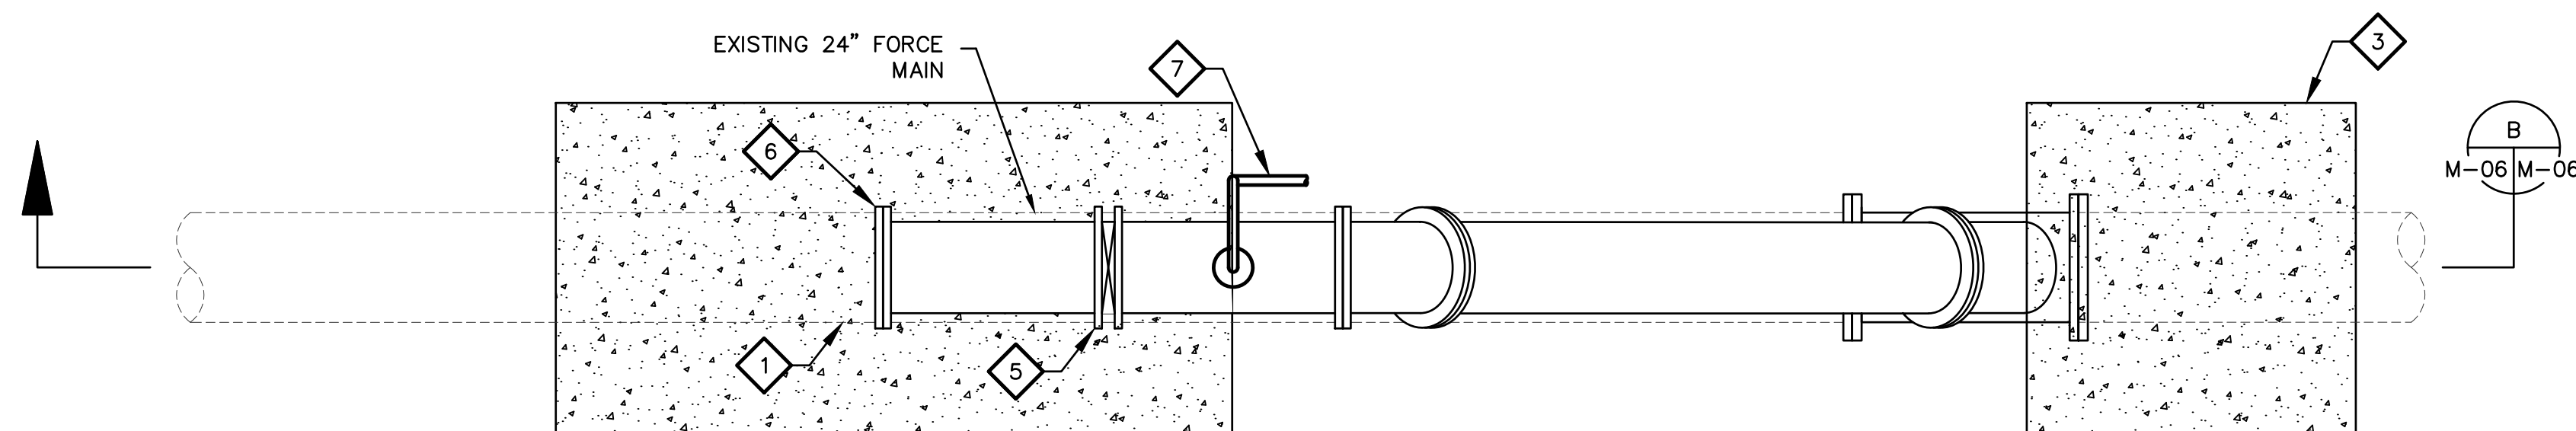

PLAN

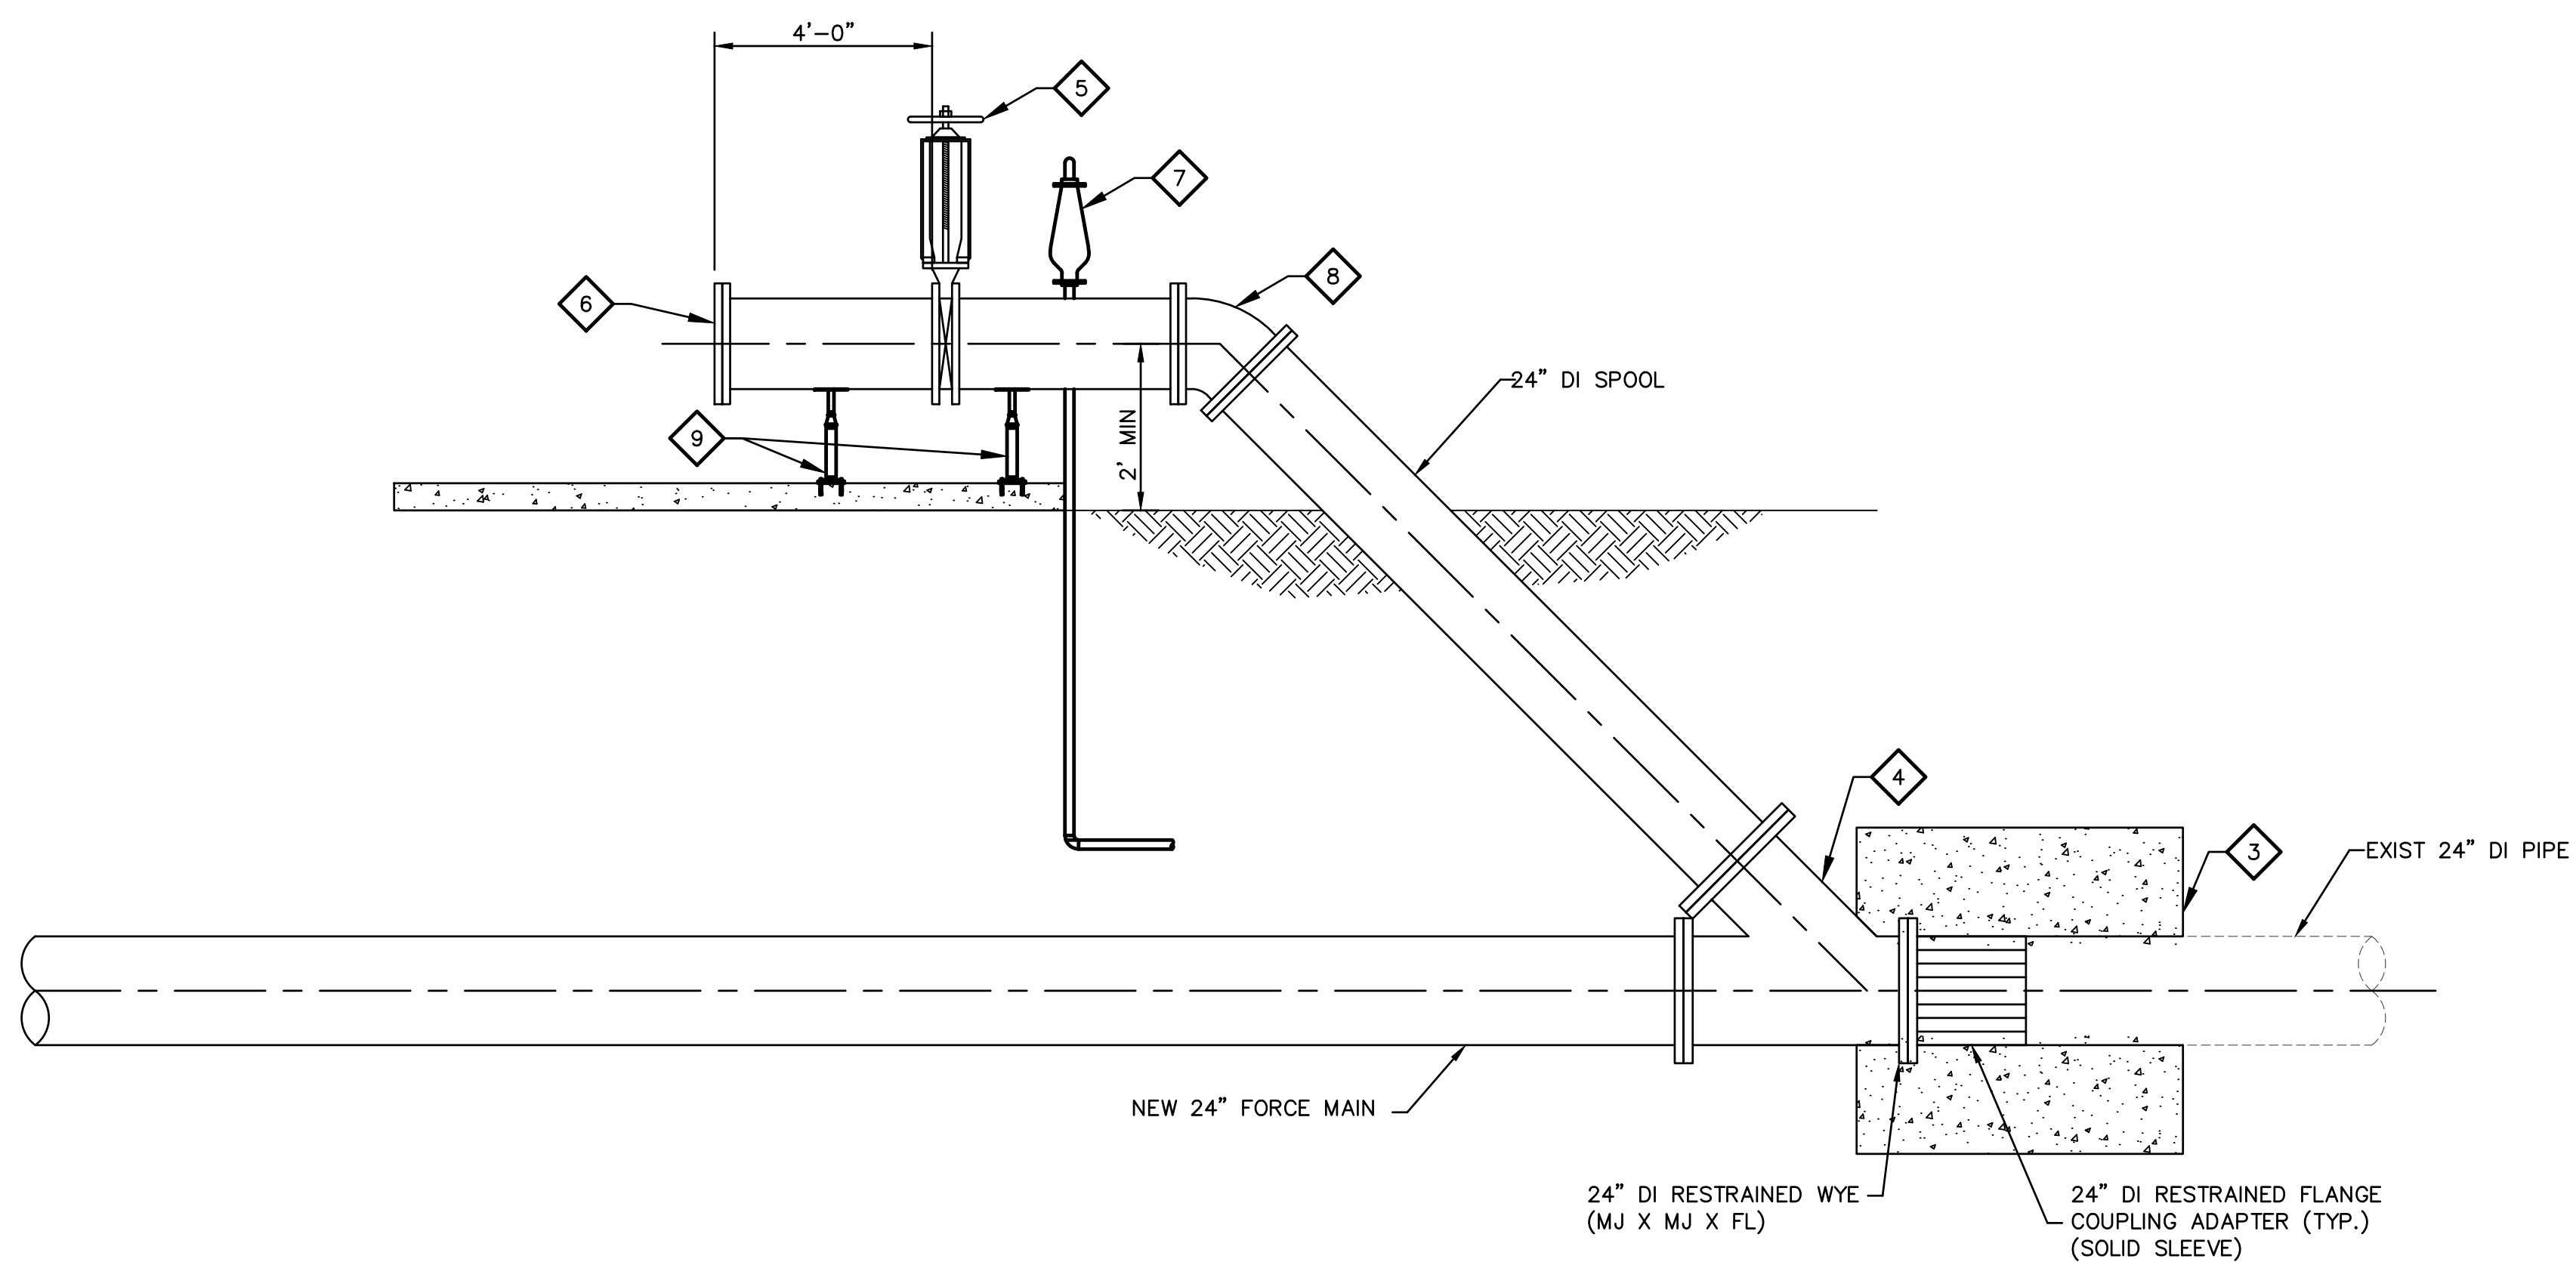

SECTION B-B  
M-06 M-06

SCALE = N.T.S.

LAUNCH STRUCTURE

DETAIL 20  
M-06 M-06

NOT TO SCALE

**KEY NOTES**


- 1 EXISTING 24" DI PIPE.
- 3 THRUST BLOCKS SHALL BE 8.5FT X 8.5FT OR 72 SQUARE FEET OF BEARING AREA PERPENDICULAR TO THE FM CENTERLINE AND POURED AGAINST NATIVE UNDISTURBED SOIL OR 1 SACK CLSM UNLESS APPROVED OTHERWISE BY THE ENGINEER. THRUST BLOCK REINFORCEMENT SHALL BE PER DTL 18 ON SHEET M-05.
- 4 24" DI WYE.
- 5 24" KNIFE GATE VALVE.
- 6 24" BLIND FLANGE.
- 7 2" CAV W/ SST ISOLATION BALL VALVE AND VENT DISCHARGE PIPE; ROUTE 2-INCH CPVC TO EXIST MH STRUCTURE NO. 402. CORE DRILL MH BELOW GRADE; SEAL W/ LINK SEAL OR APPROVED EQUAL. MAINTAIN POSITIVE SLOPE FROM MANHOLE TO ARV.
- SEE DETAIL 2  
M-06 M-02
- 8 24" DI 45 DEGREE BEND.
- 9 PIPE SUPPORT PER DETAIL 1  
M-06 M-02

**GENERAL NOTES:**


1. ALL DI FITTINGS TO BE COATED WITH SEWER/SHIELD, SEE SPEC SECTION 09 90 00 FOR ADDITIONAL REQUIREMENTS.
2. REFER TO GRADING AND DRAINAGE PLANS, SEE SHEETS C-25 AND C-26 FOR FINISHED FLOOR ELEVATIONS.
3. REFER TO SHEET M-08 FOR BURIED VALVES ON FORCE MAINS 2 AND 3.

FACILITY DRAWINGS  
This drawing was supplied by a Consultant Engineer from a past construction project. The information on this drawing is based on information provided by the Contractor to provide the Record Drawing. The City does not warrant this drawing to be a complete and accurate portrayal of facilities as they exist in the field.

FOR CITY OF PHOENIX USE ONLY - REFERENCE CID NUMBER: #	DATE	CAD FILE NAME	DWG NUMBER	REMARKS
REVISION ENGINEERING COMPANY	PROJECT NO.	PROJECT NAME		
#				
#				
#				

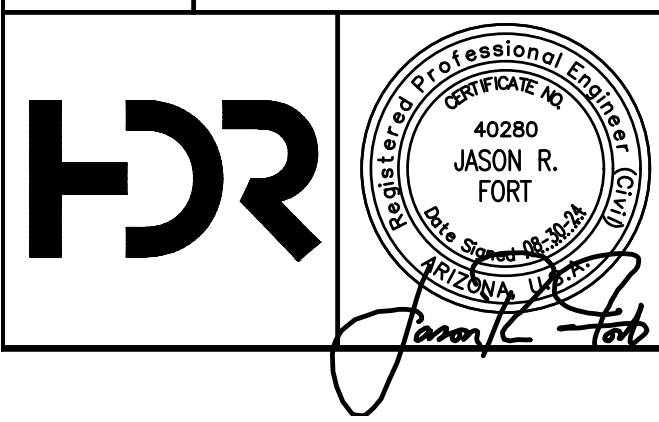

REVISIONS				
NO.	BY	DATE	CKD	REMARKS
A	RS	10/2023	JF	30% SUBMITTAL
B	RS	01/2024	JF	90% SUBMITTAL
C	RS	04/2024	JF	AGENCY REVIEW
D	FDF	08/2024	JF	ISSUED FOR CONSTRUCTION
*				
*				
*				

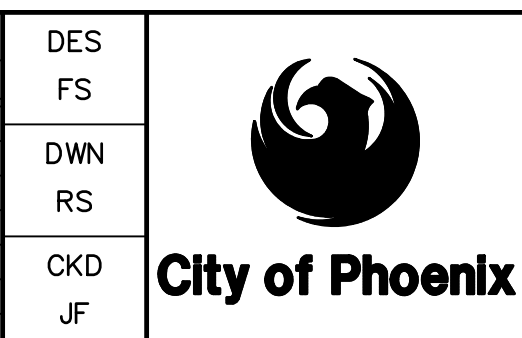

CITY OF PHOENIX  
WATER SERVICES DEPARTMENT  
  
LIFT STATION 40  
REFURBISHMENT

MECHANICAL  
  
GENERAL DETAILS 6  
NEW LAUNCHING STRUCTURE



COPYRIGHT © 2007-JANUARY  
CITY PROJECT NO. WS90400085  
DATE: 08/2024  
M-06 SHEET 42 OF 134  
CAD FILE: CSMLS40D05.DWG

USER: FDEBASFRALUD FILE: C:\pwworking\west01\03411629\42\_CSMLS40D05.dwg DATE: 9/04/24 TIME: 03:23pm

FOR CONSTRUCTION

THIS DRAWING MUST BE FIELD VERIFIED BEFORE USE  
DRAWING NOT TO SCALE UNLESS SCALE BAR IS PRESENT

\*PER CITY OF PHOENIX CODE CHAPTER 2, SECTION 2-28, THESE PLANS ARE FOR OFFICIAL USE ONLY AND MAY NOT BE SHARED WITH OTHERS EXCEPT AS REQUIRED TO FULFILL THE OBLIGATIONS OF THE CONTRACTOR'S CONTRACT WITH THE CITY OF PHOENIX.  
THIS DOCUMENT MUST BE KEPT SECURE AT ALL TIMES.

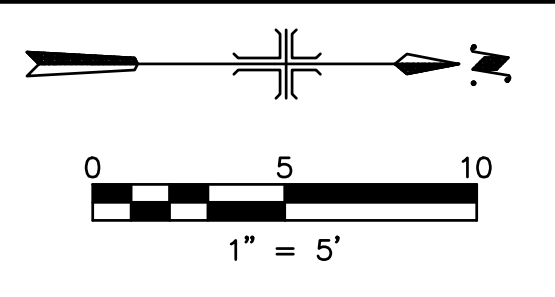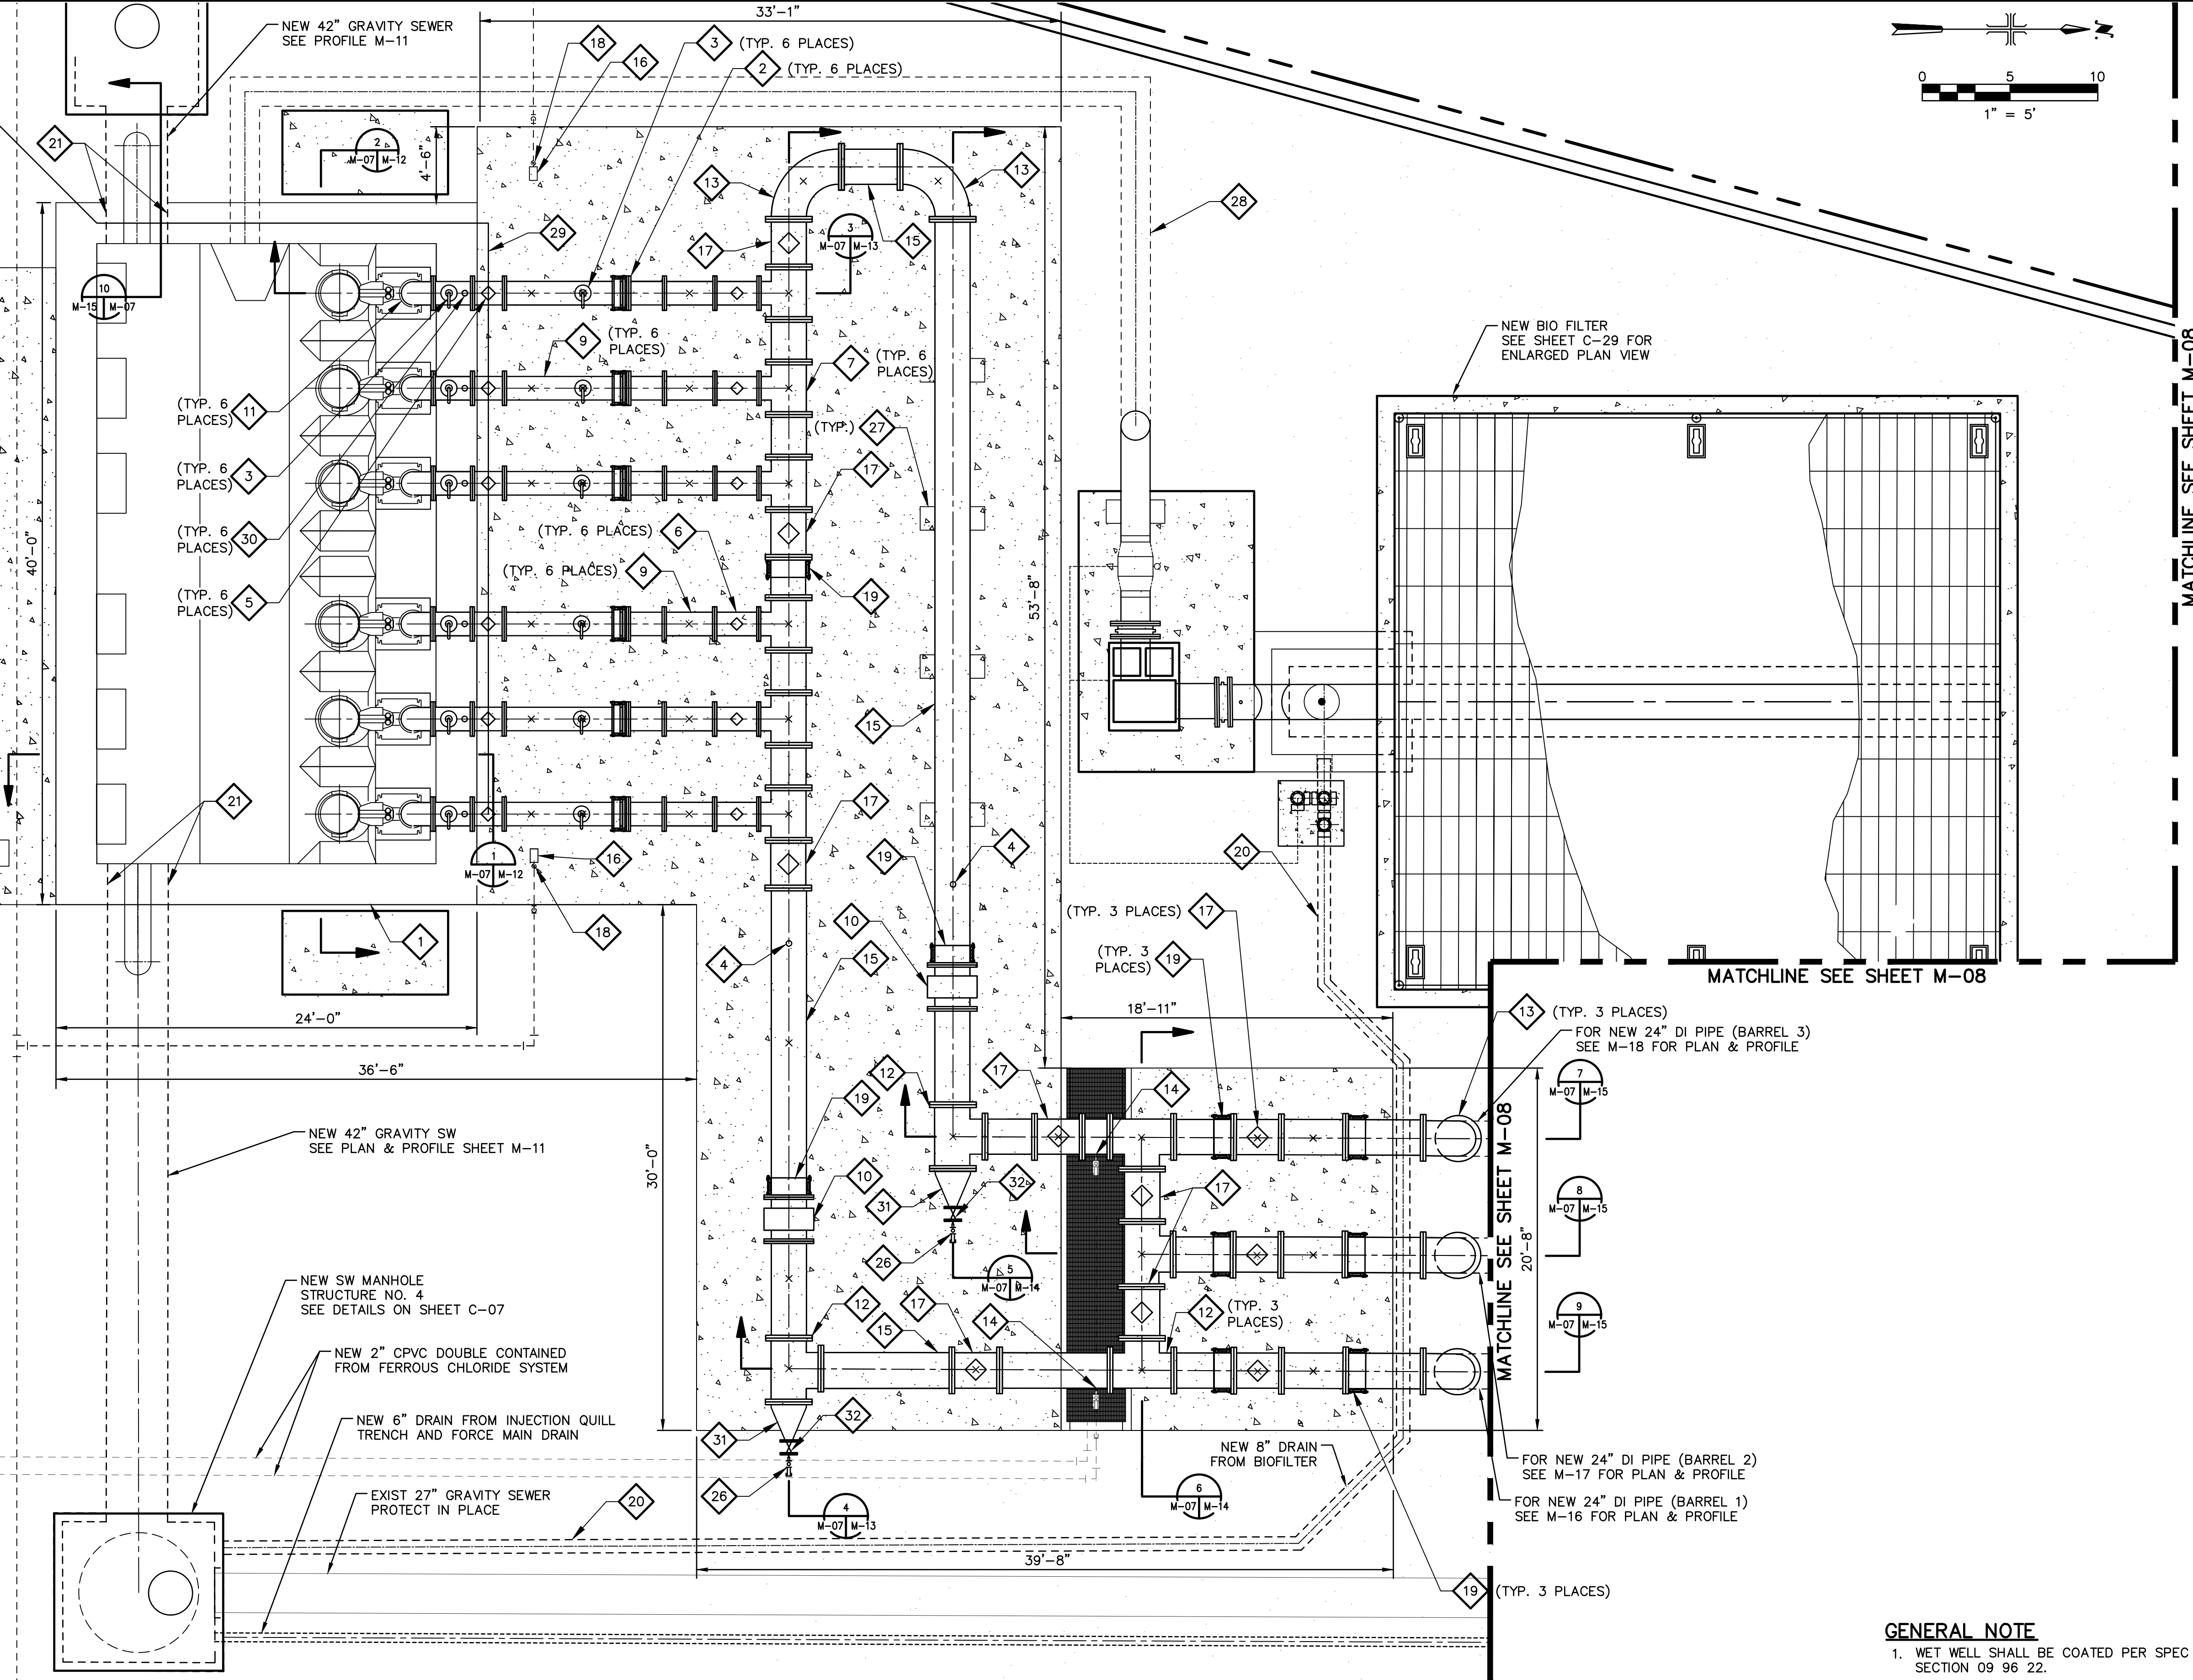

**KEY NOTES**


- 1 NEW 40'-0" X 24'-0" WET WELL. SEE SECTION 1 SHEET M-12.
- 2 16" RESTRAINED DISMANTLING JOINT ROMAC DJ400 OR APPROVED EQUAL. SEE DETAIL 3&4 M-07 M-02
- 3 3" COMBINATION AIR/VACUUM RELEASE VALVE. ROUTE VENT LINE TO WET WELL. SEE DETAIL 2 M-07 M-02
- 4 PRESSURE GAUGE AND TRANSMITTER SEE DETAIL 6 M-07 M-03
- 5 16" PLUG VALVE WITH PNEUMATIC ACTUATOR. SEE SPEC SECTION 40 05 62.
- 6 16" FULL-PORT PLUG VALVE, EXTERNAL HAND WHEEL, CAST IRON.
- 7 16" X 24" X 24" DI TEE.
- 9 16" CLASS 250 DIP.
- 10 24" INLINE MAGNETIC FLOW METER.
- 11 16" DI - 90 DEGREE BEND.
- 12 24" X 24" X 24" DI TEE.
- 13 24" DI - 90 DEGREE BEND.
- 14 INJECTION QUILL. SEE DETAIL 5 M-07 M-03
- 15 24" CLASS 250 DIP PIPE.
- 16 HEAVY DUTY HOSE RACK SEE DETAIL 13 M-07 M-04
- 17 24" FULL PORT PLUG VALVE, EXTERNAL HAND WHEEL, CAST IRON.
- 18 HOSE BIB. SEE DETAIL 13 M-07 M-04
- 19 24" RESTRAINED DISMANTLING JOINT ROMAC DJ400 OR APPROVED EQUAL. SEE DETAIL 3&4 M-07 M-02
- 20 NEW 8" CPVC DRAIN FROM BIOFILTER.
- 21 PIPE PENETRATION PER DETAIL 12 M-07 M-04
- 26 NEW CAM-LOK CONNECTION.
- 27 ADJUSTABLE PIPE SUPPORT. SEE DETAIL 1 M-07 M-02
- 28 NEW 20" FRP FAD.
- 29 3/4" TYPE K COPPER AIR SUPPLY LINE TO FEED PNEUMATIC ACTUATORS.
- 30 PRESSURE SWITCH AND GAUGE. SEE DETAIL 6 M-07 M-03
- 31 24"X6" REDUCER.
- 32 6" PLUG VALVE.

**GENERAL NOTE**

1. WET WELL SHALL BE COATED PER SPEC SECTION 09 96 22.

FACILITY DRAWINGS  
This drawing was supplied by a Consultant Engineer from a past project. The Consultant Engineer is not responsible for the construction information provided by the Contractor to provide a complete and accurate portrayal of facilities as they exist in the field.  
The City does not warrant this drawing to be a complete and accurate portrayal of facilities as they exist in the field.

REVISION	NO.	DATE	PROJECT NO.	PROJECT NAME	DATE	DWG NUMBER	REMARKS
#	#	#	#	#	#	#	#

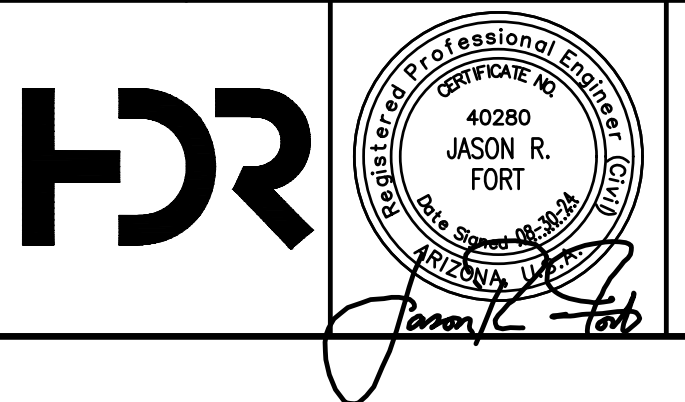

REVISIONS				
NO.	BY	DATE	CKD	REMARKS
A	RS	10/2023	JF	30% SUBMITTAL
B	RS	01/2024	JF	90% SUBMITTAL
C	RS	04/2024	JF	AGENCY REVIEW
D	DFD	08/2024	JF	ISSUED FOR CONSTRUCTION
*				
*				
*				

CITY OF PHOENIX  
WATER SERVICES DEPARTMENT

**City of Phoenix**

LIFT STATION 40  
REFURBISHMENT

MECHANICAL

LS YARD PIPING PLAN  
SHEET 1 OF 3

COPYRIGHT © 2007-JANUARY

CITY PROJECT NO. WS90400085

DATE: 08/2024

**M-07** SHEET 43 OF 134


CAD FILE: CSMLS40P01.dwg

USER: FBREASFRALUD FILE: C:\pwworking\west01\03411629\03\_CSMLS40P01.dwg DATE: 9/24/24 TIME: 03:23pm

FOR CONSTRUCTION

THIS DRAWING MUST BE FIELD VERIFIED BEFORE USE  
DRAWING NOT TO SCALE UNLESS SCALE BAR IS PRESENT


"PER CITY OF PHOENIX CODE CHAPTER 2, SECTION 2-28, THESE PLANS ARE FOR OFFICIAL USE ONLY AND MAY NOT BE SHARED WITH OTHERS EXCEPT AS REQUIRED TO FULFILL THE OBLIGATIONS OF THE CONTRACTOR'S CONTRACT WITH THE CITY OF PHOENIX."  
THIS DOCUMENT MUST BE KEPT SECURE AT ALL TIMES.

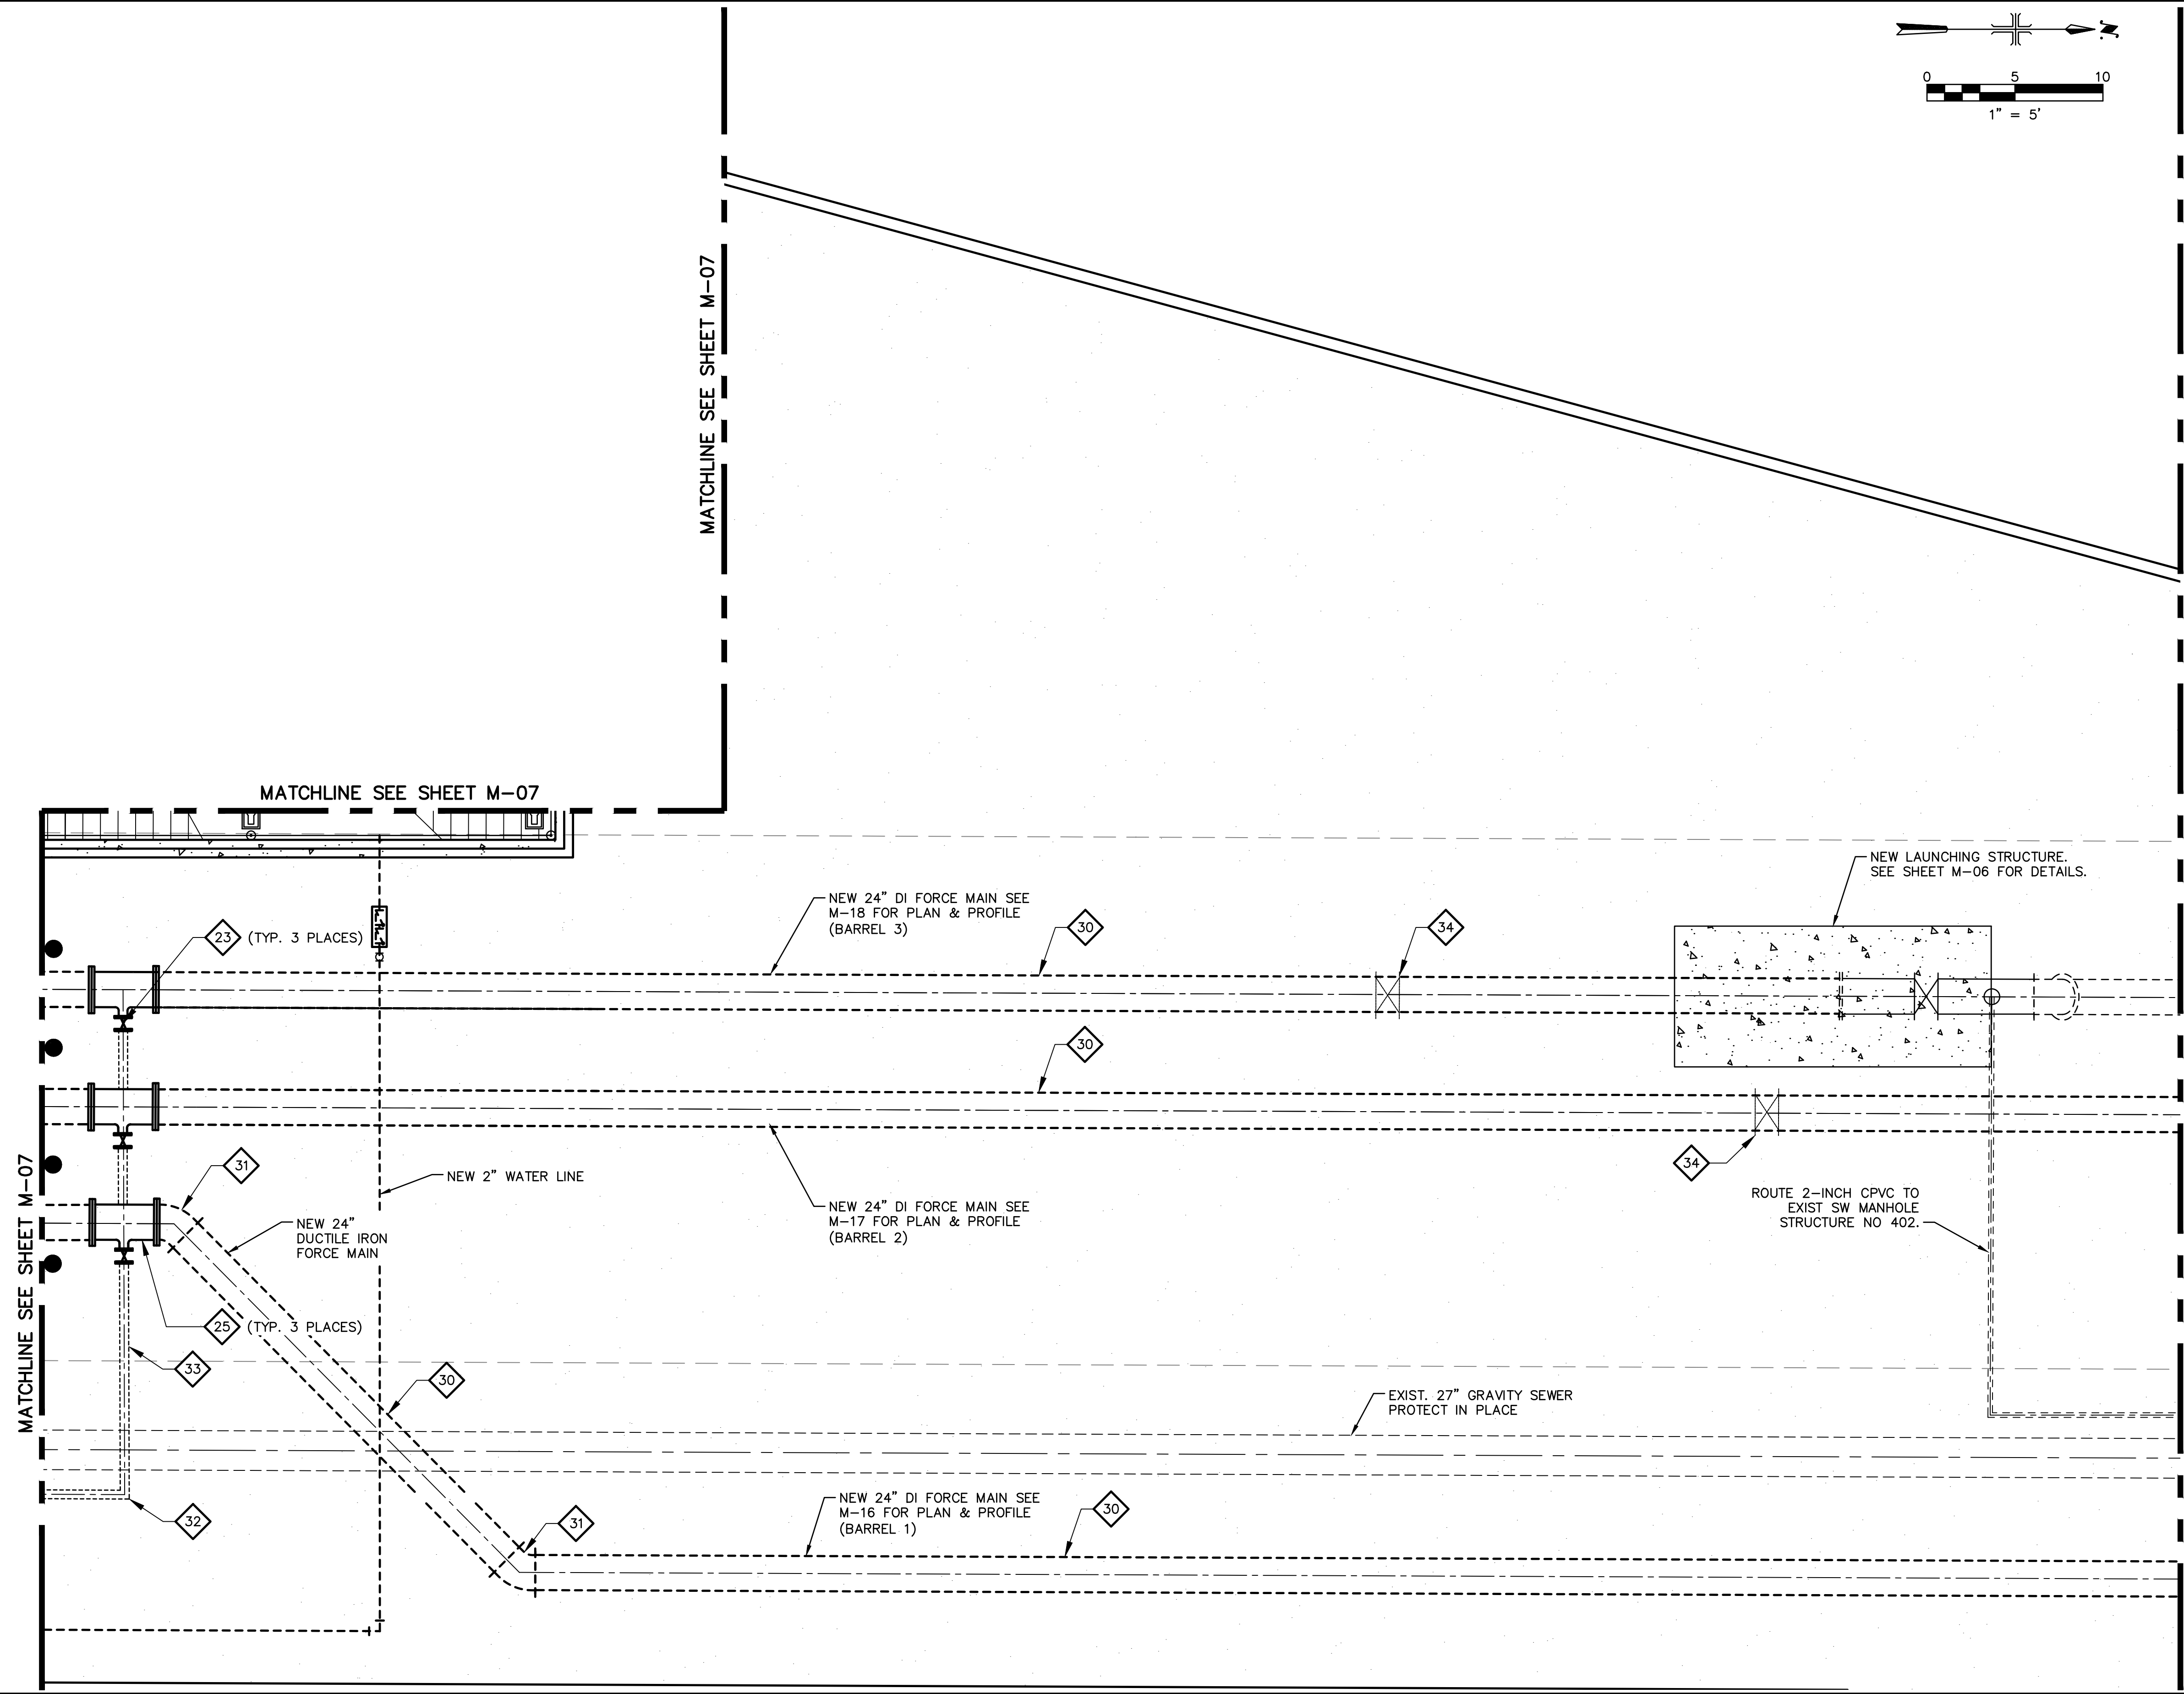


- KEY NOTES**
- 23 INSTALL NEW 6" FULL PORT PLUG VALVE. INSTALL VALVE BOX PER C.O.P. STD. DET. P1391.
  - 25 INSTALL NEW 24"X24"X6" TEE.
  - 30 INSTALL NEW 24" DI PIPE FORCE MAIN.
  - 31 INSTALL NEW 24" DI PIPE 45° BEND.
  - 32 INSTALL 6" FORCE MAIN DRAIN LINE 90° BEND.
  - 33 INSTALL 6" DIP FORCE MAIN DRAIN LINE
  - 34 INSTALL 24" FULL PORT PLUG VALVE WITH RISER AND VALVE BOX PER COP STD DET. 1391.

FACILITY DRAWINGS  
This drawing was supplied by a Consultant Engineer from a past project. The Consultant Engineer is not responsible for the construction information provided by the Contractor to provide the Record Drawing. The City does not warrant this drawing to be a complete and accurate portrayal of facilities as they exist in the field.

REVISION	ENGINEERING COMPANY	PROJECT NO.	PROJECT NAME	DATE	CAD FILE NAME	DWG NUMBER	REMARKS

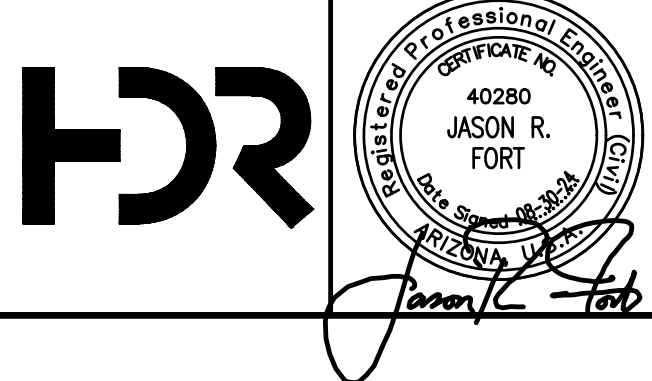

NO.	BY	DATE	CKD	REVISIONS	REMARKS
A	RS	10/2023	JF	30% SUBMITTAL	
B	RS	01/2024	JF	90% SUBMITTAL	
C	RS	04/2024	JF	AGENCY REVIEW	
D	DFD	08/2024	JF	ISSUED FOR CONSTRUCTION	

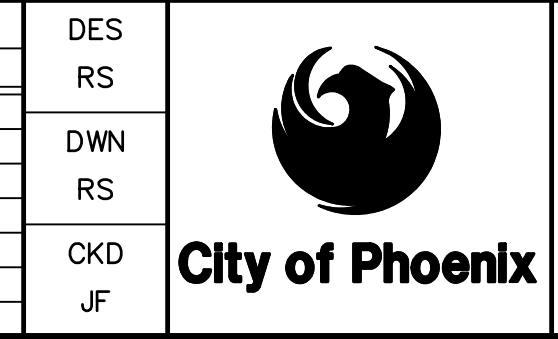

CITY OF PHOENIX  
WATER SERVICES DEPARTMENT  
  
LIFT STATION 40  
REFURBISHMENT

MECHANICAL  
  
LS YARD PIPING PLAN  
SHEET 2 OF 3

COPYRIGHT © 2007-JANUARY  
CITY PROJECT NO. WS90400085  
DATE: 08/2024  
**M-08** SHEET 44 OF 134  
CAD FILE: CSMLS40P02.dwg



USER: FIDES\FR\AUD FILE: C:\pwworking\west01\03411629\44\_CSMLS40P02.dwg DATE: 9/04/24 TIME: 03:24pm

**FOR CONSTRUCTION**

THIS DRAWING MUST BE FIELD VERIFIED BEFORE USE  
DRAWING NOT TO SCALE UNLESS SCALE BAR IS PRESENT

"PER CITY OF PHOENIX CODE CHAPTER 2, SECTION 2-28, THESE PLANS ARE FOR OFFICIAL USE ONLY AND MAY NOT BE SHARED WITH OTHERS EXCEPT AS REQUIRED TO FULFILL THE OBLIGATIONS OF THE CONTRACTOR'S CONTRACT WITH THE CITY OF PHOENIX."  
THIS DOCUMENT MUST BE KEPT SECURE AT ALL TIMES.


MATCHLINE SEE SHEET M-08

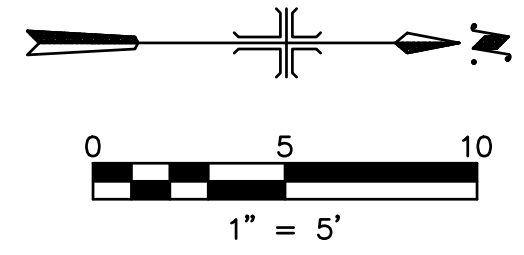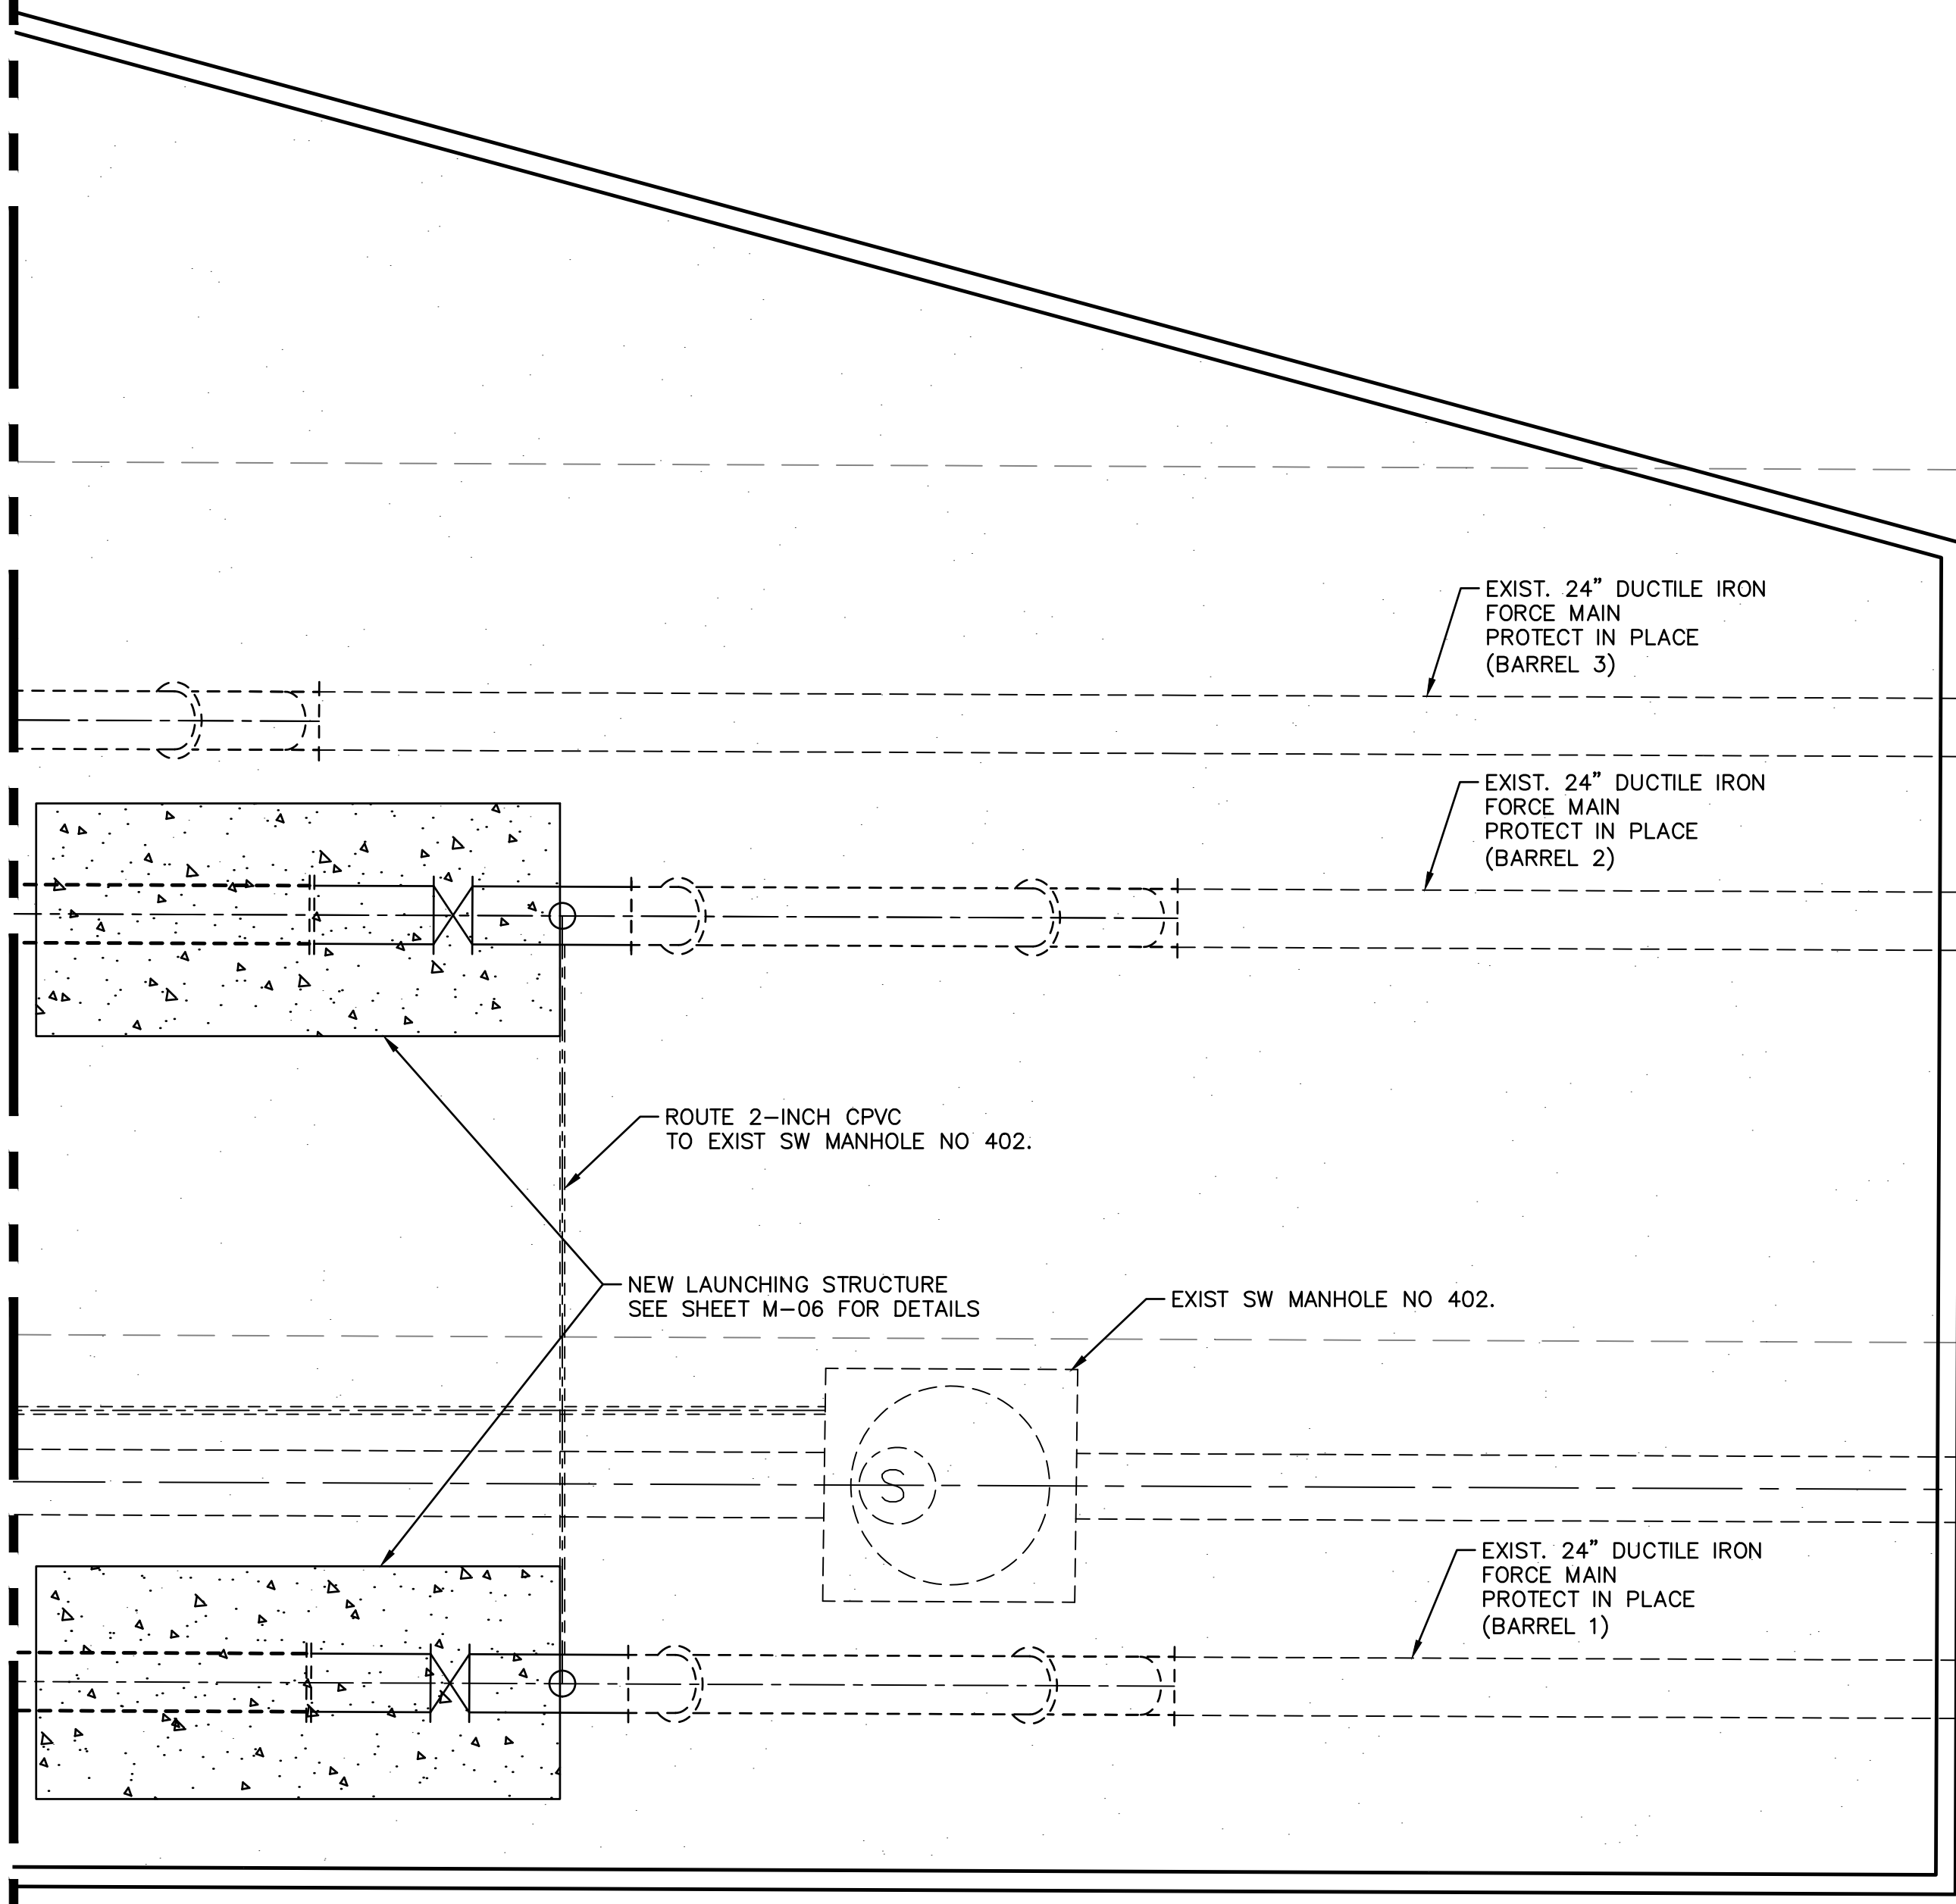

**KEY NOTES**  
30 INSTALL NEW 24" DI PIPE FORCE MAIN.

FACILITY DRAWINGS  
This drawing was supplied by a Consultant Engineer from a past construction project. The Consultant Engineer is not responsible for the construction information provided by the Contractor to provide the Record Drawing. The City does not warrant this drawing to be a complete and accurate portrayal of facilities as they exist in the field.

FOR CITY OF PHOENIX USE ONLY - REFERENCE CID NUMBER: #	PROJECT NO.	PROJECT NAME	DATE	CAD FILE NAME	DWG NUMBER	REMARKS

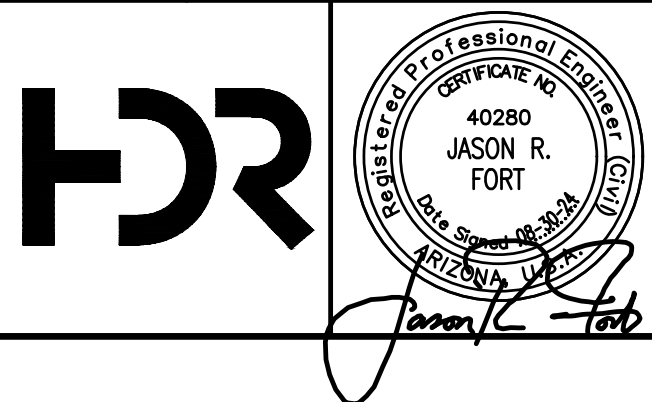

NO.	BY	DATE	CKD	REMARKS
A	RS	10/2023	JF	30% SUBMITTAL
B	RS	01/2024	JF	90% SUBMITTAL
C	RS	04/2024	JF	AGENCY REVIEW
D	FDF	08/2024	JF	ISSUED FOR CONSTRUCTION
*				
*				
*				

DES  
FA  
DWN  
RS  
CKD  
JF



CITY OF PHOENIX  
WATER SERVICES DEPARTMENT  
  
LIFT STATION 40  
REFURBISHMENT

MECHANICAL  
  
LS YARD PIPING PLAN  
SHEET 3 OF 3


COPYRIGHT © 2007-JANUARY  
CITY PROJECT NO. WS90400085  
DATE: 08/2024  
M-09 SHEET 45 OF 134  
CAD FILE: CSMLS40P03.dwg

USER: FDEBASFRALUD FILE: C:\pwworking\west01\03411629\45\_CSMLS40P03.dwg DATE: 9/04/24 TIME: 03:24pm

FOR CONSTRUCTION


THIS DRAWING MUST BE FIELD VERIFIED BEFORE USE  
DRAWING NOT TO SCALE UNLESS SCALE BAR IS PRESENT

"PER CITY OF PHOENIX CODE CHAPTER 2, SECTION 2-28, THESE PLANS ARE FOR OFFICIAL USE ONLY AND MAY NOT BE SHARED WITH OTHERS EXCEPT AS REQUIRED TO FULFILL THE OBLIGATIONS OF THE CONTRACTOR'S CONTRACT WITH THE CITY OF PHOENIX."  
THIS DOCUMENT MUST BE KEPT SECURE AT ALL TIMES.

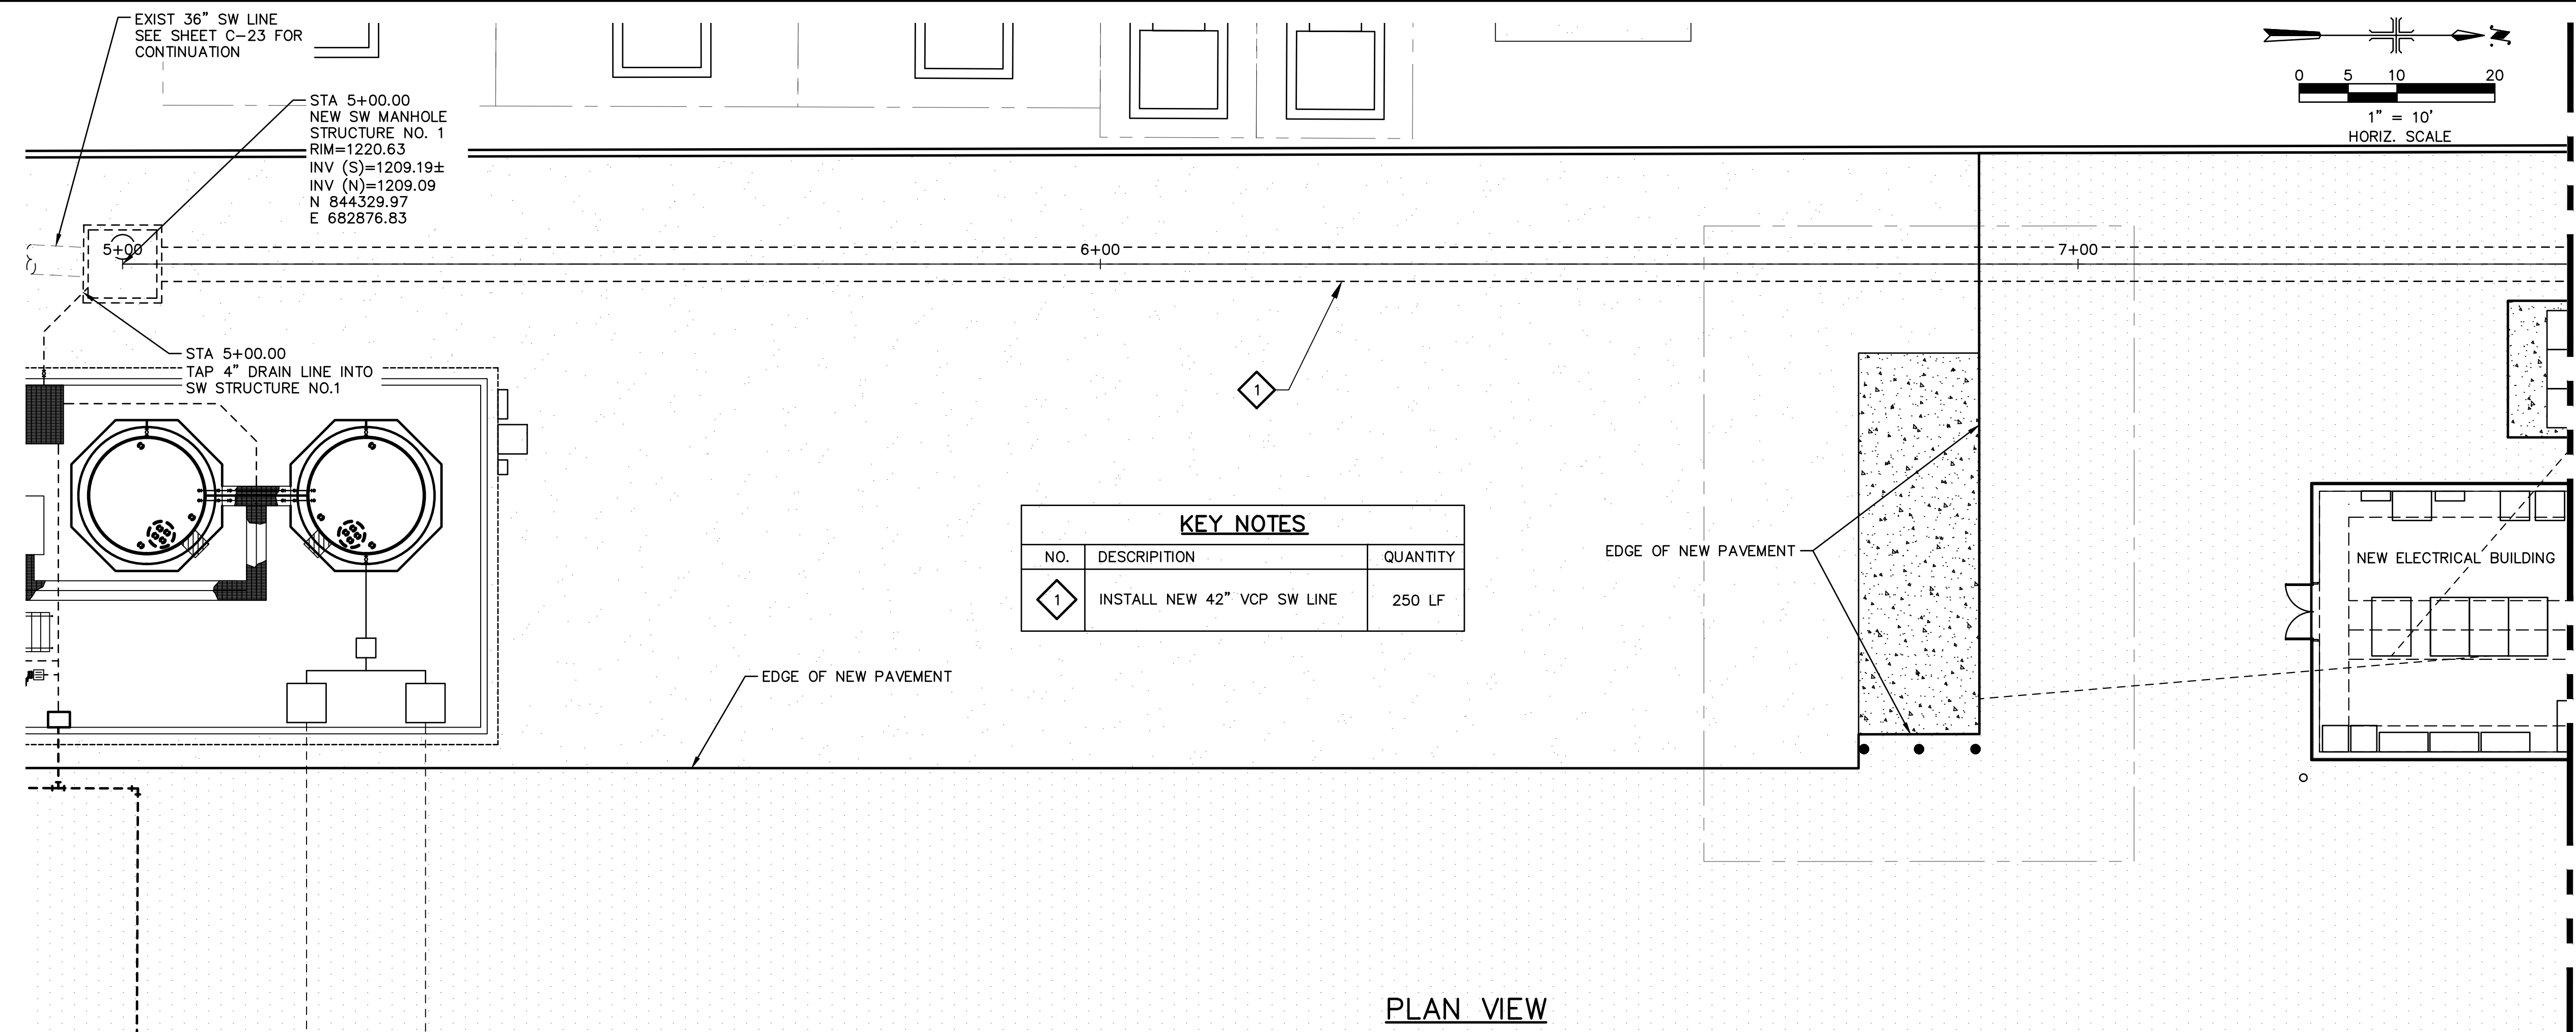

KEY NOTES		
NO.	DESCRIPTION	QUANTITY
1	INSTALL NEW 42" VCP SW LINE	250 LF


**GENERAL NOTES**  
1. WET WELL AND SANITARY SEWER MANHOLES SHALL BE COATED PER SPEC SECTION 09 96 22

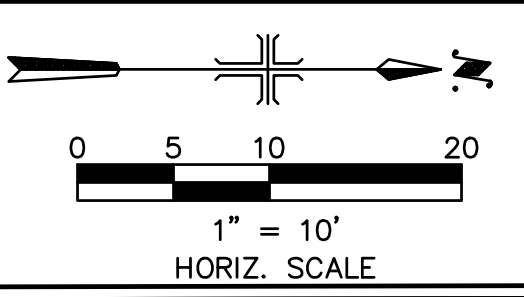


**LEGEND**

- EQUIPMENT CLEARANCE LINES
- NEW AC PAVEMENT
- DECOMPOSED GRANITE

PLAN VIEW

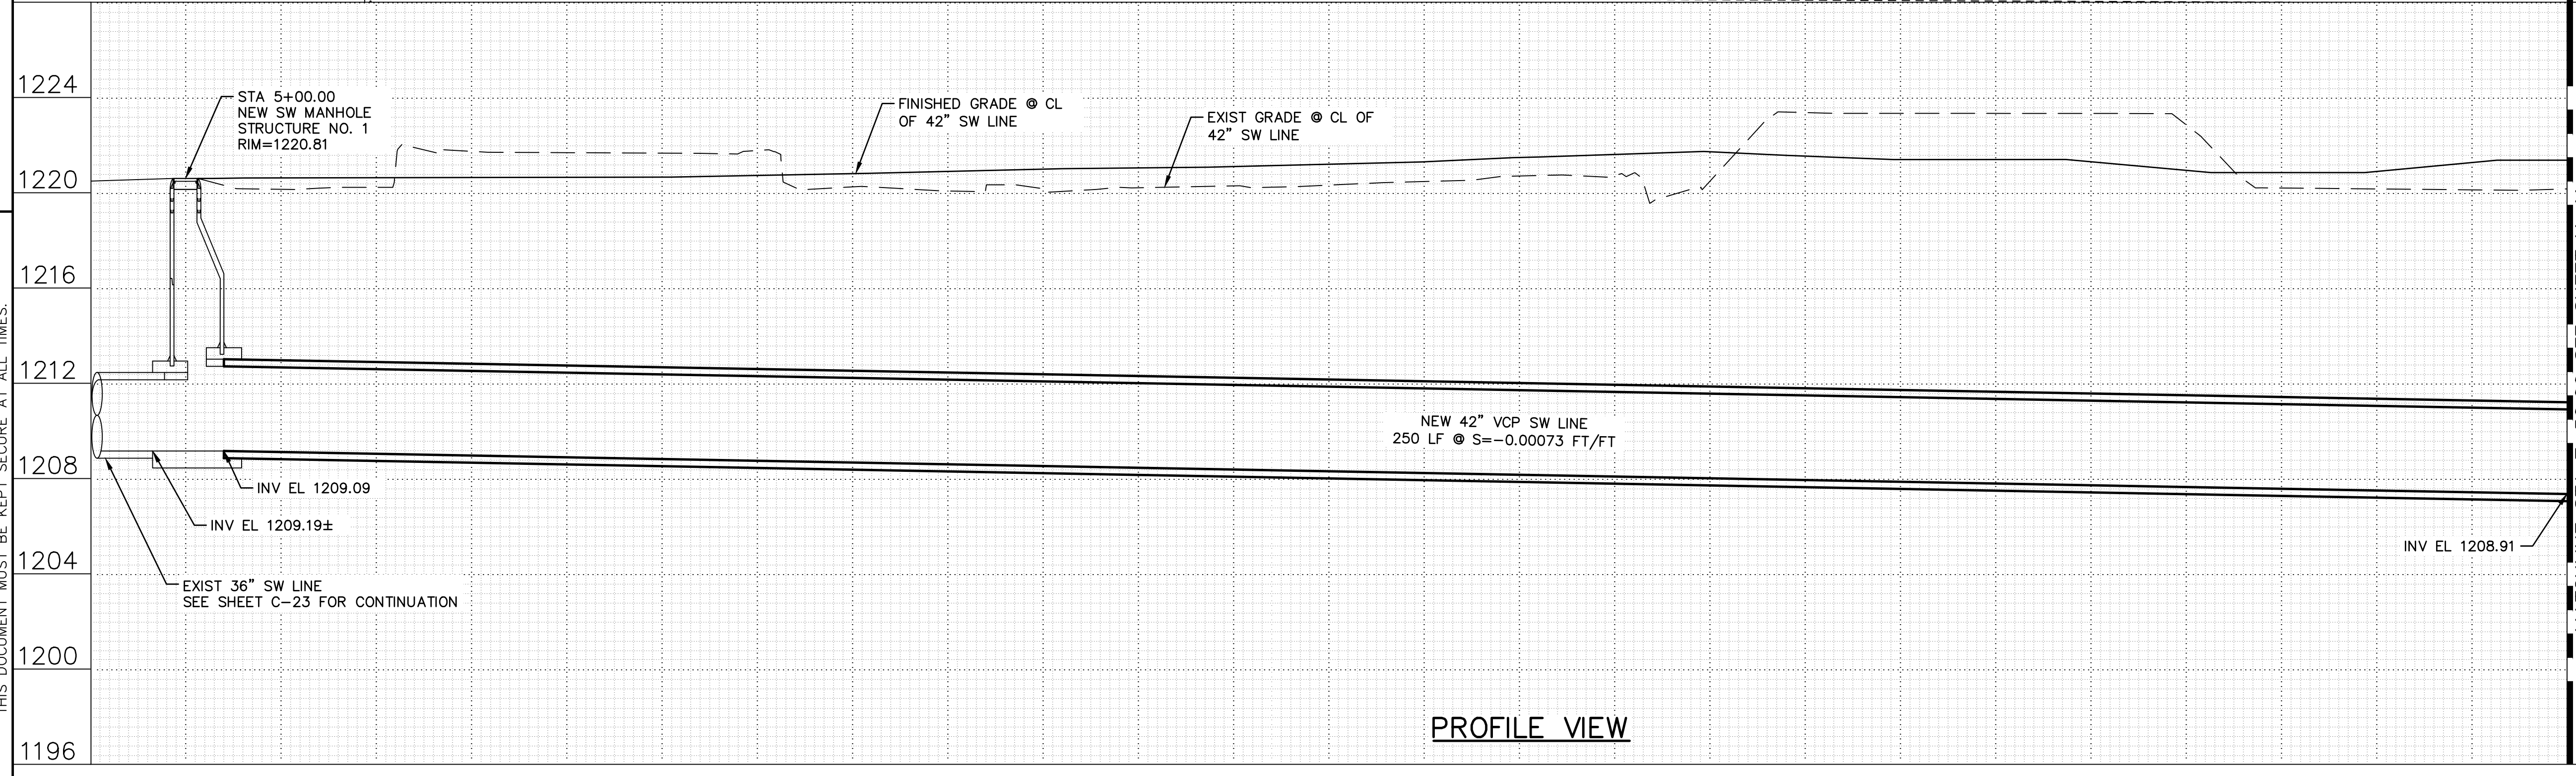


PROFILE VIEW

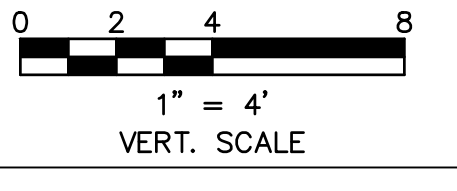


MATCHLINE STA 7+50.00 SEE SHEET M-11

FACILITY DRAWINGS  
This drawing was prepared by a Consultant Engineer from a part based on information provided by the Contractor to provide the Record Drawing. The City does not warrant this drawing to be a complete and accurate portrayal of facilities as they exist in the field.

NO.	DATE	BY	DESCRIPTION	REVISION	DWG NUMBER	REMARKS

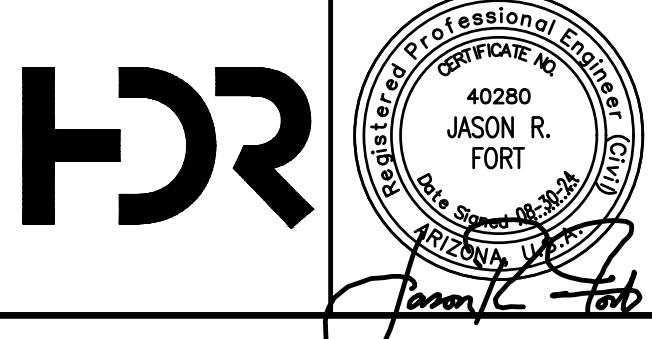

NO.	BY	DATE	CKD	REVISIONS	REMARKS
A	RS	10/2023	JF	30% SUBMITTAL	
B	RS	01/2024	JF	90% SUBMITTAL	
C	RS	04/2024	JF	AGENCY REVIEW	
D	DFD	08/2024	JF	ISSUED FOR CONSTRUCTION	

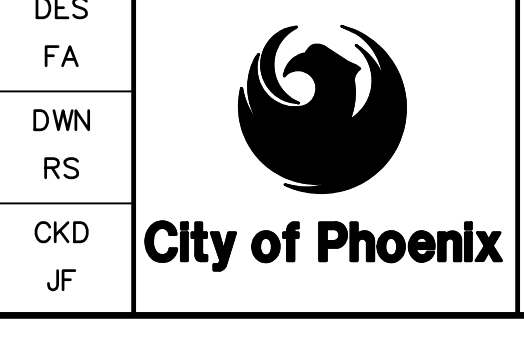

CITY OF PHOENIX  
WATER SERVICES DEPARTMENT  
  
LIFT STATION 40  
REFURBISHMENT

MECHANICAL  
  
LS 42" SW LINE PLAN AND PROFILE  
STA 5+00.00 TO 7+50.00  
SHEET 1 OF 2



COPYRIGHT © 2007-JANUARY  
CITY PROJECT NO. WS90400085  
DATE: 08/2024  
M-10 SHEET 46 OF 134  
CAD FILE: CSMLS40P04.dwg

USER: FIDES\FR\AUG FILE: C:\pwworking\west01\03411829\46\_CSMLS40P04.dwg DATE: 9/04/24 TIME: 03:25pm



THIS DRAWING MUST BE FIELD VERIFIED BEFORE USE  
DRAWING NOT TO SCALE UNLESS SCALE BAR IS PRESENT

FOR CONSTRUCTION


"PER CITY OF PHOENIX CODE CHAPTER 2, SECTION 2-28, THESE PLANS ARE FOR OFFICIAL USE ONLY AND MAY NOT BE SHARED WITH OTHERS EXCEPT AS REQUIRED TO FULFILL THE OBLIGATIONS OF THE CONTRACTOR'S CONTRACT. THIS DOCUMENT MUST BE KEPT SECURE AT ALL TIMES."

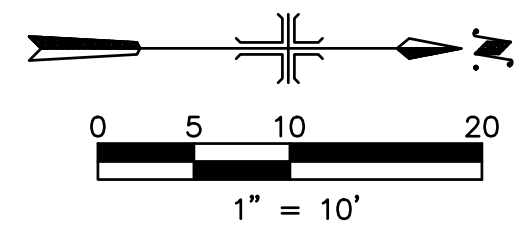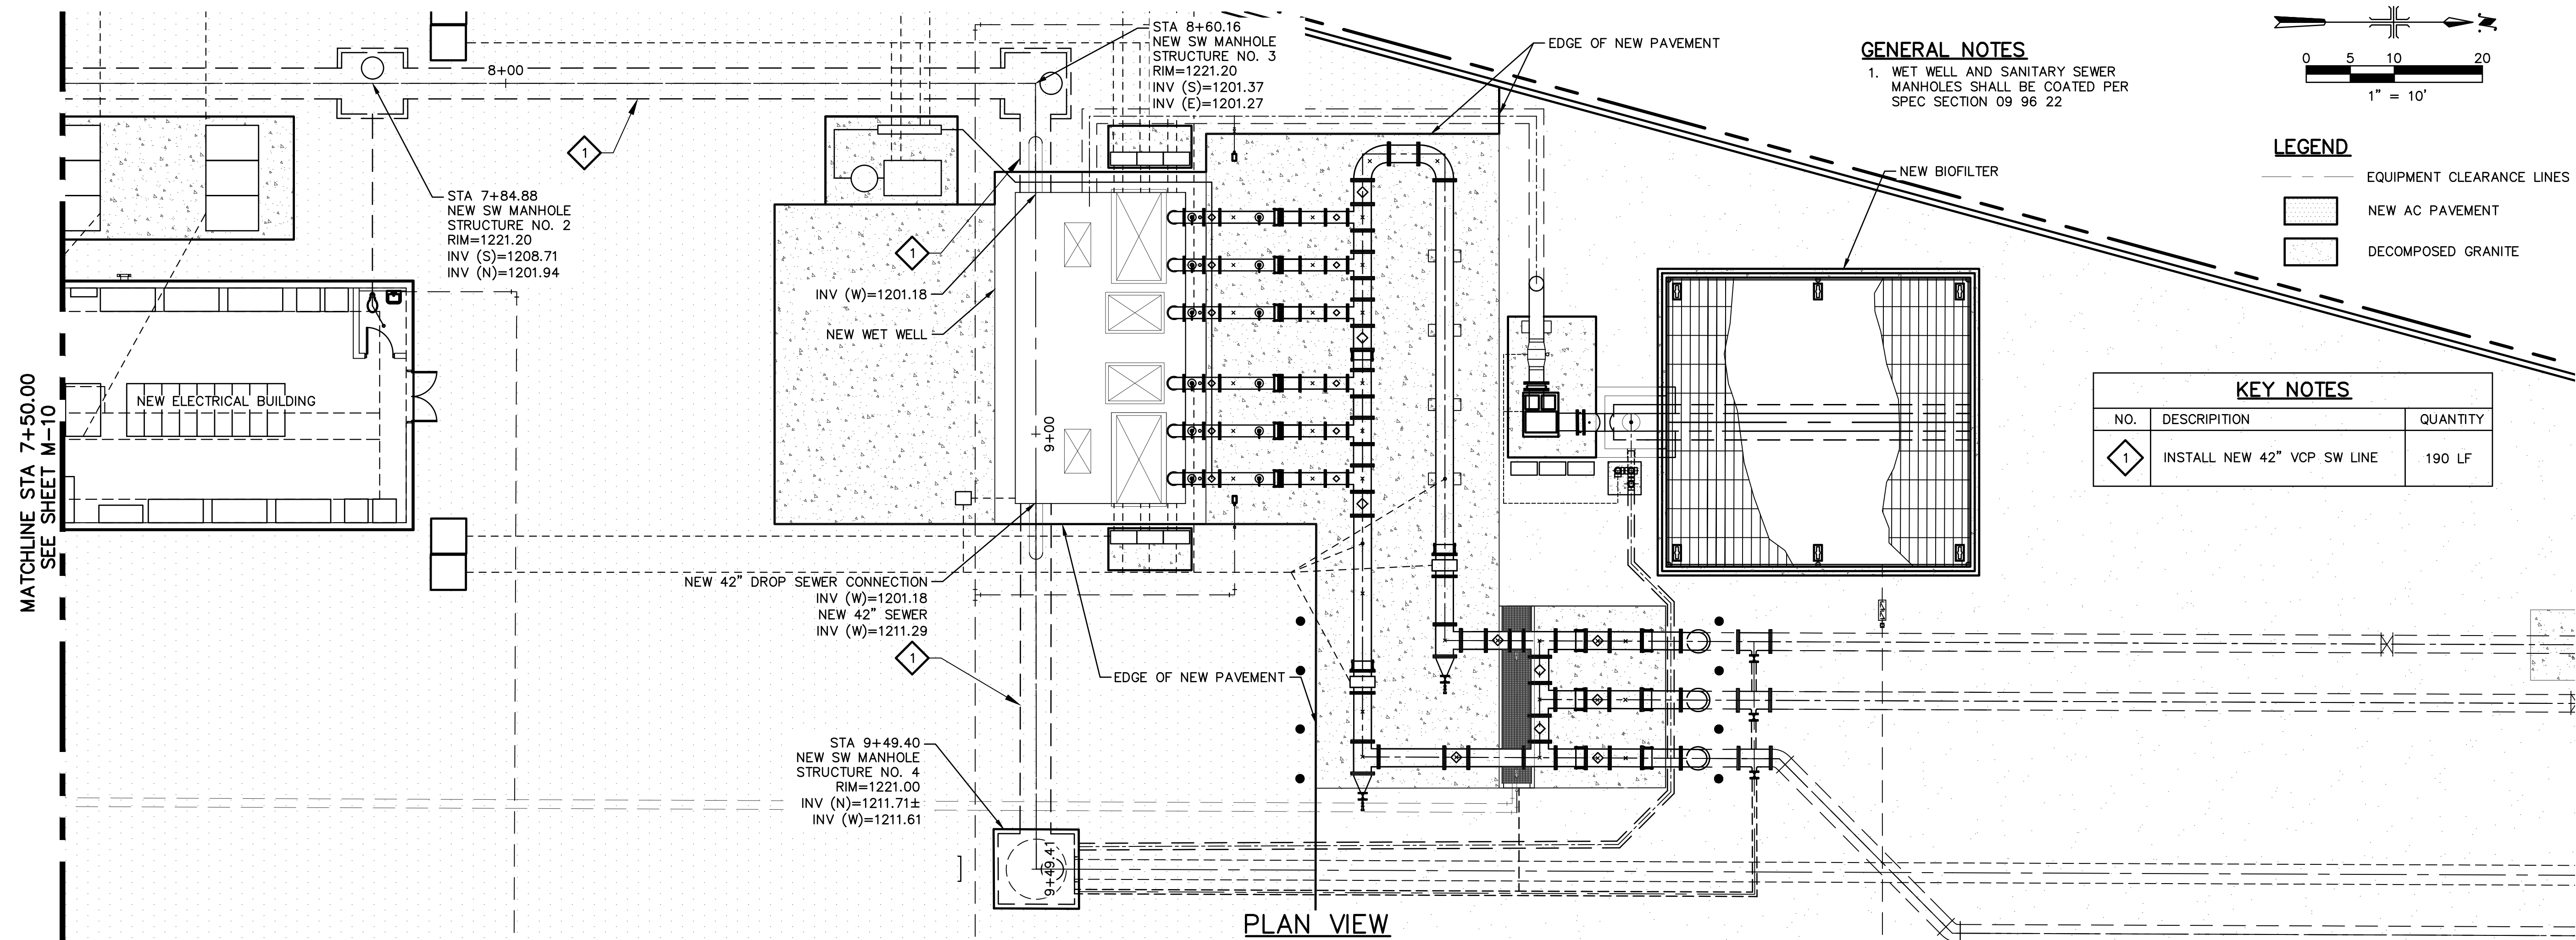

FACILITY DRAWINGS  
This drawing was prepared by a Consultant Engineer from a plan based on information provided by the Contractor to provide a complete and accurate portrayal of facilities as they exist in the field.  
The City does not warrant this drawing to be a complete and accurate portrayal of facilities as they exist in the field.

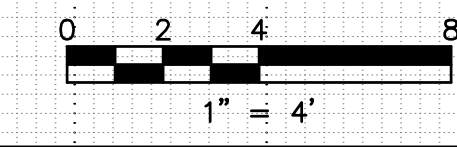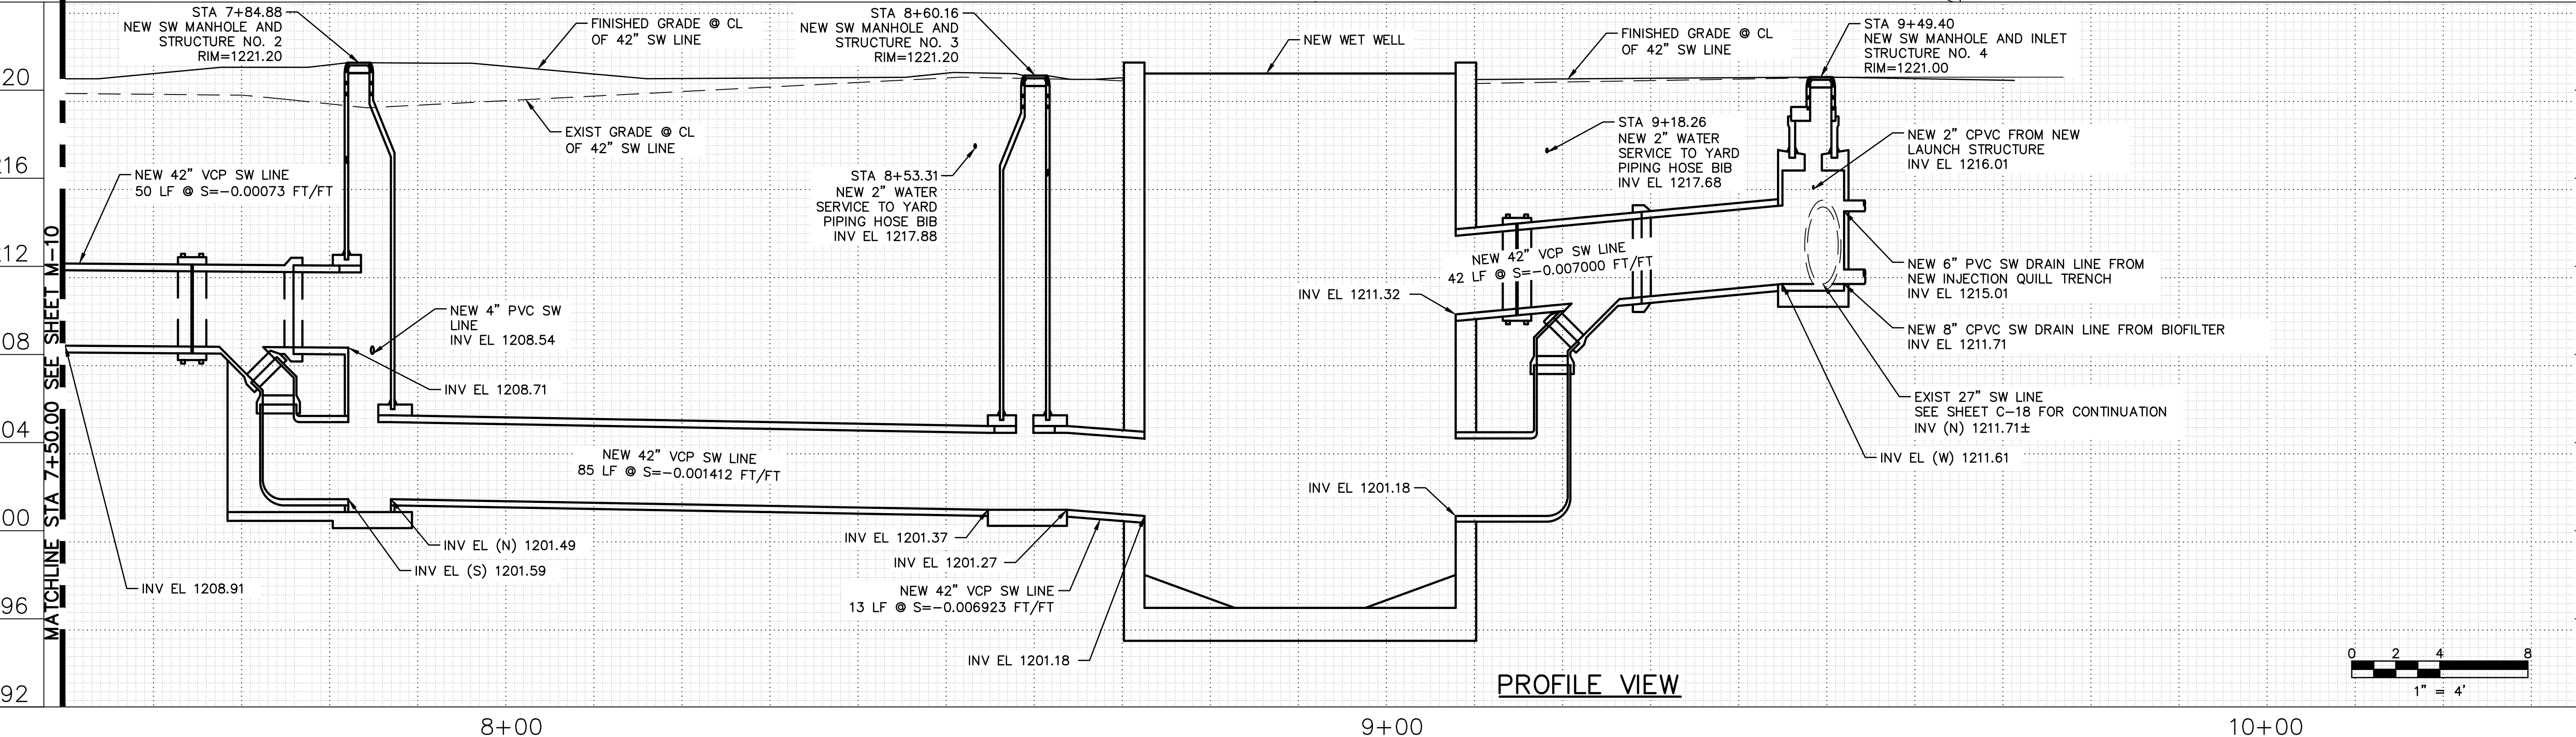


NO.	DESCRIPTION	QUANTITY	DWG NUMBER	REMARKS
1	INSTALL NEW 42" VCP SW LINE	190 LF		

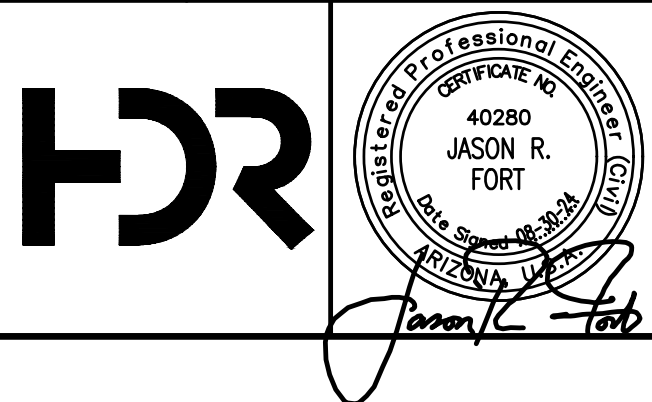

NO.	BY	DATE	CKD	REVISIONS	REMARKS
A	RS	10/2023	JF	30% SUBMITTAL	
B	RS	01/2024	JF	90% SUBMITTAL	
C	RS	04/2024	JF	AGENCY REVIEW	
D	DFD	08/2024	JF	ISSUED FOR CONSTRUCTION	

DES	FA	DWN	RS	CKD	JF

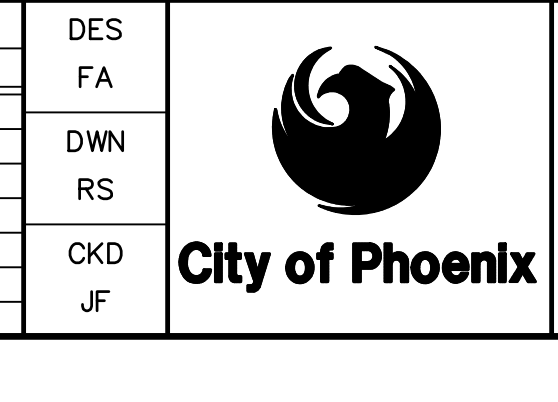

CITY OF PHOENIX  
WATER SERVICES DEPARTMENT  
LIFT STATION 40  
REFURBISHMENT


MECHANICAL  
LS 42" SW LINE PLAN AND PROFILE  
STA 7+50.00 TO 9+49.41  
SHEET 2 OF 2

COPYRIGHT © 2007-JANUARY  
CITY PROJECT NO. WS90400085  
DATE: 08/2024  
M-11 SHEET 47 OF 134  
CAD FILE: CSMLS40P05.dwg

THIS DRAWING MUST BE FIELD VERIFIED BEFORE USE. DRAWING NOT TO SCALE UNLESS SCALE BAR IS PRESENT.

**FOR CONSTRUCTION**

"PER CITY OF PHOENIX CODE CHAPTER 2, SECTION 2-28, THESE PLANS ARE FOR OFFICIAL USE ONLY AND MAY NOT BE SHARED WITH OTHERS EXCEPT AS REQUIRED TO FULFILL THE OBLIGATIONS OF THE CONTRACTOR'S CONTRACT WITH THE CITY OF PHOENIX." THIS DOCUMENT MUST BE KEPT SECURE AT ALL TIMES.

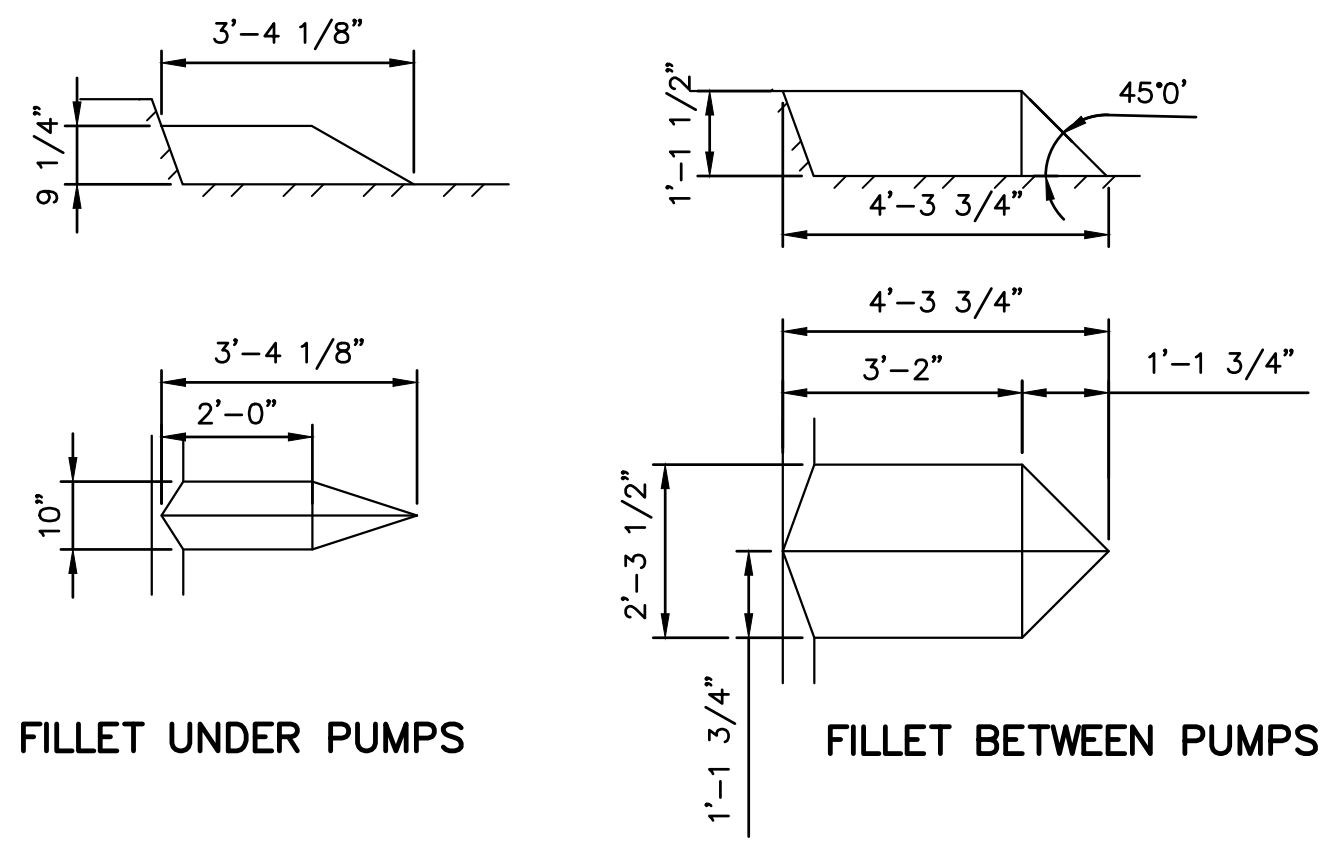

**KEY NOTES**


- 3 GUIDE RAIL BRACKET PER MANUFACTURERS RECOMMENDATIONS.
- 4 RESTRAINED DISMANTLING JOINT.
- 5 16"x12" DIP REDUCER.
- 6 DISCHARGE PIPE BRACKET. SEE DETAIL 15 ON SHEET M-05.
- 7 5'x10.5' EQUIPMENT HATCH (TYPICAL 2). SEE STRUCTURAL PLANS AND SPEC. SECTION 08 31 00 FOR ADDITIONAL DETAILS.
- 8 SUBMERSIBLE PUMP.
- 9 42" VCP SEWER PIPE.

**KEY NOTES (CON'T)**

- 11 12" DISCHARGE INLET TO A 16" DISCHARGE OUTLET CONNECTION PER FLYGT STANDARD CP/NP DISCHARGE CONNECTION (CAST IRON) PUMP MODEL 3312, PART NUMBER 442 16 05.
- 12 SLEEVE INSTALLATION THROUGH CONCRETE SLAB. SEE DETAIL 11 M-12 M-04
- 13 ADJUSTABLE PIPE SUPPORT. SEE DETAIL 1 M-12 M-02
- 14 ULTRASONIC LEVEL TRANSMITTERS (TYPICAL 2). ULTRASONIC LEVEL TRANSDUCERS SHALL BE INSTALLED WITH FACE PARALLEL TO THE WATER SURFACE. DISTANCE BELOW THE WET WELL TOP SLAB SHOULD BE PER MANUFACTURER'S RECOMMENDATIONS.
- 15 3'X5' HATCH TO ACCESS LEVEL TRANSMITTERS. (TYPICAL 2). SEE STRUCTURAL PLANS AND SPEC. SECTION 08 31 00 FOR DETAILS.
- 16 NEW 20" FRP FAD. BURIED DUCT SHALL BE ABLE TO WITHSTAND ASSHTO 16,000 LB. SINGLE AXLE LOADS. PIPE INVERT ELEVATION = 1214.83 SEE SHEET C-24 FOR CONTINUATION.
- 17 NEW 3" COMBINATION AIR/VACUUM RELEASE VALVE. SEE DETAIL 2 M-12 M-02
- 18 NEW WET-WELL LEVEL TRANSMITTER SUPPORT. SEE DETAIL 12 M-12 C-04
- 20 NEW PRESSURE GAUGE AND TRANSMITTER. SEE DETAIL 6 M-12 M-03
- 21 NEW 18" DIP WET WELL VENT. SEE SECTION 10 ON SHEET M-15.


**GENERAL NOTES**

1. SEE STRUCTURAL PLANS FOR WET WELL FLOOR, WALL AND ROOF THICKNESS.
2. REFER TO GRADING AND DRAINAGE PLANS, SEE SHEETS C-25 AND C-26 FOR FINISHED FLOOR ELEVATIONS.
3. WET WELL SHALL BE COATED PER SPEC SECTION 09 96 22

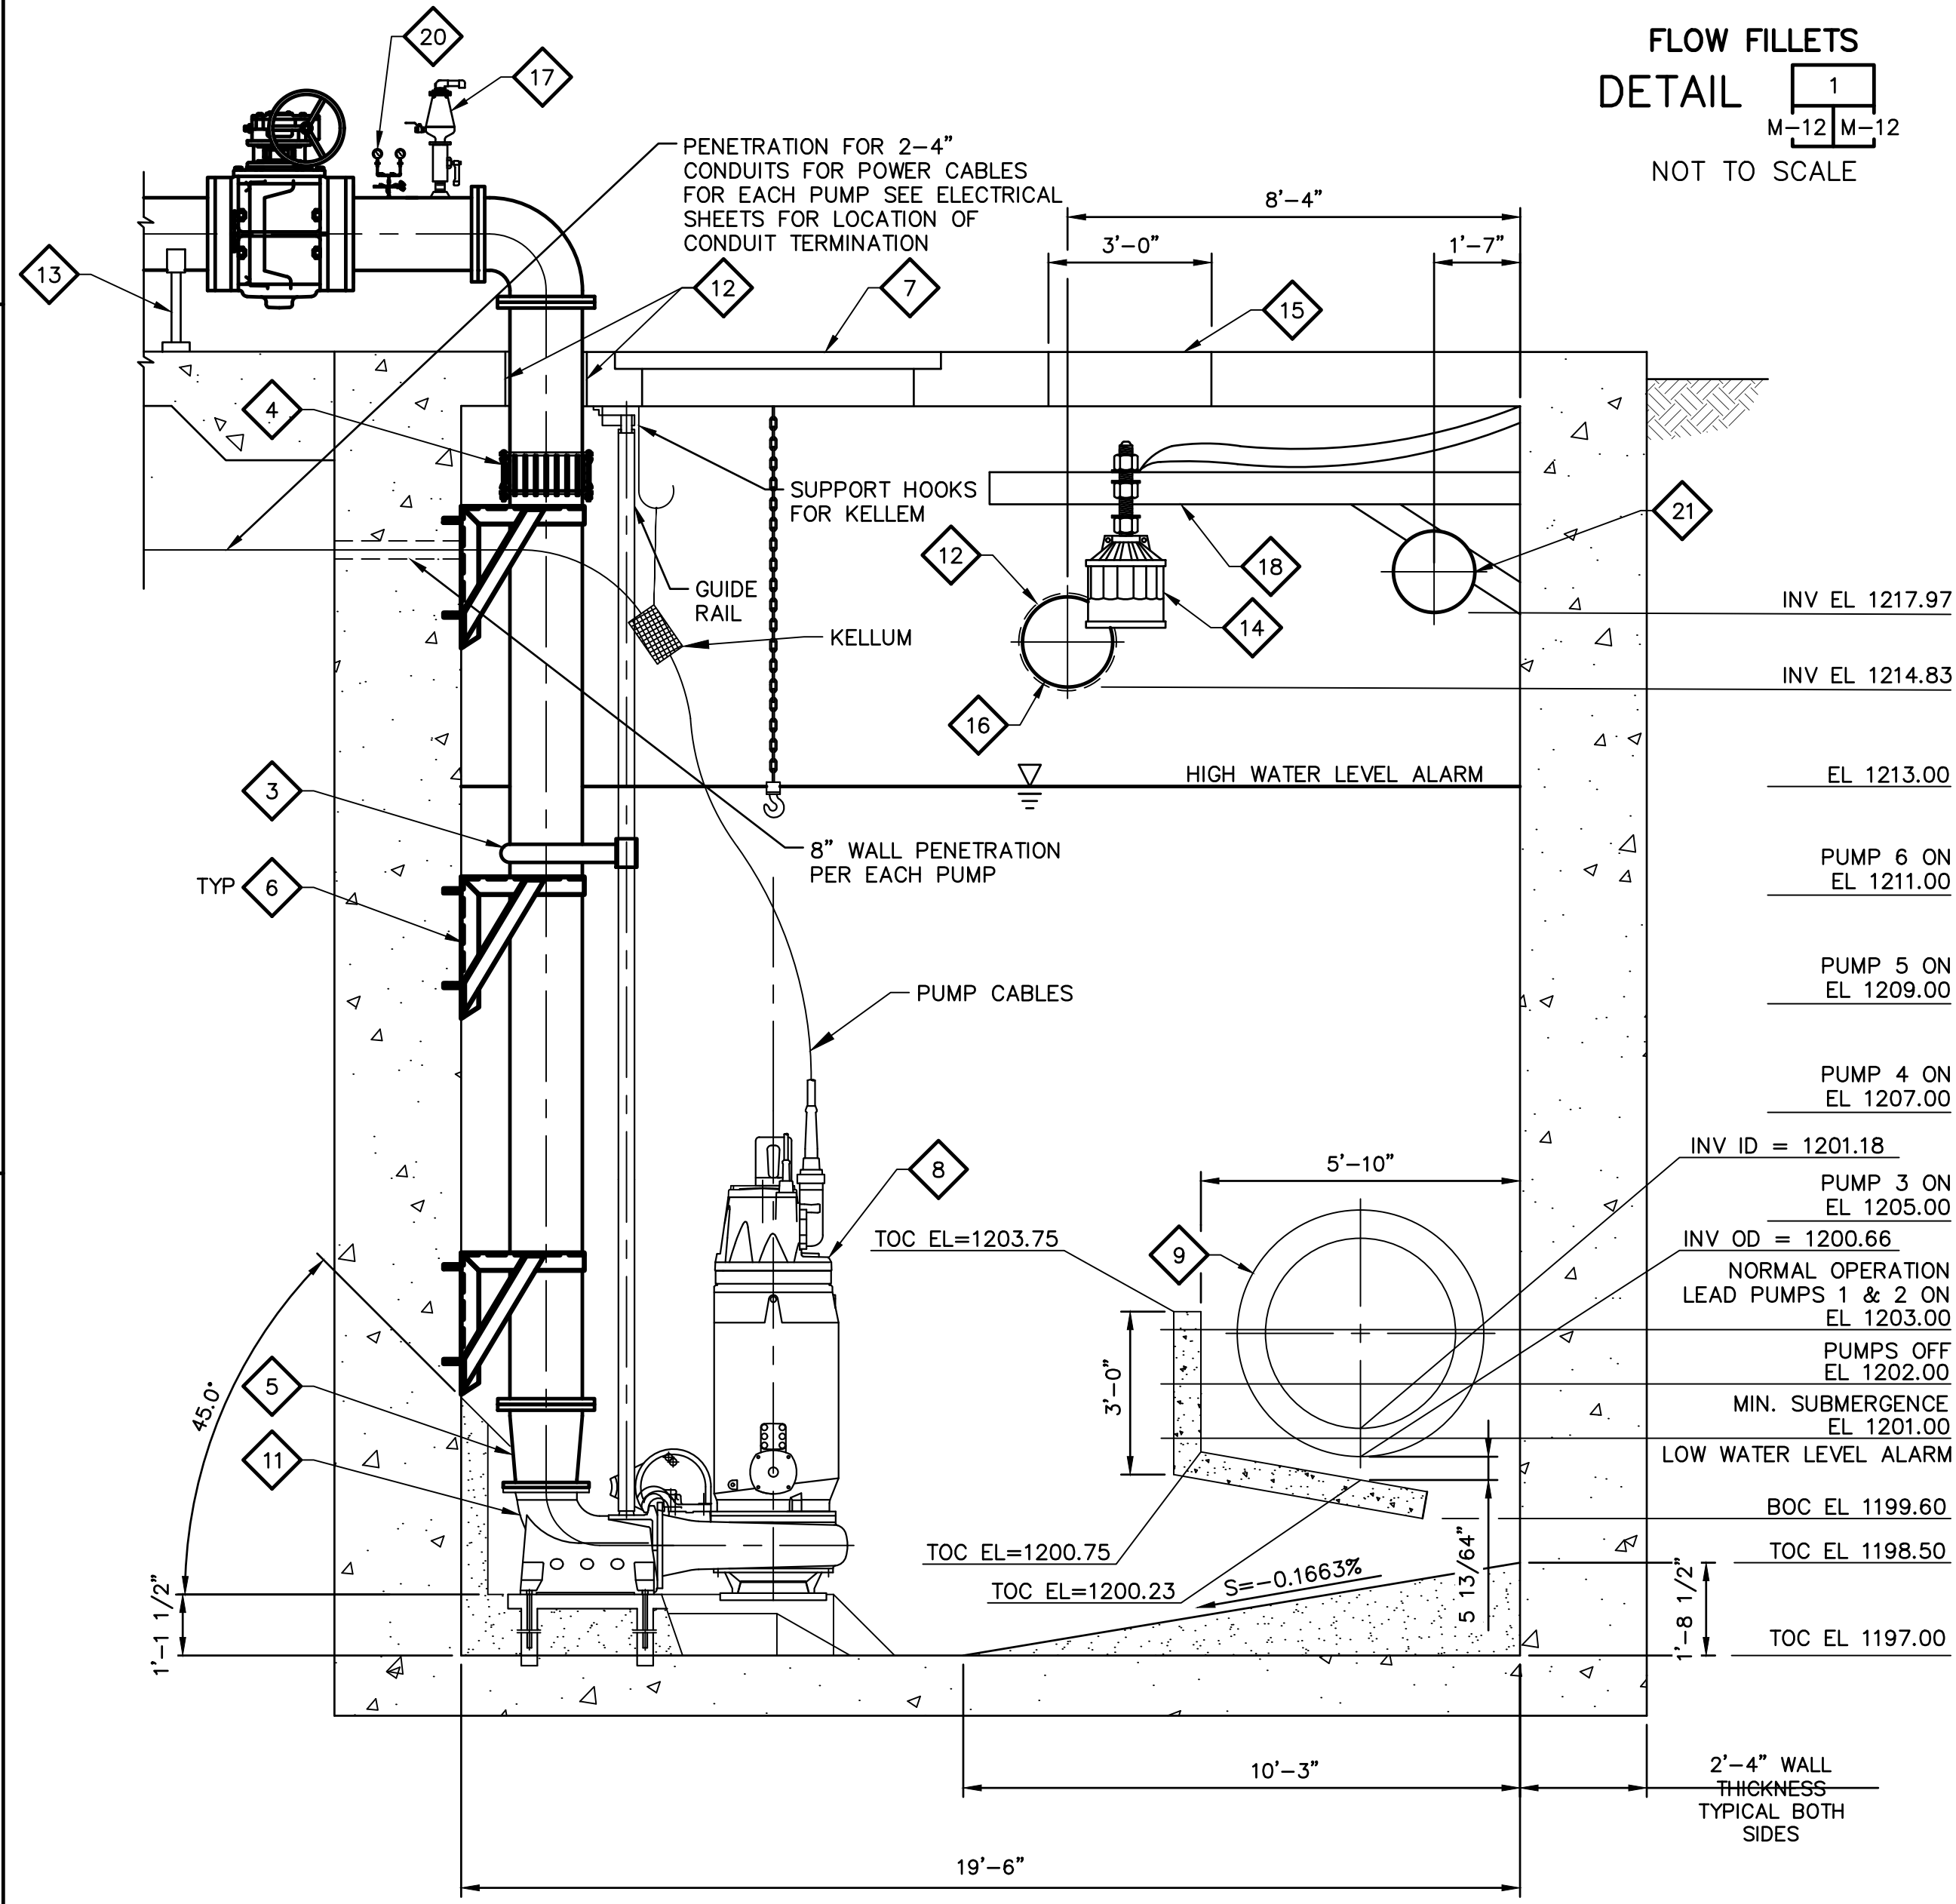


**GENERAL WET WELL NOTE**

1. THE WET WELL IS PROTECTED AGAINST CORROSION AT LEAST A 20-YEAR OPERATIONAL LIFE.

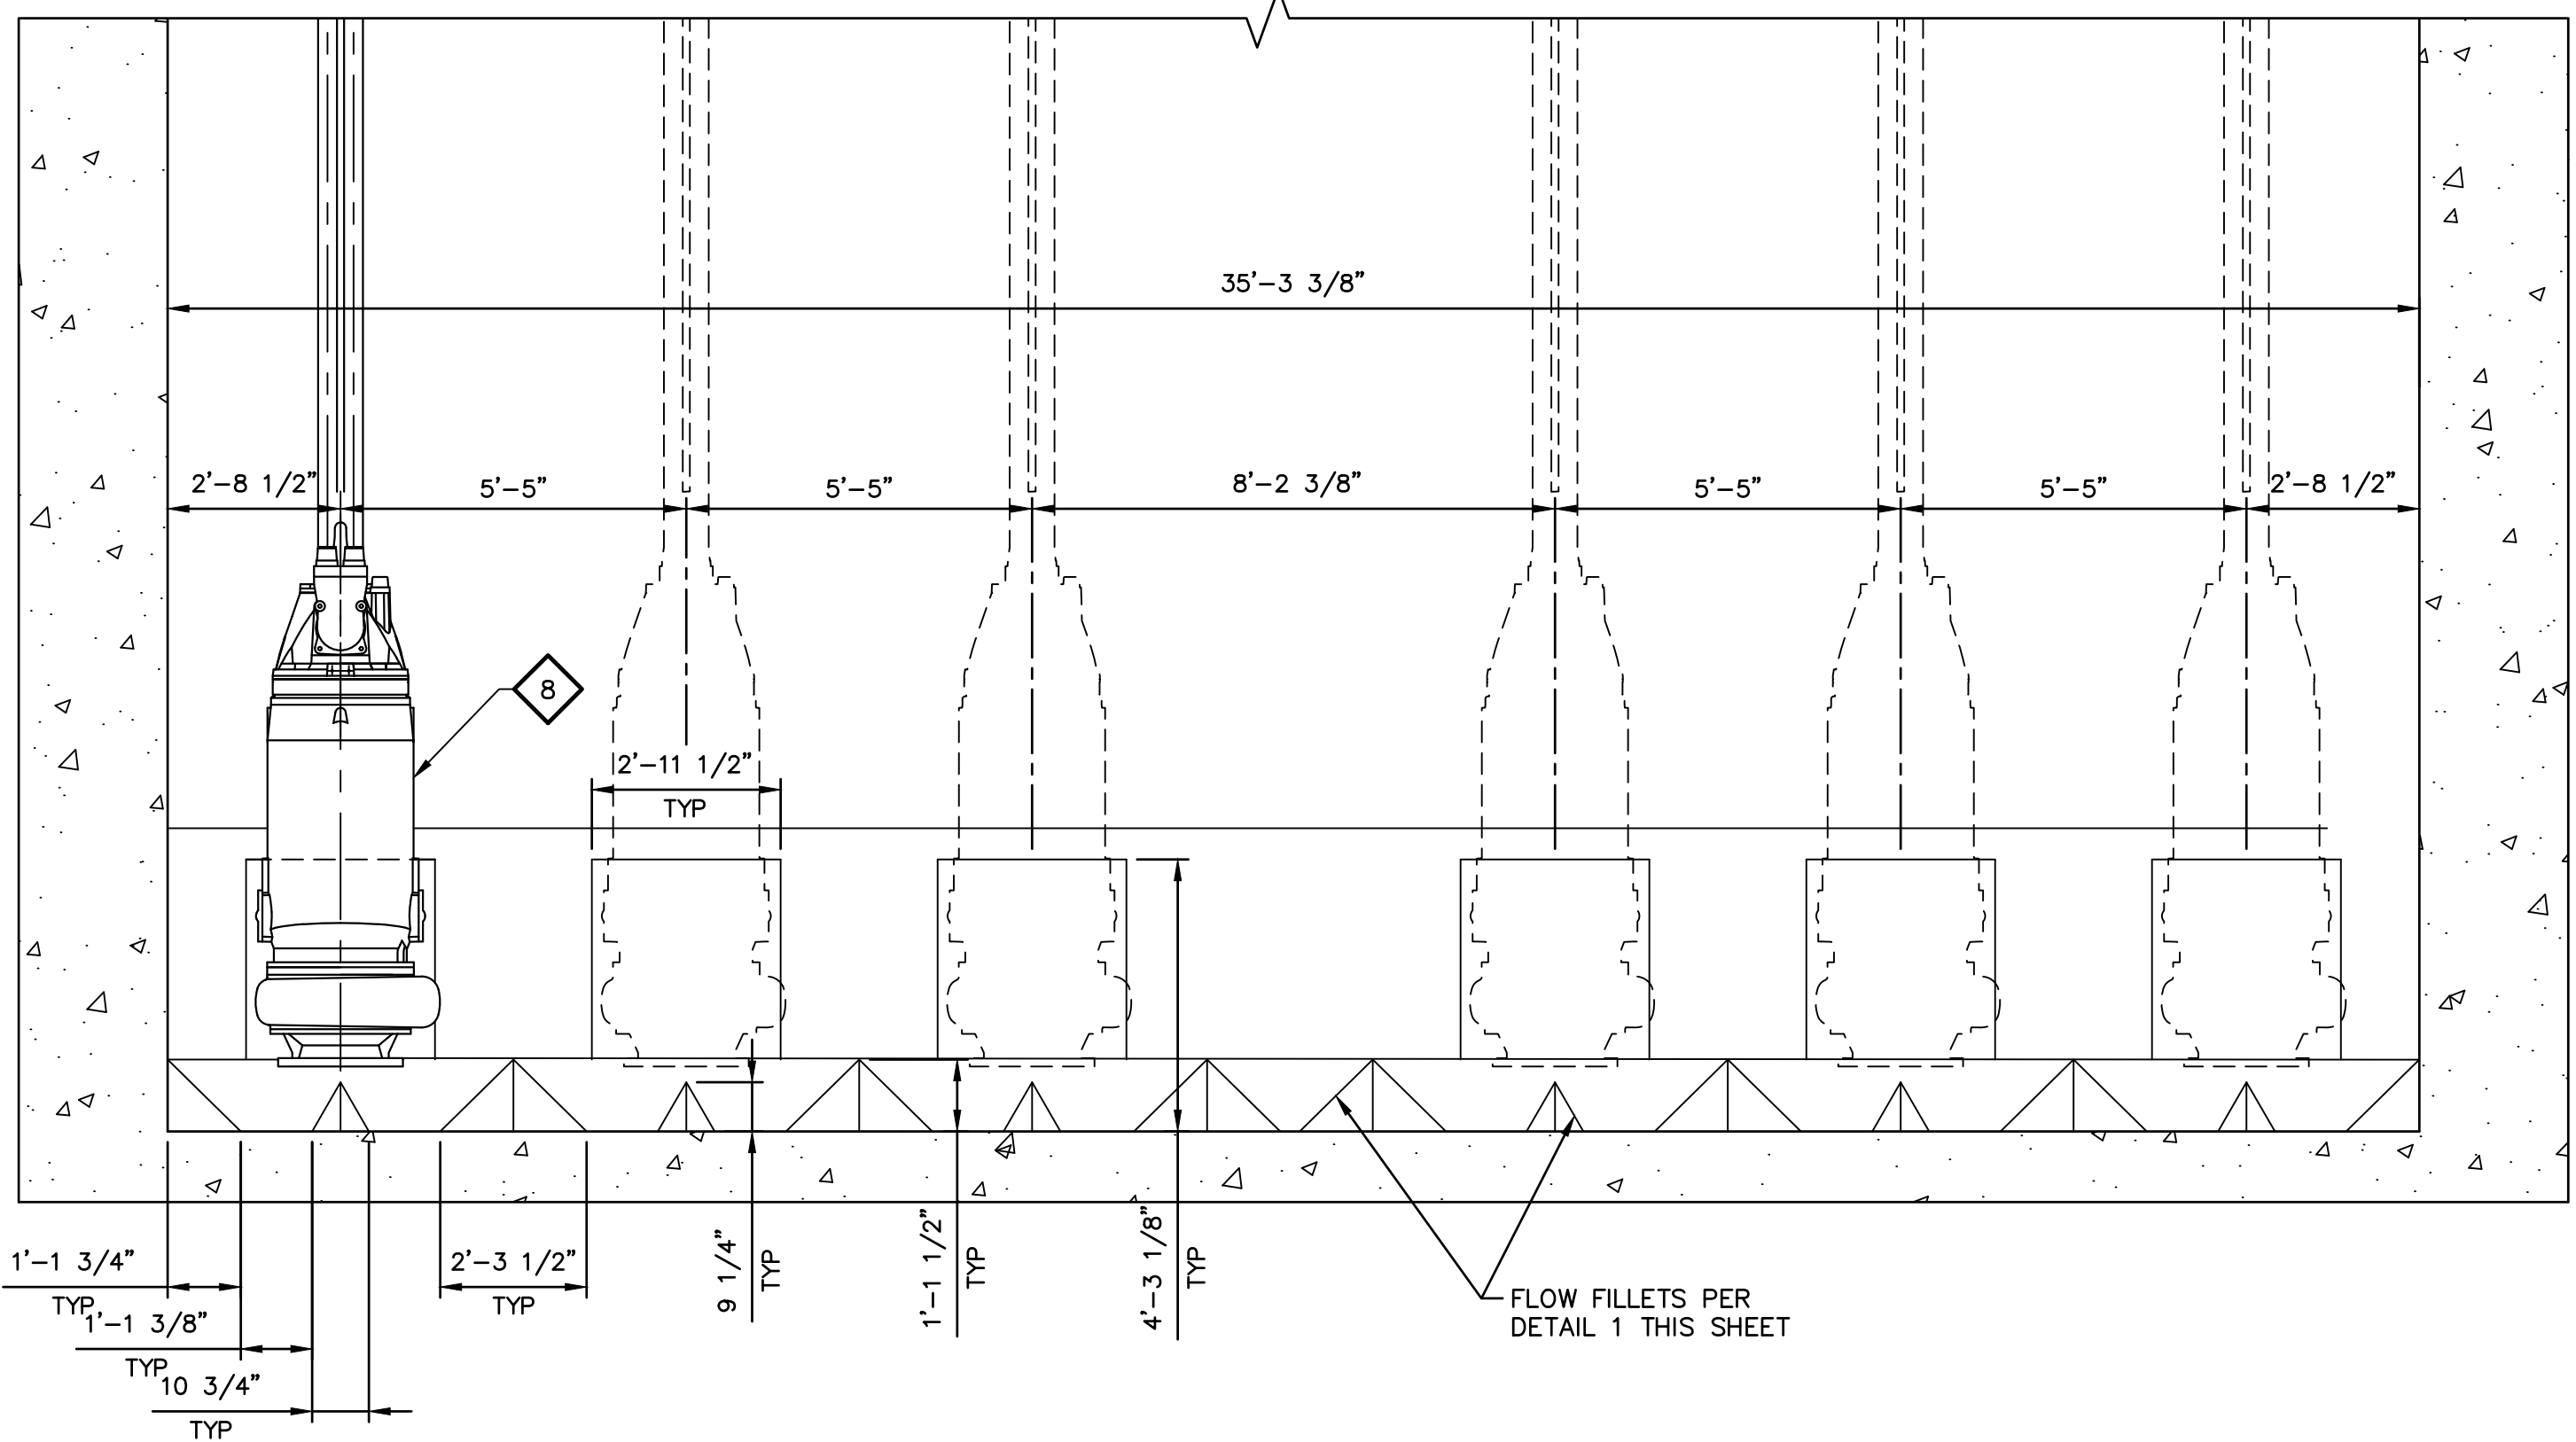

FACILITY DRAWINGS  
 This drawing was supplied by a Consultant Engineer from a past project. The Consultant Engineer is not responsible for the accuracy of the information provided by the Contractor to provide the Record Drawing. The City does not warrant this drawing to be a complete and accurate portrayal of facilities as they exist in the field.

REVISION	DATE	PROJECT NAME	PROJECT NO.	PROJECT NAME	DATE	CAD FILE NAME	DWG NUMBER	REMARKS

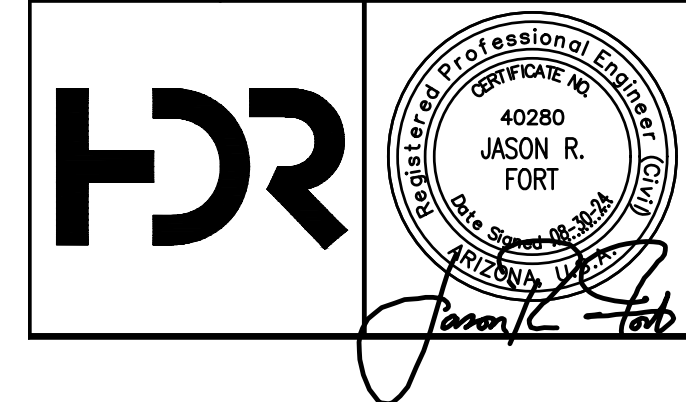

NO.	BY	DATE	CKD	REVISIONS	REMARKS
A	RS	10/2023	JF	30% SUBMITTAL	
B	RS	01/2024	JF	90% SUBMITTAL	
C	RS	04/2024	JF	AGENCY REVIEW	
D	DFD	08/2024	JF	ISSUED FOR CONSTRUCTION	

DES FS  
 DWN RS  
 CKD JF

CITY OF PHOENIX  
 WATER SERVICES DEPARTMENT

LIFT STATION 40  
 REFURBISHMENT

MECHANICAL

LS WET WELL SECTIONS 1 & 2

COPYRIGHT © 2007-JANUARY

CITY PROJECT NO. WS90400085

DATE: 08/2024

M-12 SHEET 48 OF 134

CAD FILE: CSMLS40Q01.dwg


USER: FBERASFRALD01\03411629\48\_CSMLS40Q01.dwg DATE: 9/04/24 TIME: 03:29pm




FOR CONSTRUCTION

THIS DRAWING MUST BE FIELD VERIFIED BEFORE USE. DRAWING NOT TO SCALE UNLESS SCALE BAR IS PRESENT.

"PER CITY OF PHOENIX CODE CHAPTER 2, SECTION 2-28, THESE PLANS ARE FOR OFFICIAL USE ONLY AND MAY NOT BE SHARED WITH OTHERS EXCEPT AS REQUIRED TO FULFILL THE OBLIGATIONS OF THE CONTRACTOR'S CONTRACT WITH THE CITY OF PHOENIX." THIS DOCUMENT MUST BE KEPT SECURE AT ALL TIMES.

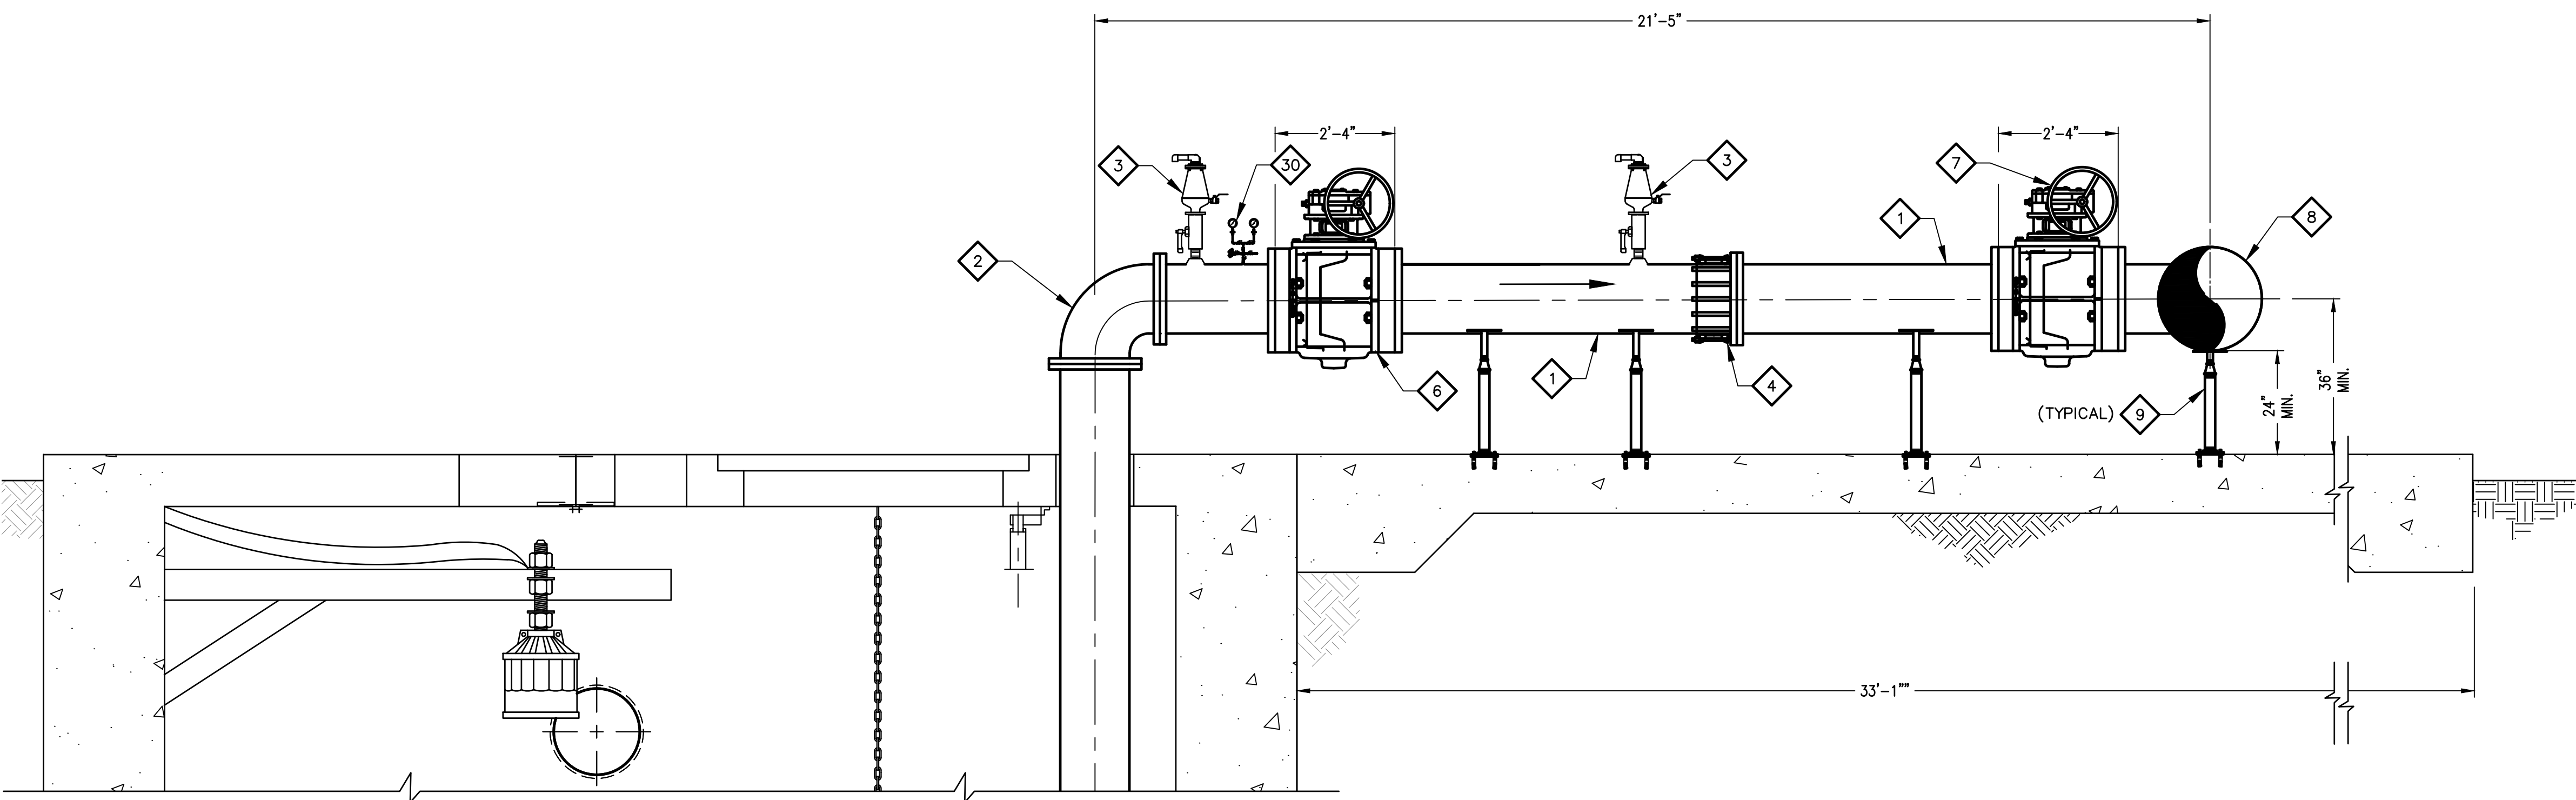

SECTION 3  
M-07 | M-13  
0 1 2 4  
1/2" = 1'-0"

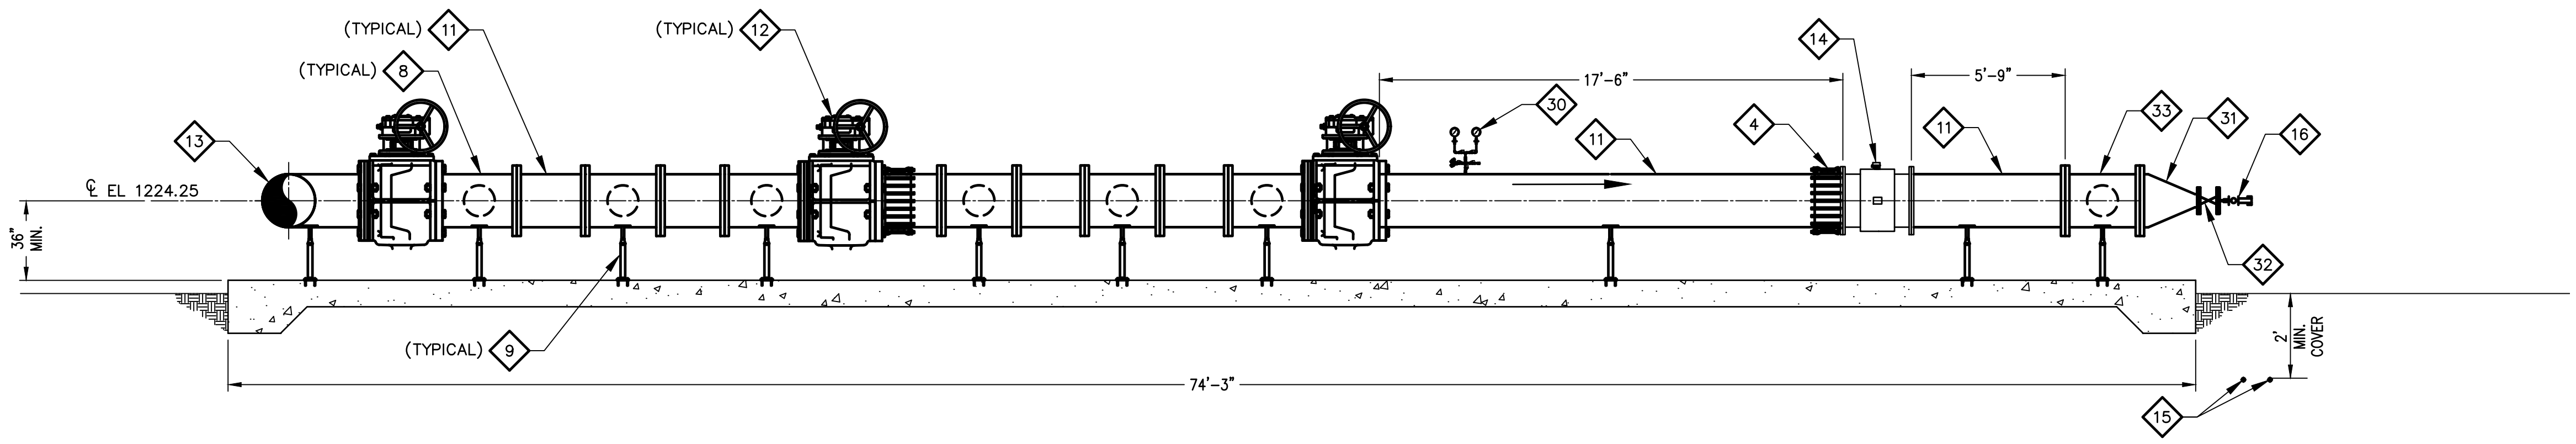

SECTION 4  
M-07 | M-13  
0 2 4 8  
1/4" = 1'-0"

**KEY NOTES**


- 1 16" CLASS 250 DIP PIPE.
- 2 16" - 90° BEND.
- 3 3" COMBO AIR/VACUUM RELEASE VALVE WITH DRAIN. SEE DETAIL M-13 M-02.
- 4 RESTRAINED DISMANTLING JOINT. ROMAC DJ400 OR APPROVED EQUAL.
- 5 PRESSURE GAUGE AND TRANSMITTER. SEE DETAIL M-13 M-03.
- 6 16" PLUG VALVE WITH PNEUMATIC ACTUATOR.
- 7 16" FULL PORT PLUG VALVE, EXTERNAL HAND WHEEL.
- 8 16"x24"x24" TEE.
- 9 ADJUSTABLE PIPE SUPPORT. SEE DETAIL M-13 M-02.
- 11 24" CLASS 250 DIP PIPE.
- 12 24" FULL PORT PLUG VALVE, EXTERNAL HAND WHEEL.
- 13 24" - 90° BEND.
- 14 24" INLINE MAGNETIC FLOW METER.
- 15 1" CPVC PIPING FROM THE CHEMICAL FEED PANEL. SEE SHEET C-23 AND C-24.
- 16 CAM-LOK CONNECTION.
- 30 PRESSURE SWITCH AND GAUGE. SEE DETAIL M-13 M-03.
- 31 24"x6" REDUCER.
- 32 6" PLUG VALVE.
- 33 24"x24"x24" TEE.

**GENERAL NOTES**


1. CONTRACTOR TO VERIFY LOCATION OF FORCE MAINS PRIOR TO CONSTRUCTION.
2. FOR CONCRETE SLAB THICKNESS AND DETAILS SEE STRUCTURAL PLANS.
3. REFER TO GRADING AND DRAINAGE PLANS, SEE SHEETS C-25 AND C-26 FOR FINISHED FLOOR ELEVATIONS.

FACILITY DRAWINGS  
This drawing was supplied by a Consultant Engineer from a past construction project. The Consultant Engineer is not responsible for construction information provided by the Contractor to provide the Record Drawing. The City does not warrant this drawing to be a complete and accurate portrayal of facilities as they exist in the field.

REVISION #	DATE	PROJECT NAME	DWG NUMBER	REMARKS

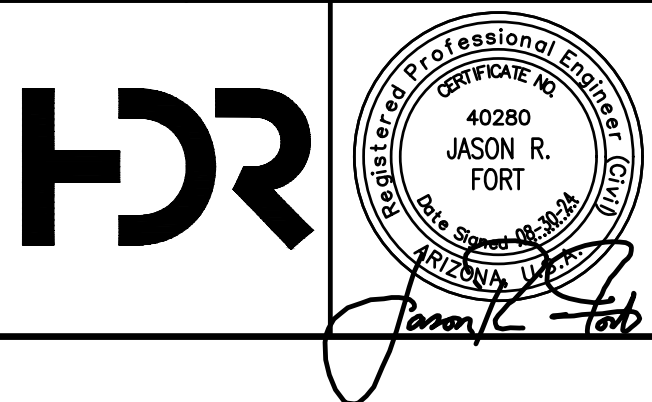

NO.	BY	DATE	CKD	REMARKS
A	RS	10/2023	JF	30% SUBMITTAL
B	RS	01/2024	JF	90% SUBMITTAL
C	RS	04/2024	JF	AGENCY REVIEW
D	DFD	08/2024	JF	ISSUED FOR CONSTRUCTION
*				
*				
*				

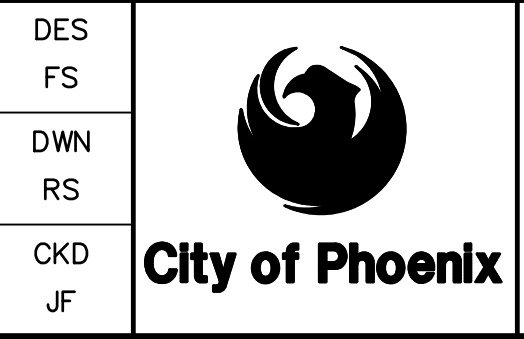

CITY OF PHOENIX  
WATER SERVICES DEPARTMENT  
  
LIFT STATION 40  
REFURBISHMENT

MECHANICAL  
  
LS YARD PIPING SECTIONS 3 & 4





COPYRIGHT © 2007-JANUARY  
CITY PROJECT NO. WS90400085  
DATE: 08/2024  
M-13 SHEET 49 OF 134  
CAD FILE: DSM4AB9Q02.DWG

USER: FBERASFRALD0 FILE: C:\pwworking\west01\03411629\49\_DSM4AB9Q02.dwg DATE: 9/04/24 TIME: 03:25pm

THIS DRAWING MUST BE FIELD VERIFIED BEFORE USE  
DRAWING NOT TO SCALE UNLESS SCALE BAR IS PRESENT

FOR CONSTRUCTION

"PER CITY OF PHOENIX CODE CHAPTER 2, SECTION 2-28, THESE PLANS ARE FOR OFFICIAL USE ONLY AND MAY NOT BE SHARED WITH OTHERS EXCEPT AS REQUIRED TO FULFILL THE OBLIGATIONS OF THE CONTRACTOR'S CONTRACT WITH THE CITY OF PHOENIX."  
THIS DOCUMENT MUST BE KEPT SECURE AT ALL TIMES.

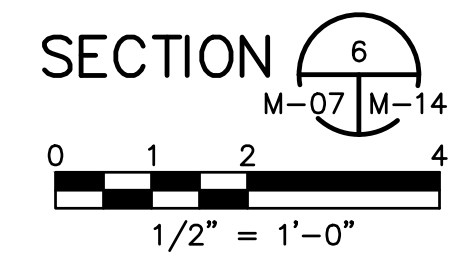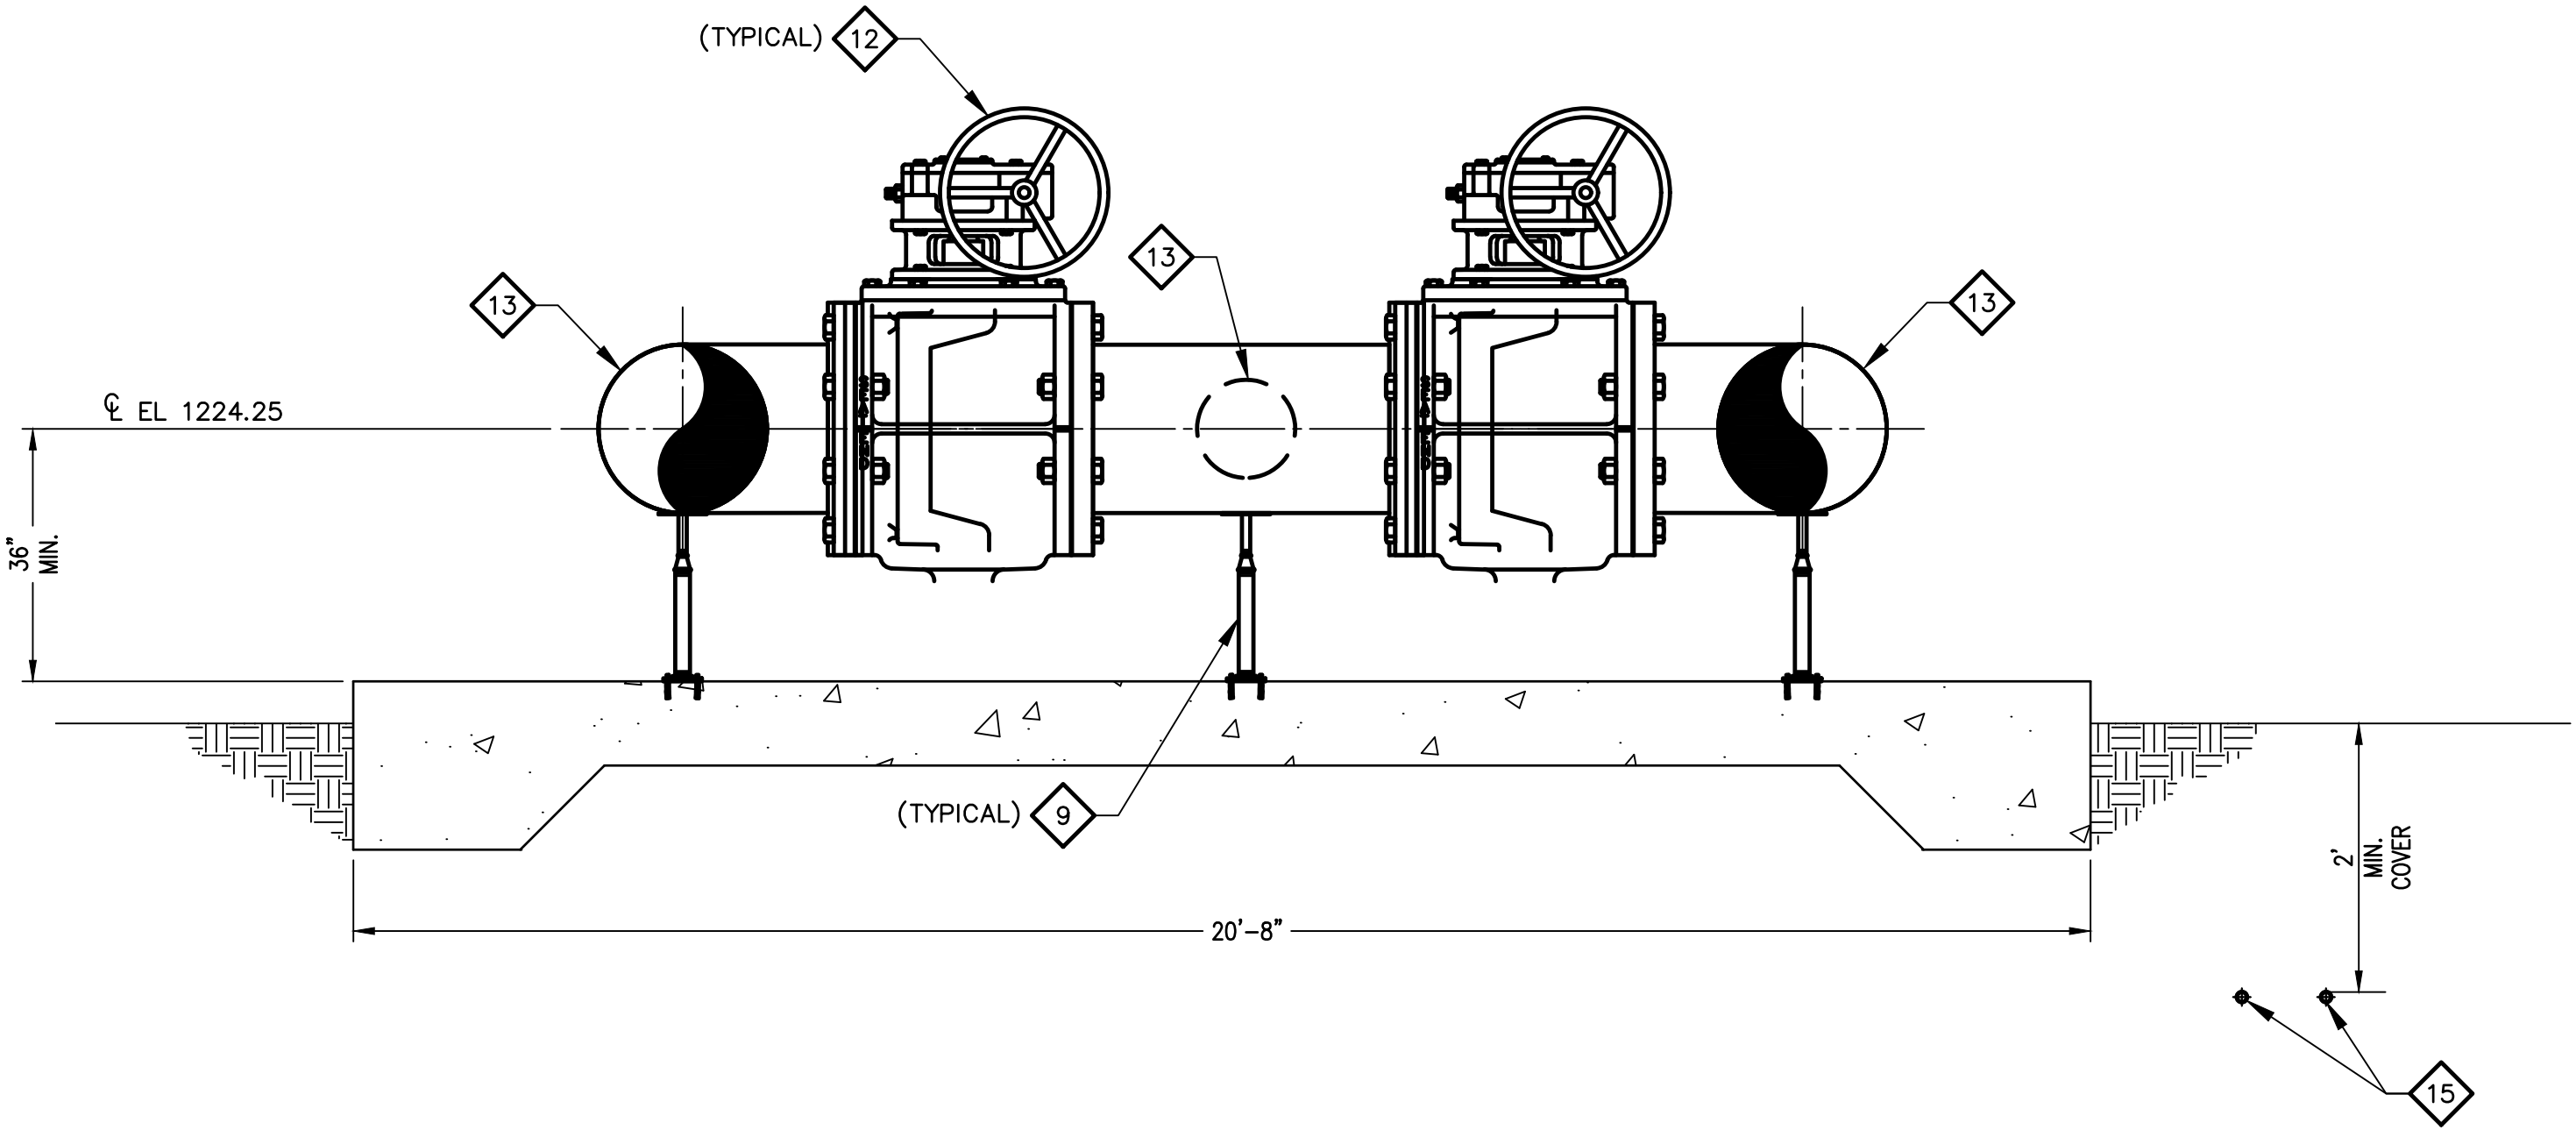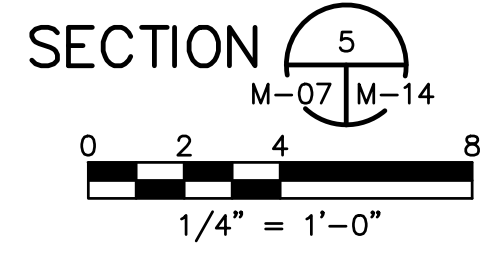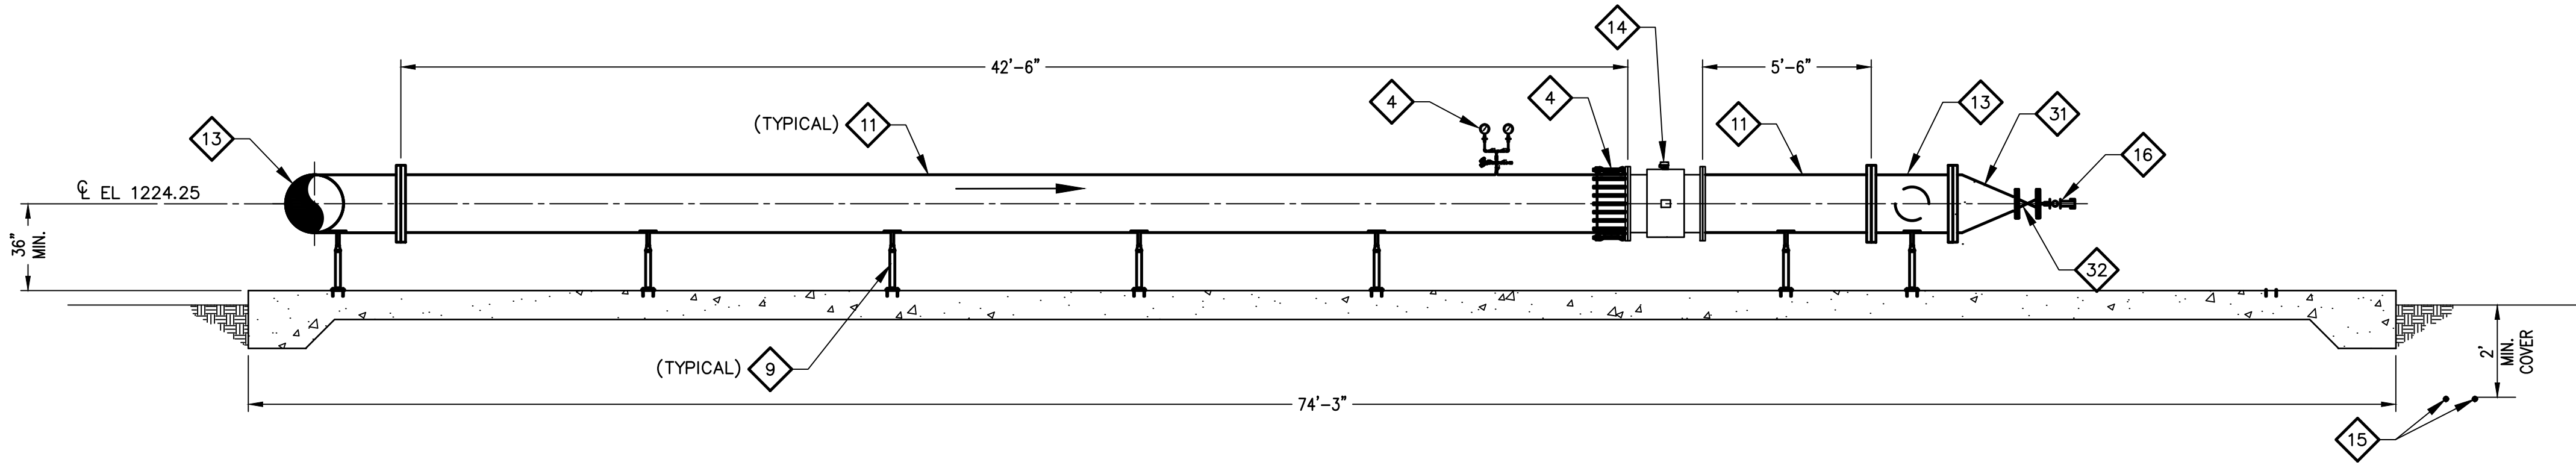

**KEY NOTES**


- 4 RESTRAINED DISMANTLING JOINT ROMAC DJ400 OR APPROVED EQUAL.
- 8 16" CLASS 250 DIP PIPE.
- 9 ADJUSTABLE PIPE SUPPORT.  
SEE DETAIL 1 .  
M-14 | M-02
- 11 24" CLASS 250 DIP PIPE.
- 12 24" FULL PORT PLUG VALVE, EXTERNAL HAND WHEEL.
- 13 24"X24"X24" TEE.
- 14 24" INLINE MAGNETIC FLOW METER.
- 15 1" CPVC PIPING FROM THE CHEMICAL FEED PANEL. SEE SHEET C-24 AND C-24.
- 16 CAM-LOK CONNECTION.
- 30 PRESSURE SWITCH AND GAUGE.  
SEE DETAIL 6 .  
M-14 | M-03
- 31 24"X6" REDUCER.
- 32 6" PLUG VALVE.

**GENERAL NOTES**


1. CONTRACTOR TO VERIFY LOCATION OF FORCE MAINS PRIOR TO CONSTRUCTION.
2. FOR CONCRETE SLAB THICKNESS AND DETAILS SEE STRUCTURAL PLANS.
3. REFER TO GRADING AND DRAINAGE PLANS, SEE SHEETS C-20 AND C-21 FOR FINISHED FLOOR ELEVATIONS.

FACILITY DRAWINGS  
 This drawing was supplied by a Consultant Engineer from a past project. The Consultant Engineer is not responsible for the accuracy of the information provided by the Contractor to provide the Record Drawing. The City does not warranty this drawing to be a complete and accurate portrayal of facilities as they exist in the field.

FOR CITY OF PHOENIX USE ONLY - REFERENCE CID NUMBER: #	PROJECT NO.	PROJECT NAME	DATE	CAD FILE NAME	DWG NUMBER	REMARKS

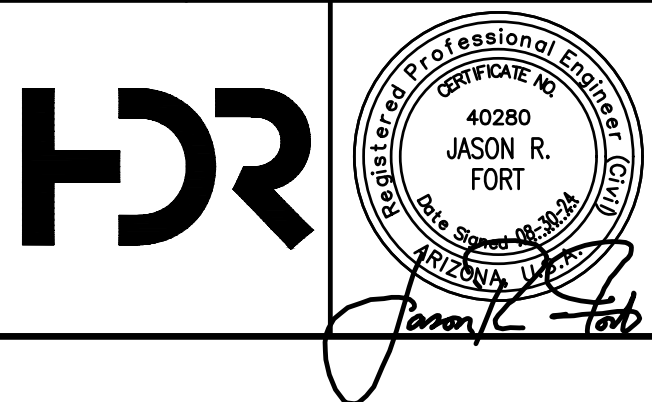

NO.	BY	DATE	CKD	REVISIONS	REMARKS
A	RS	10/2023	JF	30% SUBMITTAL	
B	RS	01/2024	JF	90% SUBMITTAL	
C	RS	04/2024	JF	AGENCY REVIEW	
D	FDF	08/2024	JF	ISSUED FOR CONSTRUCTION	
*					
*					
*					

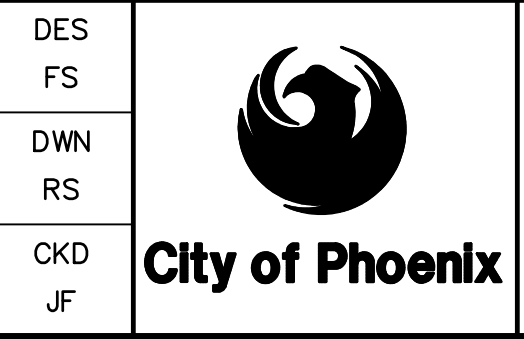

CITY OF PHOENIX  
WATER SERVICES DEPARTMENT  
  
LIFT STATION 40  
REFURBISHMENT

MECHANICAL  
  
LS YARD PIPING SECTIONS 5 & 6


COPYRIGHT © 2007-JANUARY  
CITY PROJECT NO. WS90400085  
DATE: 08/2024  
M-14 SHEET 50 OF 134  
CAD FILE: DSM4AB9Q03.DWG

USER: FBERASFRALD0 FILE: C:\pwworking\west01\03411629\50\_DSM4AB9Q03.dwg DATE: 9/04/24 TIME: 03:26pm


THIS DRAWING MUST BE FIELD VERIFIED BEFORE USE  
DRAWING NOT TO SCALE UNLESS SCALE BAR IS PRESENT

FOR CONSTRUCTION


"PER CITY OF PHOENIX CODE CHAPTER 2, SECTION 2-28, THESE PLANS ARE FOR OFFICIAL USE ONLY AND MAY NOT BE SHARED WITH OTHERS EXCEPT AS REQUIRED TO FULFILL THE OBLIGATIONS OF THE CONTRACTOR'S CONTRACT WITH THE CITY OF PHOENIX."  
THIS DOCUMENT MUST BE KEPT SECURE AT ALL TIMES.

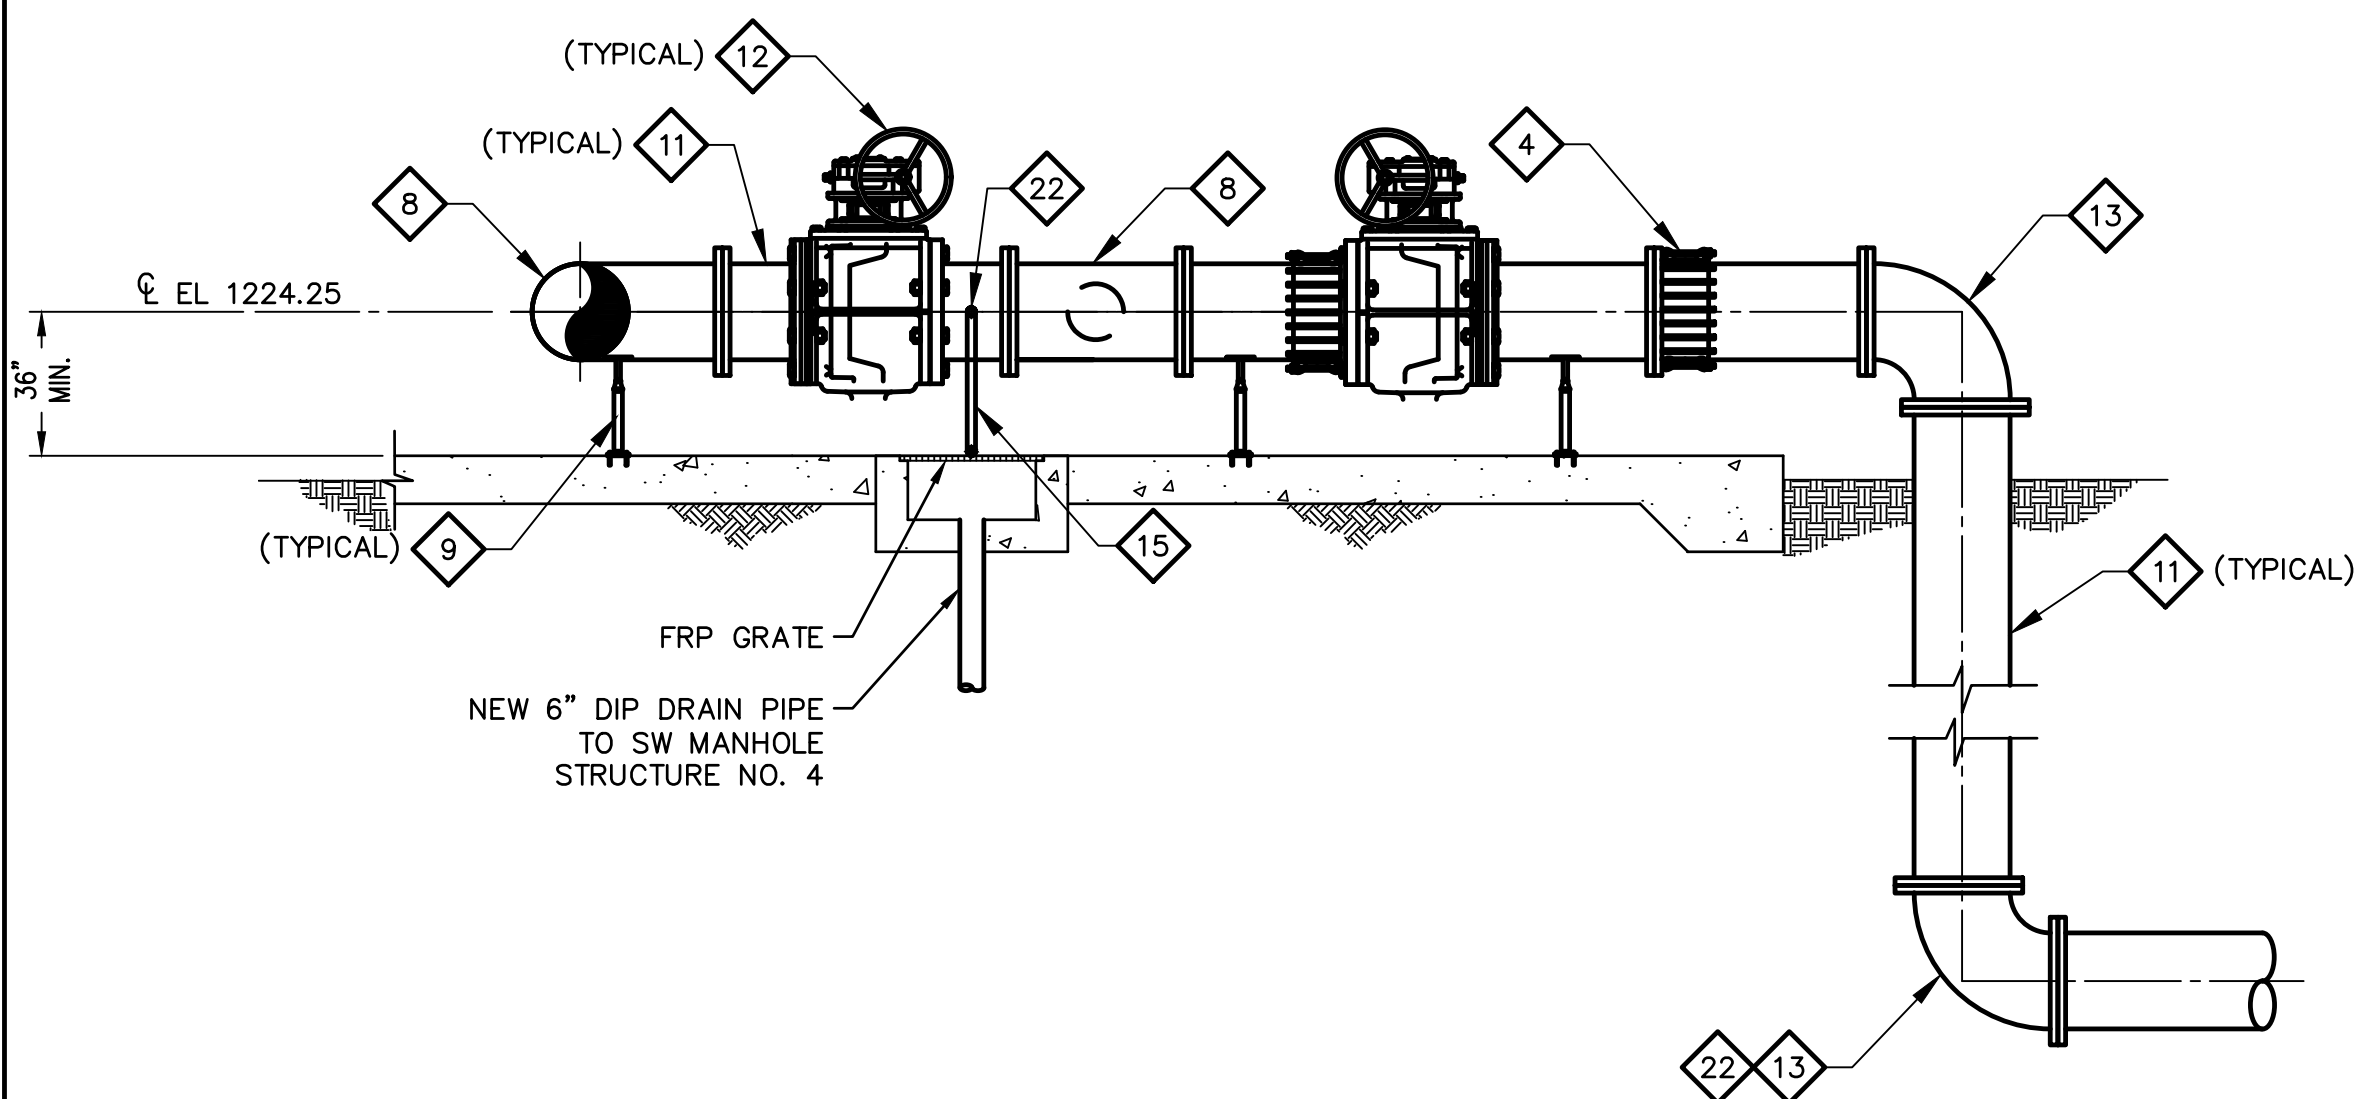


SECTION 7  
M-07 M-15  
0 2 4 8  
1/4" = 1'-0"

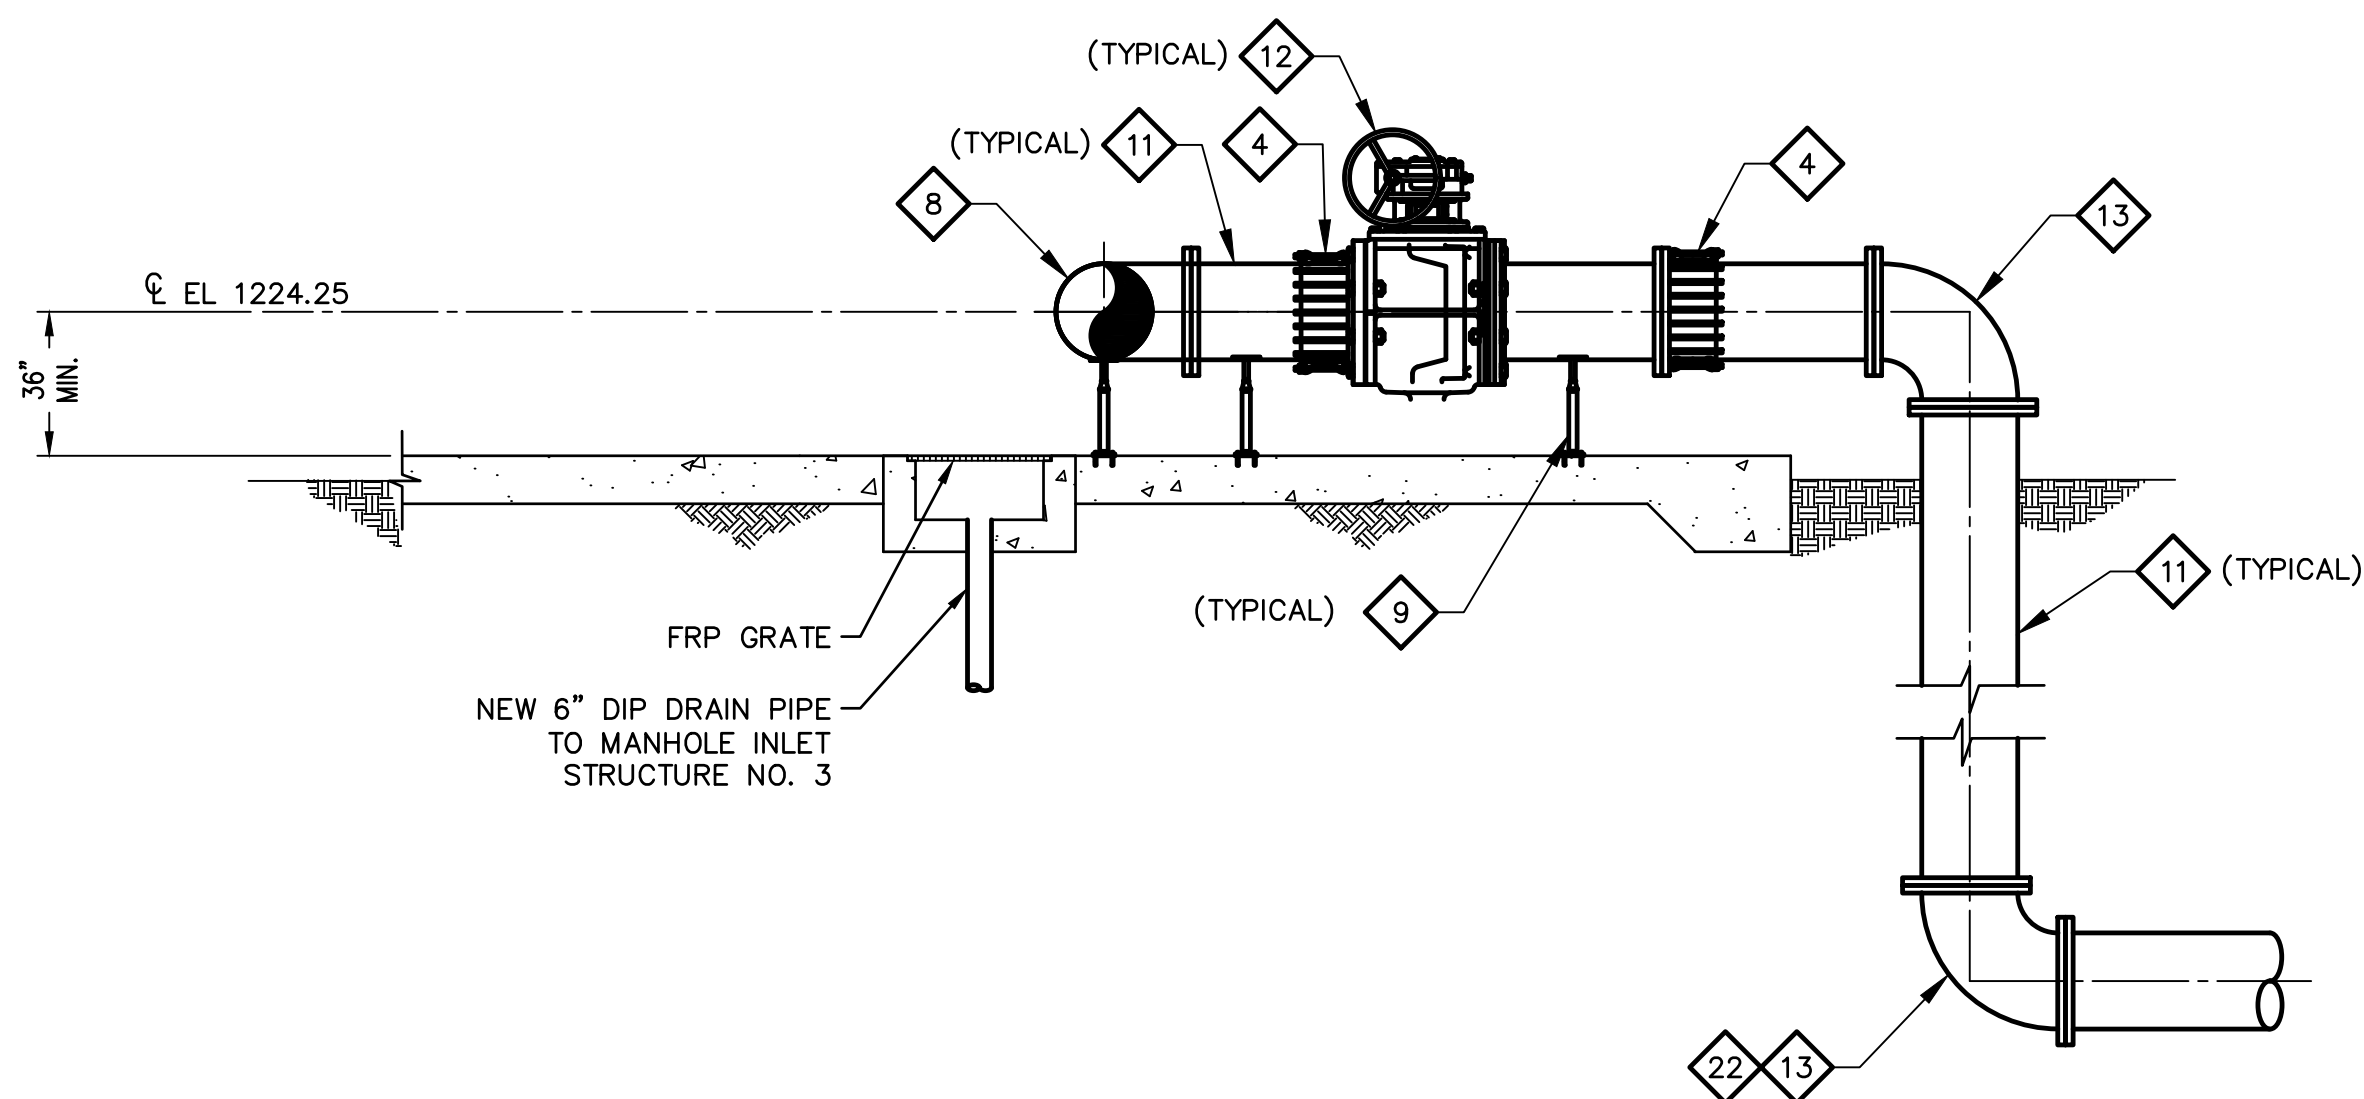

SECTION 8  
M-07 M-15  
0 2 4 8  
1/4" = 1'-0"

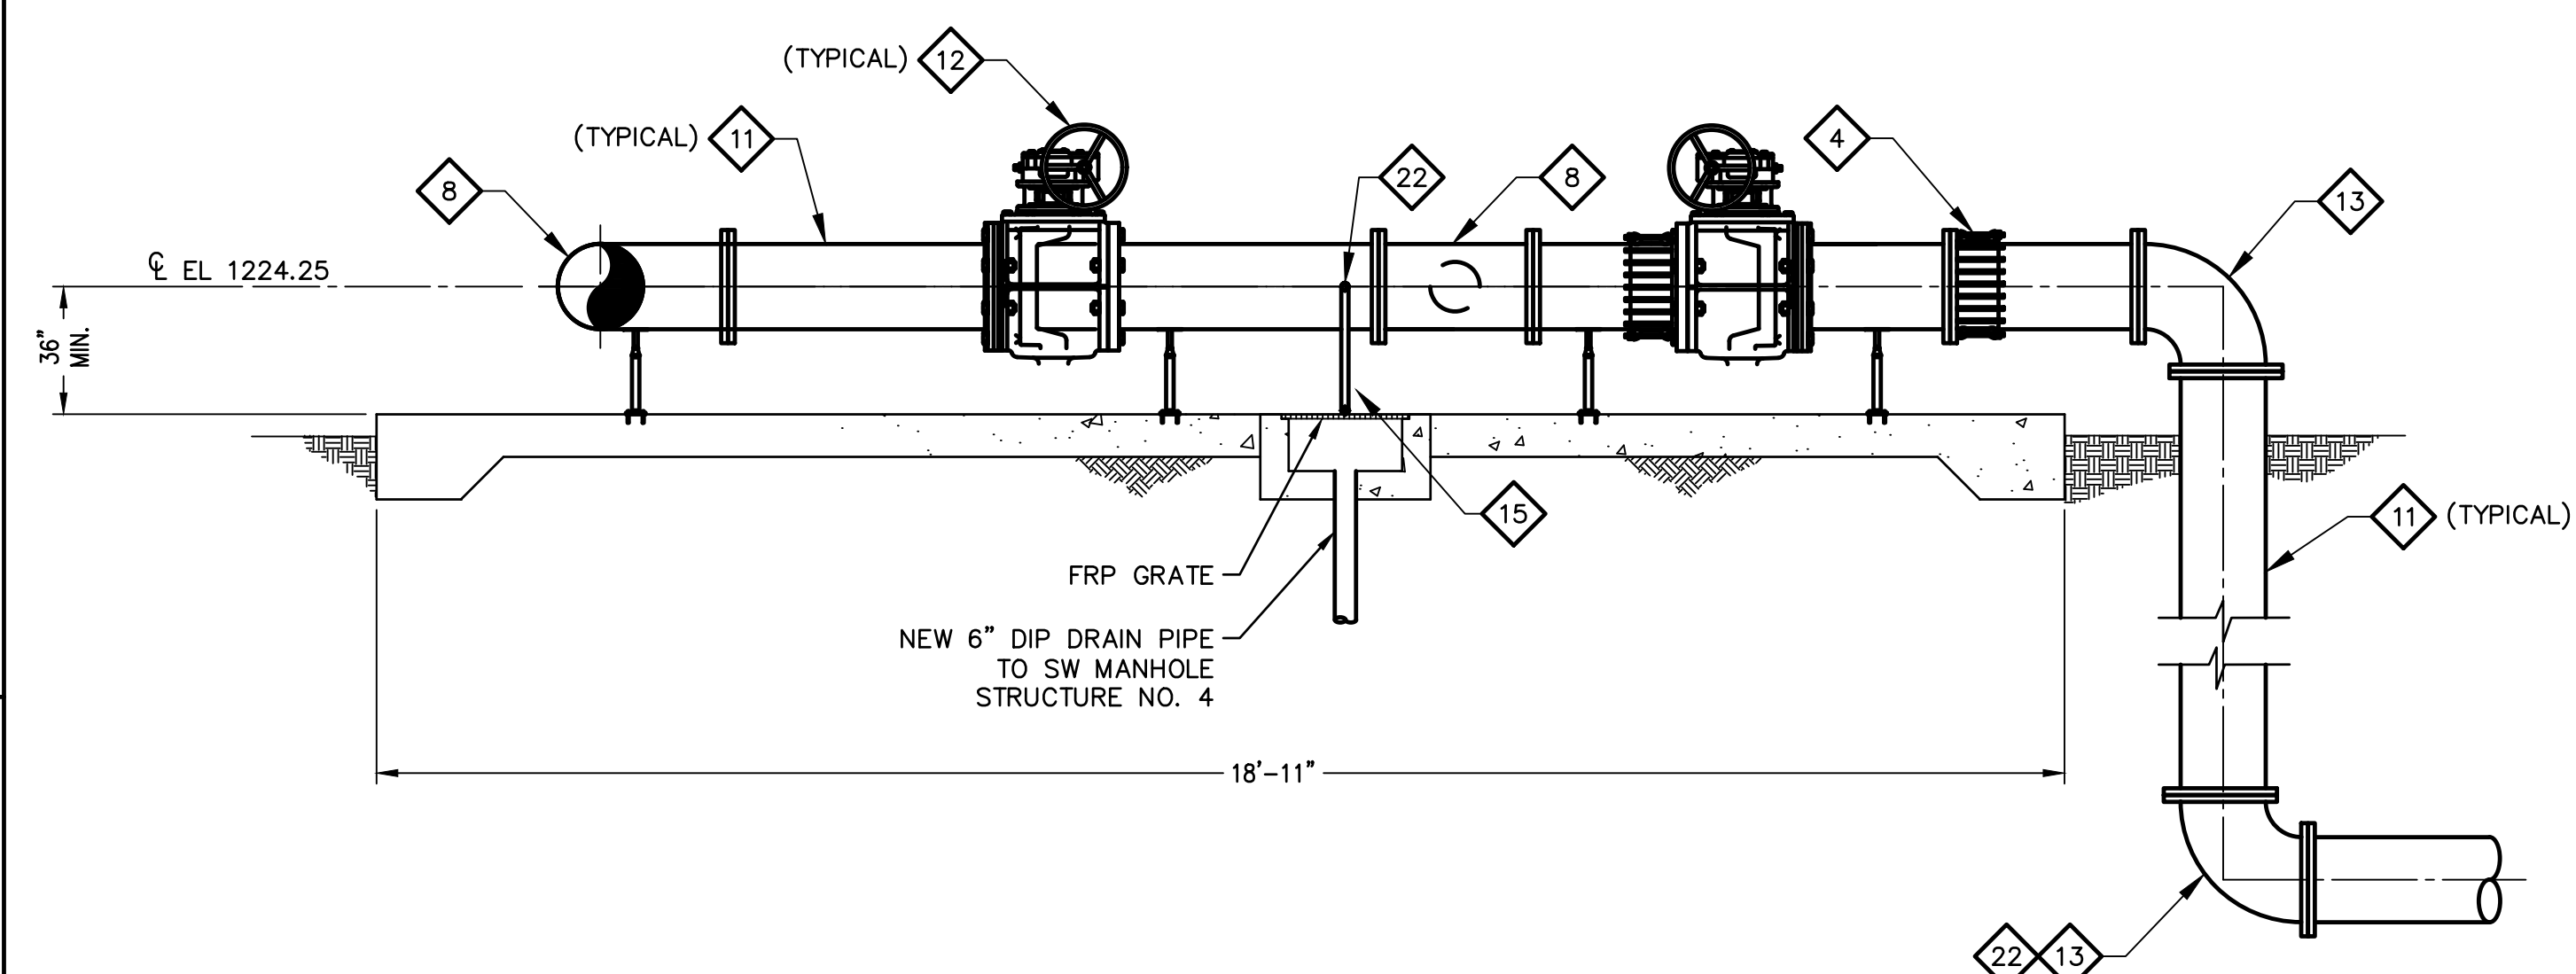

SECTION 9  
M-07 M-15  
0 2 4 8  
1/4" = 1'-0"

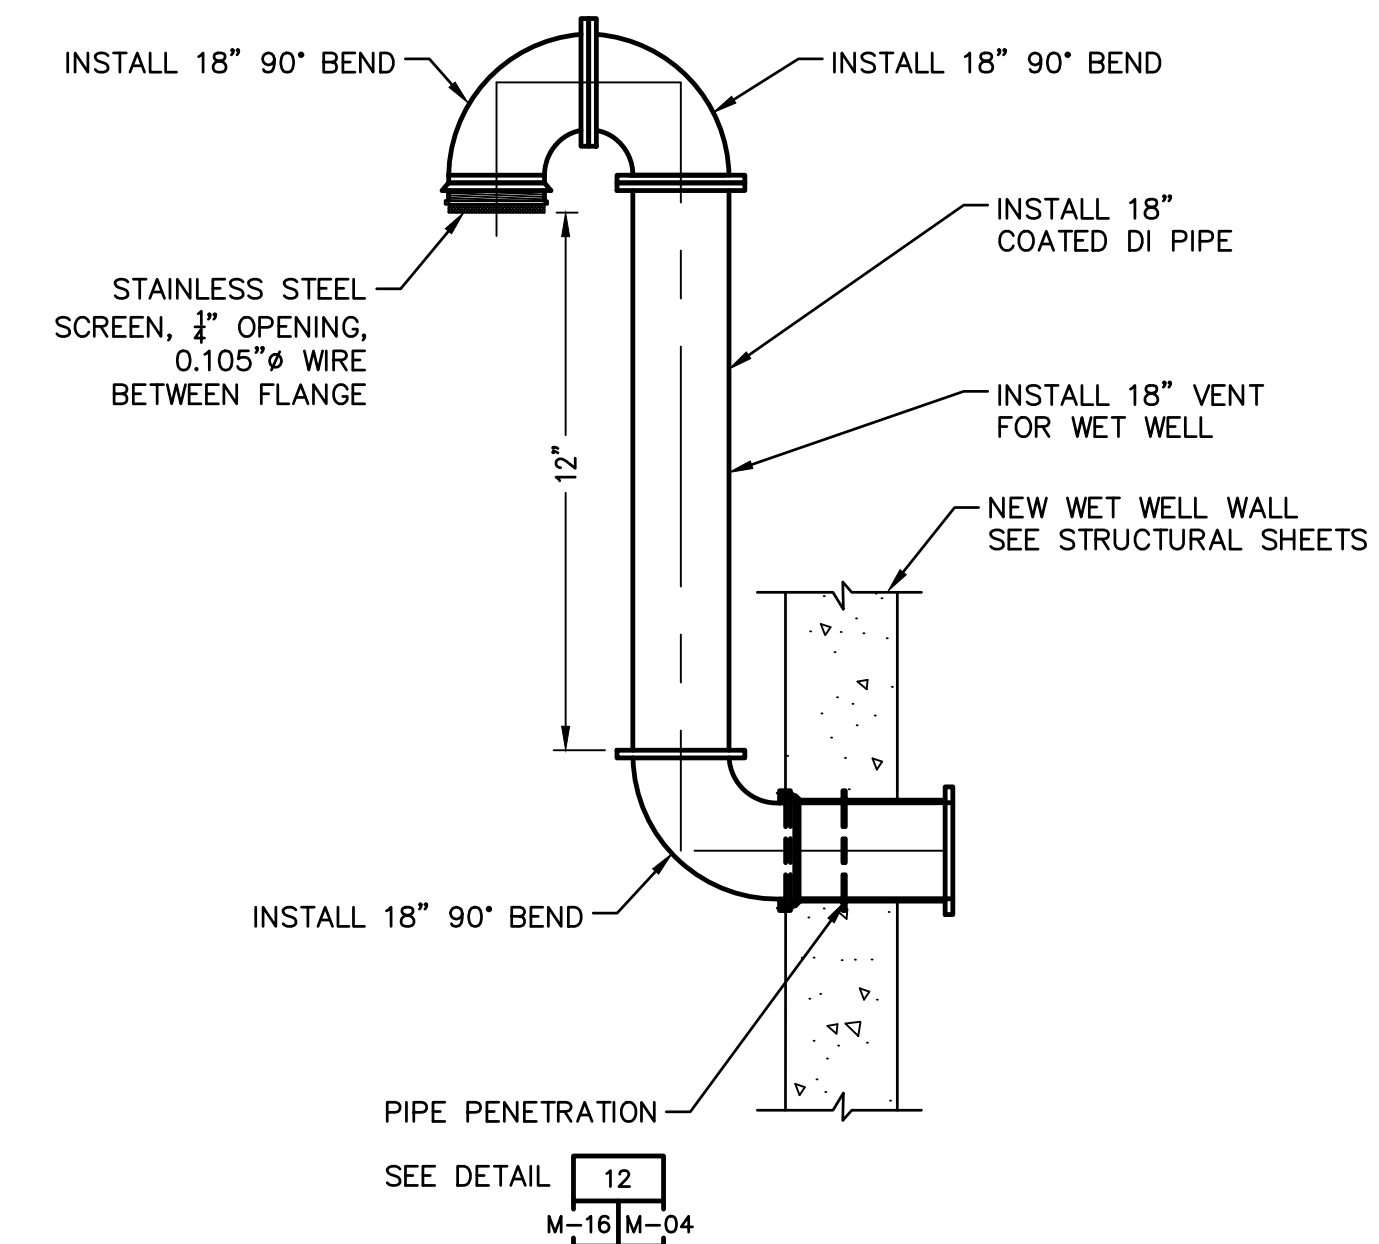

SECTION 10  
M-07 M-15  
0 2 4 8  
1/4" = 1'-0"

**KEY NOTES**


- 4 RESTRAINED DISMANTLING JOINT ROMAC DJ400 OR APPROVED EQUAL.
- 8 24"x24"x24" TEE.
- 9 ADJUSTABLE PIPE SUPPORT. SEE DETAIL 1 M-15 M-02
- 11 24" CLASS 250 DI PIPE.
- 12 24" FULL PORT PLUG VALVE, EXTERNAL HAND WHEEL.
- 13 24"- 90° BEND.
- 15 NEW 1" DOUBLE CONTAINED SCHEDULE 80 CPVC PIPING AND FITTINGS.
- 22 2" INJECTION QUILL. SEE DETAIL 5 M-15 M-03

**GENERAL NOTES**


1. CONTRACTOR TO VERIFY LOCATION OF FORCE MAINS PRIOR TO CONSTRUCTION.
2. FOR CONCRETE SLAB THICKNESS AND DETAILS SEE STRUCTURAL PLANS.
3. REFER TO GRADING AND DRAINAGE PLANS, SEE SHEETS C-25 AND C-26 FOR FINISHED FLOOR ELEVATIONS.

FACILITY DRAWINGS  
This drawing was supplied by a Consultant Engineer from a past construction project. The Consultant Engineer is not responsible for construction information provided by the Contractor to provide the Record Drawing. The City does not warranty this drawing to be a complete and accurate portrayal of facilities as they exist in the field.

REVISION #	DATE	PROJECT NAME	DWG NUMBER	REMARKS

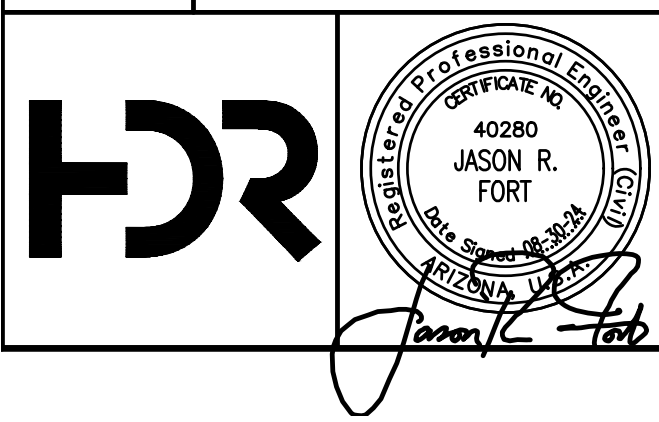

NO.	BY	DATE	CKD	REVISIONS	REMARKS
A	RS	10/2023	JF	30% SUBMITTAL	
B	RS	01/2024	JF	90% SUBMITTAL	
C	RS	04/2024	JF	AGENCY REVIEW	
D	DFD	08/2024	JF	ISSUED FOR CONSTRUCTION	
*					
*					
*					

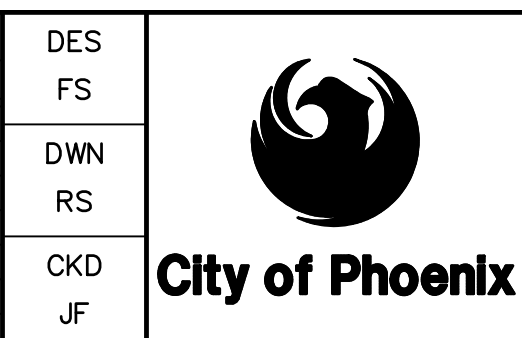

CITY OF PHOENIX  
WATER SERVICES DEPARTMENT  
  
LIFT STATION 40  
REFURBISHMENT


MECHANICAL  
  
LS YARD PIPING SECTIONS 7, 8, 9, & 10

COPYRIGHT © 2007-JANUARY  
CITY PROJECT NO. WS90400085  
DATE: 08/2024  
M-15 SHEET 51 OF 134  
CAD FILE: DSM4AB9Q04.DWG


USER: FBERASFRALD0 FILE: C:\pwworking\west01\03411629\01\_DSM4AB9Q04.dwg DATE: 9/04/24 TIME: 03:26pm

FOR CONSTRUCTION

THIS DRAWING MUST BE FIELD VERIFIED BEFORE USE  
DRAWING NOT TO SCALE UNLESS SCALE BAR IS PRESENT

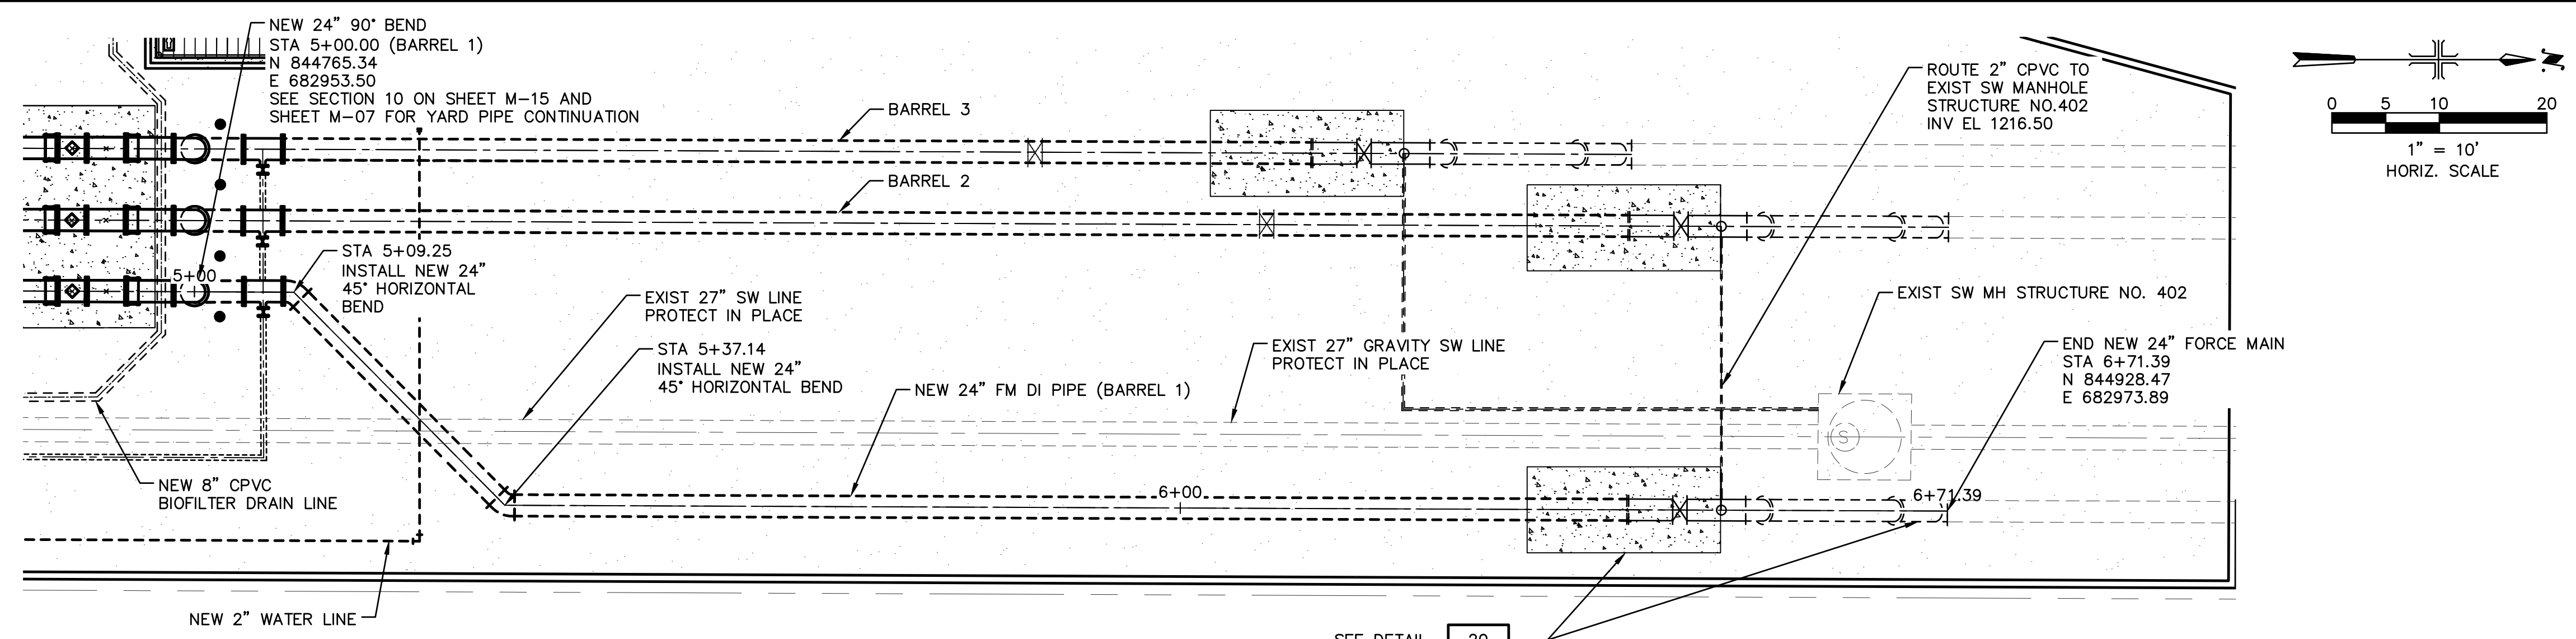

**PLAN VIEW**  
FOR LAUNCH STRUCTURE DETAILS

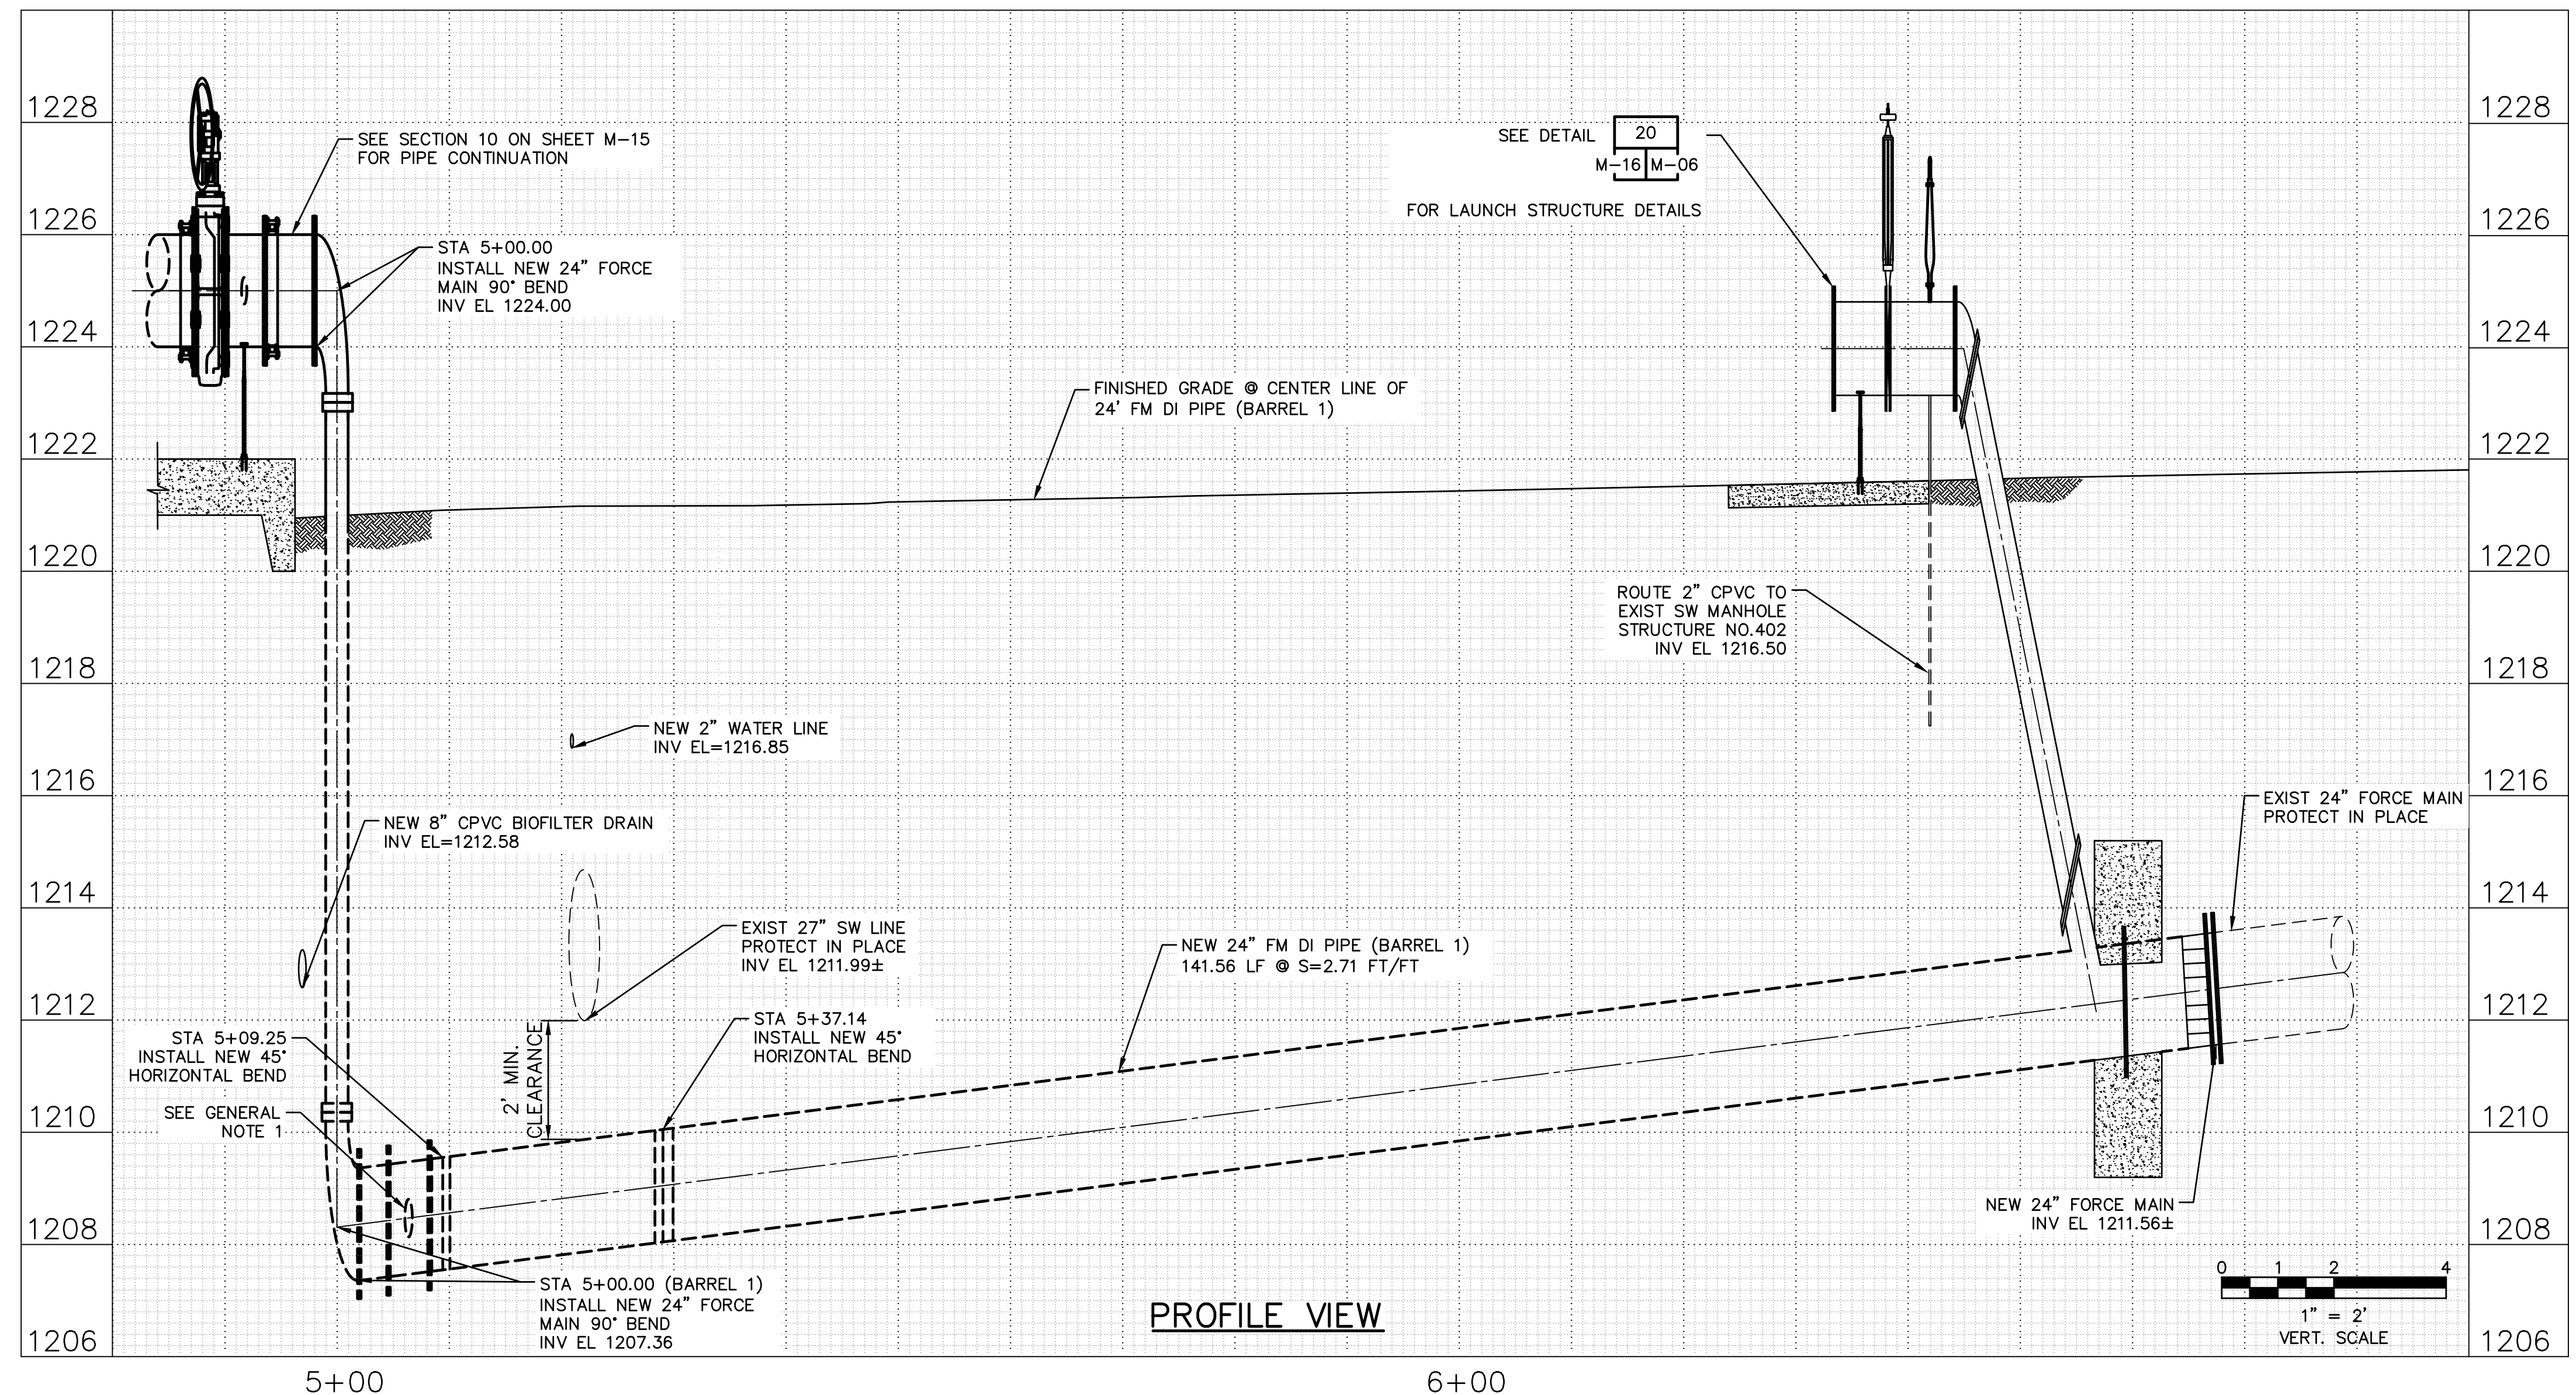


**PROFILE VIEW**

**GENERAL NOTE**  
1. FOR CONSTRUCTION KEY NOTES SEE LS YARD PIPING PLAN SHEET M-08.


"PER CITY OF PHOENIX CODE CHAPTER 2, SECTION 2-28, THESE PLANS ARE FOR OFFICIAL USE ONLY AND MAY NOT BE SHARED WITH OTHERS EXCEPT AS REQUIRED TO FULFILL THE OBLIGATIONS OF THE CONTRACTOR'S CONTRACT TO FULFILL THE OBLIGATIONS OF THE CITY OF PHOENIX."  
THIS DOCUMENT MUST BE KEPT SECURE AT ALL TIMES.

FACILITY DRAWINGS  
This drawing was supplied by a Consultant Engineer from a past project and is being provided for information only. The City does not warrant the accuracy or completeness of the information provided by the Contractor to provide a complete and accurate portrayal of facilities as they exist in the field.

REVISION	DATE	PROJECT NAME	DWG NUMBER	REMARKS

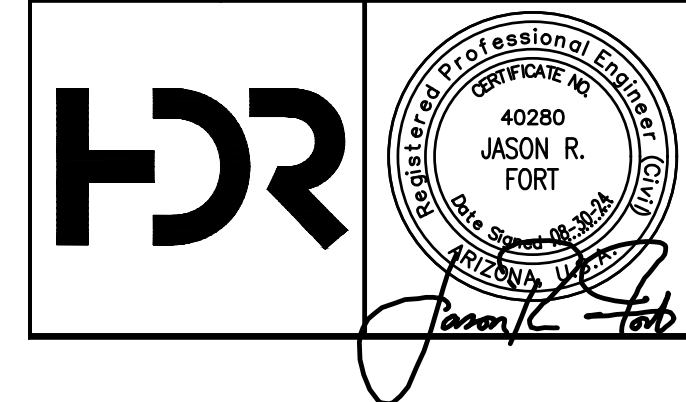

NO.	BY	DATE	CKD	REVISIONS	REMARKS
A	RS	10/2023	JF	30% SUBMITTAL	
B	RS	01/2024	JF	90% SUBMITTAL	
C	RS	04/2024	JF	AGENCY REVIEW	
D	DFD	08/2024	JF	ISSUED FOR CONSTRUCTION	
*					
*					
*					

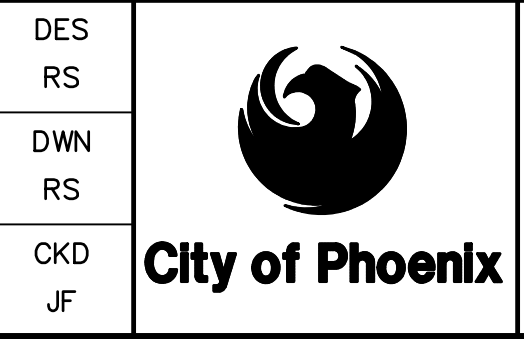

CITY OF PHOENIX  
WATER SERVICES DEPARTMENT  
**LIFT STATION 40  
REFURBISHMENT**


MECHANICAL  
**LS 24" FORCE MAIN BARREL 1  
DI PIPE PLAN AND PROFILE  
STA 5+00.00 TO STA 6+71.37**

COPYRIGHT © 2007-JANUARY  
CITY PROJECT NO. WS90400085  
DATE: 08/2024  
**M-16** SHEET 52 OF 134  
CAD FILE: CSMLS40P06.dwg



THIS DRAWING MUST BE FIELD VERIFIED BEFORE USE  
DRAWING NOT TO SCALE UNLESS SCALE BAR IS PRESENT

FOR CONSTRUCTION

"PER CITY OF PHOENIX CODE CHAPTER 2, SECTION 2-28, THESE PLANS ARE  
FOR OFFICIAL USE ONLY AND MAY NOT BE SHARED WITH OTHERS EXCEPT AS  
REQUIRED TO FULFILL THE OBLIGATIONS OF THE CONTRACTOR'S CONTRACT  
WITH THE CITY OF PHOENIX."  
THIS DOCUMENT MUST BE KEPT SECURE AT ALL TIMES.

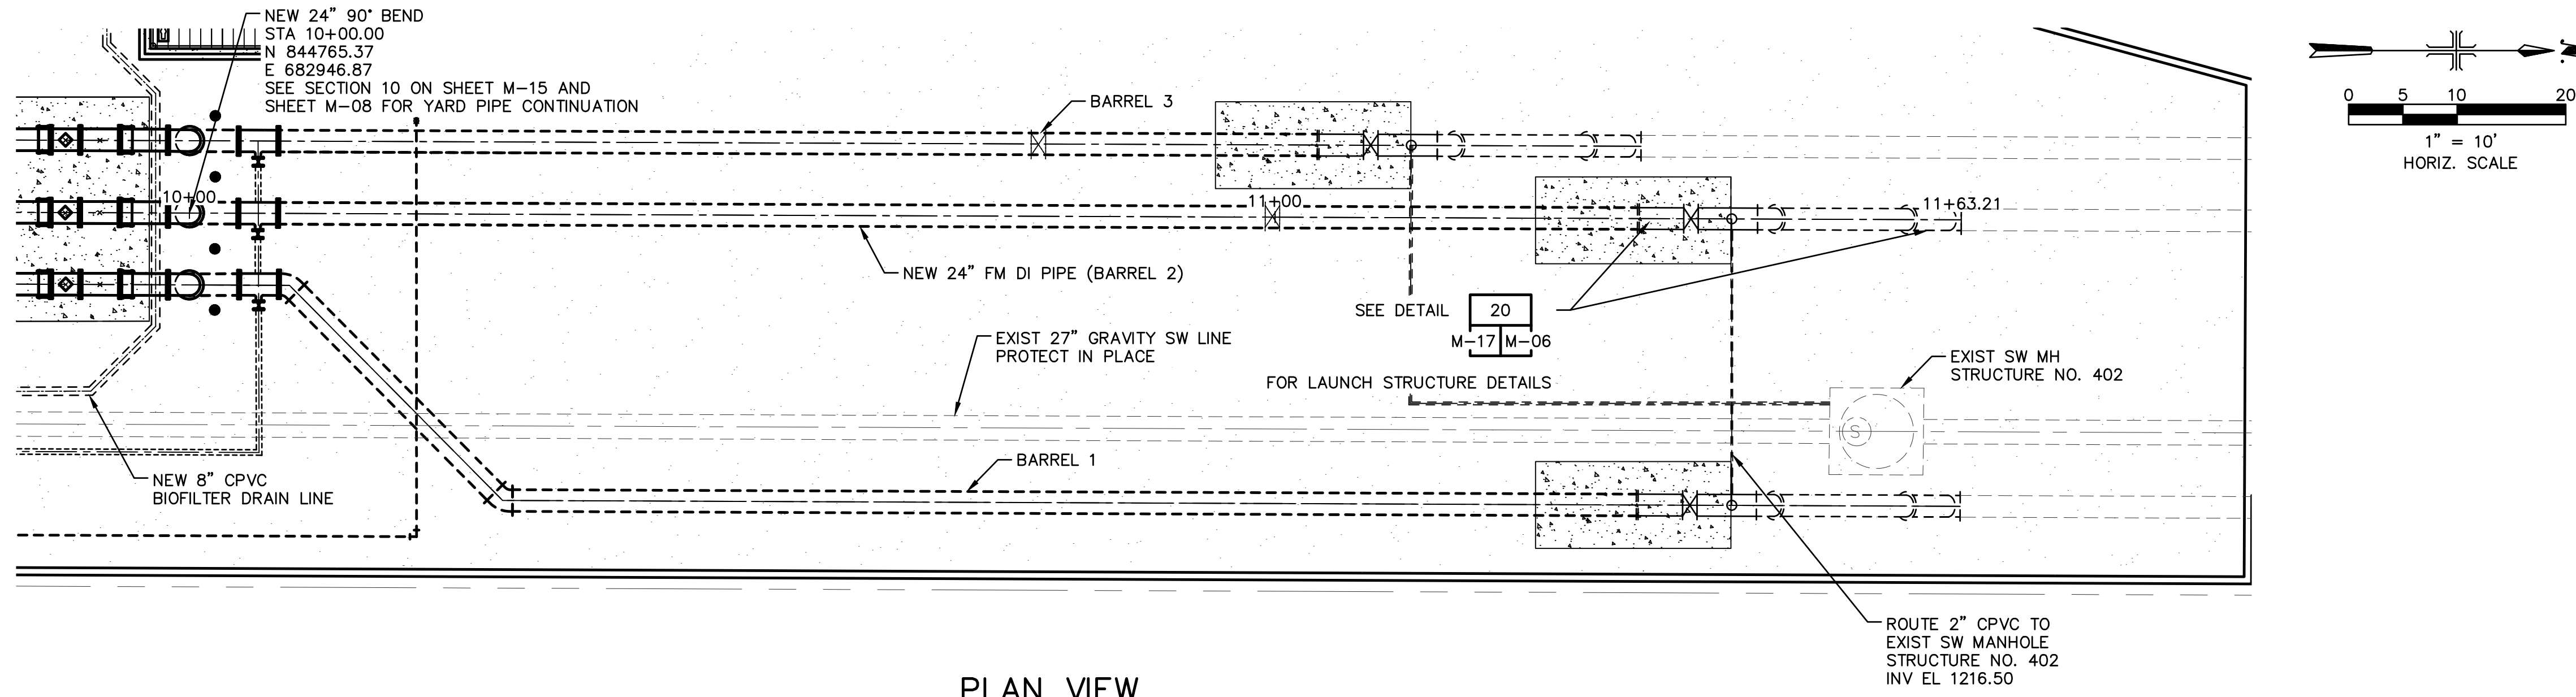

PLAN VIEW

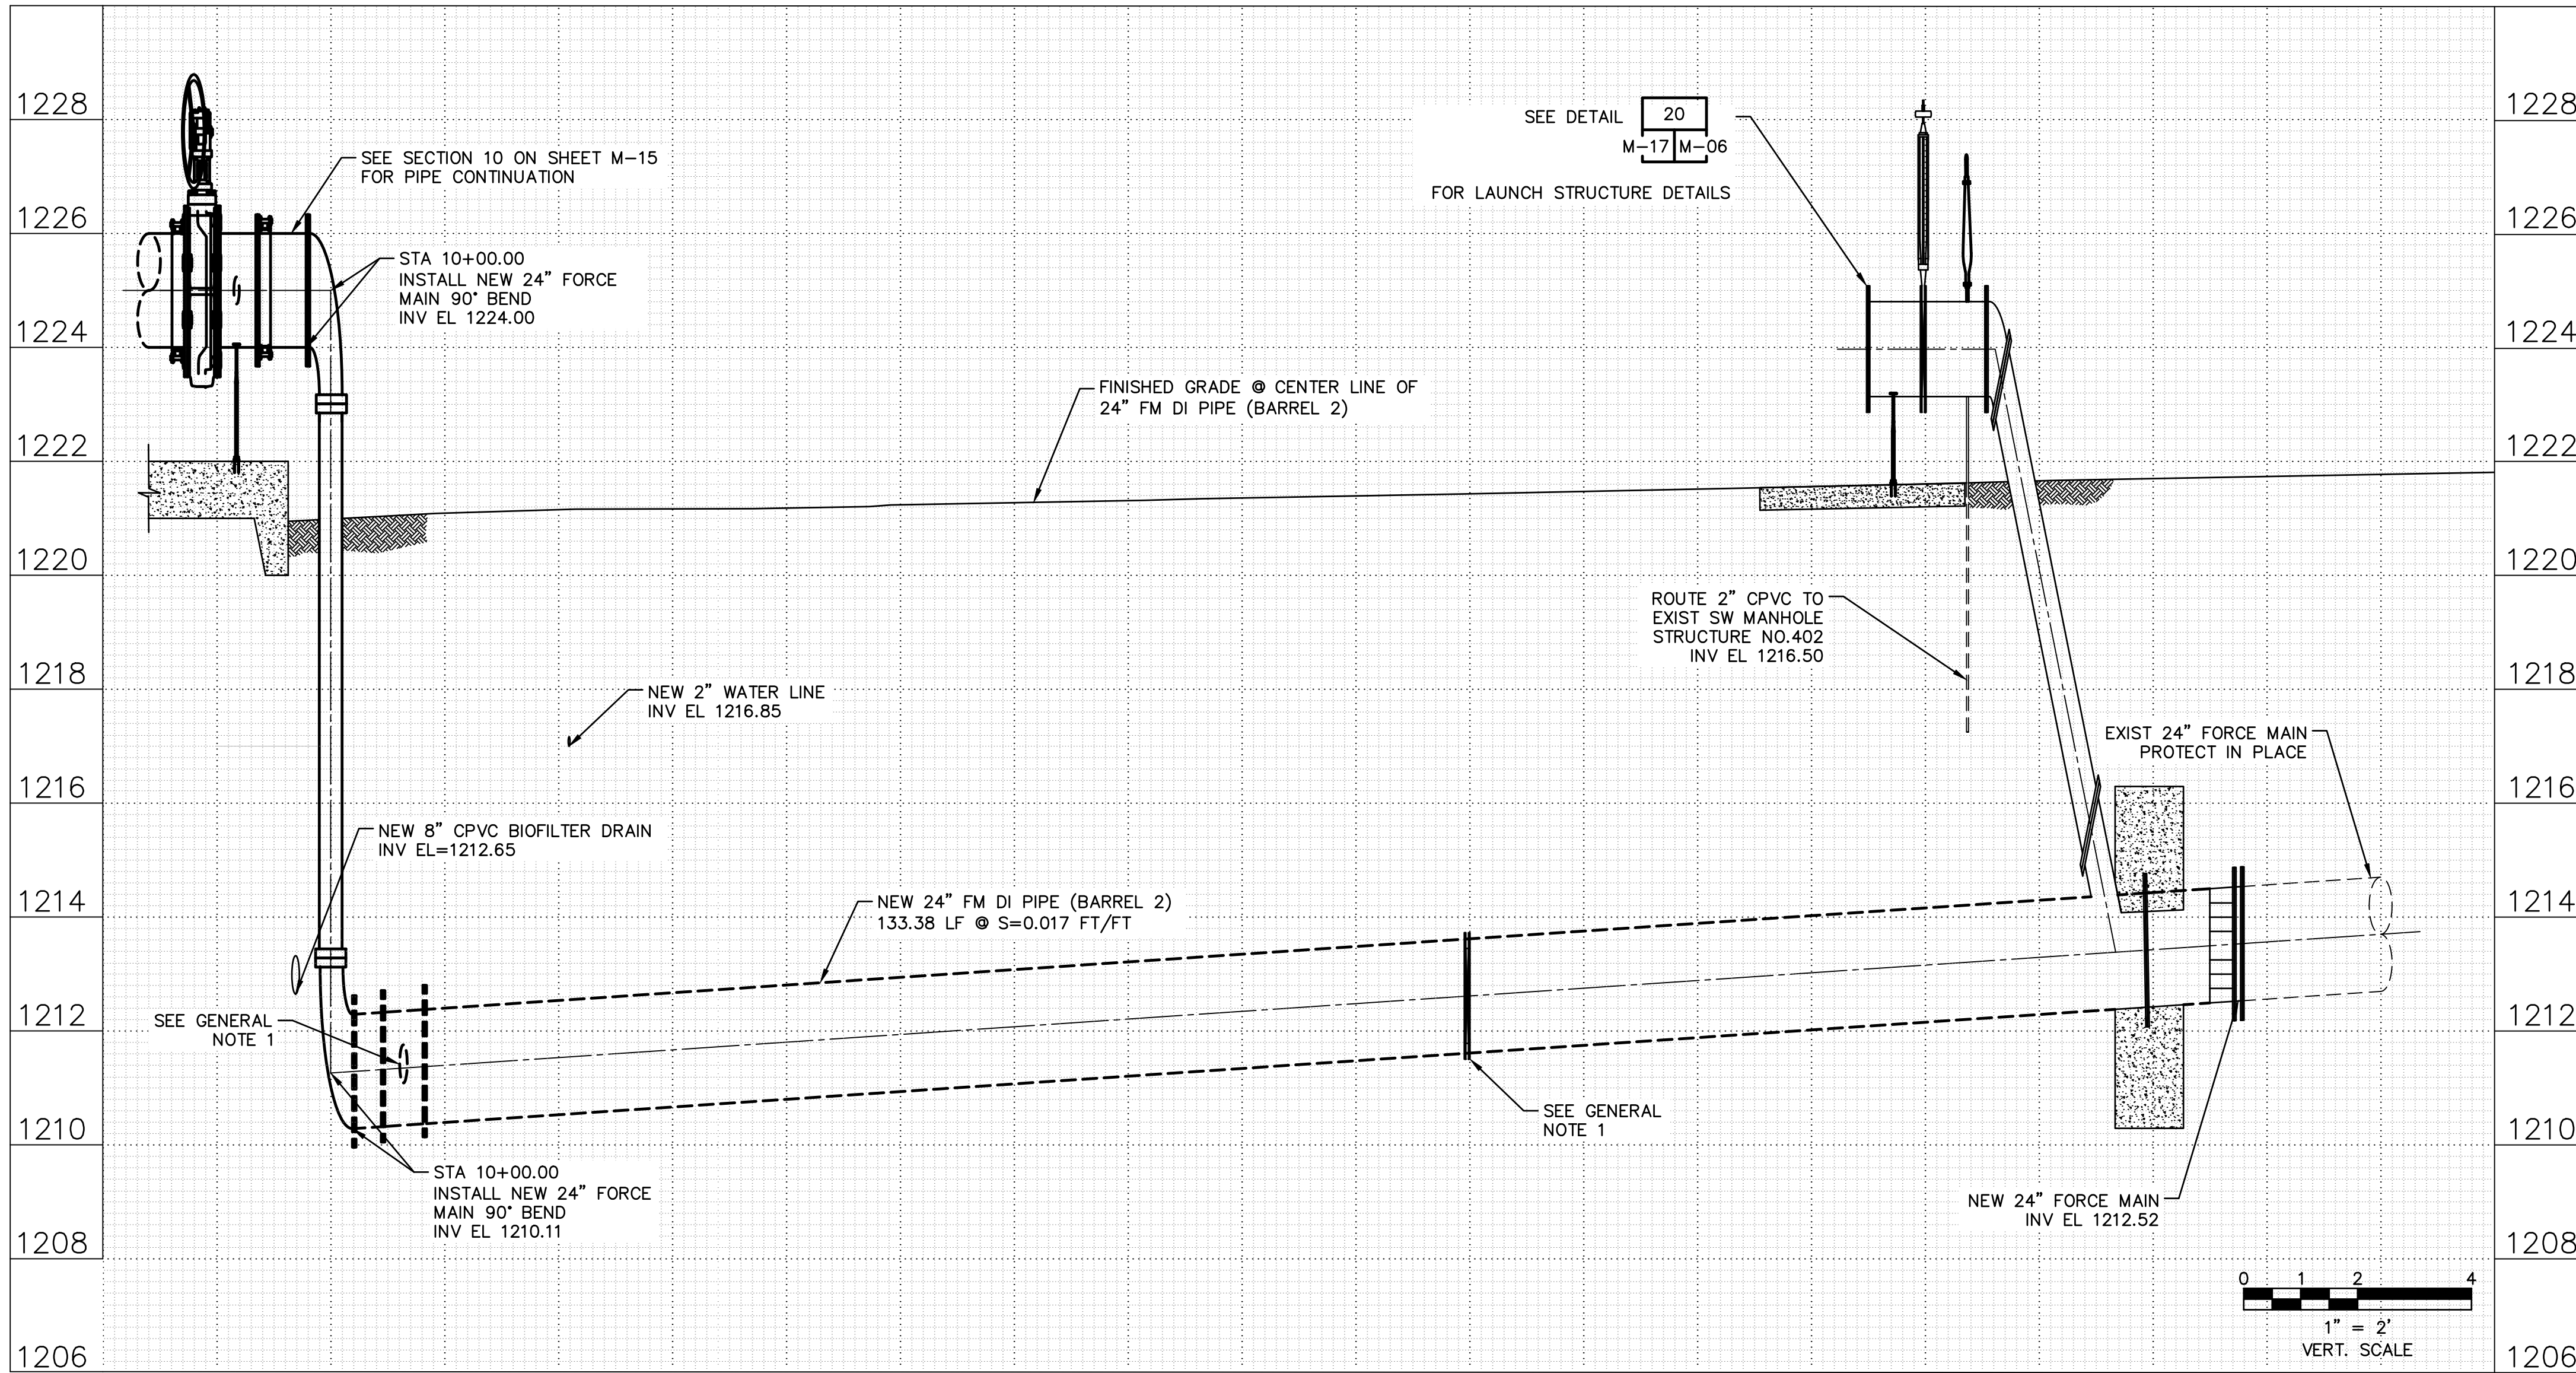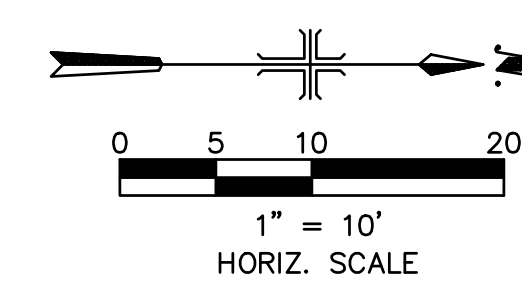


PROFILE VIEW

**GENERAL NOTE**


- FOR CONSTRUCTION KEY NOTES SEE LS YARD PIPING PLAN SHEET M-08.

FACILITY DRAWINGS  
This drawing was supplied by a Consultant Engineer from a past  
contractor and is not to be used for construction purposes based  
on information provided by the Contractor to provide the Record Drawing.  
The City does not warrant this drawing to be a complete and accurate  
portrayal of facilities as they exist in the field.

REVISION	DATE	PROJECT NAME	DWG NUMBER	REMARKS

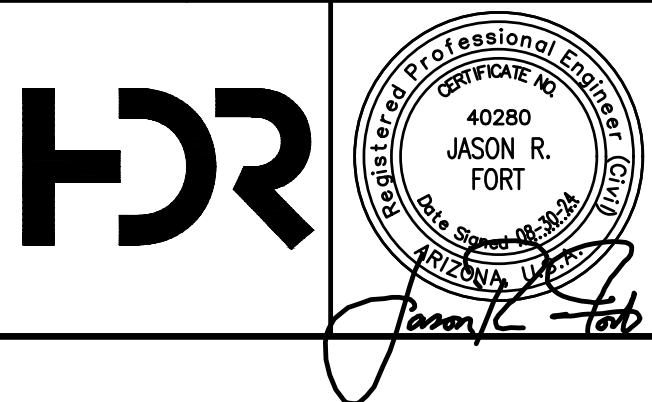

NO.	BY	DATE	CKD	REVISIONS	REMARKS
A	RS	10/2023	JF	30% SUBMITTAL	
B	RS	01/2024	JF	90% SUBMITTAL	
C	RS	04/2024	JF	AGENCY REVIEW	
D	DFD	08/2024	JF	ISSUED FOR CONSTRUCTION	
*					
*					
*					

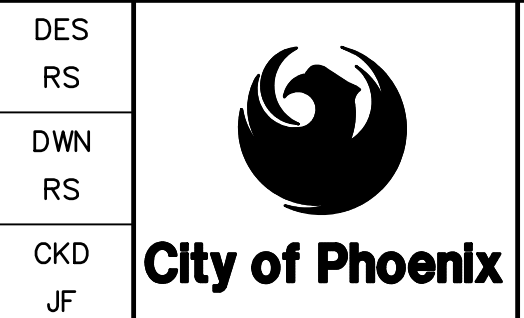

CITY OF PHOENIX  
WATER SERVICES DEPARTMENT  
  
LIFT STATION 40  
REFURBISHMENT





MECHANICAL  
  
LS 24" FORCE MAIN BARREL 2  
DI PIPE PLAN AND PROFILE  
STA 10+00.00 TO STA 11+63.21

COPYRIGHT © 2007-JANUARY  
CITY PROJECT NO. WS90400085  
DATE: 08/2024  
M-17 SHEET 53 OF 134  
CAD FILE: CSMLS40P07.dwg

THIS DRAWING MUST BE FIELD VERIFIED BEFORE USE  
DRAWING NOT TO SCALE UNLESS SCALE BAR IS PRESENT

FOR CONSTRUCTION

"PER CITY OF PHOENIX CODE CHAPTER 2, SECTION 2-28, THESE PLANS ARE FOR OFFICIAL USE ONLY AND MAY NOT BE SHARED WITH OTHERS EXCEPT AS REQUIRED TO FULFILL THE OBLIGATIONS OF THE CONTRACTOR'S CONTRACT WITH THE CITY OF PHOENIX."  
THIS DOCUMENT MUST BE KEPT SECURE AT ALL TIMES.

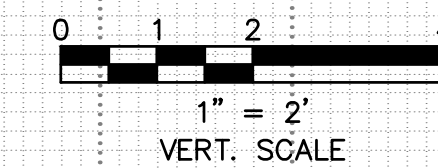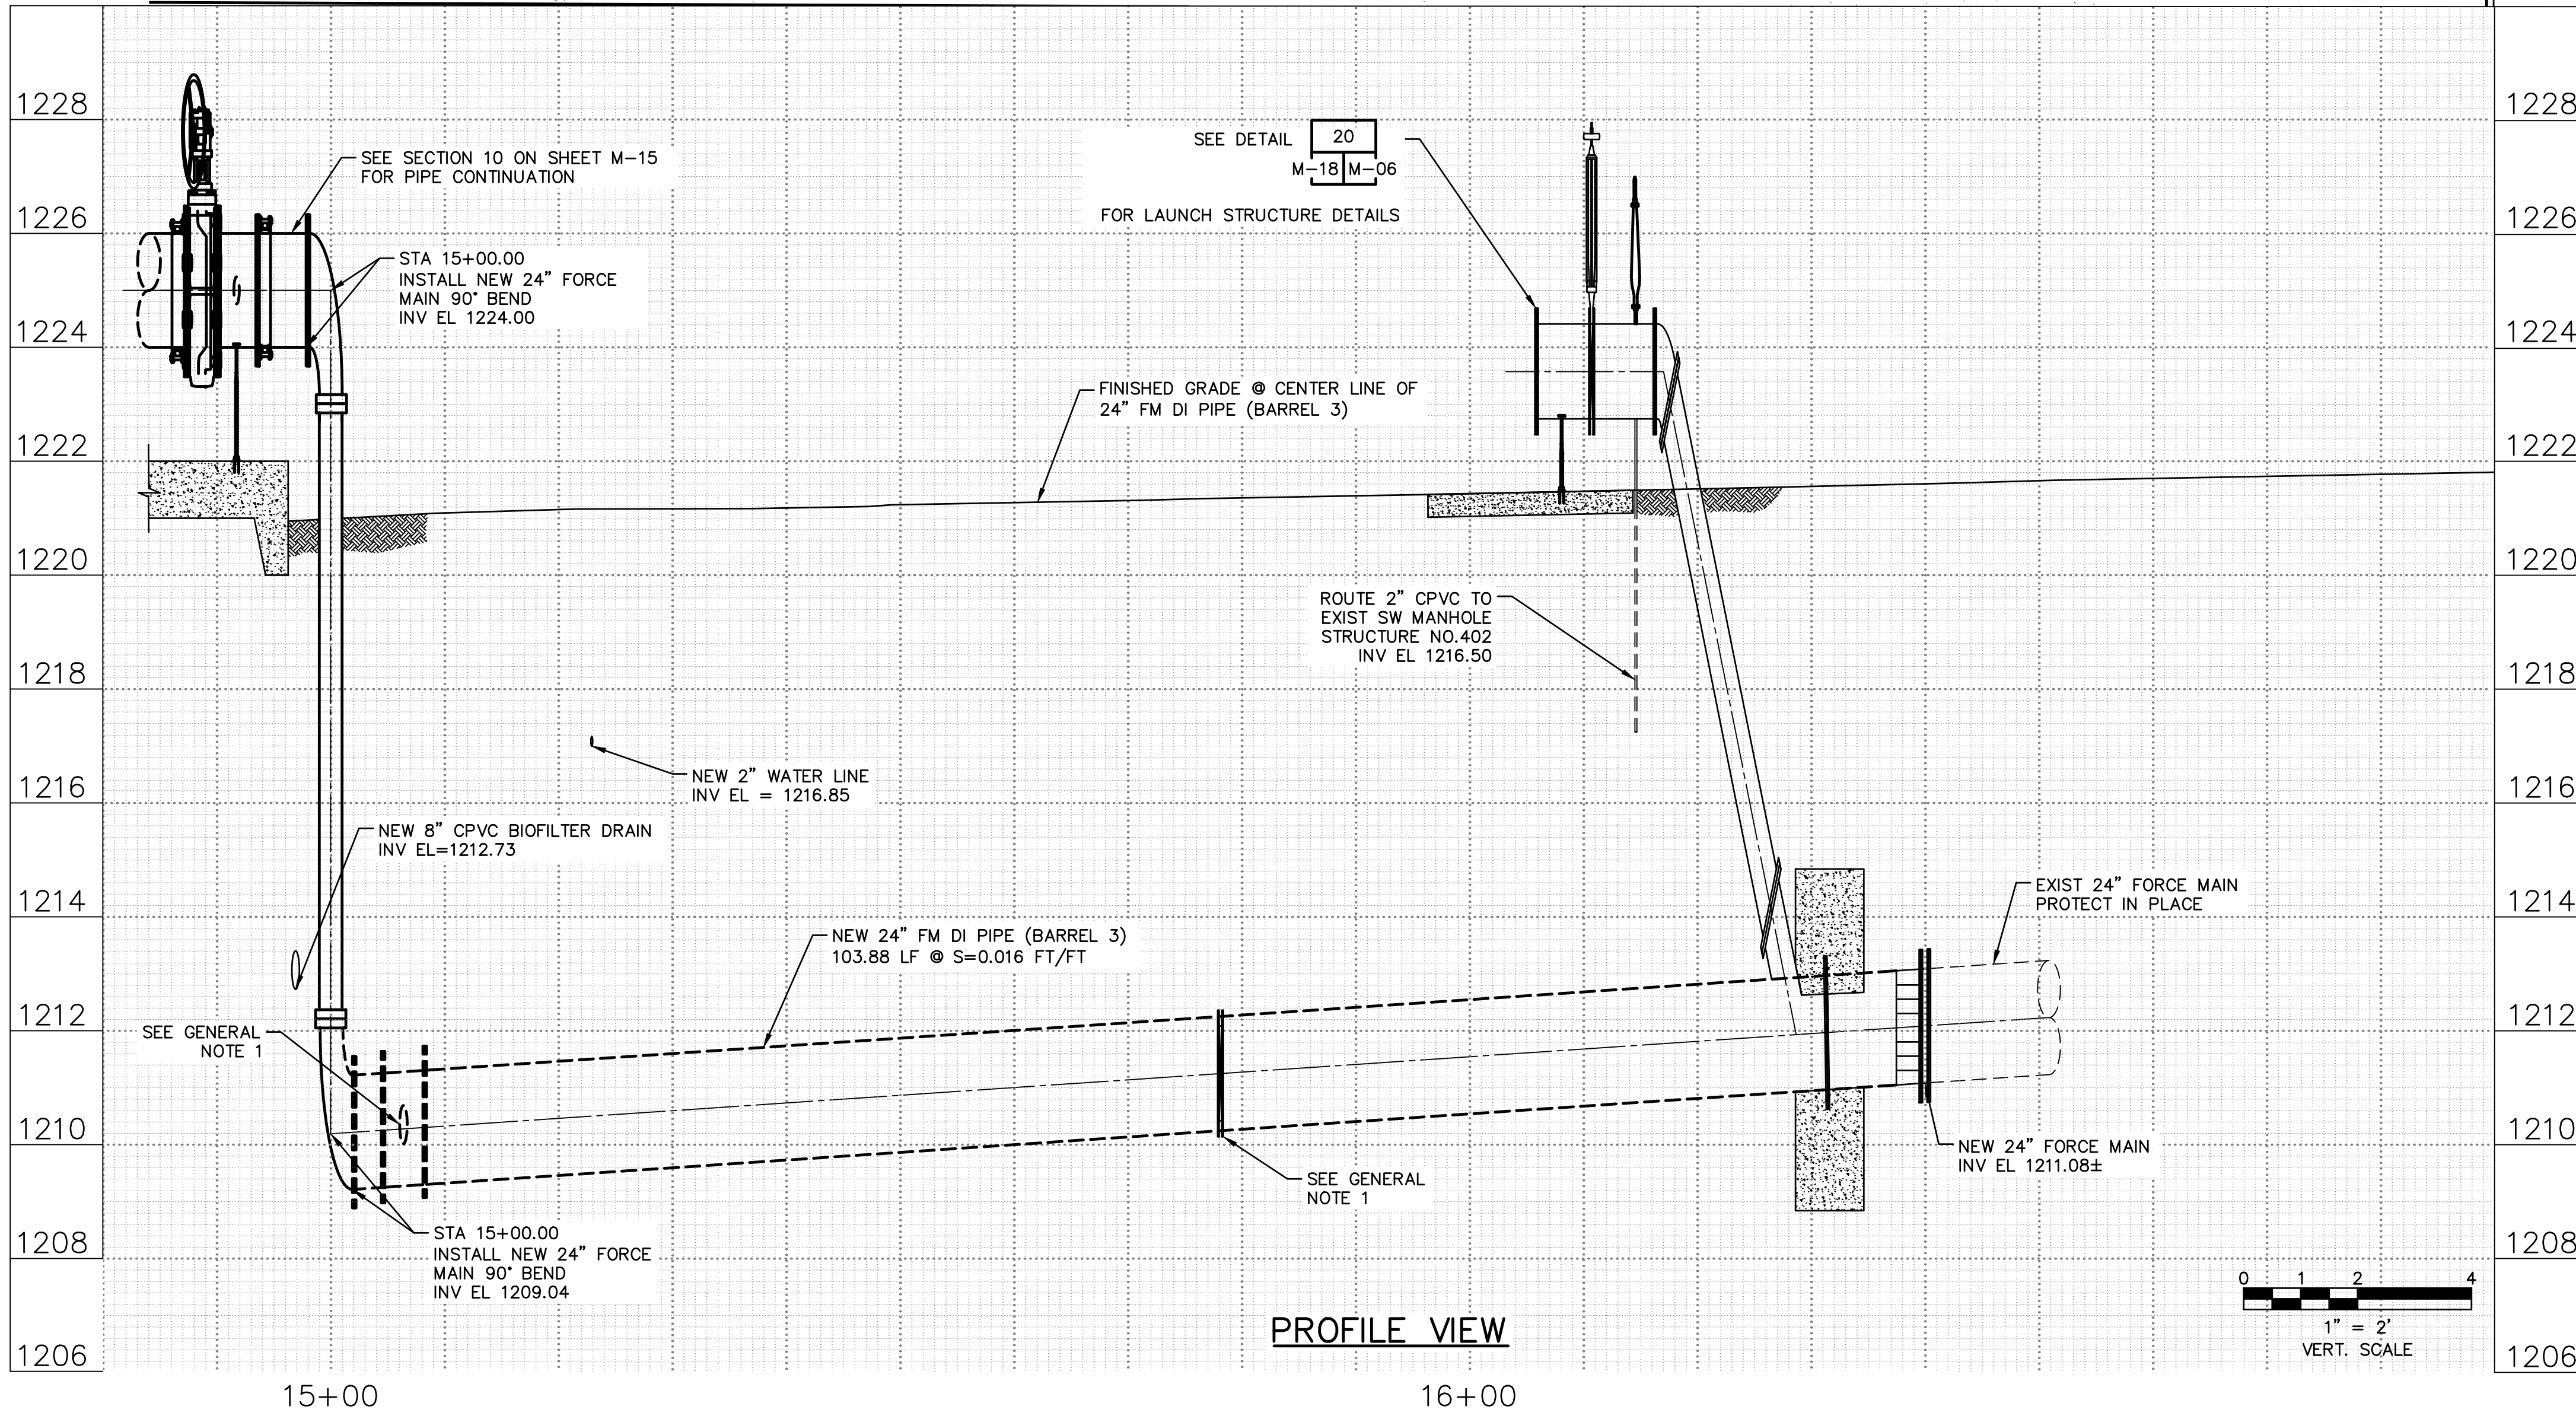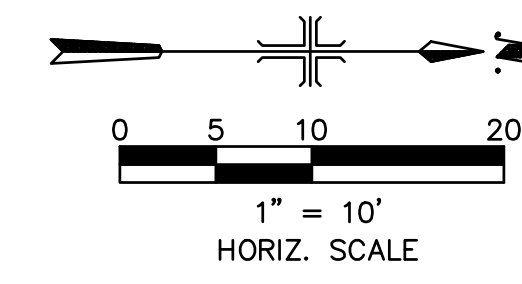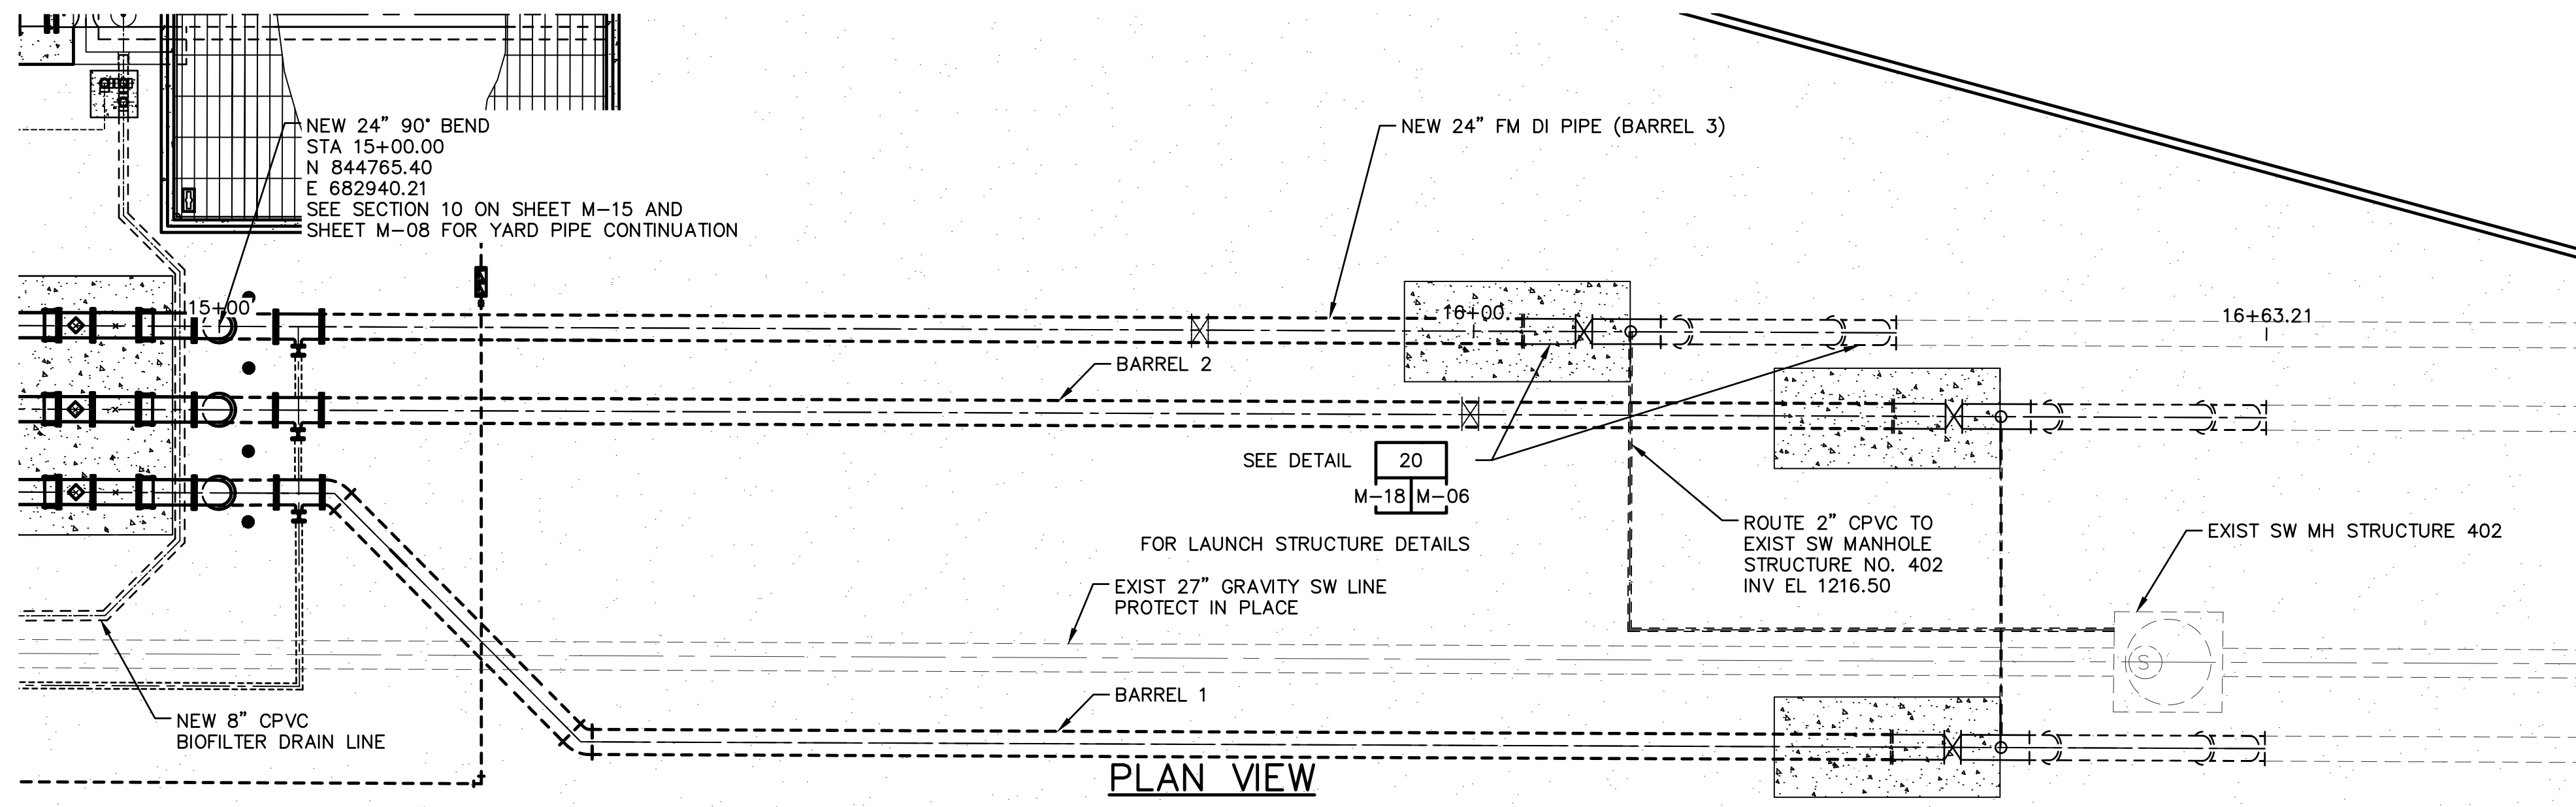


**GENERAL NOTE**


- FOR CONSTRUCTION KEY NOTES SEE LS YARD PIPING PLAN SHEET M-08.

FACILITY DRAWINGS  
This drawing was supplied by a Consultant Engineer from a past construction project. The City of Phoenix is providing this information for informational purposes only. The City does not warrant the accuracy and completeness of the information provided in this drawing or any other drawings or reports prepared by the Consultant Engineer. The City does not warrant the accuracy and completeness of the information provided in this drawing or any other drawings or reports prepared by the Consultant Engineer as they exist in the field.

REVISION NUMBER	DATE	CAD FILE NAME	DWG NUMBER	REMARKS

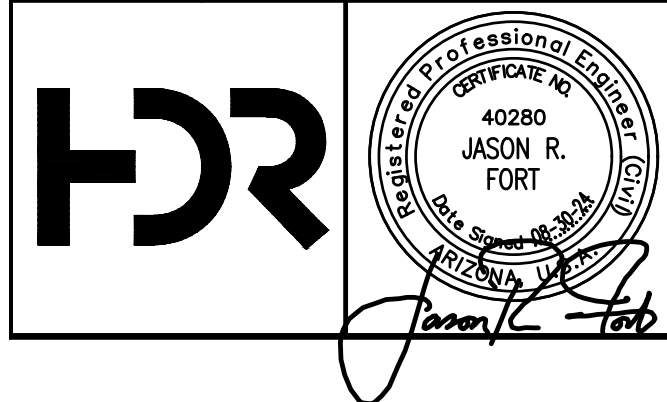

NO.	BY	DATE	CKD	REVISIONS	REMARKS
A	RS	10/2023	JF	30% SUBMITTAL	
B	RS	01/2024	JF	90% SUBMITTAL	
C	RS	04/2024	JF	AGENCY REVIEW	
D	DFD	08/2024	JF	ISSUED FOR CONSTRUCTION	
*					
*					
*					

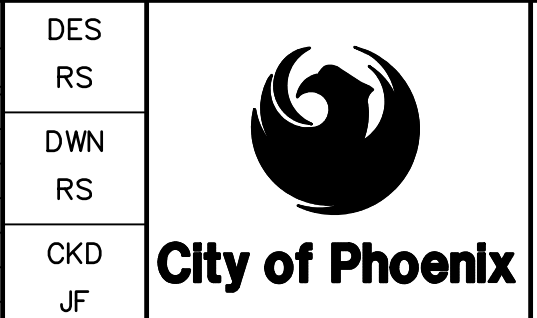

CITY OF PHOENIX  
WATER SERVICES DEPARTMENT  
  
LIFT STATION 40  
REFURBISHMENT



MECHANICAL  
  
LS 24" FORCE MAIN BARREL 3  
DI PIPE PLAN AND PROFILE  
STA 15+00.00 TO STA 16+63.21

COPYRIGHT © 2007-JANUARY  
CITY PROJECT NO. WS90400085  
DATE: 08/2024  
M-18 SHEET 54 OF 134  
CAD FILE: CSMLS40P08.dwg

**FOR CONSTRUCTION**

THIS DRAWING MUST BE FIELD VERIFIED BEFORE USE. DRAWING NOT TO SCALE UNLESS SCALE BAR IS PRESENT.

"PER CITY OF PHOENIX CODE CHAPTER 2, SECTION 2-28, THESE PLANS ARE FOR OFFICIAL USE ONLY AND MAY NOT BE SHARED WITH OTHERS EXCEPT AS REQUIRED TO FULFILL THE OBLIGATIONS OF THE CONTRACTOR'S CONTRACT WITH THE CITY OF PHOENIX." THIS DOCUMENT MUST BE KEPT SECURE AT ALL TIMES.

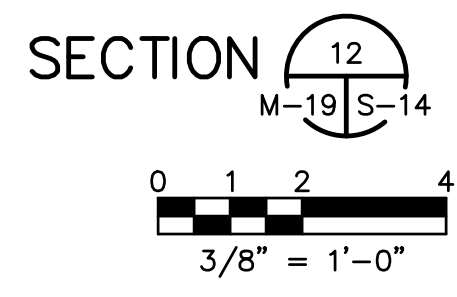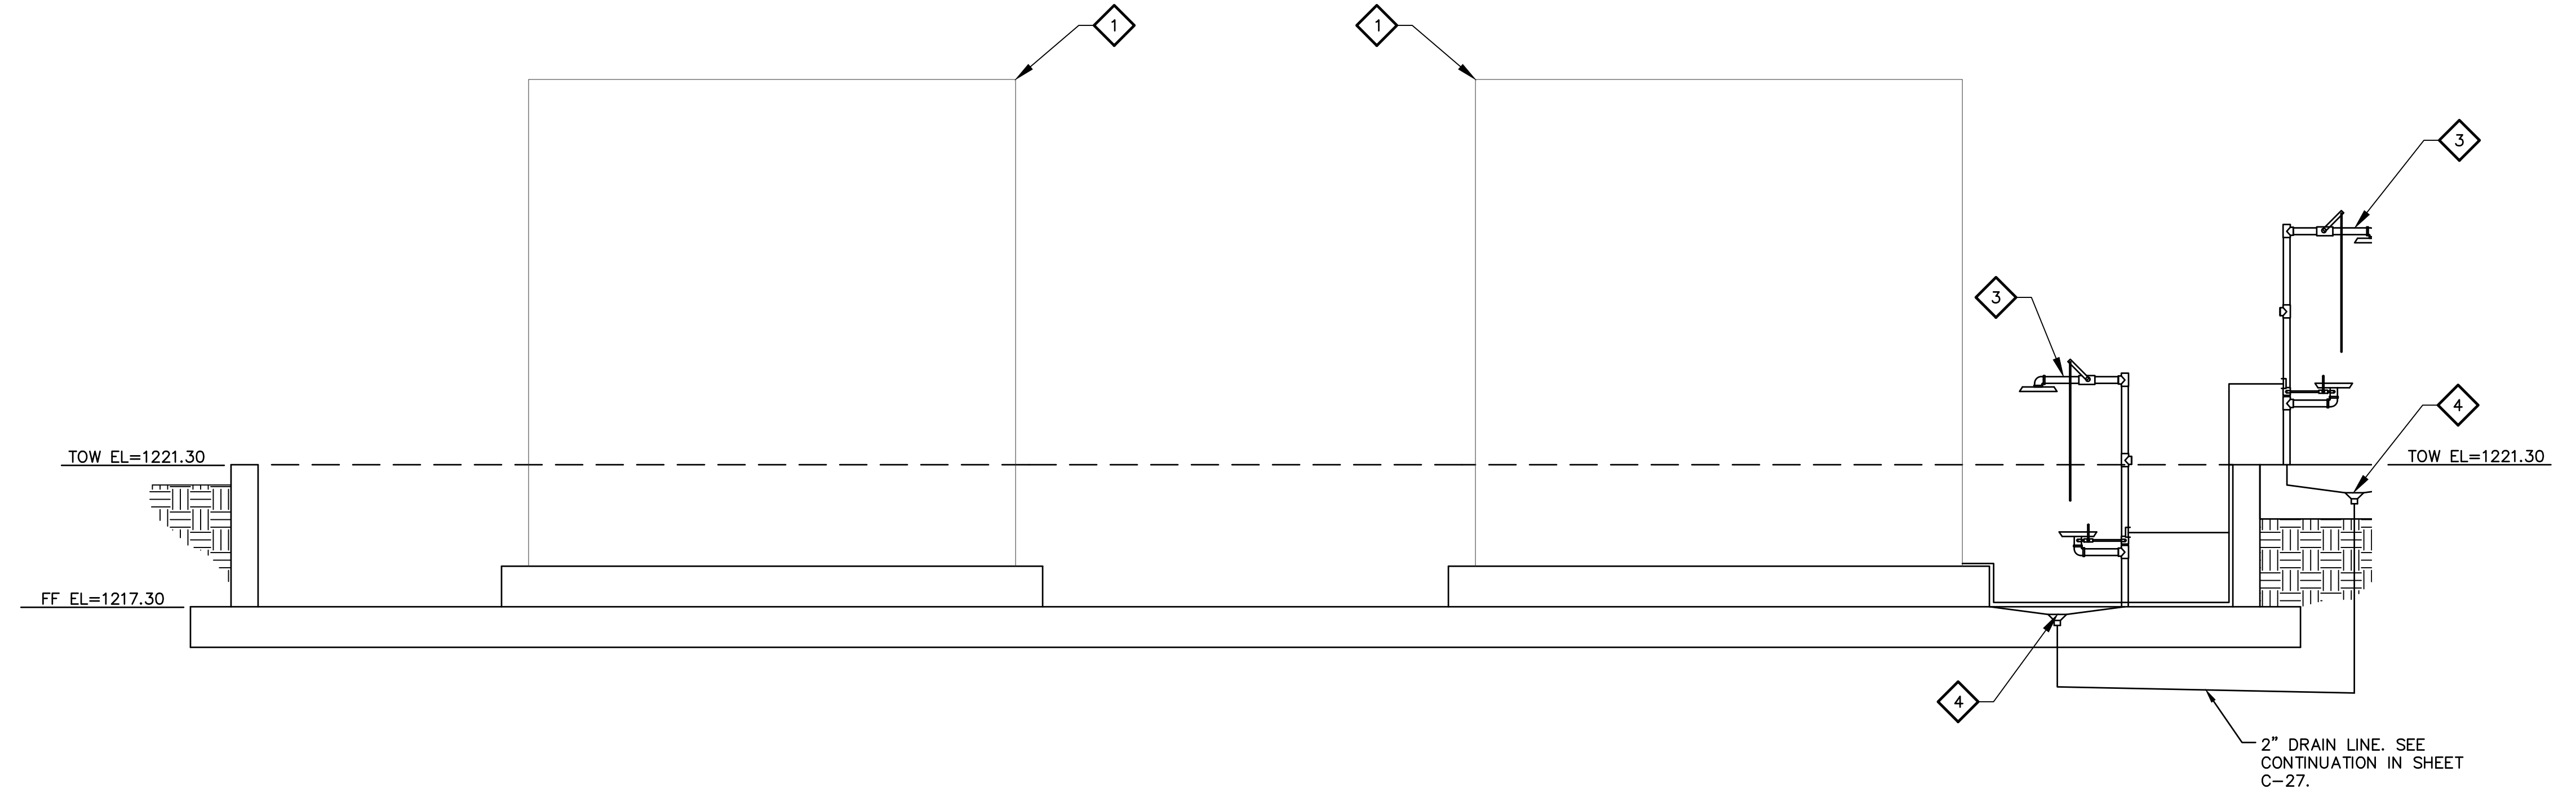

**KEY NOTES**


- 1 7800 GAL FERROUS CHLORIDE STORAGE TANK.
- 3 EMERGENCY EYEWASH/SHOWER.
- PER DETAIL  $\frac{9}{M-19 M-04}$ .
- 4 DRAIN PER DETAIL  $\frac{7}{M-19 M-03}$ .

**GENERAL NOTES**


1. REFER TO GRADING AND DRAINAGE PLANS, SEE SHEETS C-25 AND C-26 FOR FINISHED FLOOR ELEVATIONS.
2. CHEMICAL CONTAINMENT AREA TO BE COATED PER SPEC SECTION 09 96 17.
3. CHEMICAL UNLOADING AREA INCLUDING TRENCH DRAINS, SUMPS, AND HORIZONTAL PIPE CHASES TO BE COATED PER SPEC SECTION 09 96 16.

FACILITY DRAWINGS  
This drawing was supplied by a Consultant Engineer from a past construction project. The Consultant Engineer is not responsible for construction information provided by the Contractor to provide the Record Drawing. The City does not warrant this drawing to be a complete and accurate portrayal of facilities as they exist in the field.

FOR CITY OF PHOENIX USE ONLY - REFERENCE CID NUMBER: #	PROJECT NO.	PROJECT NAME	DATE	CAD FILE NAME	DWG NUMBER	REMARKS

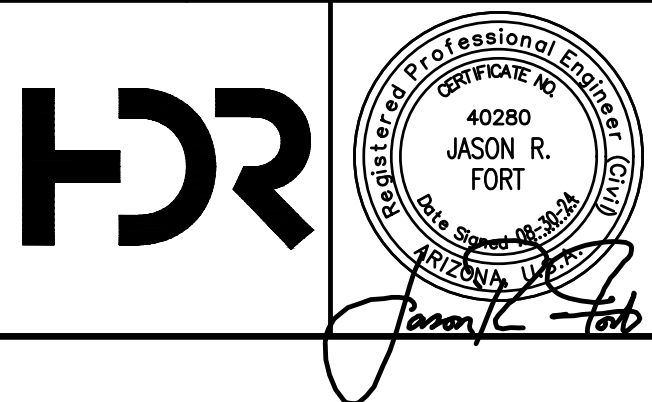

NO.	BY	DATE	CKD	REVISIONS	REMARKS
A	RS	10/2023	JF	30% SUBMITTAL	
B	RS	01/2024	JF	90% SUBMITTAL	
C	RS	04/2024	JF	AGENCY REVIEW	
D	FDF	08/2024	JF	ISSUED FOR CONSTRUCTION	
*					
*					
*					

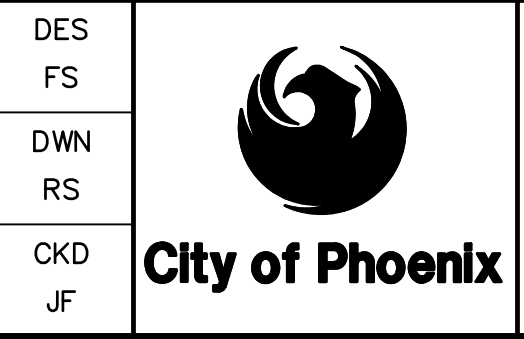

CITY OF PHOENIX  
WATER SERVICES DEPARTMENT

**LIFT STATION 40  
REFURBISHMENT**

MECHANICAL

**FERROUS CHLORIDE SYSTEM SECTION**

COPYRIGHT © 2007-JANUARY

CITY PROJECT NO. WS90400085

DATE: 08/2024

**M-19** SHEET 55 OF 134

CAD FILE: DSM4AB9Q05.DWG

USER: FBERASFRALD0 FILE: C:\pwworking\west01\03411629\05\_DSM4AB9Q05.dwg DATE: 9/04/24 TIME: 03:26pm

THIS DRAWING MUST BE FIELD VERIFIED BEFORE USE  
DRAWING NOT TO SCALE UNLESS SCALE BAR IS PRESENT

FOR CONSTRUCTION


"PER CITY OF PHOENIX CODE CHAPTER 2, SECTION 2--28, THESE PLANS ARE FOR OFFICIAL USE ONLY AND MAY NOT BE SHARED WITH OTHERS EXCEPT AS REQUIRED TO FULFILL THE OBLIGATIONS OF THE CONTRACTOR'S CONTRACT WITH THE CITY OF PHOENIX."  
THIS DOCUMENT MUST BE KEPT SECURE AT ALL TIMES.

CITY OF PHOENIX  
WATER SERVICES DEPARTMENT  
LS 40 REFURBISHMENT - EQUIPMENT SCHEDULE


VALVE SCHEDULE						
TAG NO.	SERVICE	TYPE	SIZE (IN)	ACTUATOR	COMMENTS	LOCATION
VLV-413	WASTE WATER	FULL-PORT PLUG VALVE	16	PNEUMATIC	-	PUMP 1 LS-P1 DISCHARGE
VLV-423	WASTE WATER	FULL-PORT PLUG VALVE	16	PNEUMATIC	-	PUMP 2 LS-P2 DISCHARGE
VLV-433	WASTE WATER	FULL-PORT PLUG VALVE	16	PNEUMATIC	-	PUMP 3 LS-P3 DISCHARGE
VLV-443	WASTE WATER	FULL-PORT PLUG VALVE	16	PNEUMATIC	-	PUMP 4 LS-P4 DISCHARGE
VLV-453	WASTE WATER	FULL-PORT PLUG VALVE	16	PNEUMATIC	-	PUMP 5 LS-P5 DISCHARGE
VLV-463	WASTE WATER	FULL-PORT PLUG VALVE	16	PNEUMATIC	-	PUMP 6 LS-P6 DISCHARGE
ARV-001	WASTE WATER	COMBINATION AIR/VACUUM VALVE	2	MANUAL	-	PUMP 1 LS-P1 DISCHARGE
ARV-002	WASTE WATER	COMBINATION AIR/VACUUM VALVE	2	MANUAL	-	PUMP 2 LS-P2 DISCHARGE
ARV-003	WASTE WATER	COMBINATION AIR/VACUUM VALVE	2	MANUAL	-	PUMP 3 LS-P3 DISCHARGE
ARV-004	WASTE WATER	COMBINATION AIR/VACUUM VALVE	2	MANUAL	-	PUMP 4 LS-P4 DISCHARGE
ARV-005	WASTE WATER	COMBINATION AIR/VACUUM VALVE	2	MANUAL	-	PUMP 5 LS-P5 DISCHARGE
ARV-006	WASTE WATER	COMBINATION AIR/VACUUM VALVE	2	MANUAL	-	PUMP 6 LS-P6 DISCHARGE
PV-001	WASTE WATER	FULL-PORT PLUG VALVE	16	MANUAL	-	PUMP 1 LS-P1 DISCHARGE
PV-002	WASTE WATER	FULL-PORT PLUG VALVE	16	MANUAL	-	PUMP 2 LS-P2 DISCHARGE
PV-003	WASTE WATER	FULL-PORT PLUG VALVE	16	MANUAL	-	PUMP 3 LS-P3 DISCHARGE
PV-004	WASTE WATER	FULL-PORT PLUG VALVE	16	MANUAL	-	PUMP 4 LS-P4 DISCHARGE
PV-005	WASTE WATER	FULL-PORT PLUG VALVE	16	MANUAL	-	PUMP 5 LS-P5 DISCHARGE
PV-006	WASTE WATER	FULL-PORT PLUG VALVE	16	MANUAL	-	PUMP 6 LS-P6 DISCHARGE
PV-007	WASTE WATER	FULL-PORT PLUG VALVE	24	MANUAL	-	24 INCH DISCHARGE HEADER
PV-008	WASTE WATER	FULL-PORT PLUG VALVE	24	MANUAL	-	24 INCH DISCHARGE HEADER
PV-009	WASTE WATER	FULL-PORT PLUG VALVE	24	MANUAL	-	24 INCH DISCHARGE HEADER
PV-010	WASTE WATER	FULL-PORT PLUG VALVE	24	MANUAL	-	24 INCH METER BYPASS
PV-011	WASTE WATER	FULL-PORT PLUG VALVE	24	MANUAL	-	24 INCH METER BYPASS
PV-012	WASTE WATER	FULL-PORT PLUG VALVE	24	MANUAL	-	24 INCH METER BYPASS
PV-013	WASTE WATER	FULL-PORT PLUG VALVE	24	MANUAL	-	24 INCH METER BYPASS
PV-014	WASTE WATER	FULL-PORT PLUG VALVE	24	MANUAL	-	24 INCH METER BYPASS
PV-015	WASTE WATER	FULL-PORT PLUG VALVE	24	MANUAL	-	24 INCH METER BYPASS
PV-016	WASTE WATER	FULL-PORT PLUG VALVE	24	MANUAL	-	24 INCH METER BYPASS
METER/SENSOR/GAUGE/TRANSMITTER SCHEDULE						
TAG NO.	SERVICE	TYPE	SIZE (IN)	ACTUATOR	COMMENTS	LOCATION
FE-500	WASTE WATER	MAGNETIC FLOW METER	24	N/A	-	24 INCH DISCHARGE HEADER
FE-501	WASTE WATER	MAGNETIC FLOW METER	24	N/A	-	24 INCH DISCHARGE HEADER
PSH-411	WASTE WATER	PRESSURE SWITCH	-	N/A	-	PUMP 1
PSH-421	WASTE WATER	PRESSURE SWITCH	-	N/A	-	PUMP 2
PSH-431	WASTE WATER	PRESSURE SWITCH	-	N/A	-	PUMP 3
PSH-441	WASTE WATER	PRESSURE SWITCH	-	N/A	-	PUMP 4
PSH-451	WASTE WATER	PRESSURE SWITCH	-	N/A	-	PUMP 5
PSH-461	WASTE WATER	PRESSURE SWITCH	-	N/A	-	PUMP 6
PI-411	WASTE WATER	PRESSURE GAUGE	-	N/A	-	PUMP 1
PI-421	WASTE WATER	PRESSURE GAUGE	-	N/A	-	PUMP 2
PI-431	WASTE WATER	PRESSURE GAUGE	-	N/A	-	PUMP 3
PI-441	WASTE WATER	PRESSURE GAUGE	-	N/A	-	PUMP 4
PI-451	WASTE WATER	PRESSURE GAUGE	-	N/A	-	PUMP 5
PI-461	WASTE WATER	PRESSURE GAUGE	-	N/A	-	PUMP 6
PIT-500	WASTE WATER	PRESSURE TRANSMITTER	-	N/A	-	24 INCH DISCHARGE HEADER
PIT-501	WASTE WATER	PRESSURE TRANSMITTER	-	N/A	-	24 INCH DISCHARGE HEADER
PI-500	WASTE WATER	PRESSURE GAUGE	-	N/A	-	24 INCH DISCHARGE HEADER
PI-501	WASTE WATER	PRESSURE GAUGE	-	N/A	-	24 INCH DISCHARGE HEADER
LIT-100	WASTE WATER	LEVEL TRANSMITTER	-	N/A	-	WET WELL
LIT-101	WASTE WATER	LEVEL TRANSMITTER	-	N/A	-	WET WELL
LIT-02	FERROUS CHLORIDE	LEVEL TRANSMITTER	-	N/A	-	FERROUS CHLORIDE TANK 1
LIT-04	FERROUS CHLORIDE	LEVEL TRANSMITTER	-	N/A	-	FERROUS CHLORIDE TANK 2
DPSH-511	BIOFILTER	DIFFERENTIAL PRESSURE SWITCH	-	N/A	-	BIOFILTER
DPSL-510	BIOFILTER	DIFFERENTIAL PRESSURE SWITCH	-	N/A	-	BIOFILTER
PSH-510	BIOFILTER	PRESSURE SWITCH	-	N/A	-	BIOFILTER
PUMP SCHEDULE						
TAG NO.	SERVICE	TYPE	HP	CAPACITY	TDH	COMMENTS
PMP-410	WASTE WATER	SOLID-PASSING SUBMERSIBLE PUMP	470	2,944 GPM	234 FT	480 V, 3 PH, 60 HZ
PMP-420	WASTE WATER	SOLID-PASSING SUBMERSIBLE PUMP	470	2,944 GPM	234 FT	480 V, 3 PH, 60 HZ
PMP-430	WASTE WATER	SOLID-PASSING SUBMERSIBLE PUMP	470	2,944 GPM	234 FT	480 V, 3 PH, 60 HZ
PMP-440	WASTE WATER	SOLID-PASSING SUBMERSIBLE PUMP	470	2,944 GPM	234 FT	480 V, 3 PH, 60 HZ
PMP-450	WASTE WATER	SOLID-PASSING SUBMERSIBLE PUMP	470	2,944 GPM	234 FT	480 V, 3 PH, 60 HZ
PMP-460	WASTE WATER	SOLID-PASSING SUBMERSIBLE PUMP	470	2,944 GPM	234 FT	480 V, 3 PH, 60 HZ
MPN-1000	FERROUS CHLORIDE	METERING PUMP	5.5	3 GPM	20 FT	120 V, 60 HZ
MPN-1002	FERROUS CHLORIDE	METERING PUMP	5.5	3 GPM	20 FT	120 V, 60 HZ
MPN-1004	FERROUS CHLORIDE	METERING PUMP	5.5	3 GPM	20 FT	120 V, 60 HZ
MPN-1005	FERROUS CHLORIDE	METERING PUMP	5.5	3 GPM	20 FT	120 V, 60 HZ
PIPE SCHEDULE						
DIAMETER (IN)	PIPE MATERIAL	PRESSURE CLASS	COMMENTS	LOCATION		
1	PVC	SCHEDULE 80	DOUBLE CONTAINED	FERROUS CHLORIDE SOLUTION PIPE		
4	PVC	SCHEDULE 80	GRAVITY SEWER	ELECTRICAL BUILDING SEWER SERVICE		
6	DIP	250	-	DRAIN LINE FROM FORCE MAIN AND INJECTION TRENCH		
8	CPVC	SCHEDULE 80	-	DRAIN LINE FROM BIOFILTER		
24	DIP	250	BURIED - EXTERIOR POLYETHYLENE ENCASED AND BITUMINOUS COATED INTERIOR - CEMENT MORTAR LINED	PUMP DISCHARGE PIPING		
24	DIP	250	ABOVE GRADE - POLYURETHANE COATED INTERIOR - CEMENT MORTAR LINED	PUMP DISCHARGE PIPING		
16	DIP	250	-	PUMP DISCHARGE PIPING		
2	COPPER	TYPE K	-	POTABLE WATER (EMERGENCY EYE WASH AND HOSE BIB)		
3	COPPER	TYPE K	-	POTABLE WATER (EMERGENCY EYE WASH AND HOSE BIB)		
42	VCP	-	GRAVITY SEWER	GRAVITY SEWER TO WET WELL		
20	FRP	-	FOUL AIR DUCT	WET WELL TO BIOFILTER		
MISCELLANEOUS EQUIPMENT SCHEDULE						
TAG NO.	SERVICE	TYPE	POWER	COMMENTS	LOCATION	
GEN-LS40	BACKUP ELECTRICITY	DIESEL GENERATOR	2,500 KW	-	GENERATOR SLAB	
FAN-510	ODOR CONTROL	BIOFILTER BLOWER	10 HP	-	BIOFILTER	
TANK SCHEDULE						
TANK ID	LOCATION	SERVICE	TYPE	CAPACITY	DIAMETER (FT)	COMMENTS
FERROUS CHLORIDE TANK 1	FERROUS CHLORIDE STORAGE SLAB	FERROUS CHLORIDE	VERTICAL	7,800 GAL	12	-
FERROUS CHLORIDE TANK 2	FERROUS CHLORIDE STORAGE SLAB	FERROUS CHLORIDE	VERTICAL	7,800 GAL	12	-

THIS DRAWING WAS SUPPLIED BY A CONSULTANT ENGINEER FROM A FIRM THAT IS NOT LICENSED IN THE STATE OF ARIZONA. THE CITY OF PHOENIX DOES NOT WARRANT THE ACCURACY OR COMPLETENESS OF THE INFORMATION PROVIDED BY THE CONTRACTOR TO PROVIDE THE RECORD DRAWING. THE CITY DOES NOT WARRANT THIS DRAWING TO BE A COMPLETE AND ACCURATE PORTRAYAL OF FACILITIES AS THEY EXIST IN THE FIELD.

FOR CITY OF PHOENIX USE ONLY - REFERENCE CID NUMBER: #	REVISION ENGINEERING COMPANY	PROJECT NO.	PROJECT NAME	DATE	CAD FILE NAME	DWG NUMBER	REMARKS

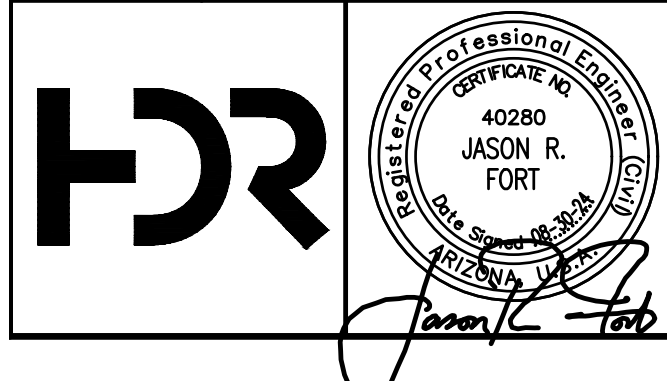

REVISIONS				
NO.	BY	DATE	CKD	REMARKS
A	RS	10/2023	JF	30% SUBMITTAL
B	RS	01/2024	JF	90% SUBMITTAL
C	RS	04/2024	JF	AGENCY REVIEW
D	DFD	08/2024	JF	ISSUED FOR CONSTRUCTION
*				
*				
*				

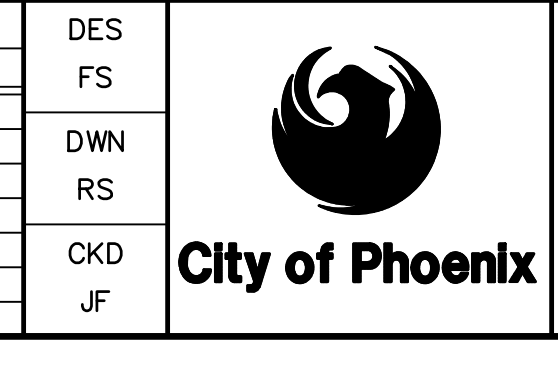

CITY OF PHOENIX  
WATER SERVICES DEPARTMENT  
  
LIFT STATION 40  
REFURBISHMENT

MECHANICAL  
  
EQUIPMENT SCHEDULE

COPYRIGHT © 2007--JANUARY  
CITY PROJECT NO. WS90400085  
DATE: 08/2024  
M-20 SHEET 56 OF 134  
CAD FILE: DSM4AB9X01.dwg



THIS DRAWING MUST BE FIELD VERIFIED BEFORE USE. DRAWING NOT TO SCALE UNLESS SCALE BAR IS PRESENT.

FOR CONSTRUCTION

"PER CITY OF PHOENIX CODE CHAPTER 2-28, THESE PLANS ARE FOR OFFICIAL USE ONLY AND MAY NOT BE SHARED WITH OTHERS EXCEPT AS REQUIRED TO FULFILL THE OBLIGATIONS OF THE CONTRACTOR'S CONTRACT TO THE CITY OF PHOENIX." THIS DOCUMENT MUST BE KEPT SECURE AT ALL TIMES.

GENERAL STRUCTURAL NOTES (GSN)

GENERAL

- G1. SCOPE: THE NOTES ON THIS SHEET AND THE STANDARD STRUCTURAL DETAILS ARE GENERAL AND APPLY TO THE ENTIRE PROJECT...
G2. CONTRACT DOCUMENTS: CONTRACT DOCUMENTS SHOW THE FINISHED PRODUCT...
G3. APPLICABLE SPECIFICATIONS AND CODES: A. INTERNATIONAL BUILDING CODE (IBC 2018) WITH APPLICABLE EDITIONS...
G4. DESIGN CRITERIA (APPLIES TO ALL STRUCTURES UNO): A. DEAD LOAD: 1. ACTUAL TRIBUTARY STRUCTURE WEIGHT...
G5. GEOTECHNICAL: THE FOLLOWING NON-CONTRACTUAL GEOTECHNICAL REPORT WAS DEVELOPED FOR THIS PROJECT...
G6. SAFETY: SAFETY AND STRUCTURE STABILITY DURING CONSTRUCTION ARE THE SOLE RESPONSIBILITY OF THE CONTRACTOR...
G7. SPECIAL INSPECTIONS: SPECIAL INSPECTIONS ARE REQUIRED IN ACCORDANCE WITH CHAPTER 1 AND CHAPTER 17 OF THE IBC...

GENERAL (CONTINUED)

- G8. STANDARD DETAILS: THE STANDARD DETAILS DEPICT TYPICAL DETAILING TO BE USED ON THIS PROJECT...
G9. EXISTING CONSTRUCTION: THE CONTRACTOR SHALL FIELD VERIFY ALL DIMENSIONS AND ELEVATIONS OF EXISTING CONSTRUCTION...
G10. CONFLICTS: IN CASES WHERE CONFLICTS OCCUR BETWEEN THE DRAWINGS OR BETWEEN THE DRAWINGS AND THE SPECIFICATIONS...
G11. DIMENSIONS: STRUCTURAL DIMENSIONS CONTROLLED BY OR RELATED TO MECHANICAL OR ELECTRICAL EQUIPMENT SHALL BE VERIFIED...
G12. OPENINGS: OPENINGS FOR PIPES, DUCTS, CONDUITS, ETC. ARE NOT ALL SHOWN ON THE STRUCTURAL DRAWINGS...
G13. CONSTRUCTION JOINTS: UNLESS SHOWN ON THE STRUCTURAL DRAWINGS, LOCATION OF ALL CONSTRUCTION JOINTS SHALL HAVE THE APPROVAL OF THE ENGINEER...
G14. PROVISIONS FOR EQUIPMENT: MECHANICAL AND ELECTRICAL EQUIPMENT SUPPORTS, ANCHORAGES, OPENINGS, RECESSES, AND REVEALS NOT SHOWN ON THE STRUCTURAL DRAWINGS...
G15. EQUIPMENT: CONTRACTOR TO SUBMIT FOR REVIEW ALL EQUIPMENT SIZES, OPERATING WEIGHTS, VIBRATION FORCES...
G16. CONTRACTOR DESIGNED ELEMENTS: WHEN THE SPECIFICATIONS REQUIRE STRUCTURAL CALCULATIONS BY THE CONTRACTOR...
CONCRETE
C1. DESIGN STRENGTHS: f'c = 4,000 PSI, TYPE 1 UNO; REINFORCING fy = 60,000 PSI
C2. CONCRETE COVER: UNLESS NOTED OTHERWISE OR SHOWN, PROVIDE CONCRETE COVER FOR REINFORCING AS FOLLOWS: CONCRETE DEPOSITED AGAINST EARTH: 3 IN; ALL OTHER: 2 IN
C3. ALL DETAILING, FABRICATION, AND ERECTION OF REINFORCING BARS, UNLESS OTHERWISE NOTED...
C4. REFER TO OTHER DISCIPLINE DRAWINGS PRIOR TO CONSTRUCTION FOR EMBEDDED ITEMS AND PENETRATIONS...
C5. PLACE CONCRETE IN CONTINUOUS OPERATION WITHIN PLANNED JOINTS OR SECTIONS...
C6. PROVIDE 3/4 IN CHAMFERS AT ALL EXPOSED EDGES...
C7. FIELD ADJUST REINFORCING AT OPENINGS AND EMBEDDED ITEMS AS INDICATED.
C8. ANCHOR BOLTS NOT SPECIFIED BY ENGINEER SHALL BE DESIGNED AND CERTIFIED BY A REGISTERED PROFESSIONAL ENGINEER...
C9. CONTINUOUS WATERSTOP SHALL BE INSTALLED IN JOINTS SUBJECT TO STATIC WATER PRESSURE...
C10. ABSOLUTELY NO WELDING OF REINFORCING BARS OR TORCHING TO BEND REINFORCING BARS...
C11. CONTRACTOR SHALL SUBMIT A CONCRETE PLACEMENT PLAN PER SPECIFICATION SECTION 03 15 16 IDENTIFYING JOINT TYPES...
C12. ALL CAST IN PLACE AND POST-INSTALLED ANCHORS INDICATED IN THE STRUCTURAL DOCUMENTS SHALL COMPLY WITH CHAPTER 17 OF ACI 318...

MASONRY NOTES:

- M1. MASONRY CONSTRUCTION SHALL CONFORM TO CHAPTER 21 OF THE 2018 IBC. QUALITY ASSURANCE SHALL BE LEVEL 2 PER TMS 402/602, TABLE 3 AND TABLE 4.
M2. DESIGN STRENGTHS: MINIMUM COMPRESSIVE STRENGTH OF CMU = 2000 PSI; MORTAR MINIMUM COMPRESSIVE STRENGTH = 2000 PSI; GROUT MINIMUM COMPRESSIVE STRENGTH = 2000 PSI; F'm= 2000 PSI; Fy = 60,000 PSI
M3. GROUT FOR FILLING MASONRY CAVITIES TO BE COARSE GROUT UNO, MAXIMUM COARSE AGGREGATE SIZE IS 3/8 INCH.
M4. GROUT POURS SHALL NOT EXCEED 4 FEET IN HEIGHT UNLESS CLEANOUTS ARE PROVIDED IN THE BOTTOM COURSE OF THE CELL(S) TO BE GROUTED...
M5. REINFORCING STEEL: ALL REINFORCING STEEL SHALL BE ASTM A615, GRADE 60, DEFORMED.
M6. LAP SPLICES: LAP SPLICES OF MASONRY REINFORCING SHALL BE PER STANDARD DETAILS.
M7. RESTRICTED BAR ANCHORAGE: IN CASES WHERE REINFORCING BARS CANNOT BE EXTENDED AS FAR AS REQUIRED...
M8. ANCHOR BOLTS: ALL MECHANICAL AND ADHESIVE ANCHORS SHALL HAVE AN ICC REPORT SHOWING EQUIVALENT LOAD CAPACITY...
M9. IF BOND BEAMS AT INTERSECTING WALLS ARE SHOWN ON THE DRAWINGS TO MEET AT DIFFERENT ELEVATIONS...
M10. LINTEL BLOCKS SHALL NOT BE USED AS BOND BEAM BLOCKS EXCEPT AT OPENINGS WHERE BOND BEAMS AND LINTELS COINCIDE.
M11. GROUT PLACEMENT SHALL CONFORM WITH THE REQUIREMENTS OF CHAPTER 21 OF THE 2018 IBC.
M12. ALL CORNERS, INTERSECTIONS, AND ANGLED WALLS SHALL BE TIED TOGETHER WITH REINFORCING STEEL AND GROUTED SOLID.
M13. GROUT WALL SOLID BELOW GRADE AND AT ALL CELLS CONTAINING REINFORCING.
M14. MORTAR COLOR TO MATCH COLOR OF CMU BLOCK.
STEEL
S1. DESIGN STRENGTHS: WIDE FLANGE AND TEES: Fy = 50 KSI; PIPE: Fy = 35 KSI; STAINLESS STEEL: Fy = 33 KSI; HSS SECTIONS: Fy = 46 KSI; ALL OTHER PLATES AND SHAPES: Fy = 36 KSI
S2. DIMENSIONS: TO CENTERLINES OF COLUMNS AND BEAMS, TOP SURFACES OF BEAMS AND TUBES AND BACKS OF CHANNELS AND ANGLES UNO.
S3. ELEVATIONS: TOP OF STEEL REFERS TO TOP SURFACE OF MEMBER OR FLANGE UNO.
S4. WHEN FILLET WELD SIZE IS NOT INDICATED, PROVIDE MAXIMUM WELD SIZE BASED ON MATERIAL THICKNESS...
S5. ALL BOLTED STRUCTURAL CONNECTIONS ARE BEARING TYPE CONNECTIONS, UNO. BOLTED CONNECTIONS SHALL BE MADE USING ASTM F3125 GRADE A325 GALVANIZED BOLTS, UNO.
S6. CONFORM TO AISC 360, STEEL CONSTRUCTION MANUAL AND AISC 341, SEISMIC DESIGN MANUAL.
S7. ALL STEEL, BOLTS, PLATES, SHAPES, AND CONNECTION ASSEMBLIES SHALL BE HOT DIP GALVANIZED AFTER FABRICATION...
STEEL DECK
SD1. THE DESIGN, FABRICATION, AND ERECTION OF METAL DECKING SHALL BE IN ACCORDANCE WITH THE CURRENT EDITION OF THE SDI SPECIFICATIONS...
SD2. STEEL ROOF DECK IS AS SHOWN ON THE PLANS AND SHALL BE DESIGNED FOR THE DEAD AND LIVE LOADS INDICATED ON THE DRAWINGS.
SD3. STEEL ROOF DECK IS TO BE A STRUCTURAL DIAPHRAGM AND SHALL BE CONNECTED TO THE STRUCTURE AS INDICATED IN THE SPECIFICATIONS.
SD4. THE DRAWINGS INDICATE DECK SPAN DIRECTION.
SD5. SUSPENDED CEILINGS, LIGHT FIXTURES, DUCTS, AND OTHER UTILITIES SHALL NOT BE SUPPORTED FROM THE STEEL DECK.
SD6. SPECIAL INSPECTIONS FOR STEEL ROOF DECK SHALL BE IN ACCORDANCE WITH THE QUALITY ASSURANCE INSPECTION REQUIREMENTS OF SDI QA/QC.

STEEL JOISTS

- SJ1. STEEL JOIST DESIGN, FABRICATION AND ERECTION SHALL BE IN ACCORDANCE WITH THE CURRENT EDITION OF THE STANDARD SPECIFICATIONS FOR OPEN WEB STEEL JOIST BY THE STEEL JOIST INSTITUTE.
SJ2. STEEL JOISTS DEPTH AND TYPE AS SHOWN ON THE DRAWINGS AND SHALL BE DESIGNED FOR THE LOADINGS INDICATED ON THE DRAWINGS...
SJ3. STEEL JOISTS AND BRIDGING SHALL BE DESIGNED BY THE MANUFACTURER'S PROFESSIONAL ENGINEER TO RESIST THE LOADS INDICATED ON THE DRAWINGS.
SJ4. CONCENTRATED LOADS SHALL BE LOCATED WITHIN 4 INCHES OF A PANEL POINT OR SPECIAL REINFORCEMENT MUST BE ADDED PER STANDARD DETAILS.
SJ5. JOIST BRIDGING SHALL BE DESIGNED BY THE STEEL JOIST MANUFACTURER.
SJ6. ADJUST JOIST BRIDGING DESIGN AND DETAILING WHERE MECHANICAL DUCTS OR OTHER OBSTRUCTIONS RUN BETWEEN THE JOISTS.
SJ7. AT COMPLETION OF MANUFACTURE, THE STEEL JOISTS MANUFACTURER SHALL SUBMIT A CERTIFICATE OF COMPLIANCE PER SECTION 2207.5 OF THE 2018 IBC.
POST INSTALLED ANCHORS
PA1. POST-INSTALLED ANCHORS SHALL ONLY BE USED WHERE SPECIFIED ON THE CONTRACT DRAWINGS OR WHERE APPROVED IN WRITING BY THE ENGINEER...
PA2. CARE SHALL BE TAKEN IN PLACING POST-INSTALLED ANCHORS TO AVOID CONFLICTS WITH EXISTING REINFORCING...
PA3. SPECIAL INSPECTION SHALL BE PROVIDED BY THE OWNER OR HIS DESIGNATED REPRESENTATIVE FOR ALL CAST-IN-PLACE, ADHESIVE AND MECHANICAL ANCHOR INSTALLATIONS...
PA4. SUBSTITUTION REQUESTS, FOR PRODUCTS OTHER THAN THOSE SPECIFIED, SHALL BE SUBMITTED BY THE CONTRACTOR TO THE ENGINEER...
PA5. UNLESS NOTED OTHERWISE ON PLANS, ACCEPTABLE POST-INSTALLED CONCRETE ANCHOR PRODUCTS SHALL BE ADHESIVE ANCHORS FOR USE IN CRACKED CONCRETE...
DEFERRED SUBMITTALS:
DS1. DEFERRED SUBMITTALS ARE THOSE PORTIONS OF THE DESIGN WHICH ARE NOT SUBMITTED AT THE TIME OF PERMIT APPLICATION...
DS2. THE FOLLOWING IS A LIST OF DEFERRED SUBMITTALS PER IBC SECTION 107.3.4.1 THAT ARE EXPECTED TO CONTAIN STRUCTURAL CALCULATIONS OR SAFETY RELATED SYSTEM INFORMATION...

Table with 2 columns: SPECIFICATION SECTION, ITEM. Rows include 05 21 00 STEEL JOISTS, 05 30 00.15 METAL DECKING ROOF, 05 50 00 MISCELLANEOUS METAL FABRICATIONS, 05 52 00.15 METAL RAILINGS ALUMINUM, 06 74 13 FIBERGLASS REINFORCED PLASTIC GRATINGS, HANDRAILS, AND RAILINGS, and OTHER ROOF MOUNTED MECHANICAL EQUIPMENT SCREENWALL...


FACILITY DRAWINGS: This drawing was supplied by a Consultant Engineer from a past project and is being provided for information only. The City does not warrant this drawing to be a complete and accurate portrayal of facilities as they exist in the field.

Table with 4 columns: FOR CITY OF PHOENIX USE ONLY, REFERENCE, CID NUMBER, PROJECT NO. Includes rows for REVISION ENGINEERING COMPANY, PROJECT NO., DATE, DWG NUMBER, CAD FILE NAME, REMARKS.



Table with 2 columns: NO., BY, DATE, CKD, REMARKS. Shows revision history for 90% SUBMITTAL, AGENCY REVIEW, and ISSUED FOR CONSTRUCTION.

Table with 2 columns: DES, RW, CKD, TH. Shows design and review status for various items.

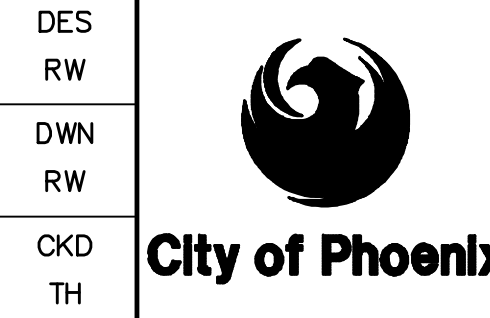

CITY OF PHOENIX WATER SERVICES DEPARTMENT LIFT STATION 40 REFURBISHMENT

STRUCTURAL GENERAL STRUCTURAL NOTES

COPYRIGHT © 2007-JANUARY CITY PROJECT NO. WS90400085 DATE: 08/2024 S-01 SHEET 57 OF 134 CAD FILE: CSSL40A01.dwg

THIS DRAWING MUST BE FIELD VERIFIED BEFORE USE  
DRAWING NOT TO SCALE UNLESS SCALE BAR IS PRESENT

FOR CONSTRUCTION

\*PER CITY OF PHOENIX CODE CHAPTER 2-28, THESE PLANS ARE FOR OFFICIAL USE ONLY AND MAY NOT BE SHARED WITH OTHERS EXCEPT AS REQUIRED TO FULFILL THE OBLIGATIONS OF THE CONTRACTOR'S CONTRACT WITH THE CITY OF PHOENIX.  
THIS DOCUMENT MUST BE KEPT SECURE AT ALL TIMES.

SCHEDULE OF SPECIAL INSPECTION SERVICES			
INSPECTION ITEM REQUIRED	FREQUENCY		CODE REFERENCE
	CONTINUOUS*	PERIODIC	
<b>GENERAL STRUCTURAL OBSERVATIONS</b>			
CONDUCT VISUAL OBSERVATION OF THE STRUCTURAL SYSTEMS FOR GENERAL CONFORMANCE TO THE CONSTRUCTION DOCUMENTS. PREPARE WEEKLY REPORT OF OBSERVATIONS DESCRIBING WORK PROGRESS AND NON-CONFORMING ITEMS.	-	X	IBC 1704.2.4
<b>STRUCTURAL STEEL</b>			
VERIFY FABRICATOR CERTIFICATION	-	X	
MATERIAL VERIFICATION OF BOLTS, NUTS, AND WASHERS: IDENTIFICATION MARKINGS TO CONFORM TO ASTM STANDARDS SPECIFIED IN THE APPROVED CONSTRUCTION DOCUMENTS. VERIFY ALL ARE GALVANIZED.	-	X	APPLICABLE ASTM MATERIAL STANDARDS
MATERIAL VERIFICATION OF BOLTS, NUTS, AND WASHERS: MANUFACTURER'S CERTIFICATE OF COMPLIANCE.	-	X	
INSPECTION OF BOLTING: SNUG-TIGHT JOINTS.	-	X	
INSTALLATION OF NEW BOLT HOLES IN EXISTING STRUCTURAL STEEL ROOF FRAMING MEMBERS: VERIFICATION OF SIZE AND LOCATION OF HOLES AND INSPECTION OF TOUCH-UP AS SPECIFIED IN THE APPROVED CONSTRUCTION DOCUMENTS.	-	X	AISC 360 SECTION N5
INSPECTION OF WELDING: FILLET WELDS < OR = 5/16"	-	X	
INSPECTION OF WELDING CJP WELDS.	X	-	
<b>OPEN-WEB STEEL JOISTS AND JOISTS GIRDERS</b>			
1. INSTALLATION OF OPEN-WEB STEEL JOISTS AND JOIST GIRDERS			
a. END CONNECTIONS - WELDING OR BOLTED.	-	X	SJI SPECIFICATIONS LISTED IN SECTION 2207.1 OF THE IBC
b. BRIDGING - HORIZONTAL OR DIAGONAL.	-	-	
2. STANDARD BRIDGING.	-	X	SJI SPECIFICATIONS LISTED IN SECTION 2207.1 OF THE IBC
3. BRIDGING THAT DIFFERS FROM THE SJI SPECIFICATIONS LISTED IN SECTION 2207.1 OF THE IBC.	-	X	
<b>CONCRETE AND REINFORCING STEEL</b>			
			IBC TABLE 1705.3
INSPECTION OF REINFORCING STEEL AND PLACEMENT.	-	X	ACI 318: CH 20, 25.2, 25.3, 26.6.1-26.6.3
INSPECTION OF ANCHORS INSTALLED IN HARDENED CONCRETE.	X	-	ACI 318: 17.8.2
VERIFYING USE OF REQUIRED DESIGN MIX.	-	X	ACI 318: CH 19, 26.4.3, 26.4.4
AT THE TIME FRESH CONCRETE IS SAMPLED TO FABRICATE SPECIMENS FOR STRENGTH TESTS, PERFORM SLUMP AND AIR CONTENT TESTS, AND DETERMINE THE TEMPERATURE OF THE CONCRETE.	X	-	ASTM C172, ASTM C31, ACI 318: 26.5, 26.12
INSPECTION FOR MAINTENANCE OF SPECIFIED CURING TEMPERATURE AND TECHNIQUES.	-	X	ACI 318: 26.5.3-26.5.5
INSPECT FORMWORK FOR SHAPE, LOCATION, AND DIMENSIONS OF THE CONCRETE MEMBER BEING FORMS.	-	X	ACI 318: 26.11.1.2(b)
DURING THE REPAIR OF SURFACE DEFECTS IN THE EXISTING CONCRETE SURFACES, VERIFY REPAIR TECHNIQUE WITH APPROVED REPAIR PROCESS AND PROVIDE ALL INSPECTIONS THAT ARE REQUIRED FOR NEW INSTALLATION.	X	-	IBC 110.3.9
<b>MASONRY CONSTRUCTION (LEVEL 2)</b>			
			TMS 602 TABLE 3 AND TABLE 4
<b>MINIMUM VERIFICATION</b>			
PRIOR TO CONSTRUCTION, VERIFY CERTIFICATES OF COMPLIANCE USED IN MASONRY CONSTRUCTION.	-	-	
PRIOR TO CONSTRUCTION, VERIFICATION OF f <sub>m</sub> , EXCEPT WHERE SPECIFICALLY EXEMPTED BY THE CODE.	-	-	ARTICLE 1.4B
PRIOR TO CONSTRUCTION, VERIFICATION OF COMPLIANCE OF APPROVED SUBMITTALS.	-	-	ARTICLE 1.5
<b>MINIMUM TESTS</b>			
1. AS MASONRY CONSTRUCTION BEGINS, VERIFY THAT THE FOLLOWING ARE IN COMPLIANCE:			
a. PROPORTIONS OF SITE-PREPARED MORTAR	-	X	TMS 602 ARTICLE 2.1, 2.6A, 2.6C
b. GRADE, TYPE, AND SIZE OF REINFORCEMENT, CONNECTORS, AND ANCHORAGES	-	X	TMS 602 ARTICLE 3.4, 3.6A
2. PRIOR TO GROUTING, VERIFY THAT THE FOLLOWING ARE IN COMPLIANCE:			
a. GROUT SPACE	-	X	TMS 602 ARTICLE 3.2D, 3.2F
b. PLACEMENT OF REINFORCEMENT, CONNECTORS AND ANCHOR BOLTS	-	X	TMS 602 ARTICLE 3.2E, 3.4
c. PROPORTIONS OF SITE-PREPARED GROUT	-	X	TMS 602 ARTICLE 2.6B, 2.4G.1b

SCHEDULE OF SPECIAL INSPECTION SERVICES			
INSPECTION ITEM REQUIRED	FREQUENCY		CODE REFERENCE
	CONTINUOUS*	PERIODIC	
<b>MASONRY CONSTRUCTION (CONT)</b>			
3. VERIFY DURING CONSTRUCTION:			
a. MATERIALS AND PROCEDURES WITH THE APPROVED SUBMITTALS.			TMS 602 ARTICLE 1.5
b. PLACEMENT OF MASONRY UNITS AND MORTAR JOINT CONSTRUCTION.	-	X	TMS 602 ARTICLE 3.3B
c. SIZE AND LOCATION OF STRUCTURAL ELEMENTS	-	X	TMS 602 ARTICLE 3.3F
d. TYPE, SIZE, AND LOCATION OF ANCHORS, INCLUDING OTHER DETAILS OF ANCHORAGE OF MASONRY TO STRUCTURAL MEMBERS, FRAMES OR OTHER CONSTRUCTION	-	X	TMS 402 SECTIONS 1.2.1(e), 6.2.1, 6.3.1
e. PREPARATION, CONSTRUCTION, AND PROTECTION OF MASONRY DURING COLD WEATHER (TEMPERATURE BELOW 40° F) OR HOT WEATHER (TEMPERATURE BELOW 90° F)	-	X	TMS 602 ARTICLE 1.8C, 1.8D
f. PLACEMENT OF GROUT	X	-	TMS 602 ARTICLE 3.5, 3.6C
4. OBSERVE PREPARATION OF GROUT SPECIMENS, MORTAR SPECIMENS, AND/OR PRISM	-	X	TMS 602 ARTICLE 1.4B
<b>SOIL &amp; EARTHWORK</b>			
VERIFY MATERIALS BELOW SHALLOW FOUNDATIONS ARE ADEQUATE TO ACHIEVE THE DESIGN BEARING CAPACITY.	-	X	
VERIFY EXCAVATIONS ARE EXTENDED TO PROPER DEPTH AND HAVE REACHED PROPER MATERIAL.	-	X	
PERFORM CLASSIFICATION AND TESTING OF COMPACTED FILL MATERIALS.	-	X	IBC TABLE 1705.6
VERIFY USE OF PROPER MATERIALS, DENSITIES, AND LIFT THICKNESS DURING PLACEMENT AND COMPACTION OF COMPACTED FILL.	X	-	
PRIOR TO PLACEMENT OF COMPACTED FILL, OBSERVE SUBGRADE AND VERIFY THAT SITE HAS BEEN PREPARED PROPERLY.	-	X	

**TESTING AND INSPECTION FOR QUALITY ASSURANCE:**

- THE BUILDING CODE (2018 IBC WITH CITY OF PHOENIX AMENDMENTS) SECTION 1704 REQUIRES THAT QUALIFIED SPECIAL INSPECTORS, WHO ARE CONTRACTUALLY INDEPENDENT OF THE CONTRACTOR AND ARE APPROVED BY BUILDING OFFICIAL, PERFORM ALL SPECIAL INSPECTION DUTIES AND RESPONSIBILITIES AS REQUIRED BY THE BUILDING CODE.
- THE FOLLOWING SCHEDULE CONTAINS A LIST OF SPECIAL INSPECTION ACTIVITIES RELATED TO THE QUALITY ASSURANCE PLAN REQUIRED BY THE BUILDING CODE (CHAPTER 17) FOR THE FABRICATION, ERECTION AND CONSTRUCTION OF THE STRUCTURAL SYSTEMS AS SHOWN ON THE CONTRACT DOCUMENTS FOR THE PROJECT. ALL INSPECTORS SHALL BE QUALIFIED BY TRAINING AND EXPERIENCE FOR THE REQUIRED INSPECTIONS AND TEST PROCEDURES. REFER TO BUILDING CODE CHAPTER 17 "STRUCTURAL TESTS AND SPECIAL INSPECTIONS" FOR SPECIFIC TEST PROCEDURES.
- TESTING AND INSPECTION REPORTS SHALL BE PREPARED FOR EACH INSPECTION ITEM ON A DAILY BASIS WHENEVER WORK IS PERFORMED ON THAT ITEM. REPORTS SHALL BE DISTRIBUTED TO THE OWNER, CONTRACTOR, MARICOPA COUNTY (IF REQUESTED), AND THE ENGINEER FOR THEIR REVIEW, COMMENT, AND ACTION, AS NEEDED.
- THE CONTRACTOR SHALL SUBMIT A STATEMENT OF RESPONSIBILITY CONTAINING THE FOLLOWING:
  - ACKNOWLEDGEMENT OF AWARENESS OF THE SPECIAL REQUIREMENTS CONTAINED IN THE STATEMENT OF SPECIAL INSPECTIONS.
  - ACKNOWLEDGEMENT THAT CONTROL WILL BE EXERCISED TO OBTAIN CONFORMANCE WITH THE CONSTRUCTION DOCUMENTS APPROVED BY THE BUILDING OFFICIAL.
  - PROCEDURES FOR EXERCISING CONTROL WITHIN THE CONTRACTOR'S ORGANIZATION, THE METHOD AND FREQUENCY OF REPORTING AND THE DISTRIBUTION OF THE REPORTS.
  - IDENTIFICATION AND QUALIFICATIONS OF THE PERSON(S) EXERCISING SUCH CONTROL AND THEIR POSITION(S) IN THE ORGANIZATION.

FACILITY DRAWINGS  
This drawing was supplied by a Consultant Engineer from a past contract. The City does not warrant this drawing to be a complete and accurate portrayal of facilities as they exist in the field.

FOR CITY OF PHOENIX USE ONLY - REFERENCE CID NUMBER: #	PROJECT NO.	PROJECT NAME	DATE	CAD FILE NAME	DWG NUMBER	REMARKS



REVISIONS					
NO.	BY	DATE	CKD	REMARKS	DES
A	RW	01/2024	TH	90% SUBMITTAL	RW
B	RW	04/2024	TH	AGENCY REVIEW	DWN
C	RW	08/2024	TH	ISSUED FOR CONSTRUCTION	RW
					CKD
					TH



CITY OF PHOENIX  
WATER SERVICES DEPARTMENT  
  
LIFT STATION 40  
REFURBISHMENT


STRUCTURAL  
  
SPECIAL INSPECTION SCHEDULE  
  
COPYRIGHT © 2007-JANUARY  
CITY PROJECT NO. WS90400085  
DATE: 08/2024  
S-02 SHEET 58 OF 134  
CAD FILE: CSSL40A02.dwg



THIS DRAWING MUST BE FIELD VERIFIED BEFORE USE DRAWING NOT TO SCALE UNLESS SCALE BAR IS PRESENT


FOR CONSTRUCTION

\*PER CITY OF PHOENIX CODE CHAPTER 2-28, THESE PLANS ARE FOR OFFICIAL USE ONLY AND MAY NOT BE SHARED WITH OTHERS EXCEPT AS REQUIRED TO FULFILL THE OBLIGATIONS OF THE CONTRACTOR'S CONTRACT TO THE CITY OF PHOENIX. THIS DOCUMENT MUST BE KEPT SECURE AT ALL TIMES.

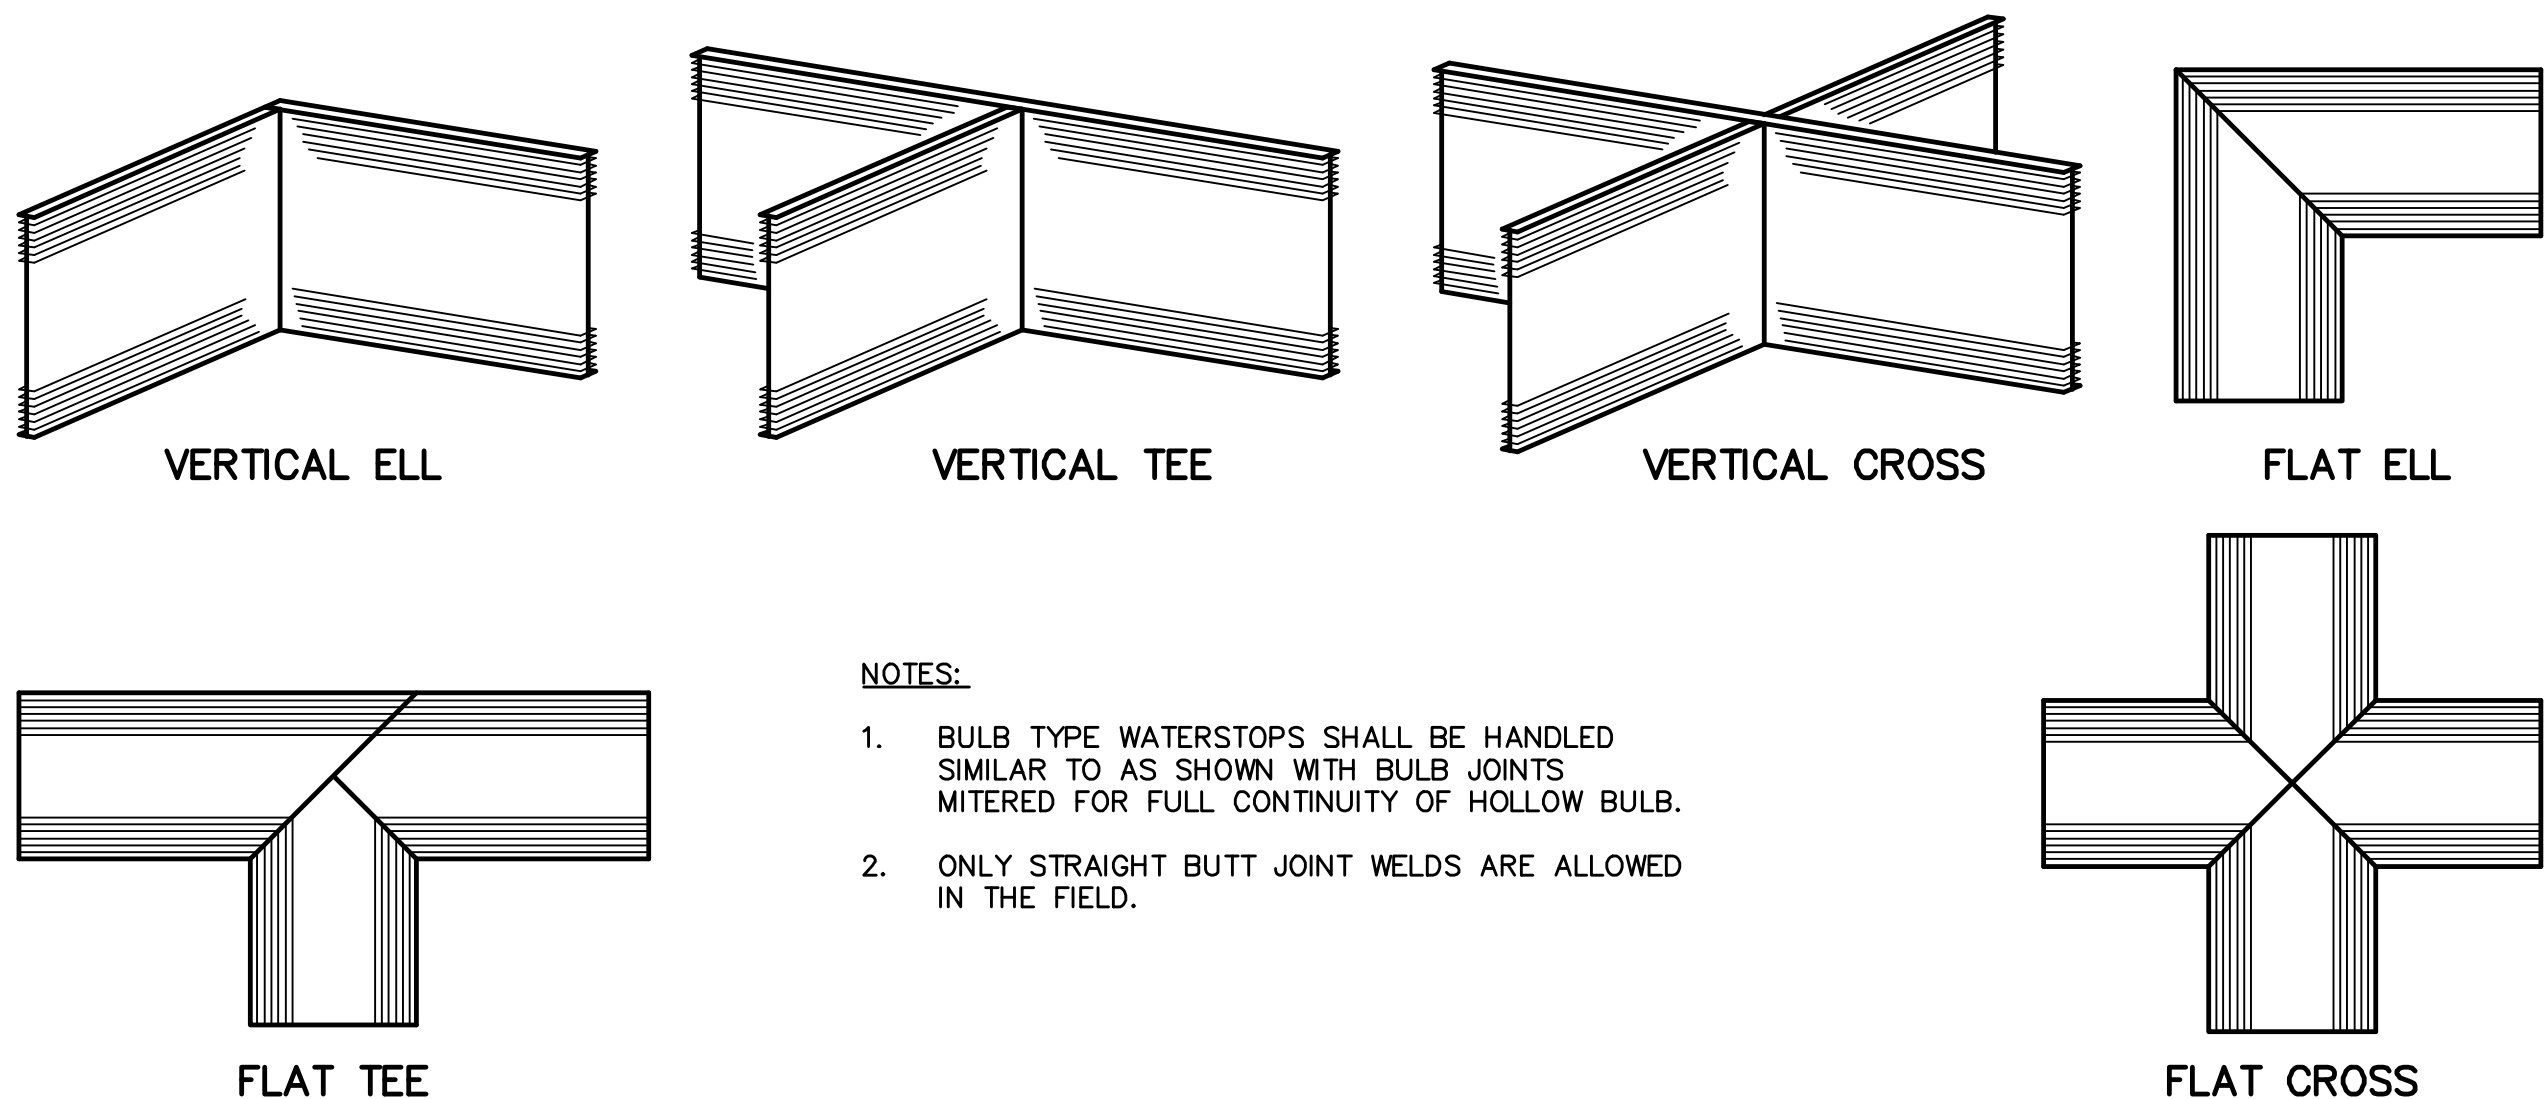


- NOTES:**
- BULB TYPE WATERSTOPS SHALL BE HANDLED SIMILAR TO AS SHOWN WITH BULB JOINTS MITERED FOR FULL CONTINUITY OF HOLLOW BULB.
  - ONLY STRAIGHT BUTT JOINT WELDS ARE ALLOWED IN THE FIELD.

**SHOP FABRICATED WATERSTOP** 1  
SCALE: NTS

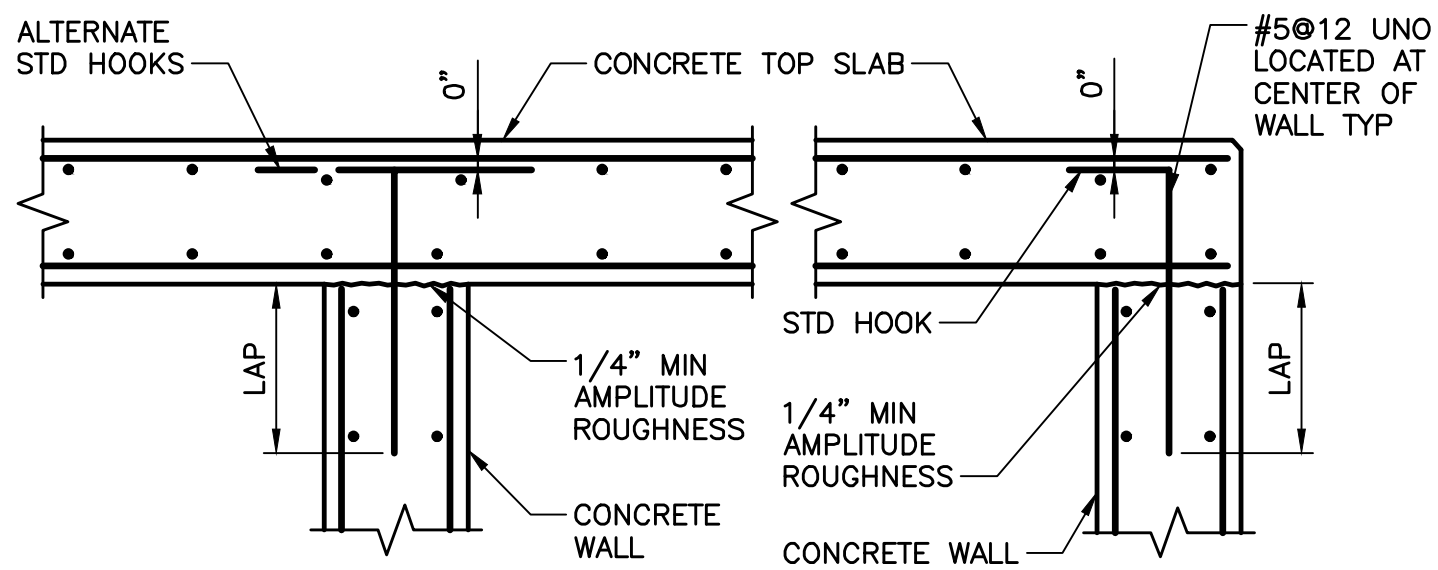


- NOTE:**
- ALL HOOKS SHALL BE STD 90 DEGREE HOOKS.

**HINGED TOP SLAB** 4  
SCALE: NTS

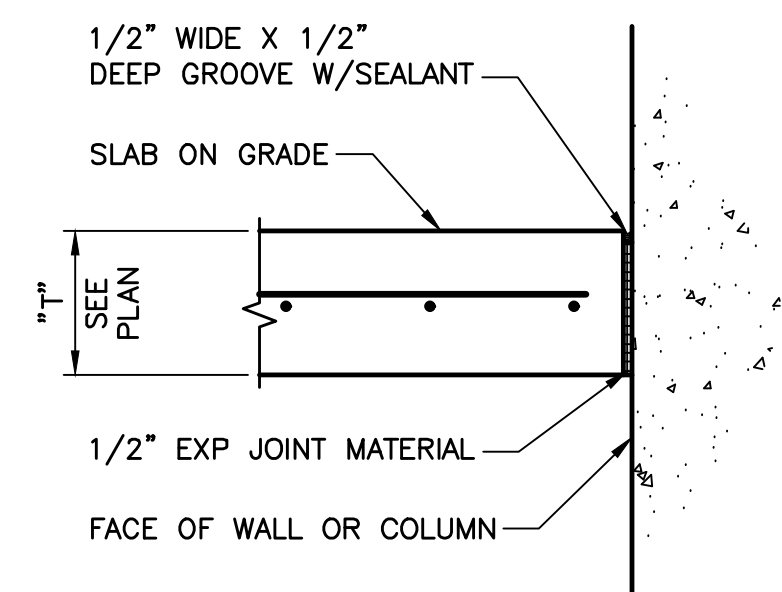


**TYPICAL ISOLATION JOINT (IJ)** 5  
SCALE: NTS

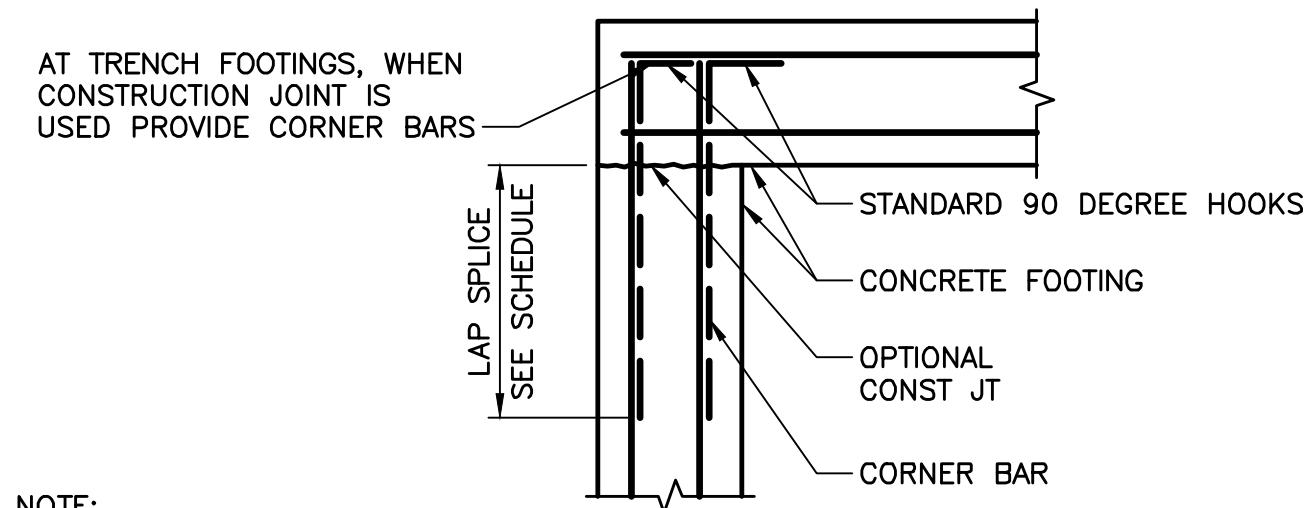


- NOTE:**
- CORNER BARS TO BE SAME SIZE AND SPACING AT FOOTING REINFORCING.


**TYPICAL FOOTING REINFORCING AT CORNER** 7  
SCALE: NTS

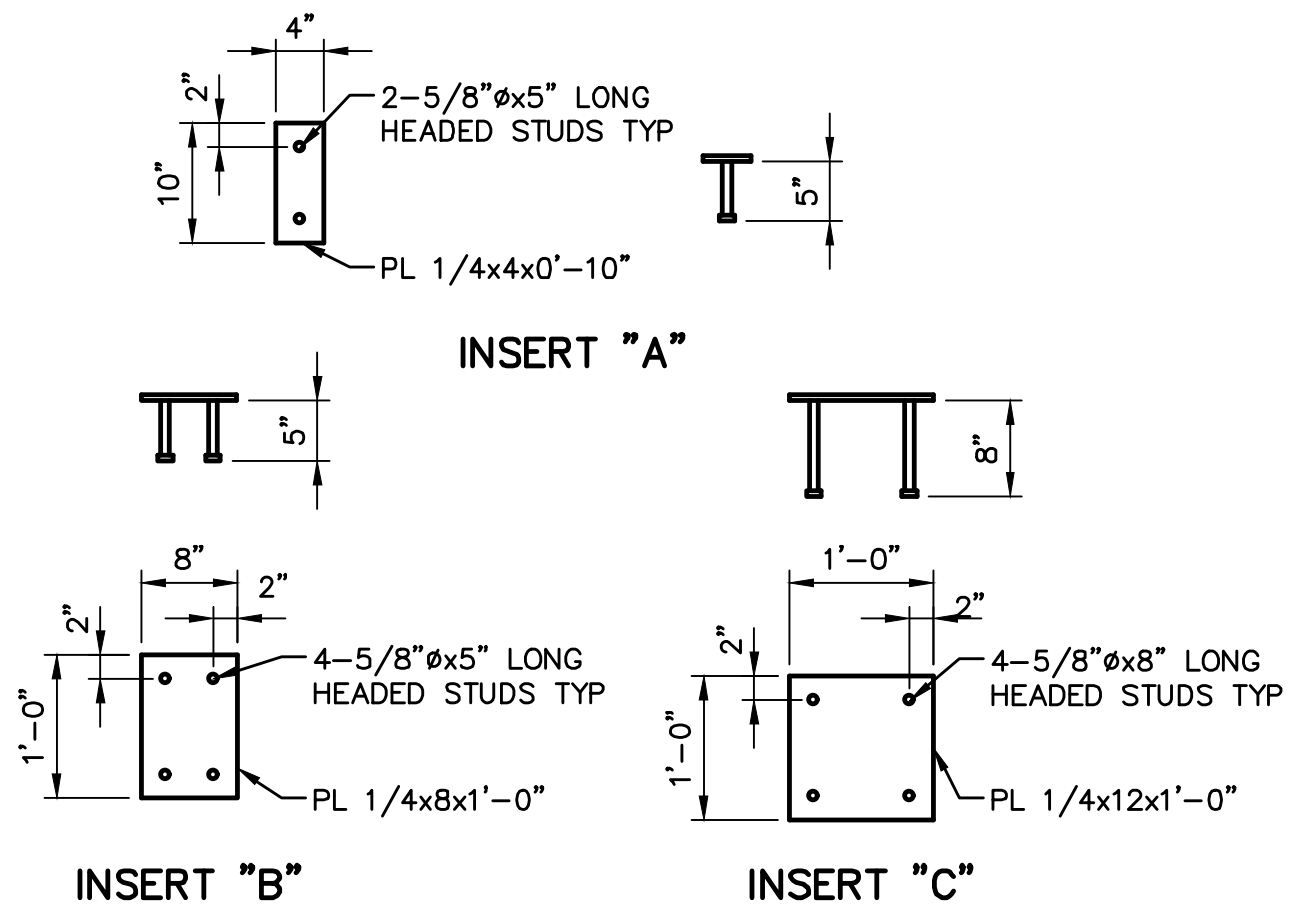

**INSERT "B"** 8  
**INSERT "C"** 8  
**INSERT DETAIL** 8  
SCALE: NTS

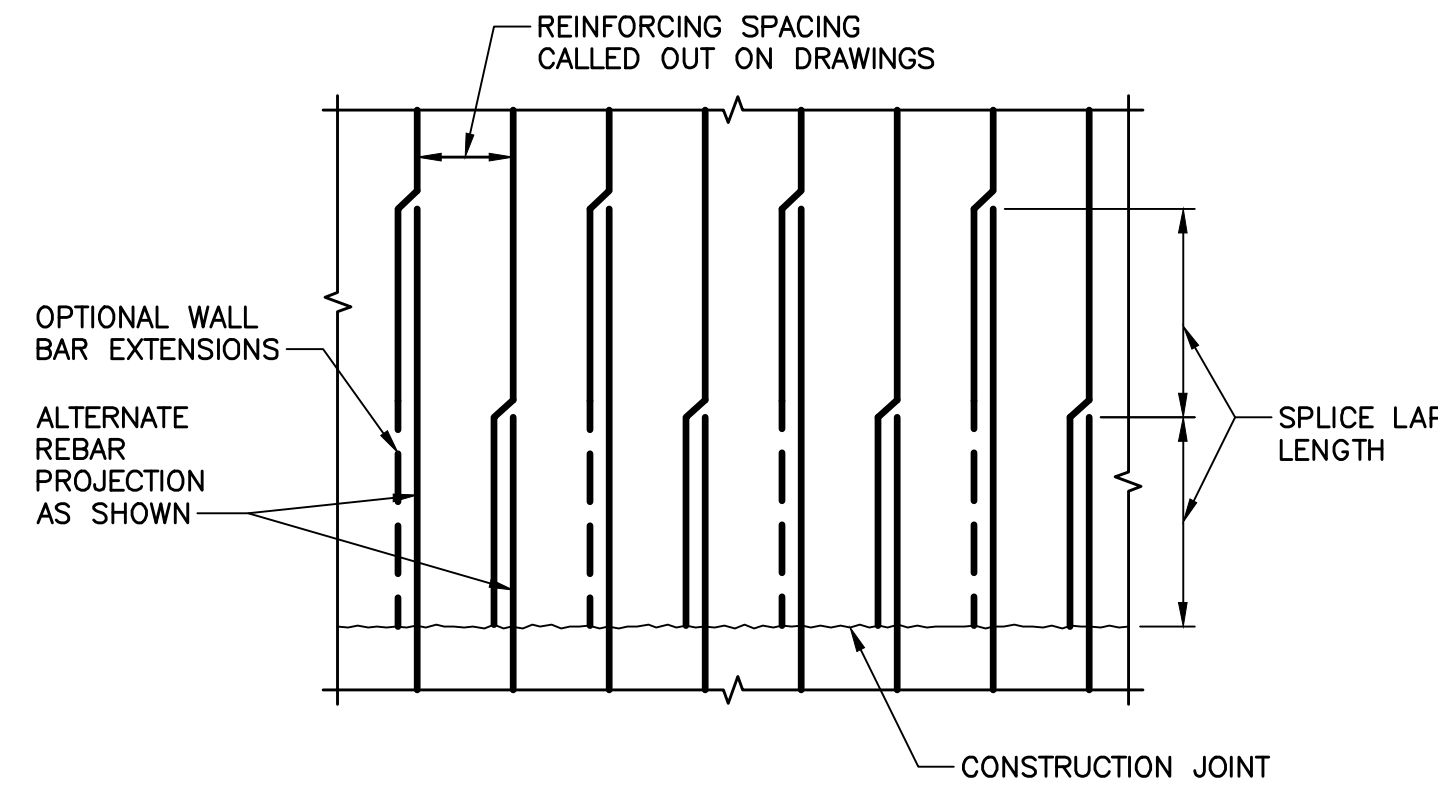


**STAGGERED REINFORCING AT CONSTRUCTION JOINT** 2  
SCALE: NTS

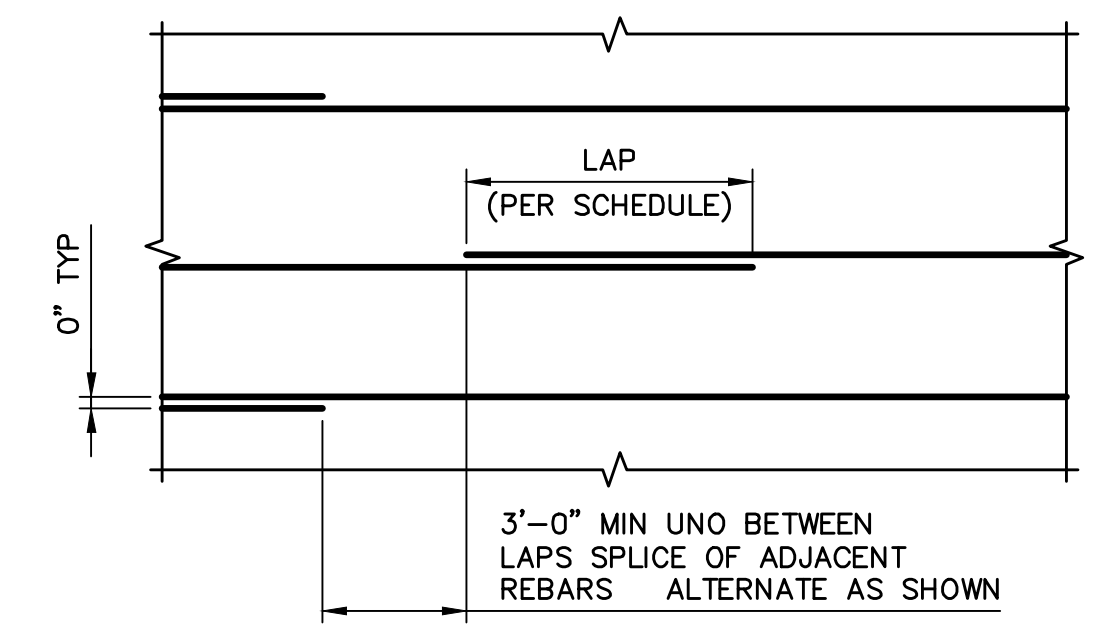


**REINFORCING SPLICE NOT AT CONSTRUCTION JOINT** 3  
SCALE: NTS

- NOTES:**
- PROVIDE ABOVE PAD UNDER ALL ELECTRICAL AND MECHANICAL EQUIPMENT SUPPORTED ON STRUCTURAL SLABS. ALSO PROVIDE FOR EQUIPMENT WEIGHING LESS THAN 5000 POUNDS WHICH ARE SUPPORTED ON GRADE OR WHERE SPECIFICALLY NOTED ON PLANS.
  - PAD THICKNESS SHALL BE THE LARGER OF SLAB THICKNESS PLUS 3 1/2" OR MINIMUM PAD THICKNESS FROM TABLE. PROVIDE AN ADDITIONAL LAYER OF #4@12 EACH WAY WITH 1 1/2" CLEAR TOP AND BOTTOM FOR EACH 8" ADDITIONAL PAD THICKNESS EXCEEDING THE 3 1/2" MINIMUM THICKNESS. ALTERNATIVELY, THICKEN SLAB ON GRADE BELOW EQUIPMENT PAD AS REQD TO MAINTAIN MIN 3" COVER ON ANCHOR BOLTS.
  - BEFORE EQUIPMENT SUPPORT PADS ARE CAST, THE PAD SIZES AND REINFORCING SHALL BE APPROVED BY THE ENGINEER AS BEING CAPABLE OF SUPPORTING EQUIPMENT TO BE PLACED THEREON. EQUIPMENT BASE DIMENSIONS SHALL BE THE LARGER OF AS DETERMINED BY THE EQUIPMENT MANUFACTURER OR AS INDICATED ON THE DRAWINGS. SUBMIT ALL EQUIPMENT DIMENSIONS AND LOADS TO ENGINEER. THE SIZE, NUMBER, TYPE, LOCATION AND THREAD PROJECTION OF THE ANCHOR BOLTS (AB) SHALL BE AS DETERMINED BY THE EQUIPMENT MANUFACTURER AND SHALL BE AS APPROVED BY THE ENGINEER. AB SHALL BE HELD IN POSITION WITH A TEMPLATE WHILE EQUIPMENT PAD IS CAST.
  - FOR CONCRETE EQUIPMENT PADS ON EXISTING CONCRETE, PROVIDE #4@12" O.C. ADHESIVE DOWELS AROUND PERIMETER WITH STANDARD HOOK AS SHOWN.
  - FOR CONCRETE EQUIPMENT PADS ON NEW CONCRETE, PROVIDE #4@12" O.C. DOWELS AROUND PERIMETER WITH STANDARD HOOKS EACH ENDS.
  - CONCRETE SURFACE SHALL BE CLEAN, FREE OF LAITANCE, ROUGHENED TO A 1/4" AMPLITUDE, AND COATED WITH BONDING AGENT.
  - PROVIDE 3" CONCRETE COVER AT SLABS ON GRADE AND 2" AT ELEVATED SLABS.

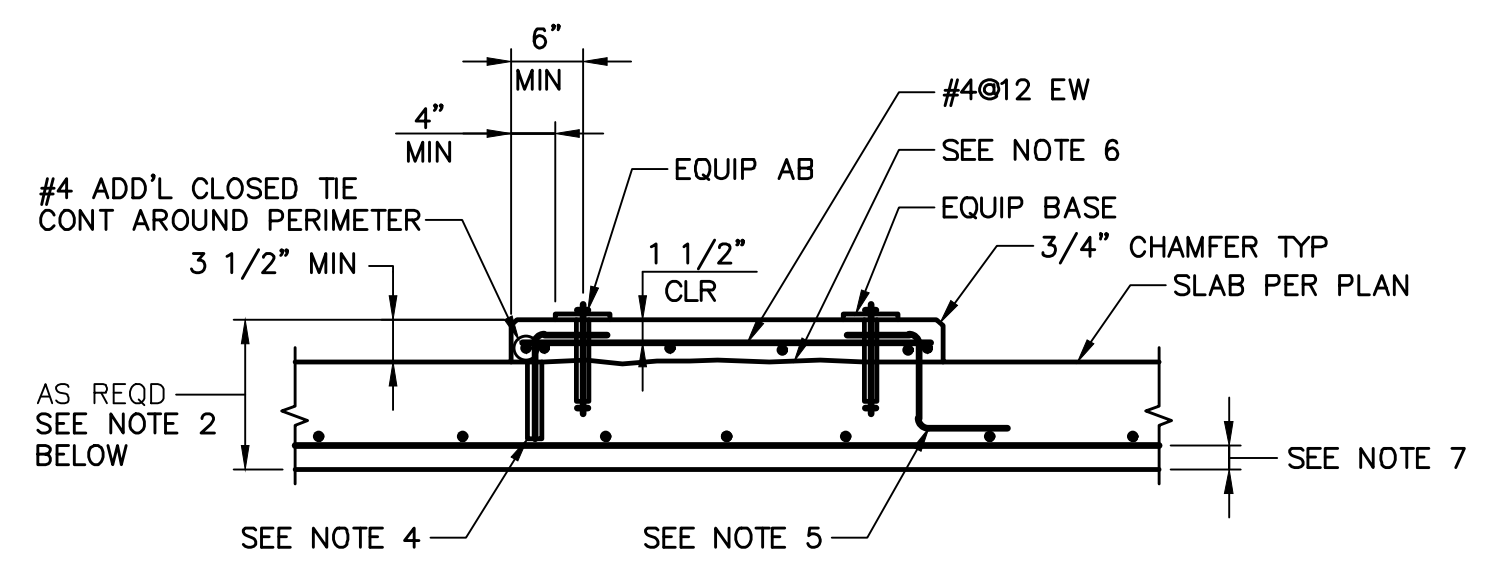


MINIMUM PAD THICKNESS TABLE		
AB DIA	MIN PAD THK	
1/4" DIA	5"	
3/8" DIA	6 1/2"	
1/2" DIA	8"	
5/8" DIA	9 1/2"	
3/4" DIA	11"	
7/8" DIA	12 1/2"	
1" DIA	14"	

**EQUIPMENT SUPPORT PAD** 6  
SCALE: NTS

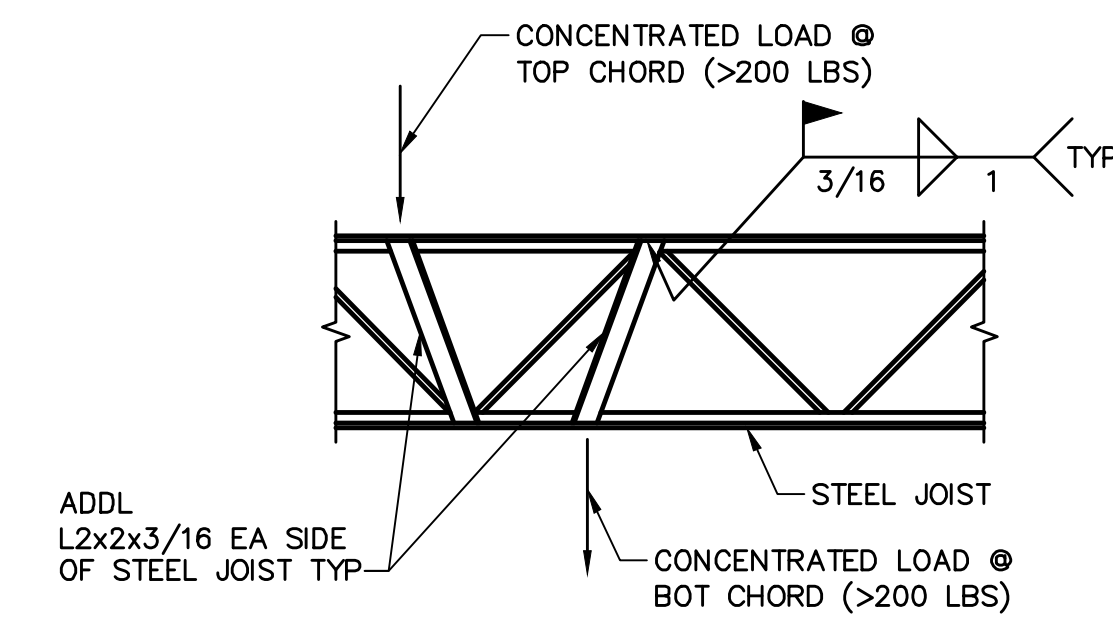

- NOTE:**
- PROVIDE ADDL ANGLE REINFORCEMENT WHEN CONCENTRATED LOAD IS MORE THAN 9" FROM PANEL JOINT.

**JOIST REINFORCEMENT AT CONCENTRATED LOAD** 9  
SCALE: NTS

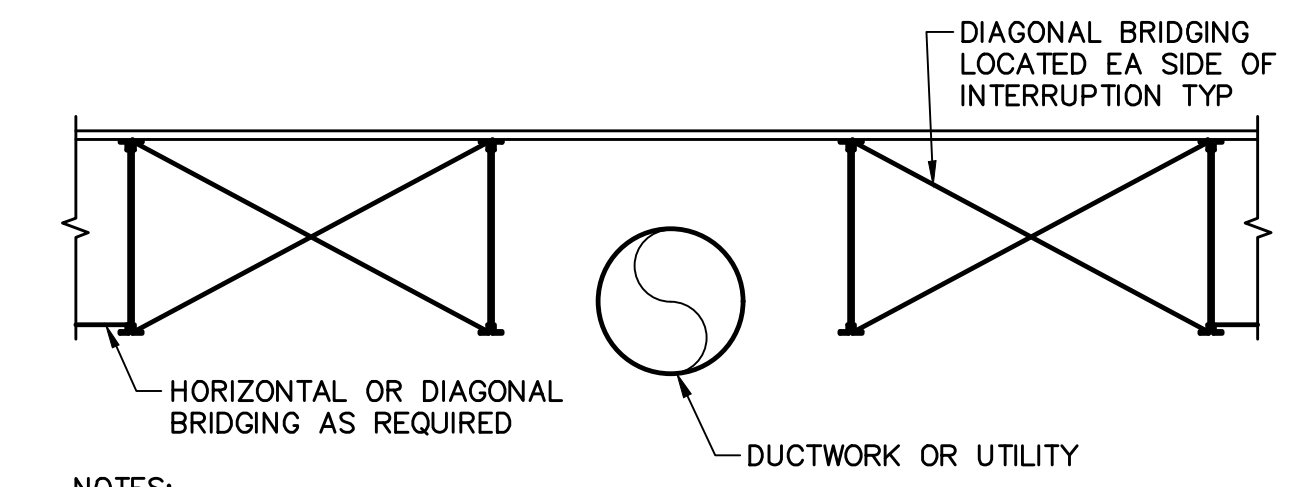

- NOTES:**
- USE ONLY WHERE DUCTWORK OR UTILITY ARE SHOWN BETWEEN JOISTS ON ELECTRICAL, MECHANICAL OR PROCESS SHEETS. VERIFY LOCATION WITH SPECIALITY CONTRACTOR. LOCATION TO BE APPROVED BY ENGINEER.
  - DO NOT INSTALL DUCTWORK OR UTILITIES IN TWO ADJACENT JOIST SPACES.

**INTERRUPTION OF JOIST BRIDGING** 10  
SCALE: NTS


FACILITY DRAWINGS  
This drawing was supplied by a Consultant Engineer from a past contract and is being provided to the Contractor to provide the Record Drawing. The City does not warrant this drawing to be a complete and accurate portrayal of facilities as they exist in the field.

REVISION	ENGINEERING COMPANY	PROJECT NO.	PROJECT NAME	DATE	DWG NUMBER	REMARKS



REVISIONS				
NO.	BY	DATE	CKD	REMARKS
A	RW	01/2024	TH	90% SUBMITTAL
B	RW	04/2024	TH	AGENCY REVIEW
C	RW	08/2024	TH	ISSUED FOR CONSTRUCTION

DES	RW
DWN	RW
CKD	TH

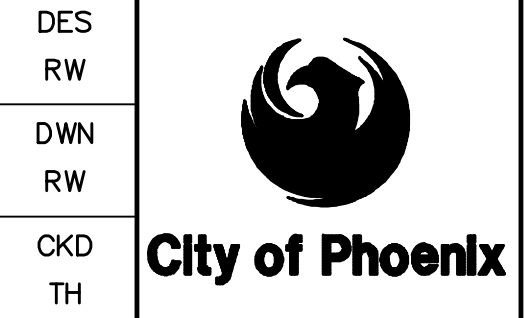

CITY OF PHOENIX  
WATER SERVICES DEPARTMENT  
  
LIFT STATION 40  
REFURBISHMENT

STRUCTURAL  
  
STANDARD STRUCTURAL DETAILS 2

COPYRIGHT © 2007-JANUARY  
CITY PROJECT NO. WS90400085  
DATE: 08/2024  
S-04 SHEET 60 OF 134  
CAD FILE: CSSL40D02.dwg

THIS DRAWING MUST BE FIELD VERIFIED BEFORE USE. DRAWING NOT TO SCALE UNLESS SCALE BAR IS PRESENT.

FOR CONSTRUCTION


\*PER CITY OF PHOENIX CODE CHAPTER 2-28, THESE PLANS ARE FOR OFFICIAL USE ONLY AND MAY NOT BE SHARED WITH OTHERS EXCEPT AS REQUIRED TO FULFILL THE OBLIGATIONS OF THE CONTRACTOR'S CONTRACT WITH THE CITY OF PHOENIX. THIS DOCUMENT MUST BE KEPT SECURE AT ALL TIMES.

MASONRY LAP SPLICE LENGTHS f <sub>m</sub> =1500 psi, f <sub>y</sub> =60000 psi		
BAR SIZE	8" BLOCK	
	BAR @ CL	BAR @ EDGE
#3	19"	19"
#4	25"	31"
#5	31"	48"
#6	57"	-

NOTE:  
1. WHEN REQD SPLICE LENGTH EXCEEDS 4'-0" USE HIGH LIFT GROUTING WITH NO SPLICES OR USE MECHANICAL TENSION SPLICES WITH LOW LIFT GROUTING.


**CMU REINFORCING LAP SCHEDULE**

SCALE: NTS

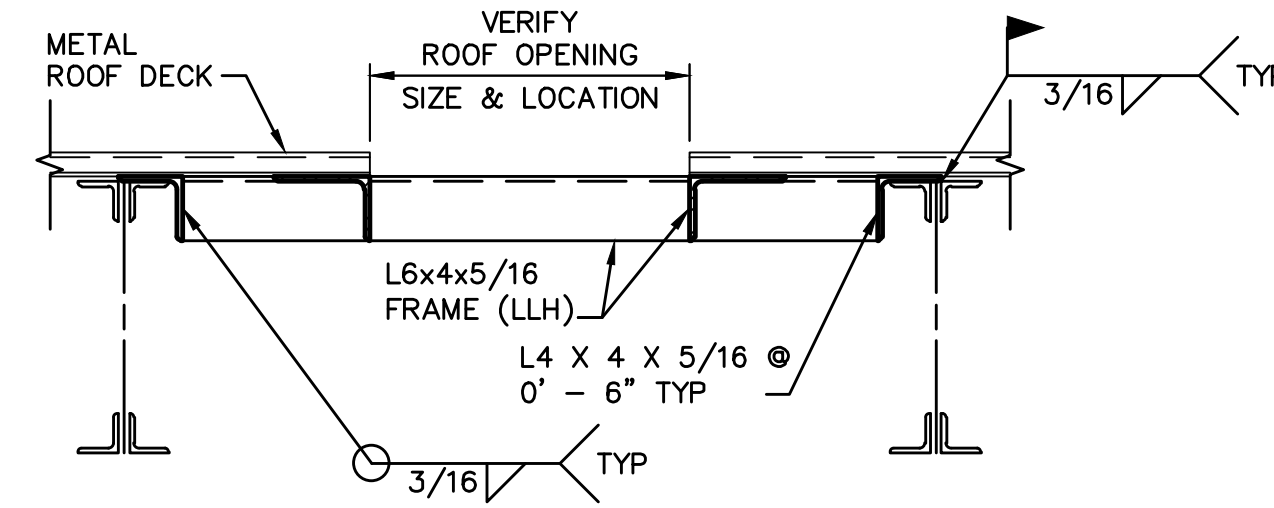

**ROOF DECK OPENING**

SCALE: NTS

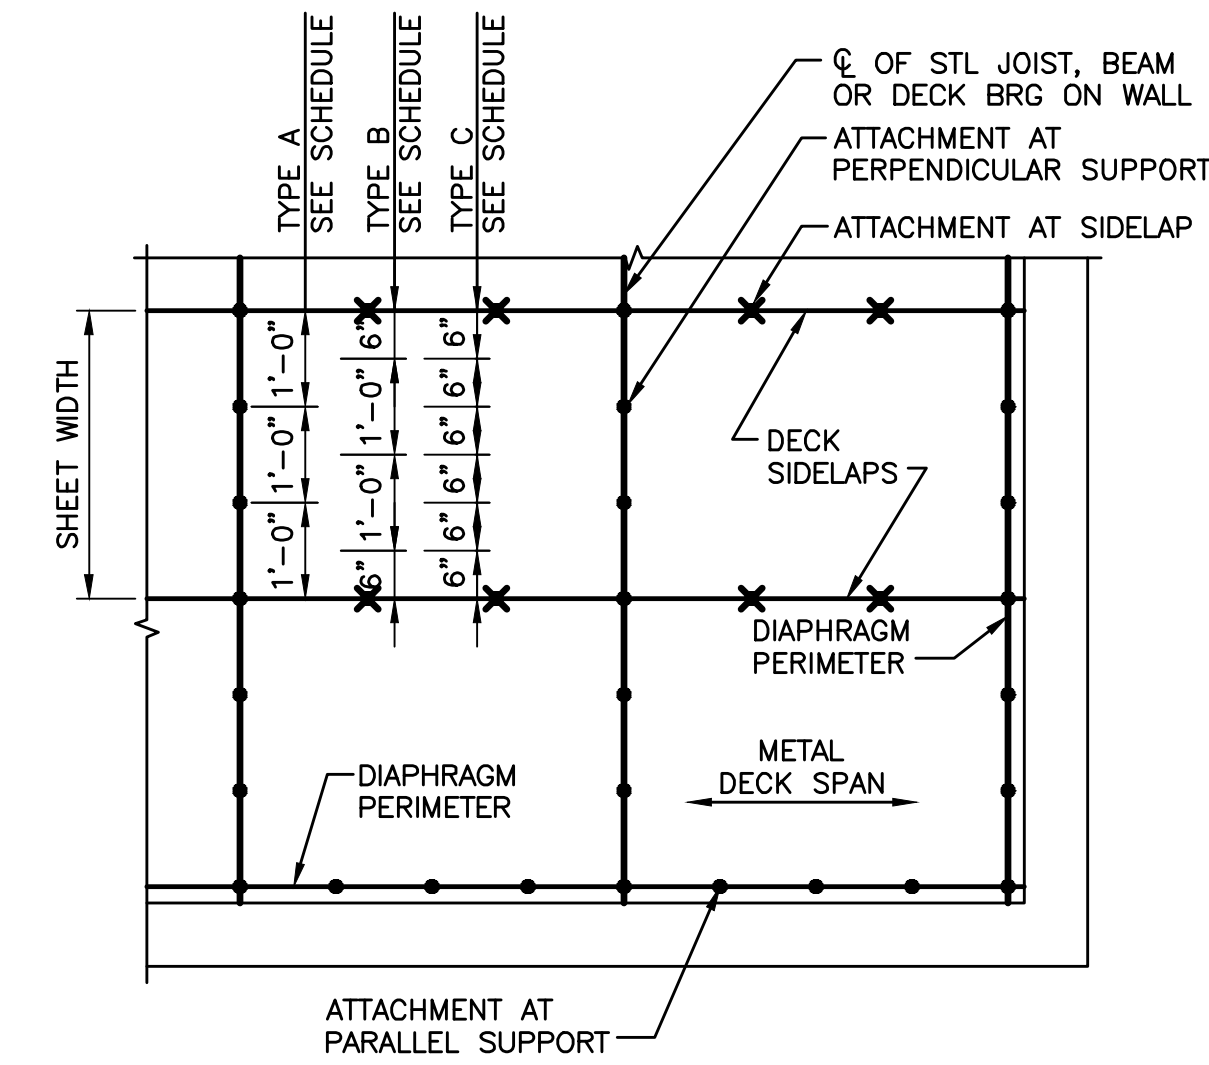


**ROOF DECK ATTACHMENT**

SCALE: NTS

METAL DECK ATTACHMENT SCHEDULE				
TYPE	ATTACHMENT AT SUPPORTS PERPENDICULAR TO FLUTES	ATTACHMENT AT SUPPORTS PARALLEL TO FLUTES	ATTACHMENT AT SIDELAPS	REMARKS
A	36/4: 4-FASTENERS PER 36" WIDE SHEET	FASTENERS @12"OC	PER SPECIFICATIONS	
B	36/5: 5-FASTENERS PER 36" WIDE SHEET	FASTENERS @12"OC	PER SPECIFICATIONS	
C	36/7: 7-FASTENERS PER 36" WIDE SHEET	FASTENERS @12"OC	PER SPECIFICATIONS	USE UNLESS NOTED ON PLANS


NOTES:  
1. DIAPHRAGM PERIMETER SHALL BE ATTACHED WITH MOST STRINGENT AT POINTS PARALLEL OR POINTS PERPENDICULAR AS APPLICABLE PER SCHEDULE.  
2. FASTENERS SHALL BE POWDER ACTUATED WITH SPACING AS INDICATED IN SCHEDULE.  
3. AT CONTRACTOR'S OPTION, INTERLOCKING PUNCHED SIDE LAP CONNECTIONS (SIMILAR TO VULCRAFT PUNCHLOK II SYSTEM) MAY BE SUBSTITUTED FOR ARC SEAM WELDS. SUBMIT PROPOSED SIDELAP ATTACHMENTS FOR REVIEW.  
4. WHERE DECK IS SUPPORTED ON STEEL JOISTS, WELDS SHALL BE STAGGERED TO ALTERNATE TOP CHORD JOIST ANGLES.  
5. SEE SPECIFICATION SECTION 05 30 00.15 FOR ADDITIONAL INFORMATION.

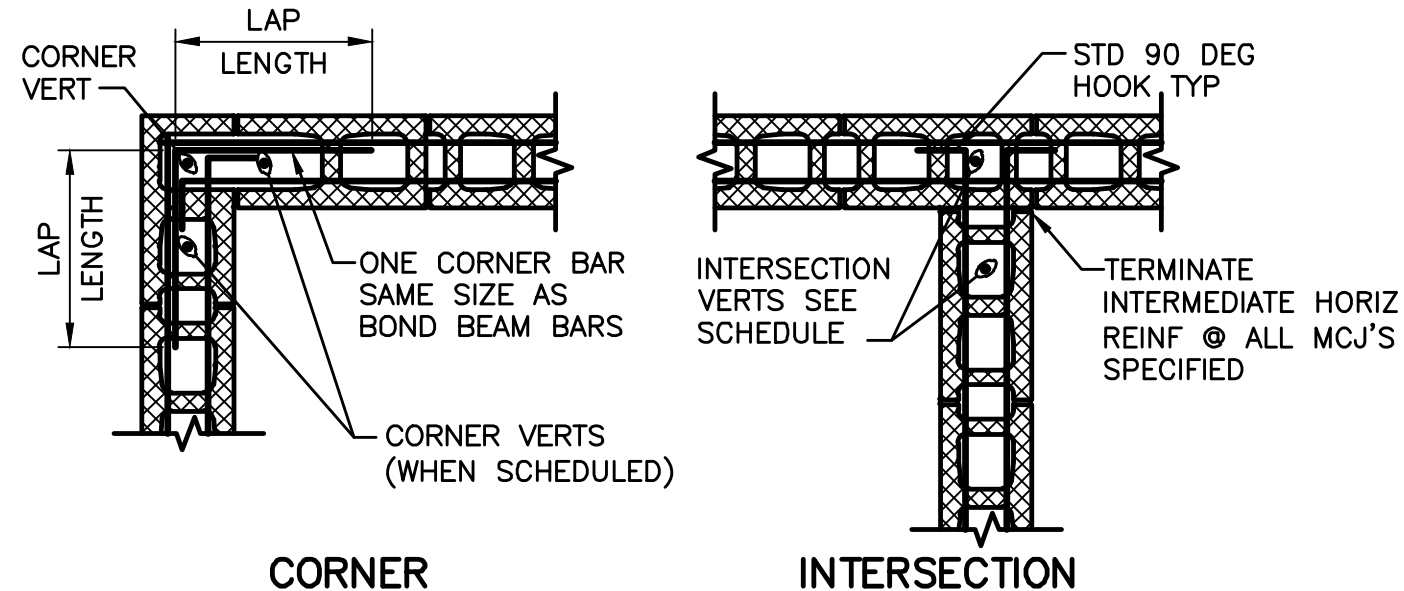

**CORNER**


**INTERSECTION**

LINTEL REINFORCEMENT SCHEDULE					
MARK	"W"	"R"	"L"	"H"	STIRRUPS
ML-1	1'-4" THRU 3'-4"	(1) #5	25"	8"	-
ML-2	1'-4" THRU 3'-4"	(2) #5	25"	16"	-
ML-3	3'-5" THRU 6'-8"	(2) #5	25"	24"	-
ML-4	6'-9" THRU 10'-0"	(2) #6	30"	32"	-
ML-5	10'-1" THRU 12'-0"	(2) #7	35"	32"	#3@16"

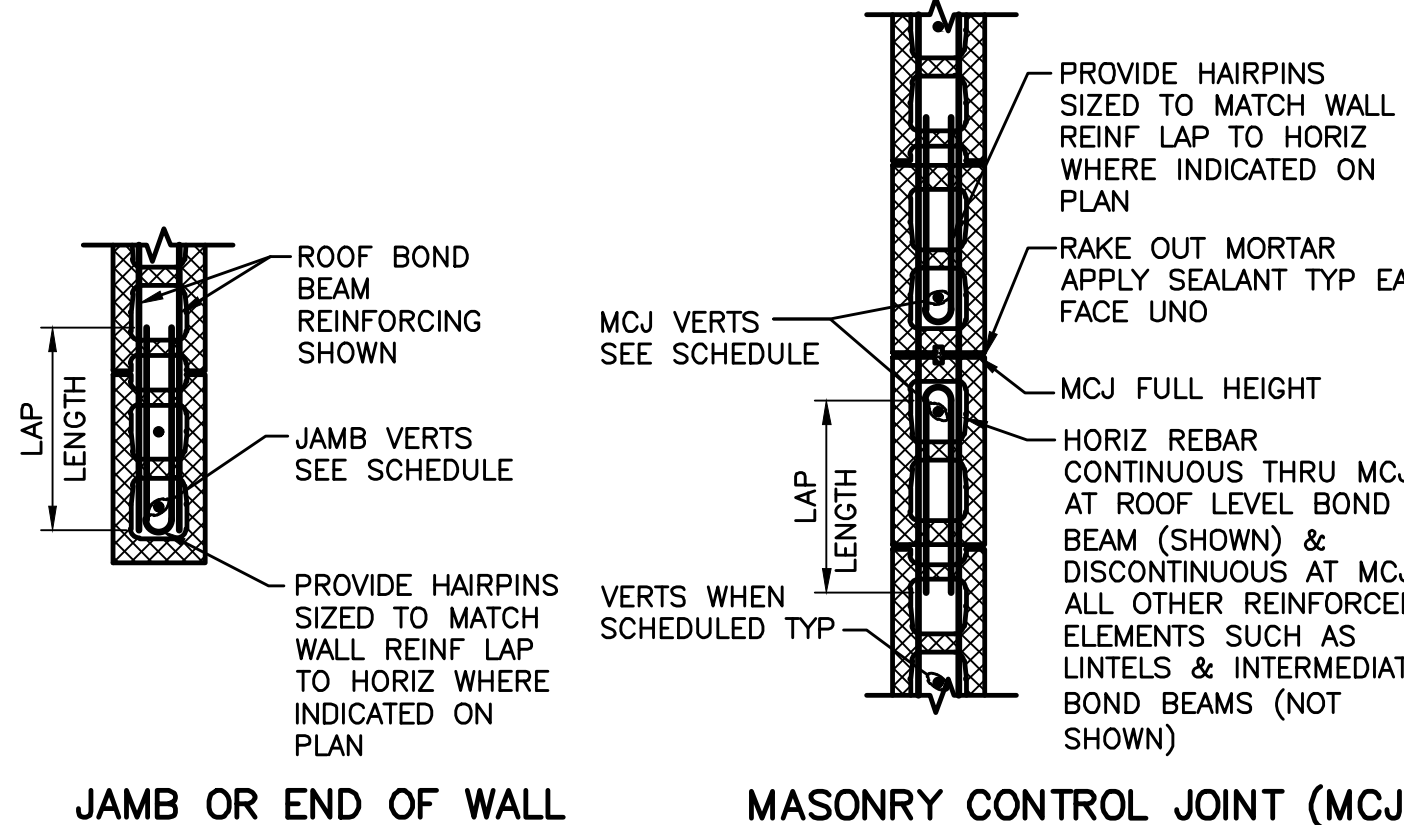


**JAMB OR END OF WALL**

**MASONRY CONTROL JOINT (MCJ)**

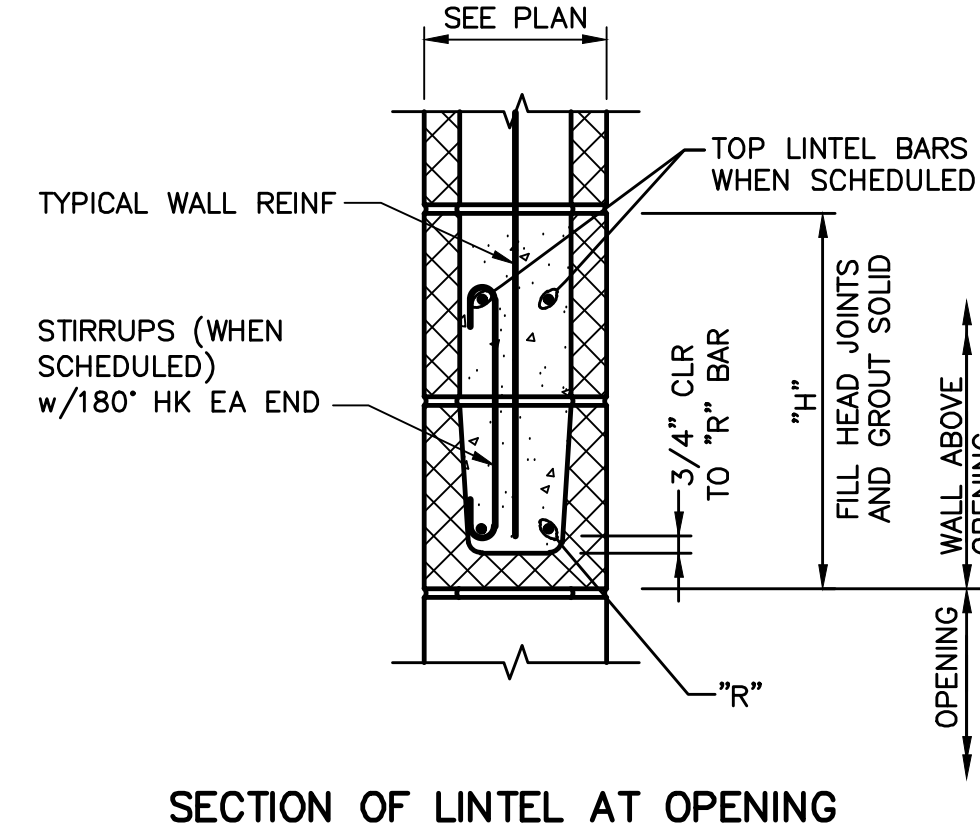

**SECTION OF LINTEL AT OPENING**

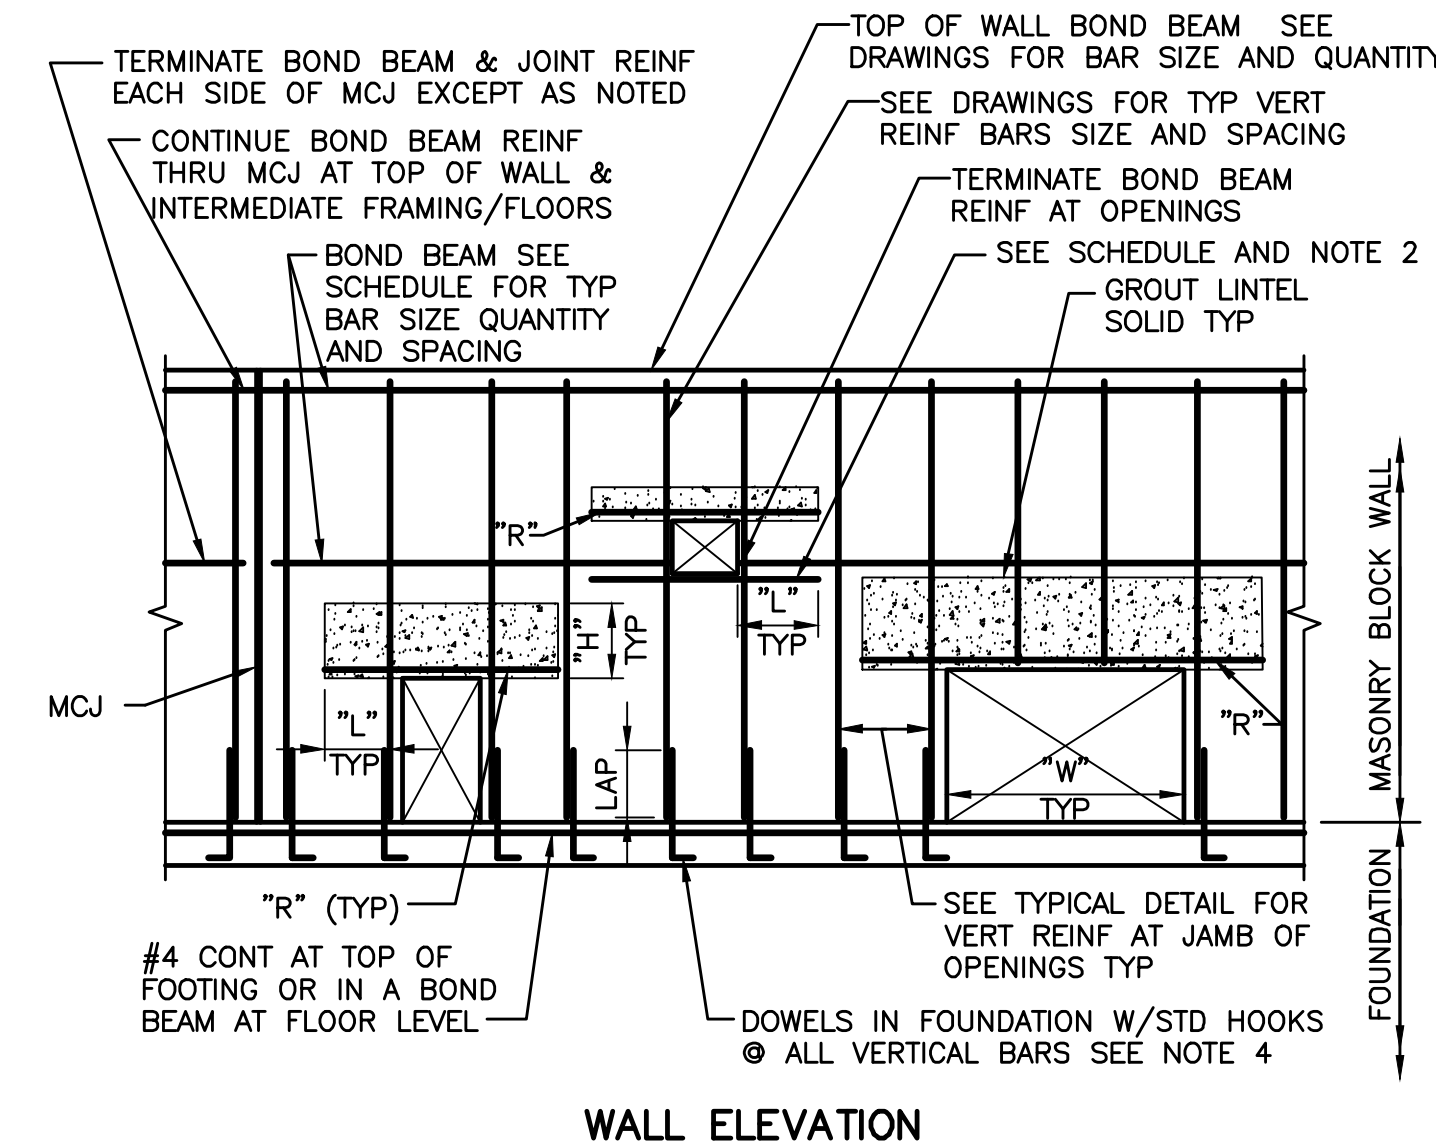

**WALL ELEVATION**

NOTES:  
1. FOR REINFORCING SEE "CMU REINFORCING SCHEDULE".  
2. EXTEND MCJ FULL HEIGHT OF MASONRY WALL EXCEPT AT TOP OF WALL BOND BEAM.  
3. LIMIT DISTANCE BETWEEN MCJ TO MAX 24'-0". SEE DRAWINGS FOR LOCATIONS.  
4. MODIFY BAR CONFIGURATION SHOWN AS REQUIRED WHERE TWO VERTICAL REINFORCING BARS ARE SHOWN ON THE SCHEDULE.  
5. SEE ARCHITECTURAL DRAWINGS FOR MCJ DETAILS AND REMAINDER OF JOINT DETAILS.


NOTES:  
1. OPENINGS 8" OR LESS WIDE MAY OCCUR WITHOUT LINTEL REINFORCING AS LONG AS NO REINFORCING IS INTERRUPTED.  
2. ML-1 TO BE USED ONLY AT NON-LOAD BEARING SITUATIONS.  
3. SEE DRAWINGS FOR LINTEL TYPES. WHERE LINTEL TYPES ARE NOT SHOWN, PROVIDE LINTELS FROM THE ABOVE SCHEDULE BASED ON THICKNESS OF WALL AND MAX CLEAR OPENING WIDTH.

NOTES:  
1. HATCHING SHOWN ONLY DEFINE EXTENTS OF LINTEL REINFORCING. GROUT SOLID ALL REINFORCED CELLS. SEE CMU WALL REINFORCING SCHEDULE.  
2. WHERE OTHER DRAWING DETAILS INDICATE SOLID MASONRY SILL, PLACE BOND BEAM REINF IN FIRST COURSE BELOW SOLID CMU.  
3. PROVIDE BOND BEAM AT ALL ELEVATED FLOORS WITH SAME REINFORCING AS TOP OF WALL, UNO.  
4. STRAIGHT BARS EMBEDDED ONE CONCRETE LAP LENGTH INTO CONCRETE FOUNDATION MAY BE USED AT CONTRACTOR'S OPTION.  
5. LINTEL REINFORCING AND BARS PASSING THROUGH "H" SHALL NOT BE SPLICED.  
6. SHORE LINTEL MINIMUM 7 DAYS AFTER GROUTING OR UNTIL GROUT ATTAINS FULL DESIGN STRENGTH.

**CMU WALL REINFORCING**

SCALE: NTS

TYPE	REINFORCING LOCATION	8" WALL THK
VERTS	VERTICAL BARS	#5@32" OC SINGLE CENTERED
	JAMBS/ENDS/MCJ	#5, SEE [4]
	CORNERS/INTERSECTIONS	#5, SEE [4]
HORIZ	TOP OF WALL BOND BEAM	2-#5, SEE [4]
	INTERMEDIATE BOND BEAMS	2-#5
	HORIZ JOINT REINF	9 GAGE WIRE, TRUSS TYPE JOINT REINF @16" OC BETWEEN BOND BEAMS
	BELOW OPENINGS	2-#5
	LINTELS	SEE CMU REINFORCEMENT ELEVATION [4]

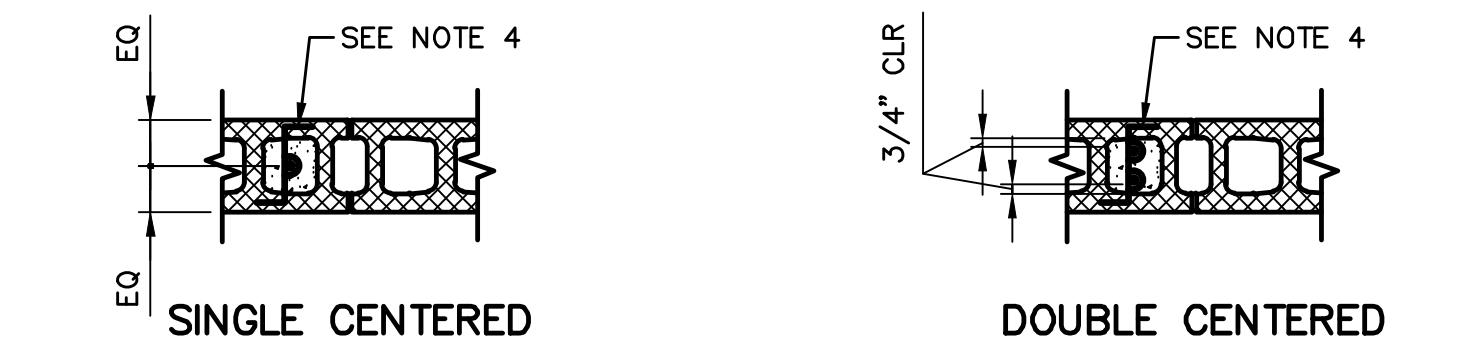

NOTES:  
1. PROVIDE THE ABOVE SCHEDULED MINIMUM WALL REINFORCING IN ALL CMU, UNO. SEE CMU WALL REINFORCEMENT DETAIL.  
2. GROUT ONLY CELLS WITH REINFORCING.  
3. MAINTAIN MINIMUM 3"x3" CONTINUOUS VERTICAL CELL AT EACH REBAR. PLACE WALLS TO MAXIMUM 4'-0" HEIGHT BEFORE GROUTING.  
4. PROVIDE WIRE REBAR POSITIONERS TO HOLD BARS IN PLACE.  
5. STOP GROUT POUR 1/2" BELOW TOP OF COURSE AT EACH GROUT LIFT.

**CMU REINFORCING SCHEDULE**

SCALE: NTS

REVISIONS					
NO.	BY	DATE	CKD	REMARKS	
A	RW	01/2024	TH	90% SUBMITTAL	
B	RW	04/2024	TH	AGENCY REVIEW	
C	RW	08/2024	TH	ISSUED FOR CONSTRUCTION	

DES RW  
DWN  
RW  
CKD  
TH

**City of Phoenix**

CITY OF PHOENIX  
WATER SERVICES DEPARTMENT

LIFT STATION 40  
REFURBISHMENT

STRUCTURAL

STANDARD STRUCTURAL DETAILS 3

COPYRIGHT © 2007-JANUARY

CITY PROJECT NO. WS90400085

DATE: 08/2024

S-05 SHEET 61 OF 134

CAD FILE: CSSL540D03.dwg

FACILITY DRAWINGS This drawing was supplied by a Consultant Engineer from a past contract. The City does not warrant this drawing to be a complete and accurate portrayal of facilities as they exist in the field.

FOR CITY OF PHOENIX USE ONLY - REFERENCE CID NUMBER: # PROJECT NO. PROJECT NAME DATE

REVISION ENGINEERING COMPANY PROJECT NO. PROJECT NAME DATE


REMARKS

DWG NUMBER

CAD FILE NAME

DATE




TIME: 04:40pm

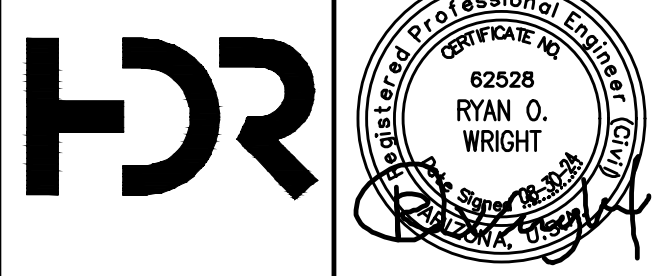

THIS DRAWING MUST BE FIELD VERIFIED BEFORE USE  
DRAWING NOT TO SCALE UNLESS SCALE BAR IS PRESENT

**FOR CONSTRUCTION**

"PER CITY OF PHOENIX CODE CHAPTER 2, SECTION 2-28, THESE PLANS ARE FOR OFFICIAL USE ONLY AND MAY NOT BE SHARED WITH OTHERS EXCEPT AS REQUIRED TO FULFILL THE OBLIGATIONS OF THE CONTRACTOR'S CONTRACT WITH THE CITY OF PHOENIX."  
THIS DOCUMENT MUST BE KEPT SECURE AT ALL TIMES.

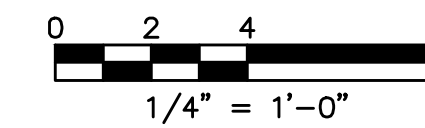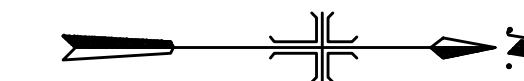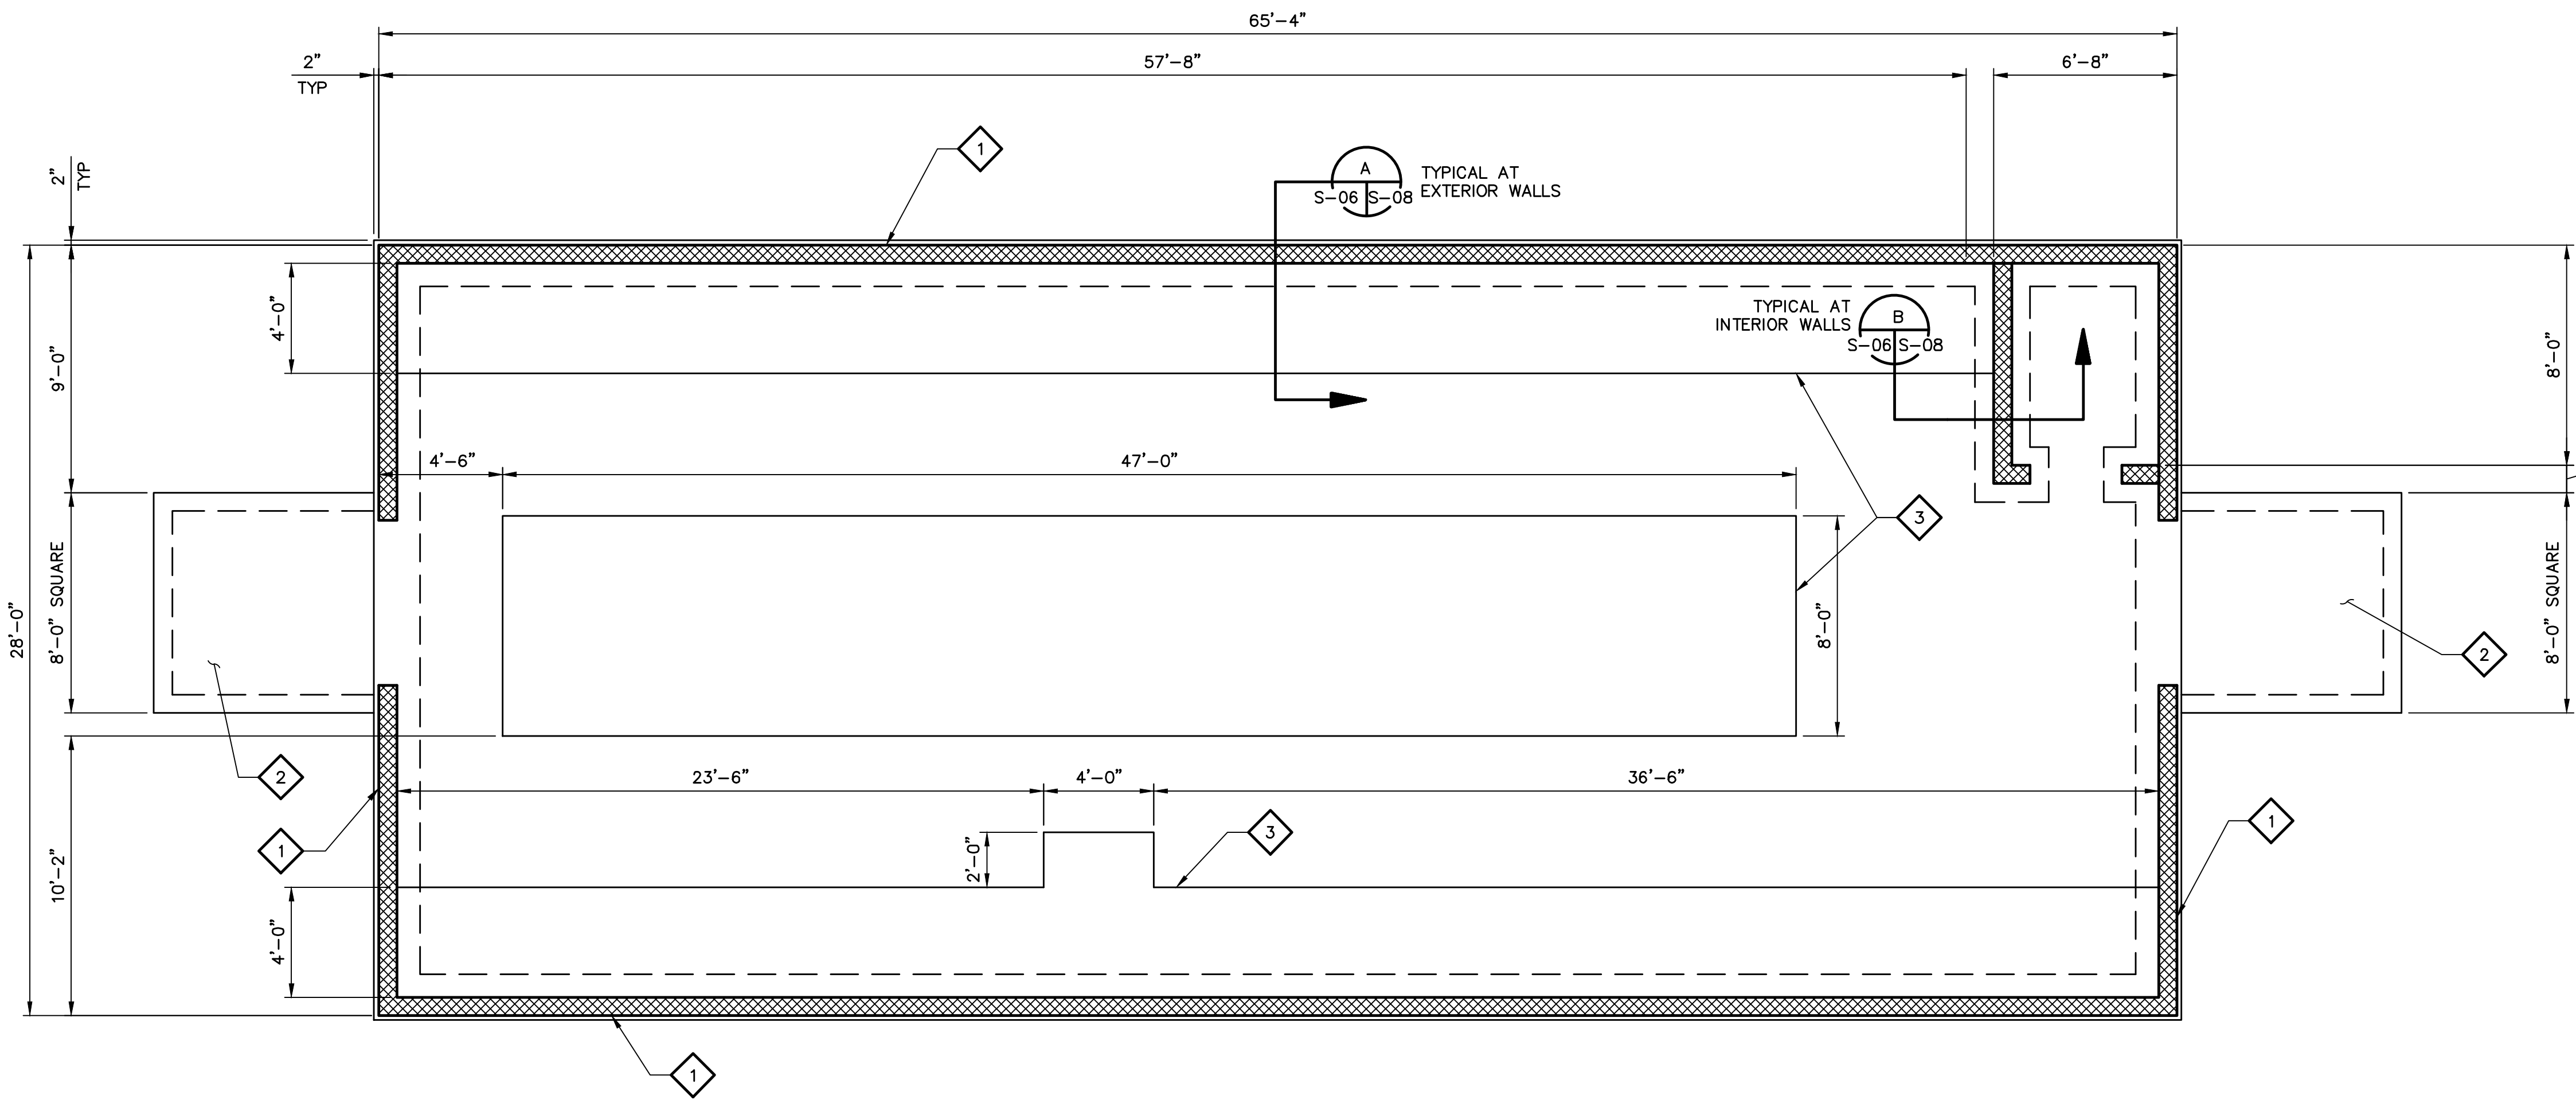

**GENERAL NOTES**


- STRUCTURAL DESIGN CRITERIA SHALL BE IN ACCORDANCE WITH THE REQUIREMENTS SHOWN ON SHEETS S-01.
- SEE ARCHITECTURAL DRAWINGS FOR ADDITIONAL INFORMATION.
- COORDINATE LOCATION AND SIZE OF EQUIPMENT PADS PRIOR TO CONCRETE PLACEMENT.
- SEE CIVIL DRAWINGS FOR STRUCTURE LOCATION AND COORDINATE POINTS.
- FOR SLAB REINFORCEMENT, SEE WALL SECTIONS.
- SEE ARCHITECTURAL DRAWINGS FOR LOCATION OF MASONRY CONTROL JOINTS (MCJ).

FACILITY DRAWINGS  
This drawing was supplied by a Consultant Engineer from a past contract and is being provided for information only. The City does not warrant this drawing to be a complete and accurate portrayal of facilities as they exist in the field.

**KEY NOTES**


- 1 8" STRUCTURAL MASONRY WALL WITH EIFS. SEE 4 S-06 S-05  
SEE ARCHITECTURAL DRAWINGS FOR ADDITIONAL INFORMATION ON FINISHES, ROUGH OPENING DIMENSIONS, ETC.
- 2 CONCRETE STOOP, TYPICAL. SEE 4 S-06 S-03
- 3 CONCRETE EQUIPMENT SUPPORT PAD, TYPICAL. SEE 6 S-06 S-04

NO.	DATE	BY	REVISION	REMARKS

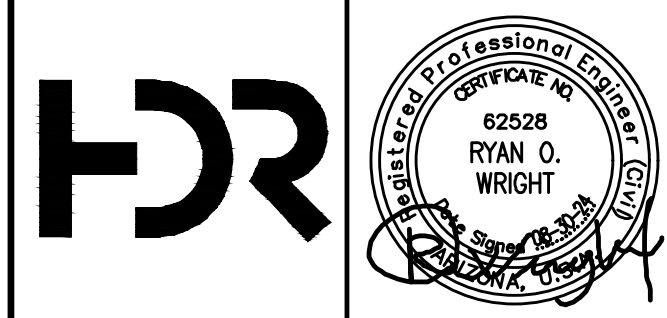

NO.	BY	DATE	CKD	REVISIONS	REMARKS
A	RW	01/2024	TH	90% SUBMITTAL	
B	RW	04/2024	TH	AGENCY REVIEW	
C	RW	08/2024	TH	ISSUED FOR CONSTRUCTION	

DES	
RW	
DWN	
RW	
CKD	
TH	

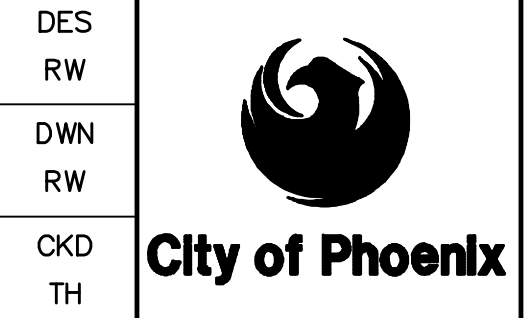

CITY OF PHOENIX  
WATER SERVICES DEPARTMENT  
  
LIFT STATION 40  
REFURBISHMENT

STRUCTURAL  
  
ELECTRICAL AND CONTROL BUILDING  
FOUNDATION PLAN



COPYRIGHT © 2007-JANUARY  
CITY PROJECT NO. WS90400085  
DATE: 08/2024  
S-06 SHEET 62 OF 134  
CAD FILE: CSSL40P01.dwg

USER: RWRIGHT FILE: C:\Users\wright\MyAppData\Local\Temp\Temp\Publishing\_16400\CSSL40P01.dwg DATE: 8/28/24 TIME: 04:44pm

THIS DRAWING MUST BE FIELD VERIFIED BEFORE USE  
DRAWING NOT TO SCALE UNLESS SCALE BAR IS PRESENT

**FOR CONSTRUCTION**

"PER CITY OF PHOENIX CODE CHAPTER 2, SECTION 2-28, THESE PLANS ARE FOR OFFICIAL USE ONLY AND MAY NOT BE SHARED WITH OTHERS EXCEPT AS REQUIRED TO FULFILL THE OBLIGATIONS OF THE CONTRACTOR'S CONTRACT WITH THE CITY OF PHOENIX."  
THIS DOCUMENT MUST BE KEPT SECURE AT ALL TIMES.

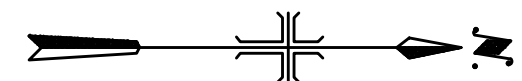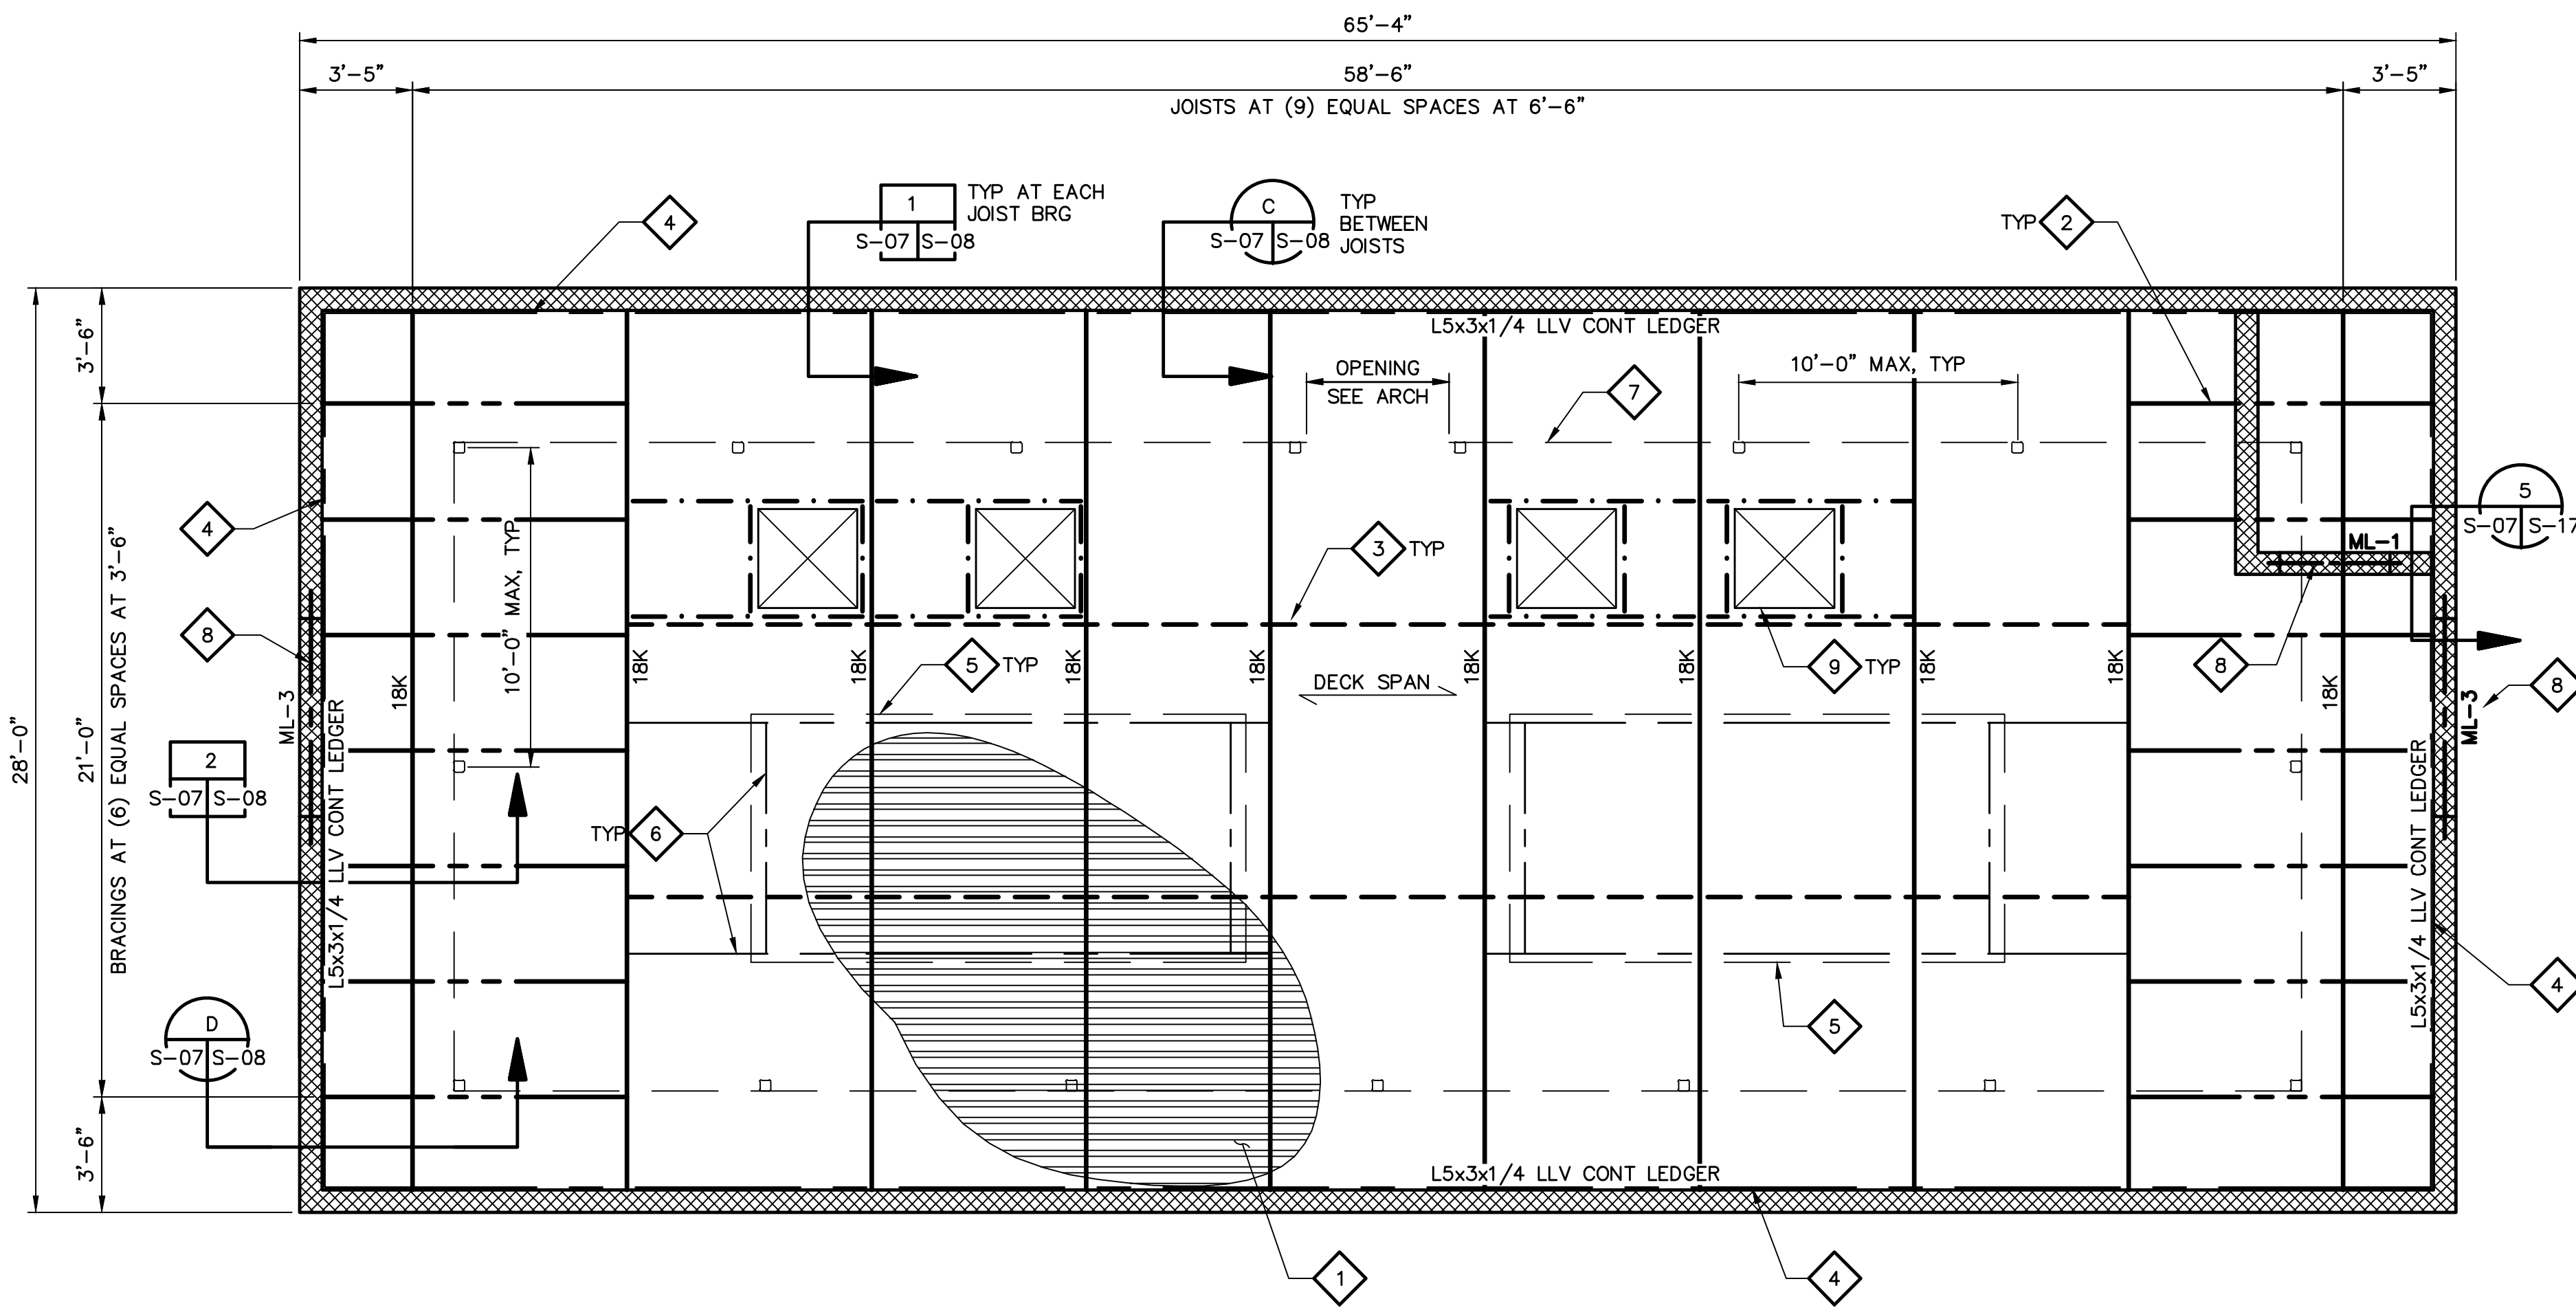


**GENERAL NOTES**

- STRUCTURAL DESIGN CRITERIA SHALL BE IN ACCORDANCE WITH THE REQUIREMENTS SHOWN ON SHEETS S-01.
- SEE ARCHITECTURAL DRAWINGS FOR DIMENSIONS AND ELEVATIONS NOT SHOWN.
- COORDINATE LOCATION OF ALL OPENINGS AND SIZES WITH MEP DRAWINGS PRIOR TO CONSTRUCTION.
- DESIGN STEEL JOISTS FOR THE DESIGN CRITERIA DEFINED ON SHEET S-01 AND LOAD DIAGRAM ON SHEET S-08. ALL LOADS SHALL BE COMBINED PER THE REQUIREMENTS OF THE 2018 IBC AND ASCE 7-16. SEE SPECIFICATION SECTION 05 21 00 FOR ADDITIONAL INFORMATION.
- PROVIDE HORIZONTAL BRIDGING OF STEEL JOISTS PER THE SPECIFICATIONS. BRIDGING TO BE DESIGNED BY THE JOIST MANUFACTURER.
- REFER TO STANDARD DETAILS FOR LINTEL REINFORCEMENT.

FACILITY DRAWINGS  
This drawing was supplied by a Consultant Engineer from a past contractor and is not intended to be used as a basis for construction. The City does not warrant this drawing to be a complete and accurate portrayal of facilities as they exist in the field.

**KEY NOTES**

- 1 1/2" GALVANIZED METAL DECK PER SPECIFICATION SECTION 05 30 00.15. SEE STANDARD DETAILS FOR REQUIRED ATTACHMENT.
- 2.5K3 BRACING, TYPICAL. SEE GENERAL NOTE 3 FOR ADDITIONAL INFORMATION.
- JOIST BRIDGING, TYPICAL. SEE GENERAL NOTE 5 FOR ADDITIONAL INFORMATION. ADJUST LOCATION OF BRIDGING, AS REQUIRED TO AVOID OPENINGS FOR MEP EQUIPMENT PER GENERAL SHEET NOTE 3.
- CONTINUOUS LEDGER ANGLE, TYPICAL. MITER AND FULLY WELD LEDGER ANGLE AT CORNERS, TYPICAL.
- ROOF MOUNTED MECHANICAL UNIT. MAXIMUM WEIGHT NOT TO EXCEED 5000 LBS. SEE MECHANICAL DRAWINGS FOR ADDITIONAL INFORMATION.
- ADDITIONAL FRAMING AT ROOF MOUNTED MECHANICAL UNIT. SEE **7** S-07 S-17
- SCREEN AROUND ROOF MOUNTED MECHANICAL UNIT. SEE ARCHITECTURAL DRAWINGS FOR ADDITIONAL INFORMATION. FOR ADDITIONAL STRUCTURAL FRAMING, SEE **6** S-07 S-17
- MASONRY LINTEL, TYPICAL. SEE **4** S-07 S-05
- PENETRATION IN ROOF DECKING FOR HVAC EQUIPMENT. SEE HVAC DRAWINGS. PROVIDE ADDITIONAL FRAMING OPENING PER **2** S-07 S-05

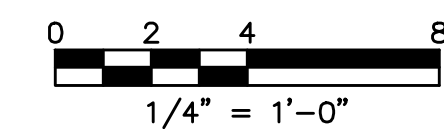

REVISION	NO.	DATE	BY	DESCRIPTION	DATE	CAD FILE NAME	DWG NUMBER	REMARKS
	A	01/2024	RW	90% SUBMITTAL				
	B	04/2024	RW	AGENCY REVIEW				
	C	08/2024	RW	ISSUED FOR CONSTRUCTION				



REVISIONS				
NO.	BY	DATE	CKD	REMARKS
A	RW	01/2024	TH	90% SUBMITTAL
B	RW	04/2024	TH	AGENCY REVIEW
C	RW	08/2024	TH	ISSUED FOR CONSTRUCTION

DES  
RW  
DWN  
RW  
CKD  
TH

City of Phoenix

CITY OF PHOENIX  
WATER SERVICES DEPARTMENT

LIFT STATION 40  
REFURBISHMENT

STRUCTURAL

ELECTRICAL AND CONTROL BUILDING  
ROOF FRAMING PLAN

COPYRIGHT © 2007-JANUARY

CITY PROJECT NO. WS90400085

DATE: 08/2024

S-07 SHEET 63 OF 134


CAD FILE: CSSL40P02.dwg

USER:RWRIGHT FILE: C:\pwworking\west01\05411632\CSSL40P02.dwg DATE: 8/28/24 TIME: 04:46pm


THIS DRAWING MUST BE FIELD VERIFIED BEFORE USE. DRAWING NOT TO SCALE UNLESS SCALE BAR IS PRESENT

FOR CONSTRUCTION


PER CITY OF PHOENIX CODE CHAPTER 2, SECTION 2-28, THESE PLANS ARE FOR OFFICIAL USE ONLY AND MAY NOT BE SHARED WITH OTHERS EXCEPT AS REQUIRED TO FULFILL THE OBLIGATIONS OF THE CONTRACTOR'S CONTRACT WITH THE CITY OF PHOENIX. THIS DOCUMENT MUST BE KEPT SECURE AT ALL TIMES.

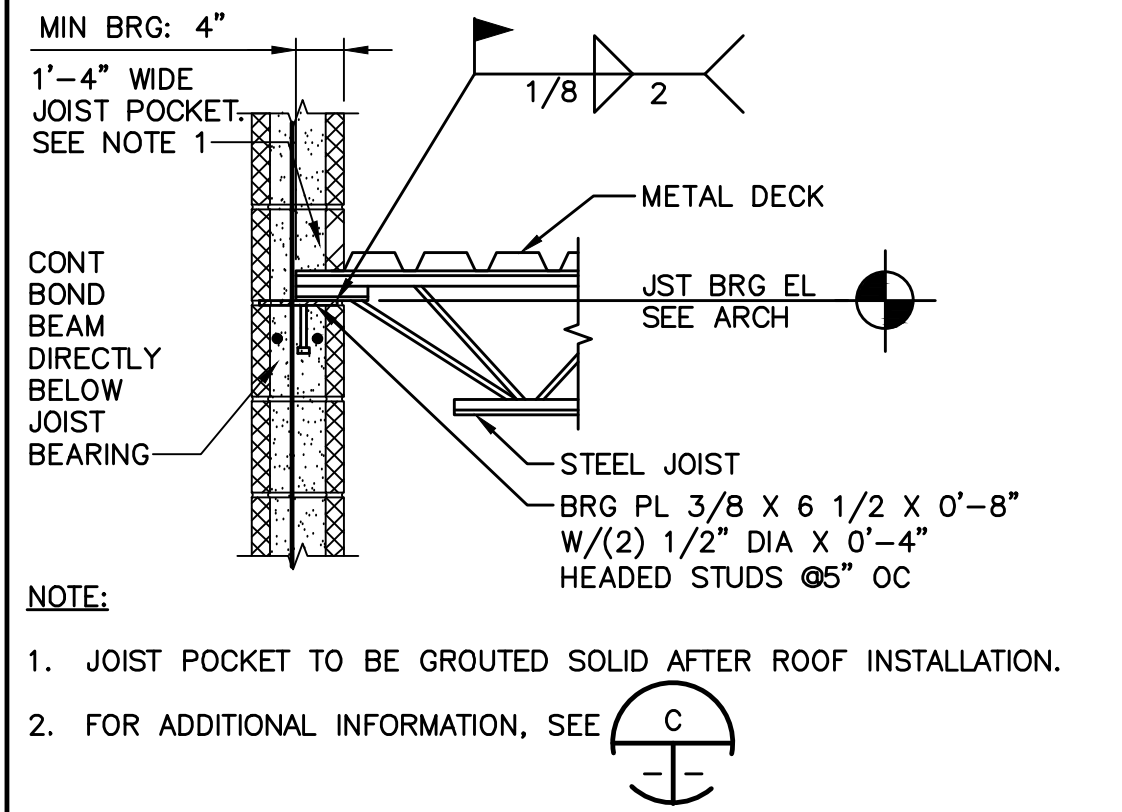


**TYPICAL JOIST BEARING DETAIL** 1  
 S-08 | S-07  
 SCALE = NTS

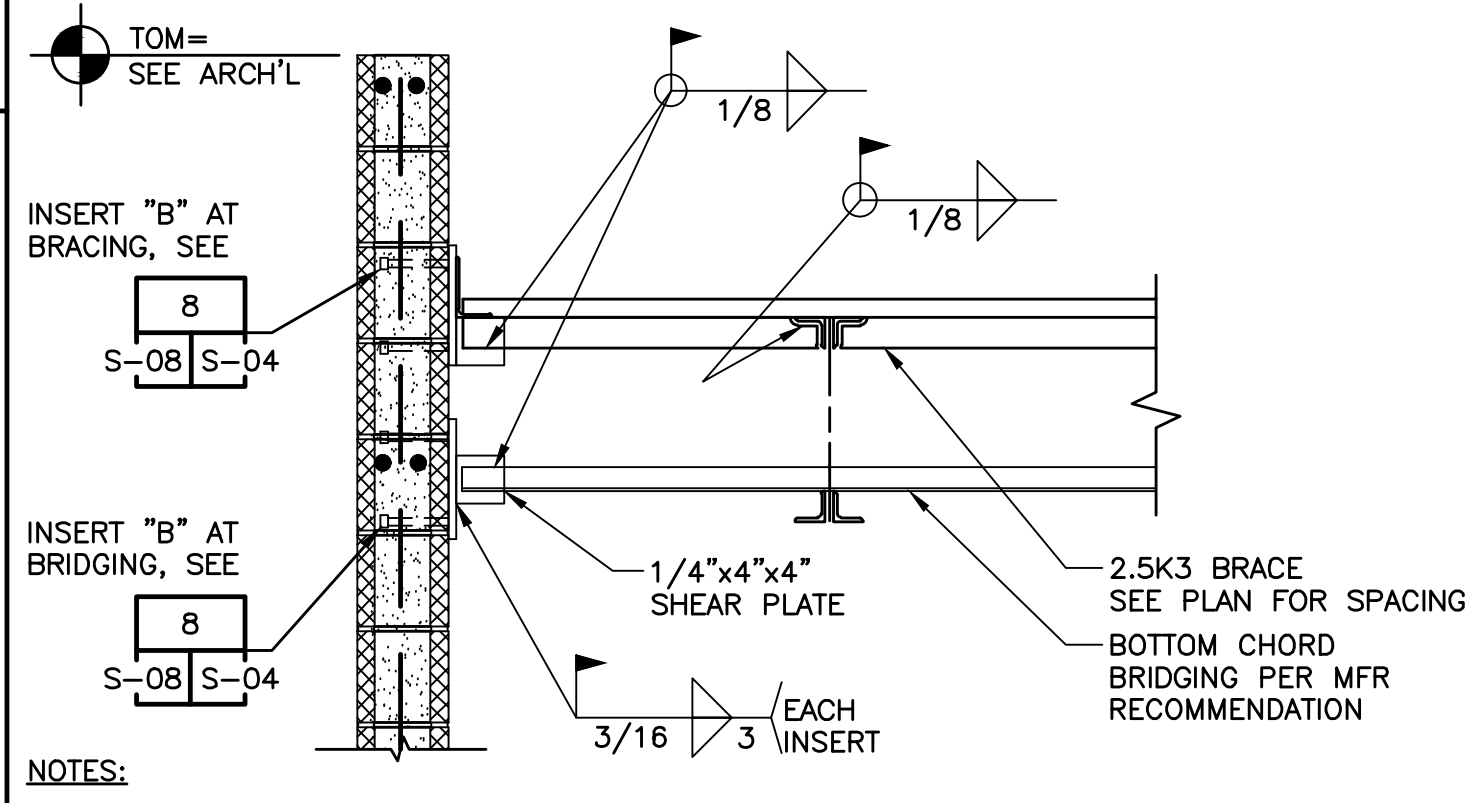

**DETAIL AT BRACING** 2  
 S-08 | S-07  
 SCALE = NTS

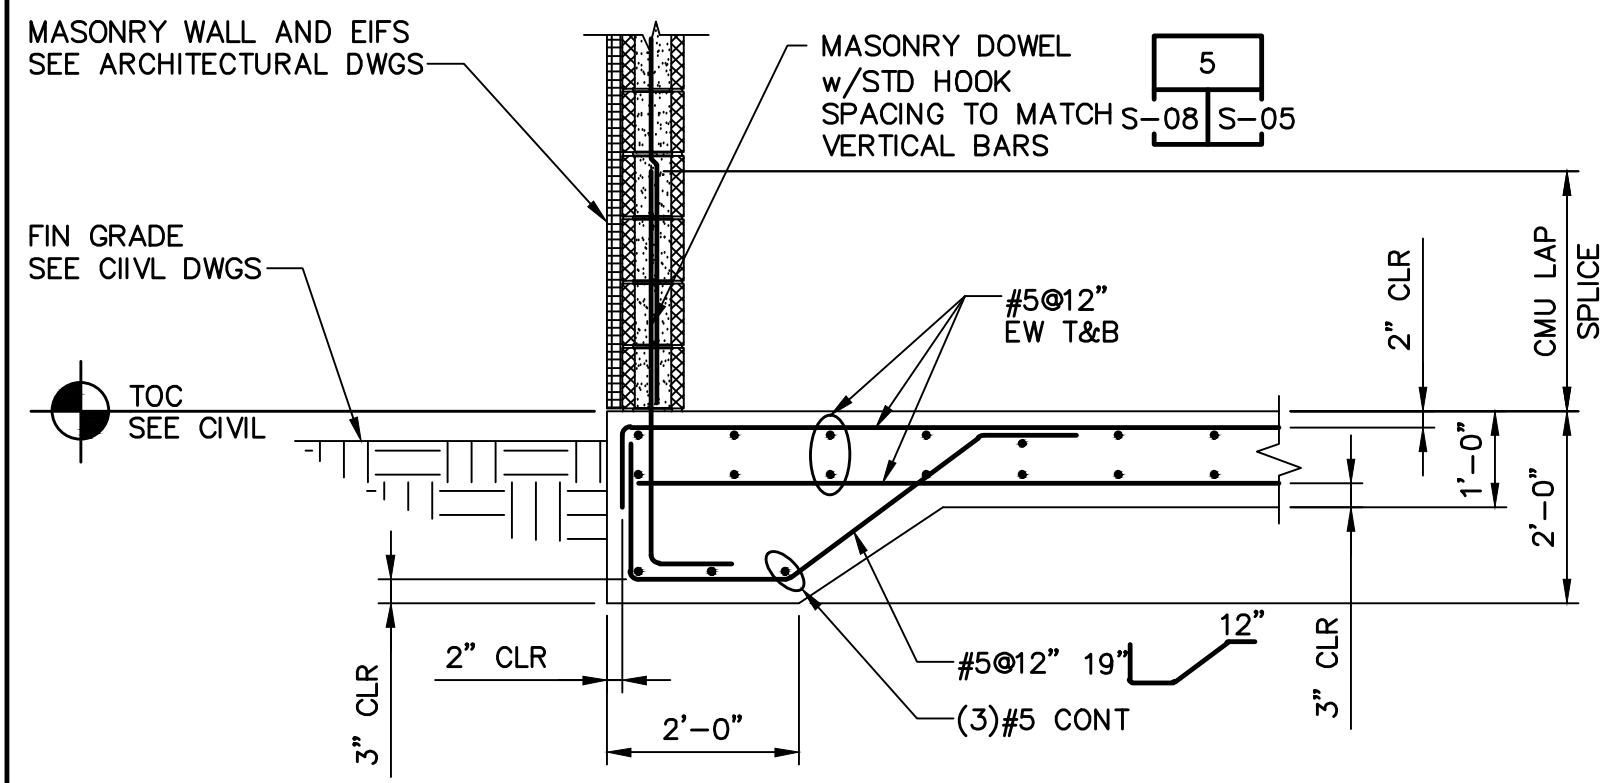


**SECTION A** 5  
 S-08 | S-05  
 SCALE = NTS

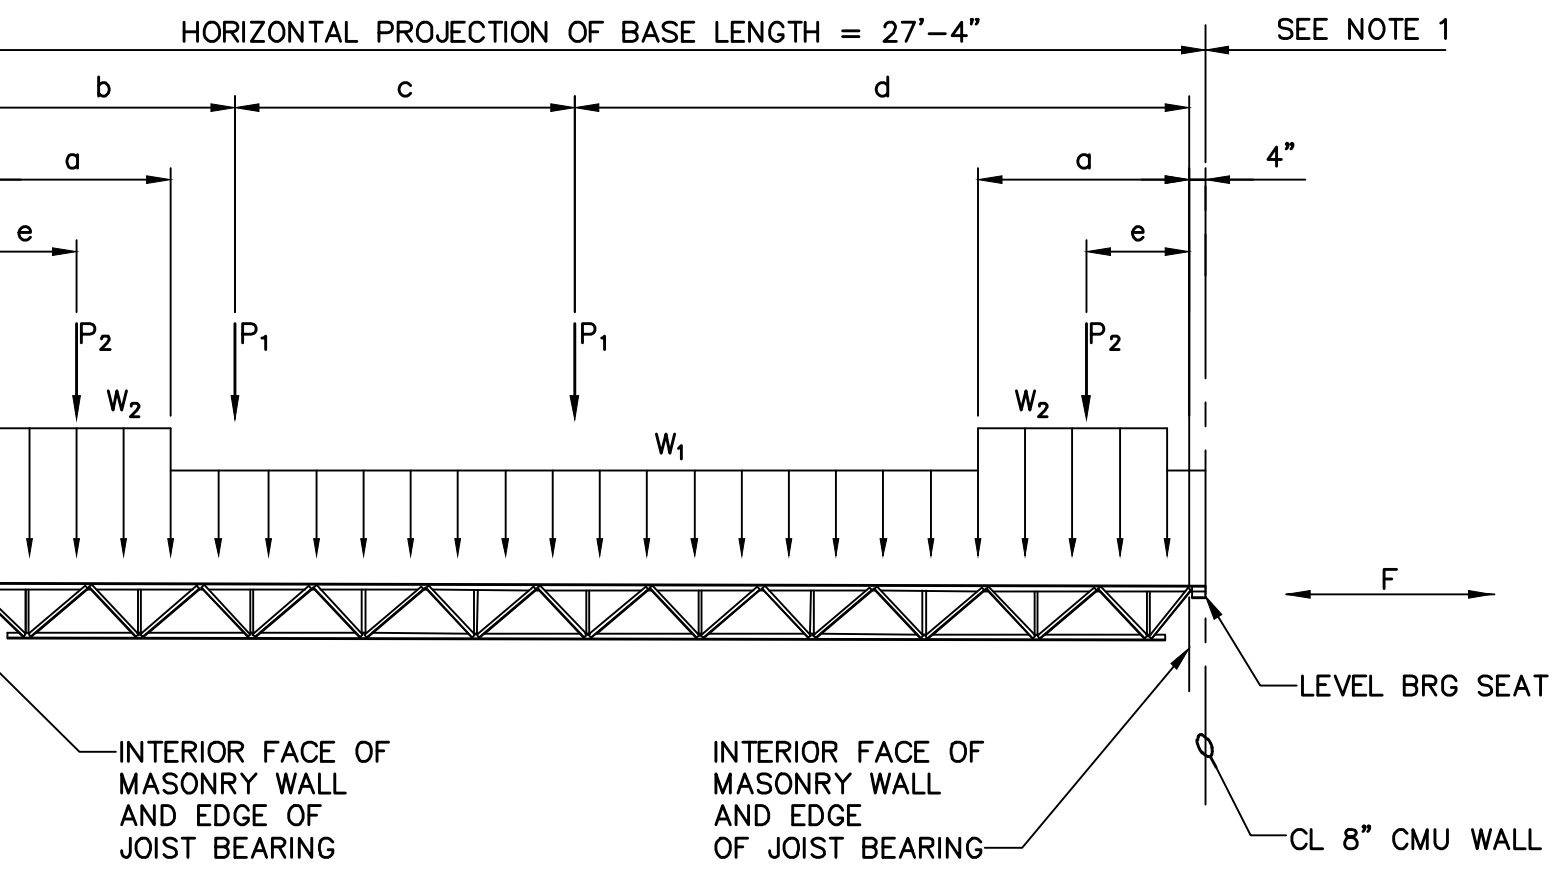


**JOIST LOADING DIAGRAM**

JOIST	DIMENSION	LOAD	DEAD	LIVE	WIND	SEISMIC
18K	a=8'-4"	W1	210 PLF	130 PLF	+120 PLF / -317 PLF	-
	b=6'-11"	W2	210 PLF	130 PLF	+120 PLF / -528 PLF	-
	c=7'-6"	F	-	-	+/-1.5 KIP	+/-1.6 KIP
	d=12'-3"	P1	1200 LBS	-	-	-
	e=2'-0"	P2	1300 LBS	-	-	-


**JOIST LOAD DIAGRAM** 3  
 SCALE = NTS

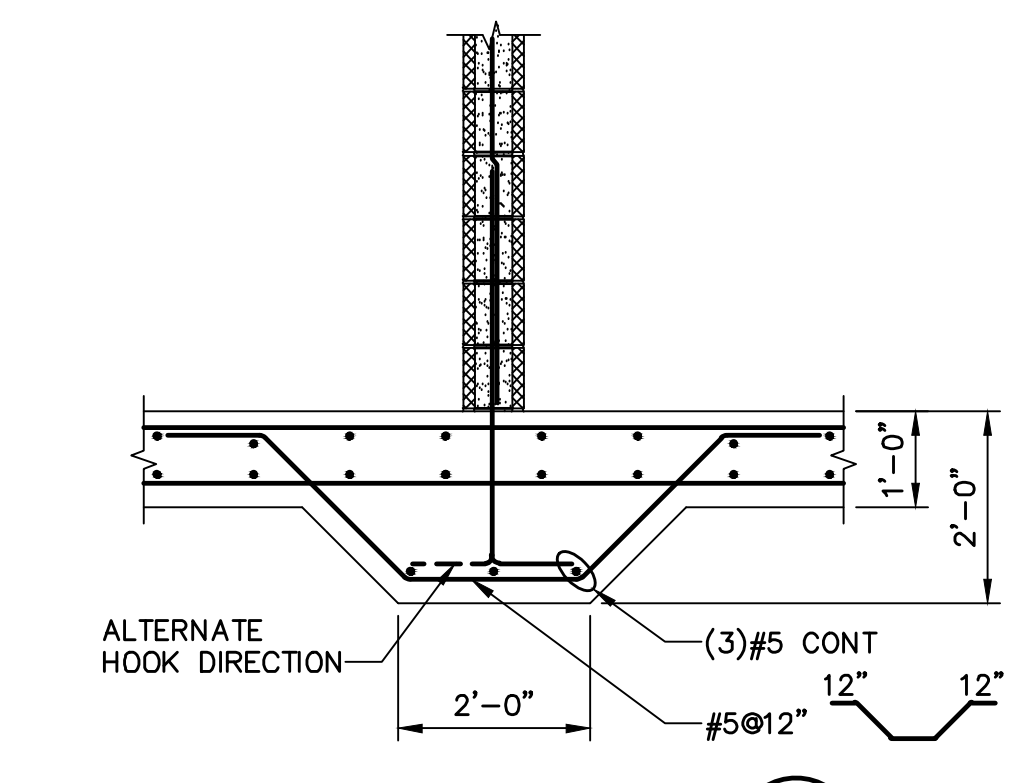

**SECTION B** 8  
 S-08 | S-04  
 SCALE = 3/4" = 1'-0"

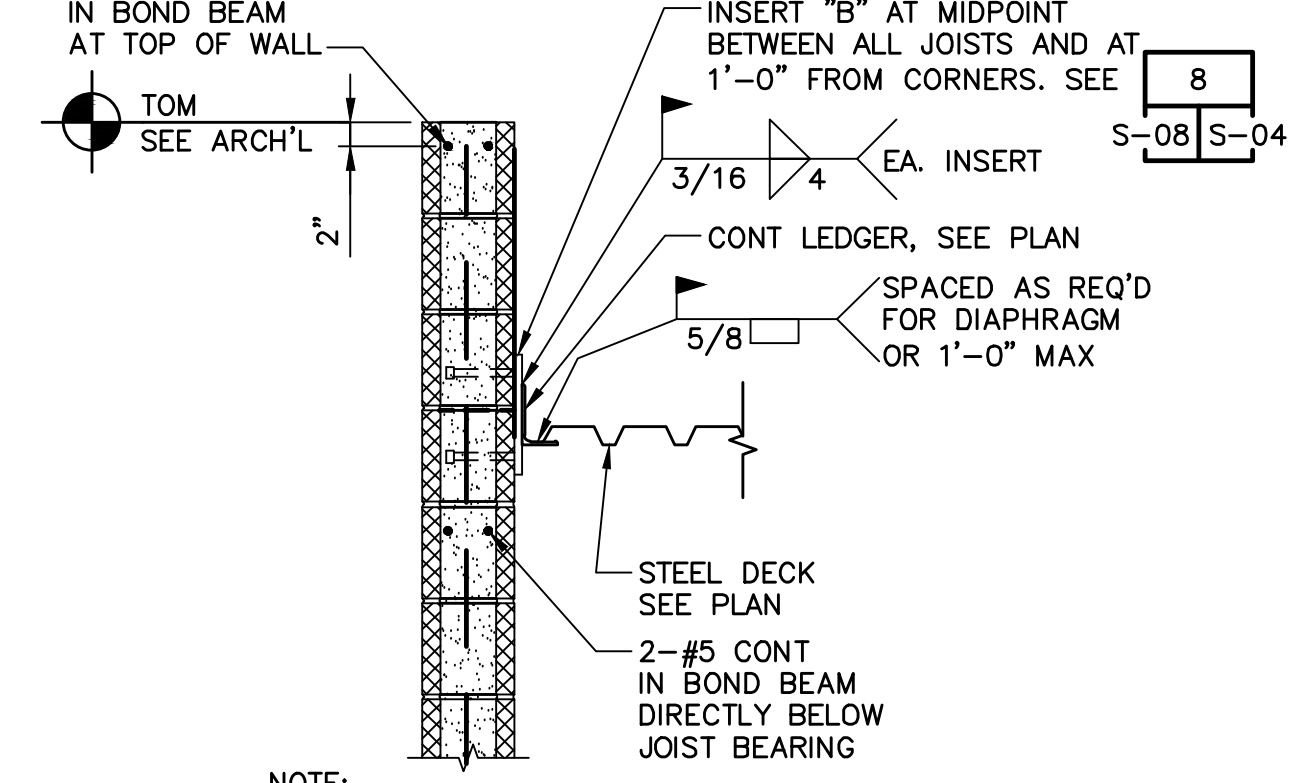


**SECTION C** 8  
 S-08 | S-04  
 SCALE = 3/4" = 1'-0"

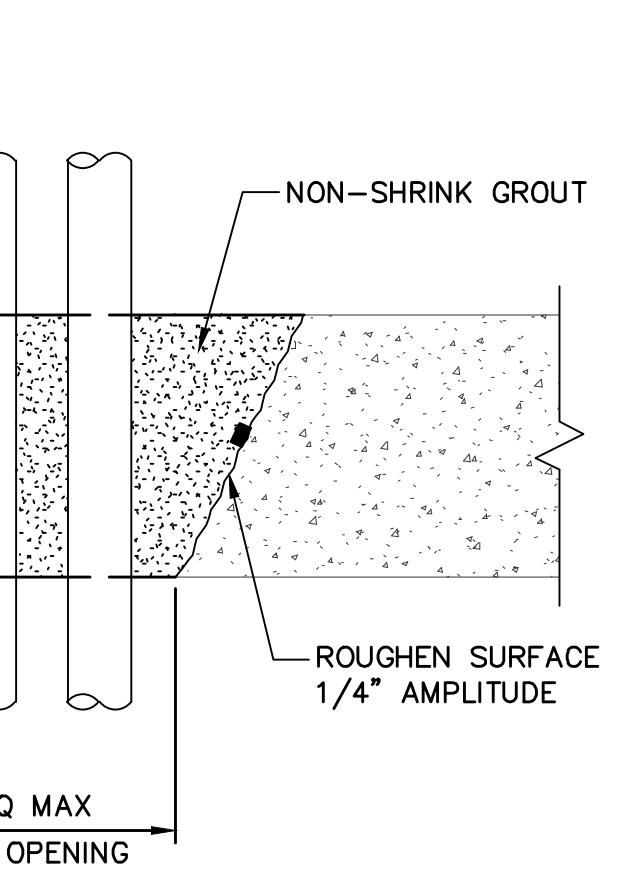


**IN CONCRETE SLAB**

- NOTES:**
- USE DETAIL ONLY WHERE THE FOLLOWING APPLY UNLESS NOTED ON THE DRAWINGS:
    - CONDUITS ARE CLOSELY SPACED IN A CLUSTER OF (4) OR MORE CONDUITS.
    - SLAB OR WALL REINFORCEMENT IS TIGHTLY SPACED AT 6" AND SMALLER.
    - CONDUIT CANNOT BE LOCATED WITHOUT INTERFERING WITH REINFORCEMENT.
  - WHERE SLAB AND WALL BLOCKOUTS ARE LOCATED BELOW GRADE PROVIDE 1 1/2" WIDE PREFORMED STRIP TYPE WATERSTOP CENTERED IN WALL OR SLAB ALL AROUND OPENING.
  - WALL AND SLAB REINFORCEMENT NOT SHOWN FOR CLARITY.
  - PROVIDE ADDITIONAL REINFORCEMENT AROUND OPENING PER DETAIL 1 ON SHEET S-03.
  - THERE SHALL BE 2'-6" MINIMUM SPACING BETWEEN ADJACENT OPENINGS.
  - CONDUITS SHALL NOT BE LOCATED TO PENETRATE THROUGH FOOTINGS OR NEAR BEARING WALLS.
  - SEE ELECTRICAL DRAWINGS FOR ADDITIONAL INFORMATION.

**ELECTRICAL CONDUIT BLOCKOUT** 4  
 S-08 | S-04  
 SCALE: NTS

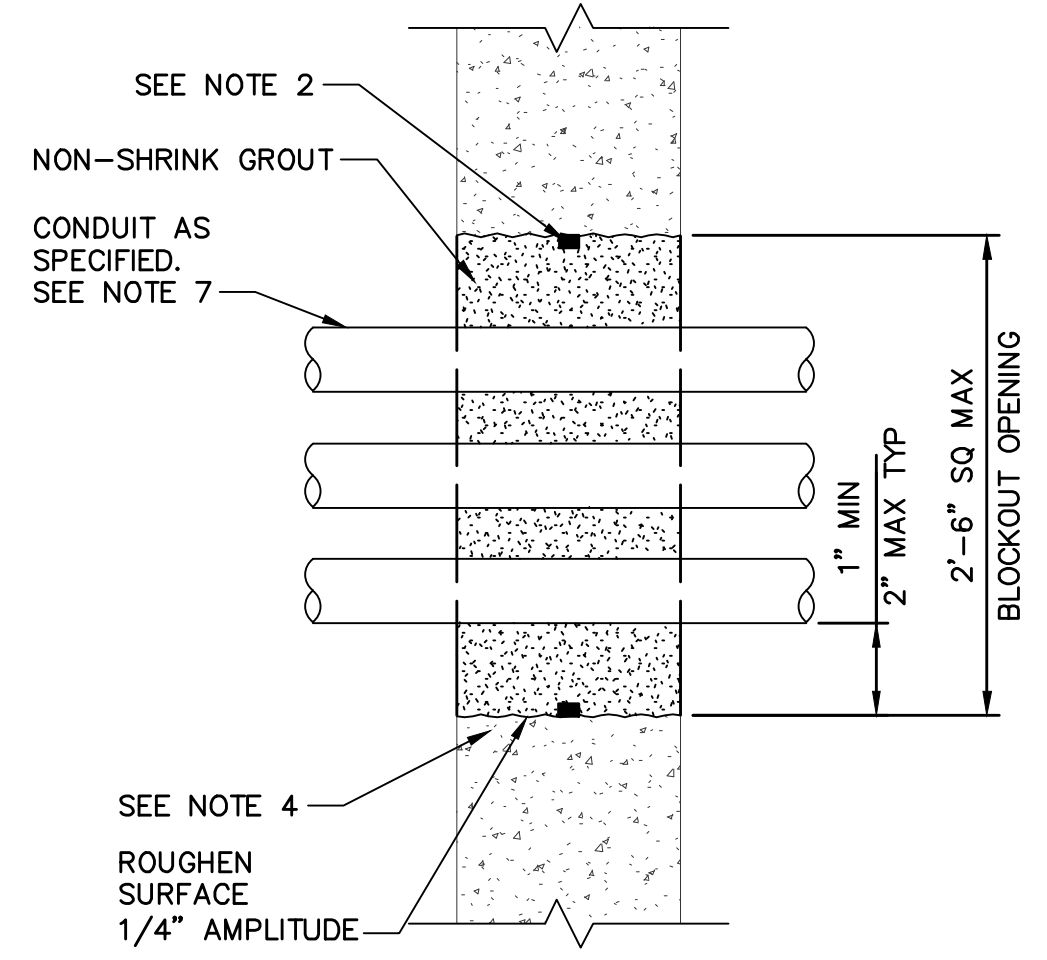

**IN CONCRETE WALL**

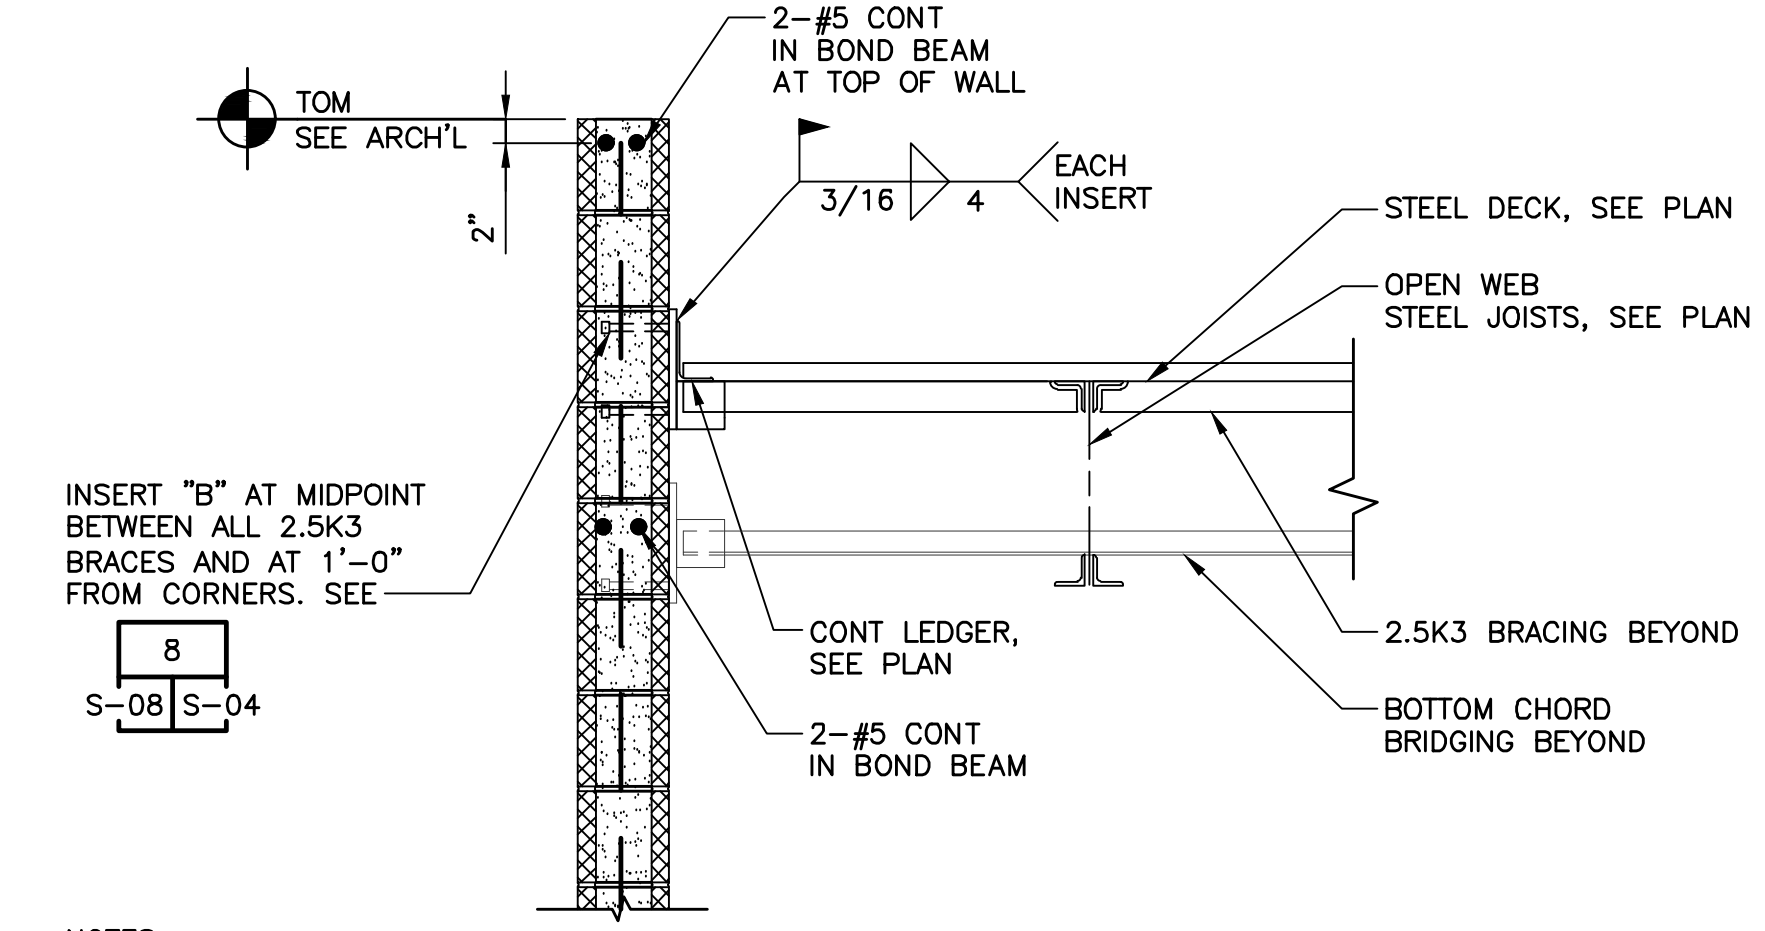

- NOTES:**
- AT CONTRACTOR'S OPTION, INSERTS FOR BRIDGING AND BRACING ATTACHMENT TO CMU WALL MAY BE POST-INSTALLED. SUBMIT DETAILS FOR REVIEW AND APPROVAL. SEE SPECIFICATION SECTION 03 15 19 FOR ADDITIONAL INFORMATION.
  - FOR ADDITIONAL INFORMATION, SEE 2

**SECTION D** 8  
 S-08 | S-07  
 SCALE = 3/4" = 1'-0"

REVISIONS					
NO.	BY	DATE	CHKD	REMARKS	
A	RW	01/2024	TH	90% SUBMITTAL	
B	RW	04/2024	TH	AGENCY REVIEW	
C	RW	08/2024	TH	ISSUED FOR CONSTRUCTION	

DES  
 RW  
 DWN  
 RW  
 CKD  
 TH

CITY OF PHOENIX  
 WATER SERVICES DEPARTMENT  
 LIFT STATION 40  
 REFURBISHMENT

STRUCTURAL  
 ELECTRICAL AND CONTROL BUILDING  
 SECTIONS AND DETAILS

COPYRIGHT © 2007-JANUARY  
 CITY PROJECT NO. WS90400085  
 DATE: 08/2024  
 S-08 SHEET 64 OF 134  
 CAD FILE: CSSL40001.dwg

FACILITY DRAWINGS  
 This drawing was supplied by a Consultant Engineer from a past contract. The City of Phoenix does not warrant the accuracy or completeness of the information provided by the Contractor to provide a complete and accurate portrayal of facilities as they exist in the field.


FOR CITY OF PHOENIX USE ONLY - REFERENCE CID NUMBER: #	PROJECT NO.	PROJECT NAME	DATE	CAD FILE NAME	DWG NUMBER	REMARKS




THIS DRAWING MUST BE FIELD VERIFIED BEFORE USE  
DRAWING NOT TO SCALE UNLESS SCALE BAR IS PRESENT

FOR CONSTRUCTION

"PER CITY OF PHOENIX CODE CHAPTER 2, SECTION 2-28, THESE PLANS ARE FOR OFFICIAL USE ONLY AND MAY NOT BE SHARED WITH OTHERS EXCEPT AS REQUIRED TO FULFILL THE OBLIGATIONS OF THE CONTRACTOR'S CONTRACT WITH THE CITY OF PHOENIX."  
THIS DOCUMENT MUST BE KEPT SECURE AT ALL TIMES.

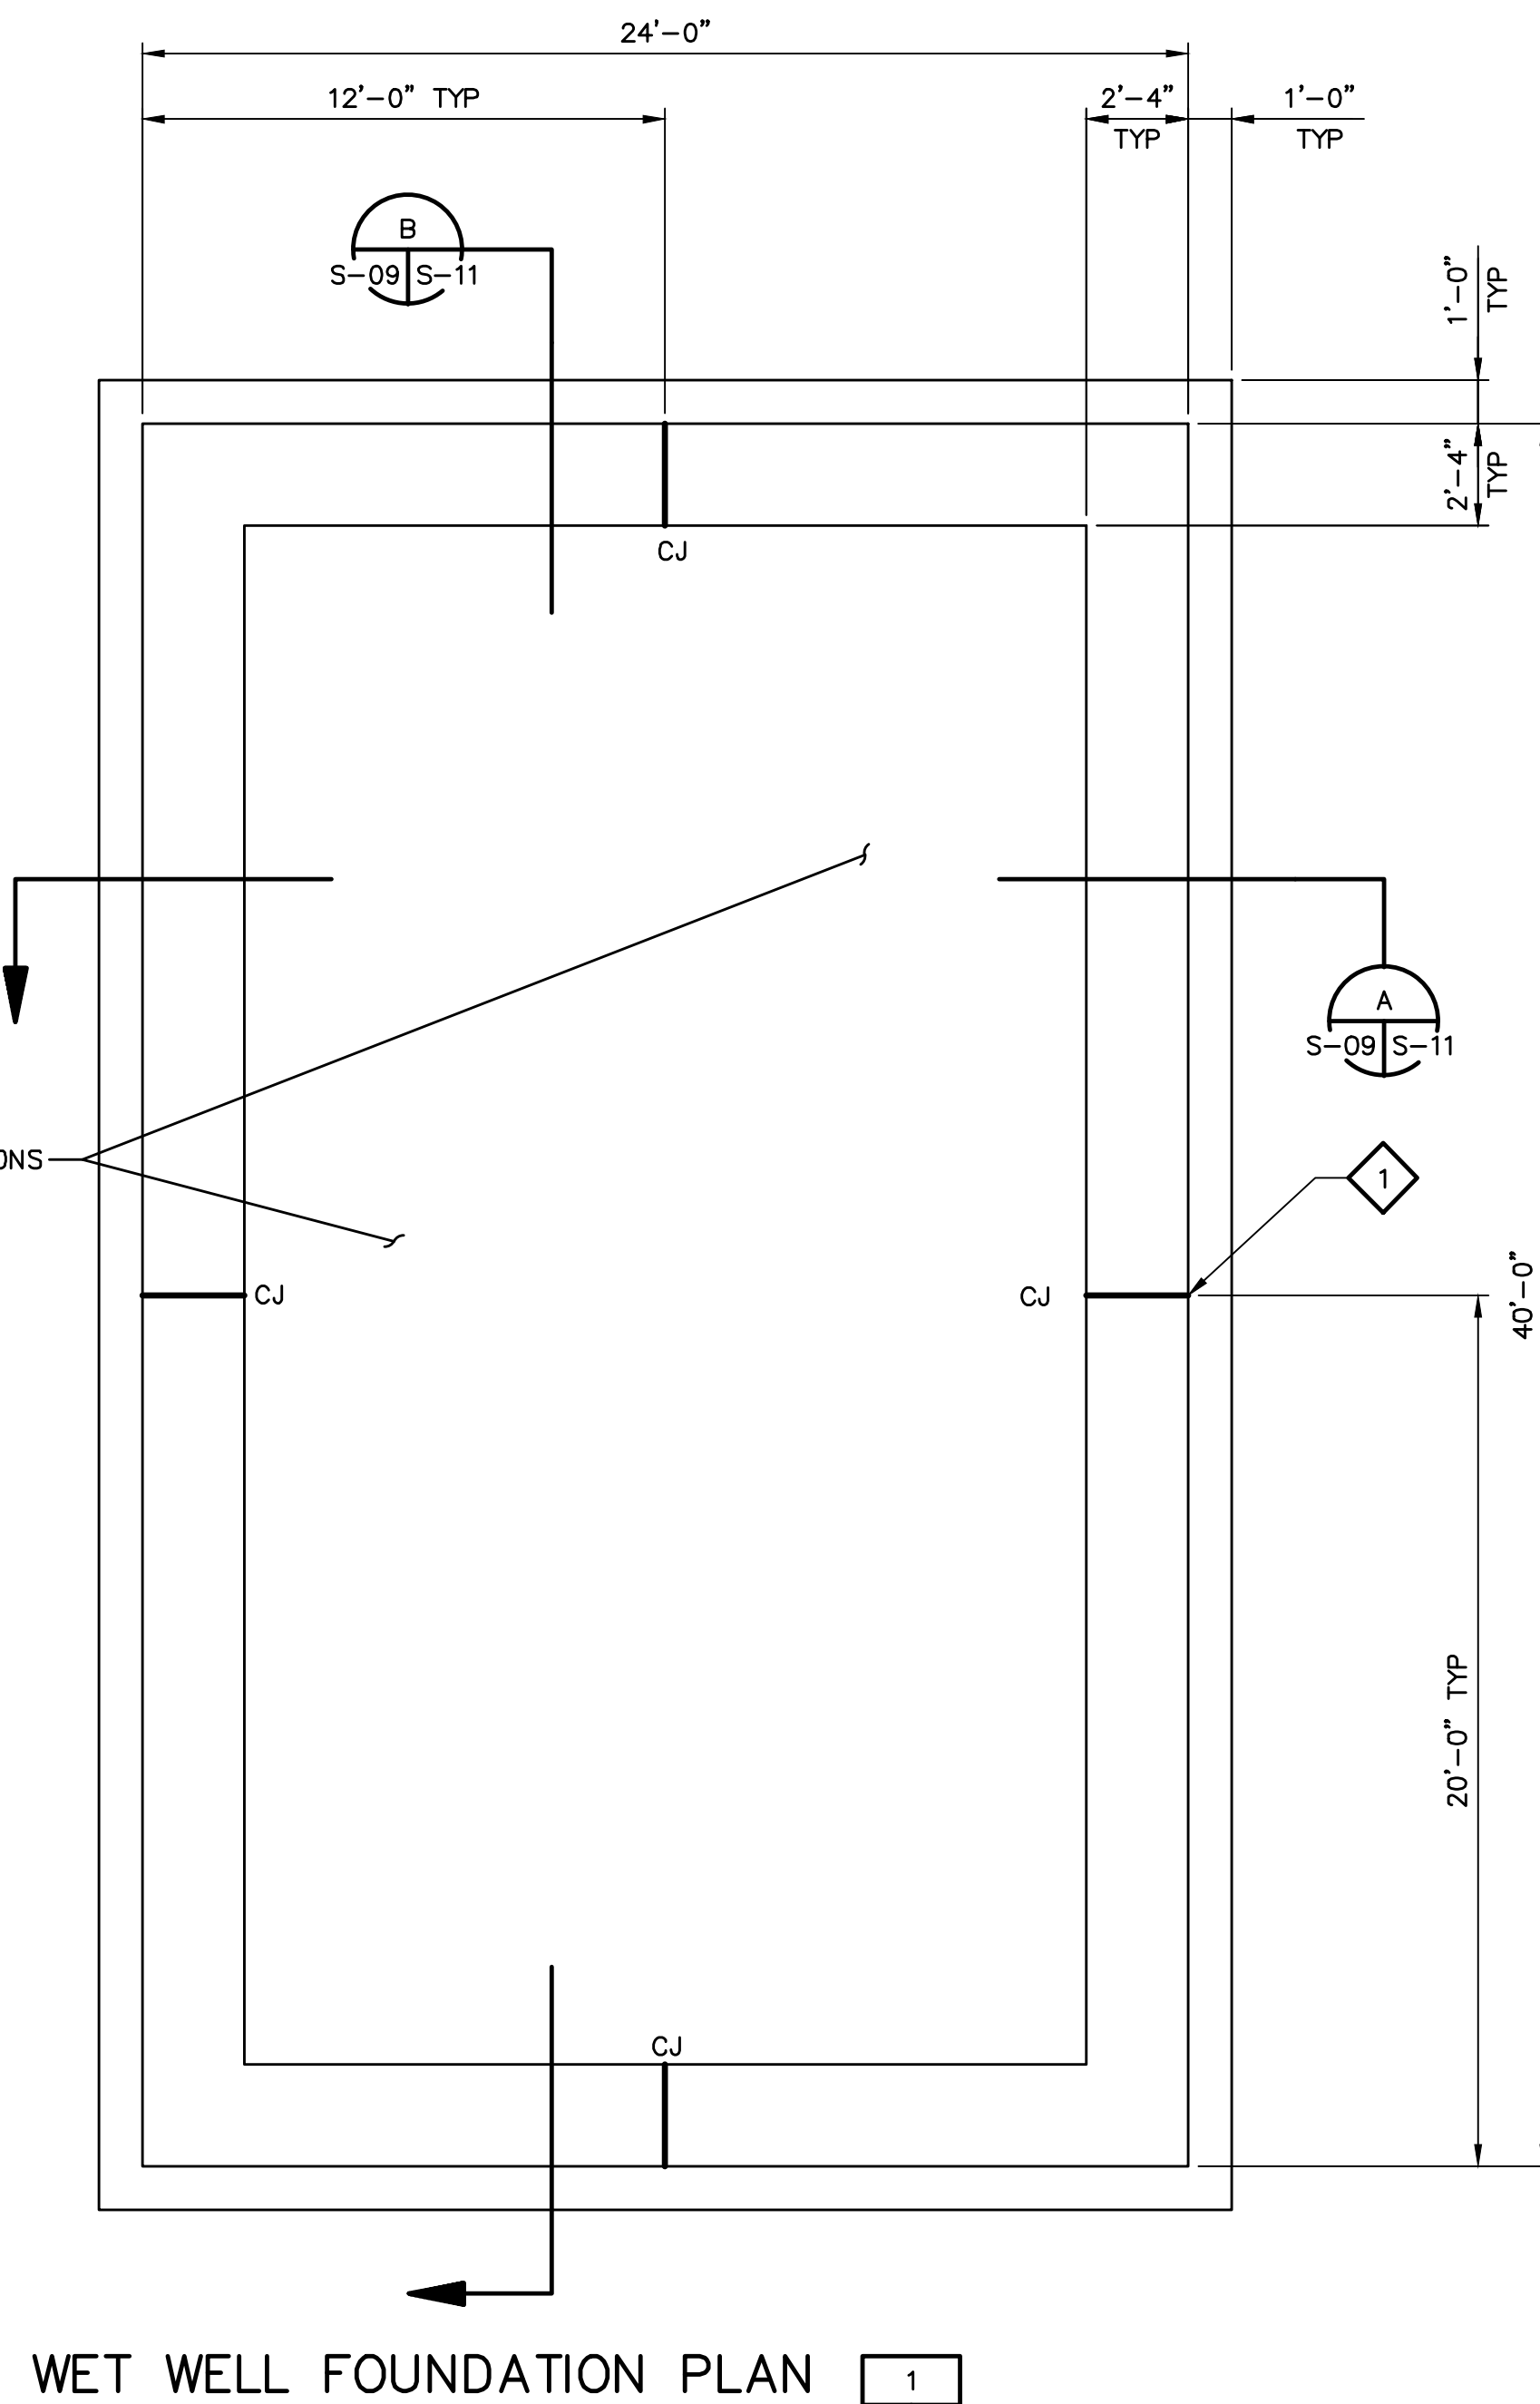


WET WELL FOUNDATION PLAN 1  
SCALE: 1/4" = 1'-0"

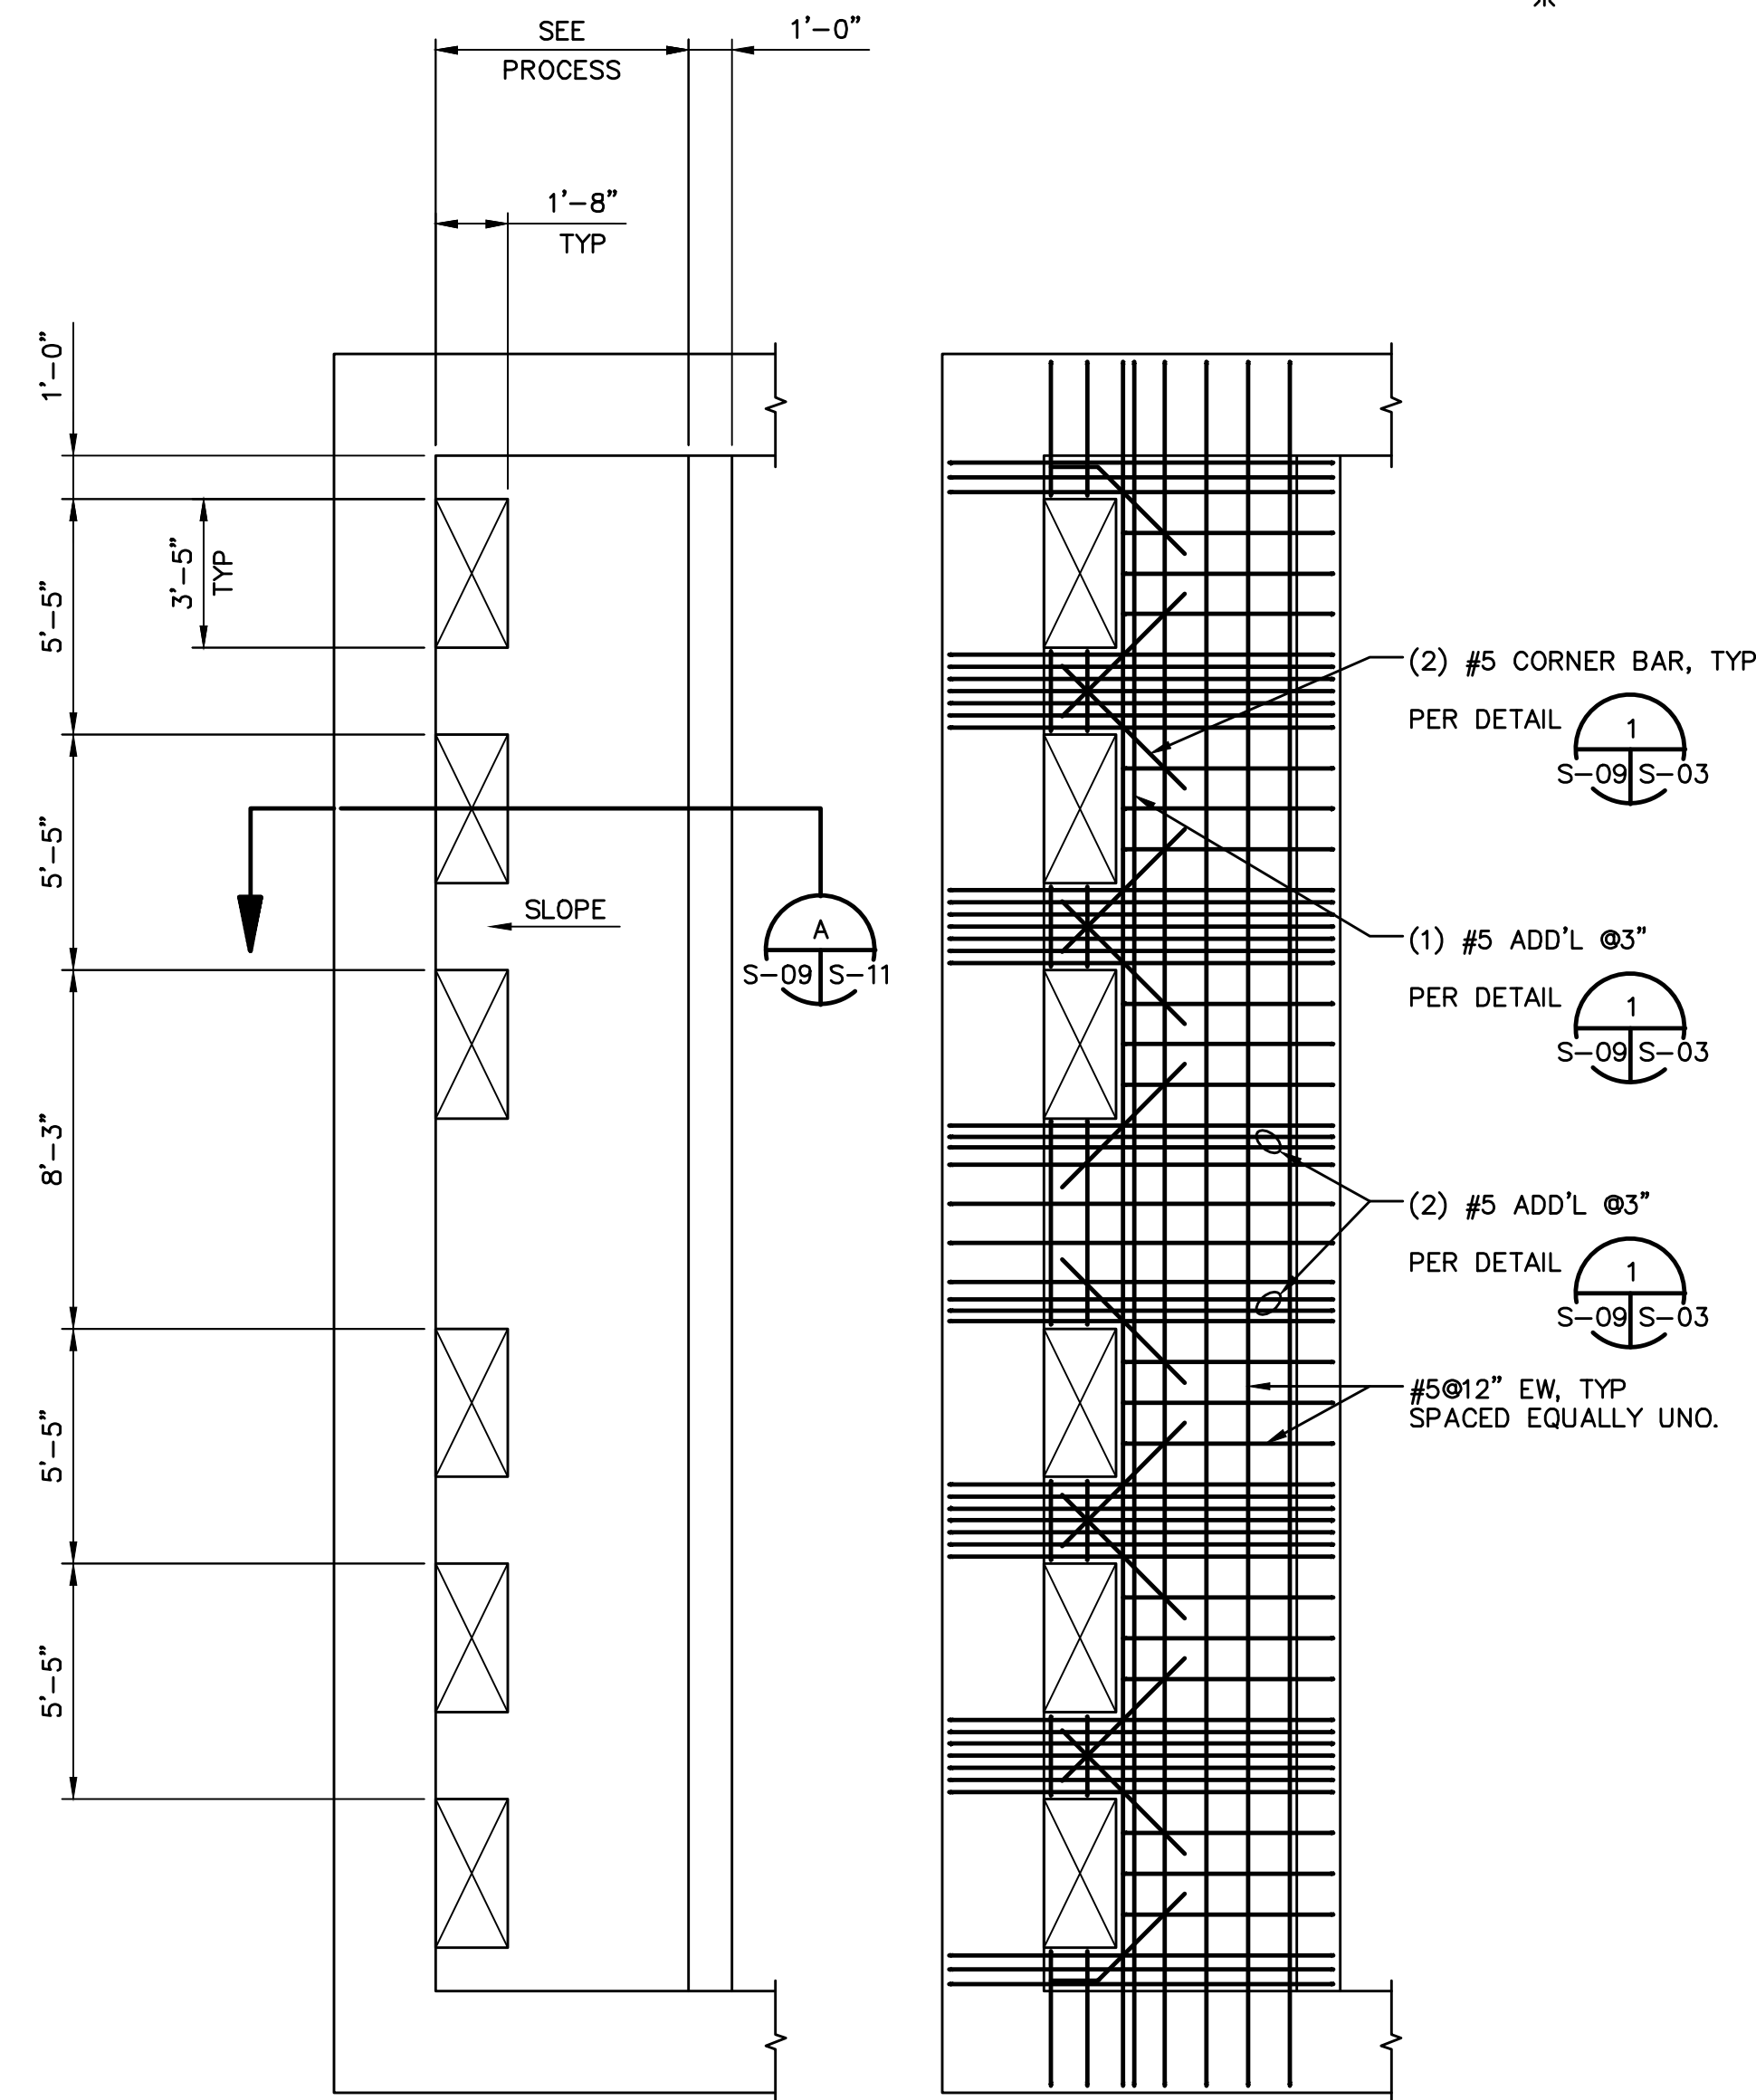

WET WELL CHANNEL PARTIAL PLAN 2  
AT ELEVATION 1200.75'  
SCALE: 1/4" = 1'-0"

REINFORCEMENT LAYOUT PLAN

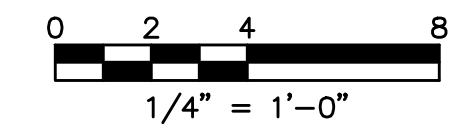

GENERAL NOTES


- STRUCTURAL DESIGN CRITERIA SHALL BE IN ACCORDANCE WITH THE REQUIREMENTS SHOWN ON SHEETS S-01.
- SEE CIVIL DRAWINGS FOR STRUCTURE LOCATION AND COORDINATE POINTS.
- SEE PROCESS DRAWINGS FOR EQUIPMENT, PIPING AND PIPE SUPPORT INFORMATION.
- FOR SLAB REINFORCEMENT, SEE FULL SECTIONS.

KEY NOTES

- VERTICAL CONSTRUCTION JOINT IN WALL WITH WATERSTOP. TYPICAL. SEE 6 S-09 S-03

FACILITY DRAWINGS  
This drawing was supplied by a Consultant Engineer from a past contractor and is provided for informational purposes only. The City does not warrant this drawing to be a complete and accurate portrayal of facilities as they exist in the field.

REVISION	ENGINEERING COMPANY	PROJECT NO.	PROJECT NAME	DATE	DWG NUMBER	REMARKS
#						

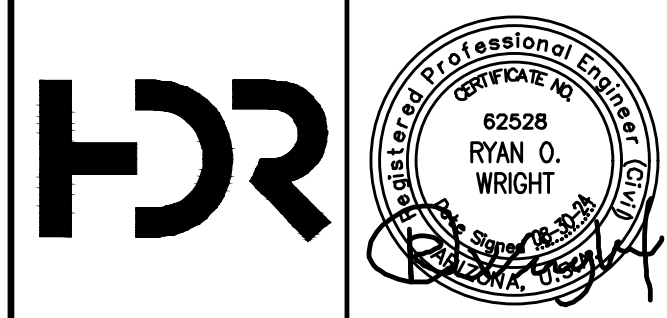

REVISIONS				
NO.	BY	DATE	CKD	REMARKS
A	RW	01/2024	TH	90% SUBMITTAL
B	RW	04/2024	TH	AGENCY REVIEW
C	RW	08/2024	TH	ISSUED FOR CONSTRUCTION

DES  
RW  
DWN  
RW  
CKD  
TH

City of Phoenix

CITY OF PHOENIX  
WATER SERVICES DEPARTMENT

LIFT STATION 40  
REFURBISHMENT

STRUCTURAL

WET WELL  
FOUNDATION PLAN  
AND CHANNEL PARTIAL PLAN

COPYRIGHT © 2007-JANUARY

CITY PROJECT NO. WS90400085

DATE: 08/2024

S-09 SHEET 65 OF 134


CAD FILE: CSSL40P03.dwg

USER: RWRIGHT FILE: C:\Users\wright\MyAppData\Local\Temp\MapData\Local\CSSL40P03.dwg DATE: 8/28/24 TIME: 04:51pm

THIS DRAWING MUST BE FIELD VERIFIED BEFORE USE  
DRAWING NOT TO SCALE UNLESS SCALE BAR IS PRESENT

**FOR CONSTRUCTION**

"PER CITY OF PHOENIX CODE CHAPTER 2, SECTION 2-28, THESE PLANS ARE FOR OFFICIAL USE ONLY AND MAY NOT BE SHARED WITH OTHERS EXCEPT AS REQUIRED TO FULFILL THE OBLIGATIONS OF THE CONTRACTOR'S CONTRACT WITH THE CITY OF PHOENIX."  
THIS DOCUMENT MUST BE KEPT SECURE AT ALL TIMES.

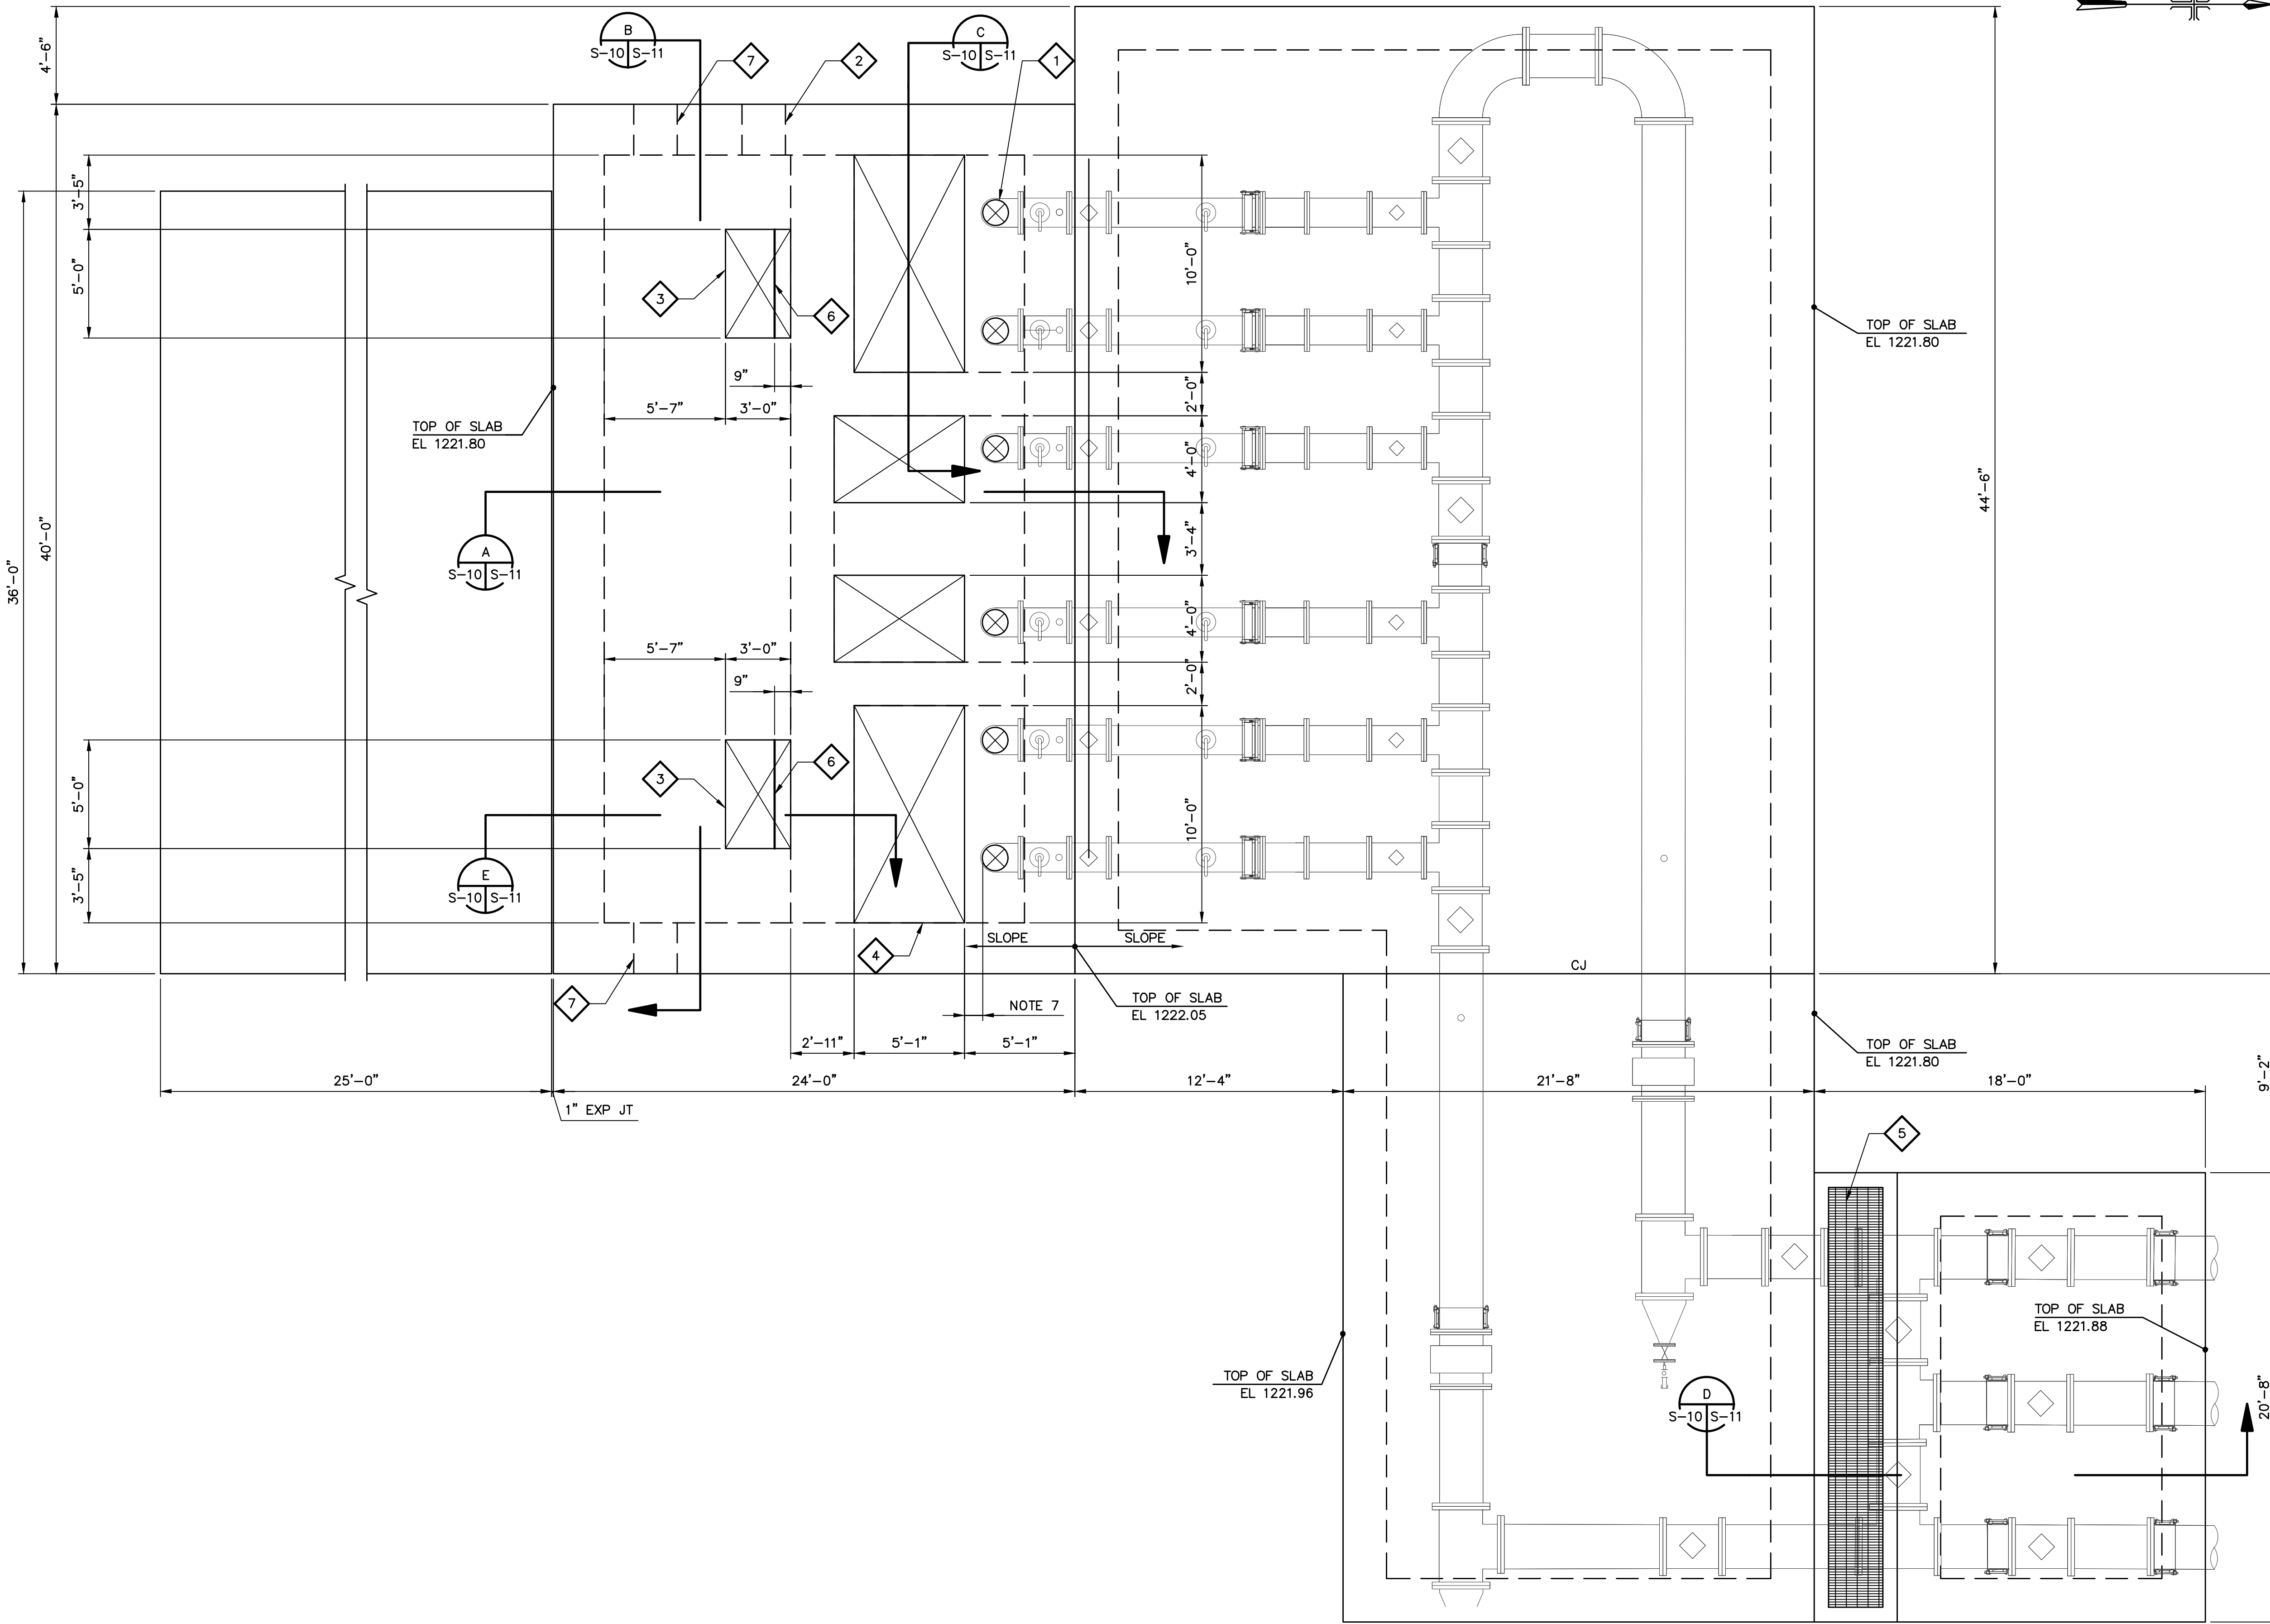

**GENERAL NOTES**


- STRUCTURAL DESIGN CRITERIA SHALL BE IN ACCORDANCE WITH THE REQUIREMENTS SHOWN ON SHEETS S-01.
- COORDINATE LOCATION AND SIZE OF EQUIPMENT PADS PRIOR TO CONCRETE PLACEMENT.
- SEE CIVIL DRAWINGS FOR STRUCTURE LOCATION AND COORDINATE POINTS.
- SEE PROCESS DRAWINGS FOR PIPING AND PIPE SUPPORT INFORMATION.
- FOR SLAB REINFORCEMENT, SEE FULL SECTIONS.
- EQUIPMENT HATCH SIZE TO BE COORDINATED WITH FINAL PUMP SELECTION TO ENSURE ADEQUATE CLEARANCES. IF A LARGER OPENING THAN THAT SHOWN IS REQUIRED, CONTACT ENGINEER TO PROVIDE CLARIFICATION PRIOR TO FABRICATION.
- ELIMINATE ADDITIONAL REINFORCING BARS REQUIRED AT OPENINGS EXCEPT THE DIAGONAL BARS AND SPACE MAIN EAST-WEST SLAB BARS AT 3" ON CENTER.

**KEY NOTES**

- 1 PENETRATION FOR PUMP DISCHARGE PIPE. TYPICAL. SEE PROCESS DRAWINGS.
- 2 PENETRATION FOR FOUL AIR DUCT. SEE PROCESS DRAWINGS.
- 3 ACCESS HATCH WITH SECONDARY FALL PROTECTION SYSTEM, TYPICAL. SEE SPECIFICATION SECTION 08 31 00 FOR ADDITIONAL INFORMATION.
- 4 EQUIPMENT HATCH WITH SECONDARY FALL PROTECTION SYSTEM, TYPICAL. SEE SPECIFICATION SECTION 08 31 00 FOR ADDITIONAL INFORMATION. SEE GENERAL NOTE 6.
- 5 FRP GRATING AND SUPPORTS PER STANDARD DETAIL. SEE SPECIFICATION SECTION 06 74 13 FOR ADDITIONAL INFORMATION.
- 6 W4x13 SST SUPPORT BEAM FOR WATER LEVEL ALARM FLOATS. FOR ADDITIONAL INFORMATION, SEE S-10 S-17.
- 7 PENETRATION FOR EXHAUST VENT. SEE PROCESS DRAWINGS.

FACILITY DRAWINGS  
This drawing was supplied by a Consultant Engineer from a past contract and is being provided to the Contractor for information only. The City does not warrant this drawing to be a complete and accurate portrayal of facilities as they exist in the field.

REVISION	ENGINEERING COMPANY	PROJECT NO.	PROJECT NAME	DATE	CAD FILE NAME	DWG NUMBER	REMARKS

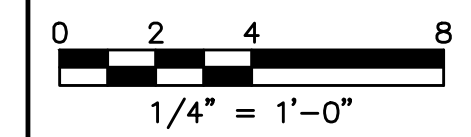

REVISIONS					
NO.	BY	DATE	CKD	REVISIONS	REMARKS
A	RW	01/2024	TH	90% SUBMITTAL	
B	RW	04/2024	TH	AGENCY REVIEW	
C	RW	08/2024	TH	ISSUED FOR CONSTRUCTION	

DES  
RW  
DWN  
RW  
CKD  
TH

CITY OF PHOENIX  
WATER SERVICES DEPARTMENT

LIFT STATION 40  
REFURBISHMENT

STRUCTURAL

WET WELL ROOF PLAN  
AND  
PIPING SUPPORT PAD

COPYRIGHT © 2007-JANUARY

CITY PROJECT NO. WS90400085

DATE: 08/2024


S-10 SHEET 66 OF 134

CAD FILE: CSSL40P04.dwg


THIS DRAWING MUST BE FIELD VERIFIED BEFORE USE  
DRAWING NOT TO SCALE UNLESS SCALE BAR IS PRESENT

FOR CONSTRUCTION


PER CITY OF PHOENIX CODE CHAPTER 2, SECTION 2-28, THESE PLANS ARE FOR OFFICIAL USE ONLY AND MAY NOT BE SHARED WITH OTHERS EXCEPT AS REQUIRED TO FULFILL THE OBLIGATIONS OF THE CONTRACTOR'S CONTRACT WITH THE CITY OF PHOENIX. THIS DOCUMENT MUST BE KEPT SECURE AT ALL TIMES.

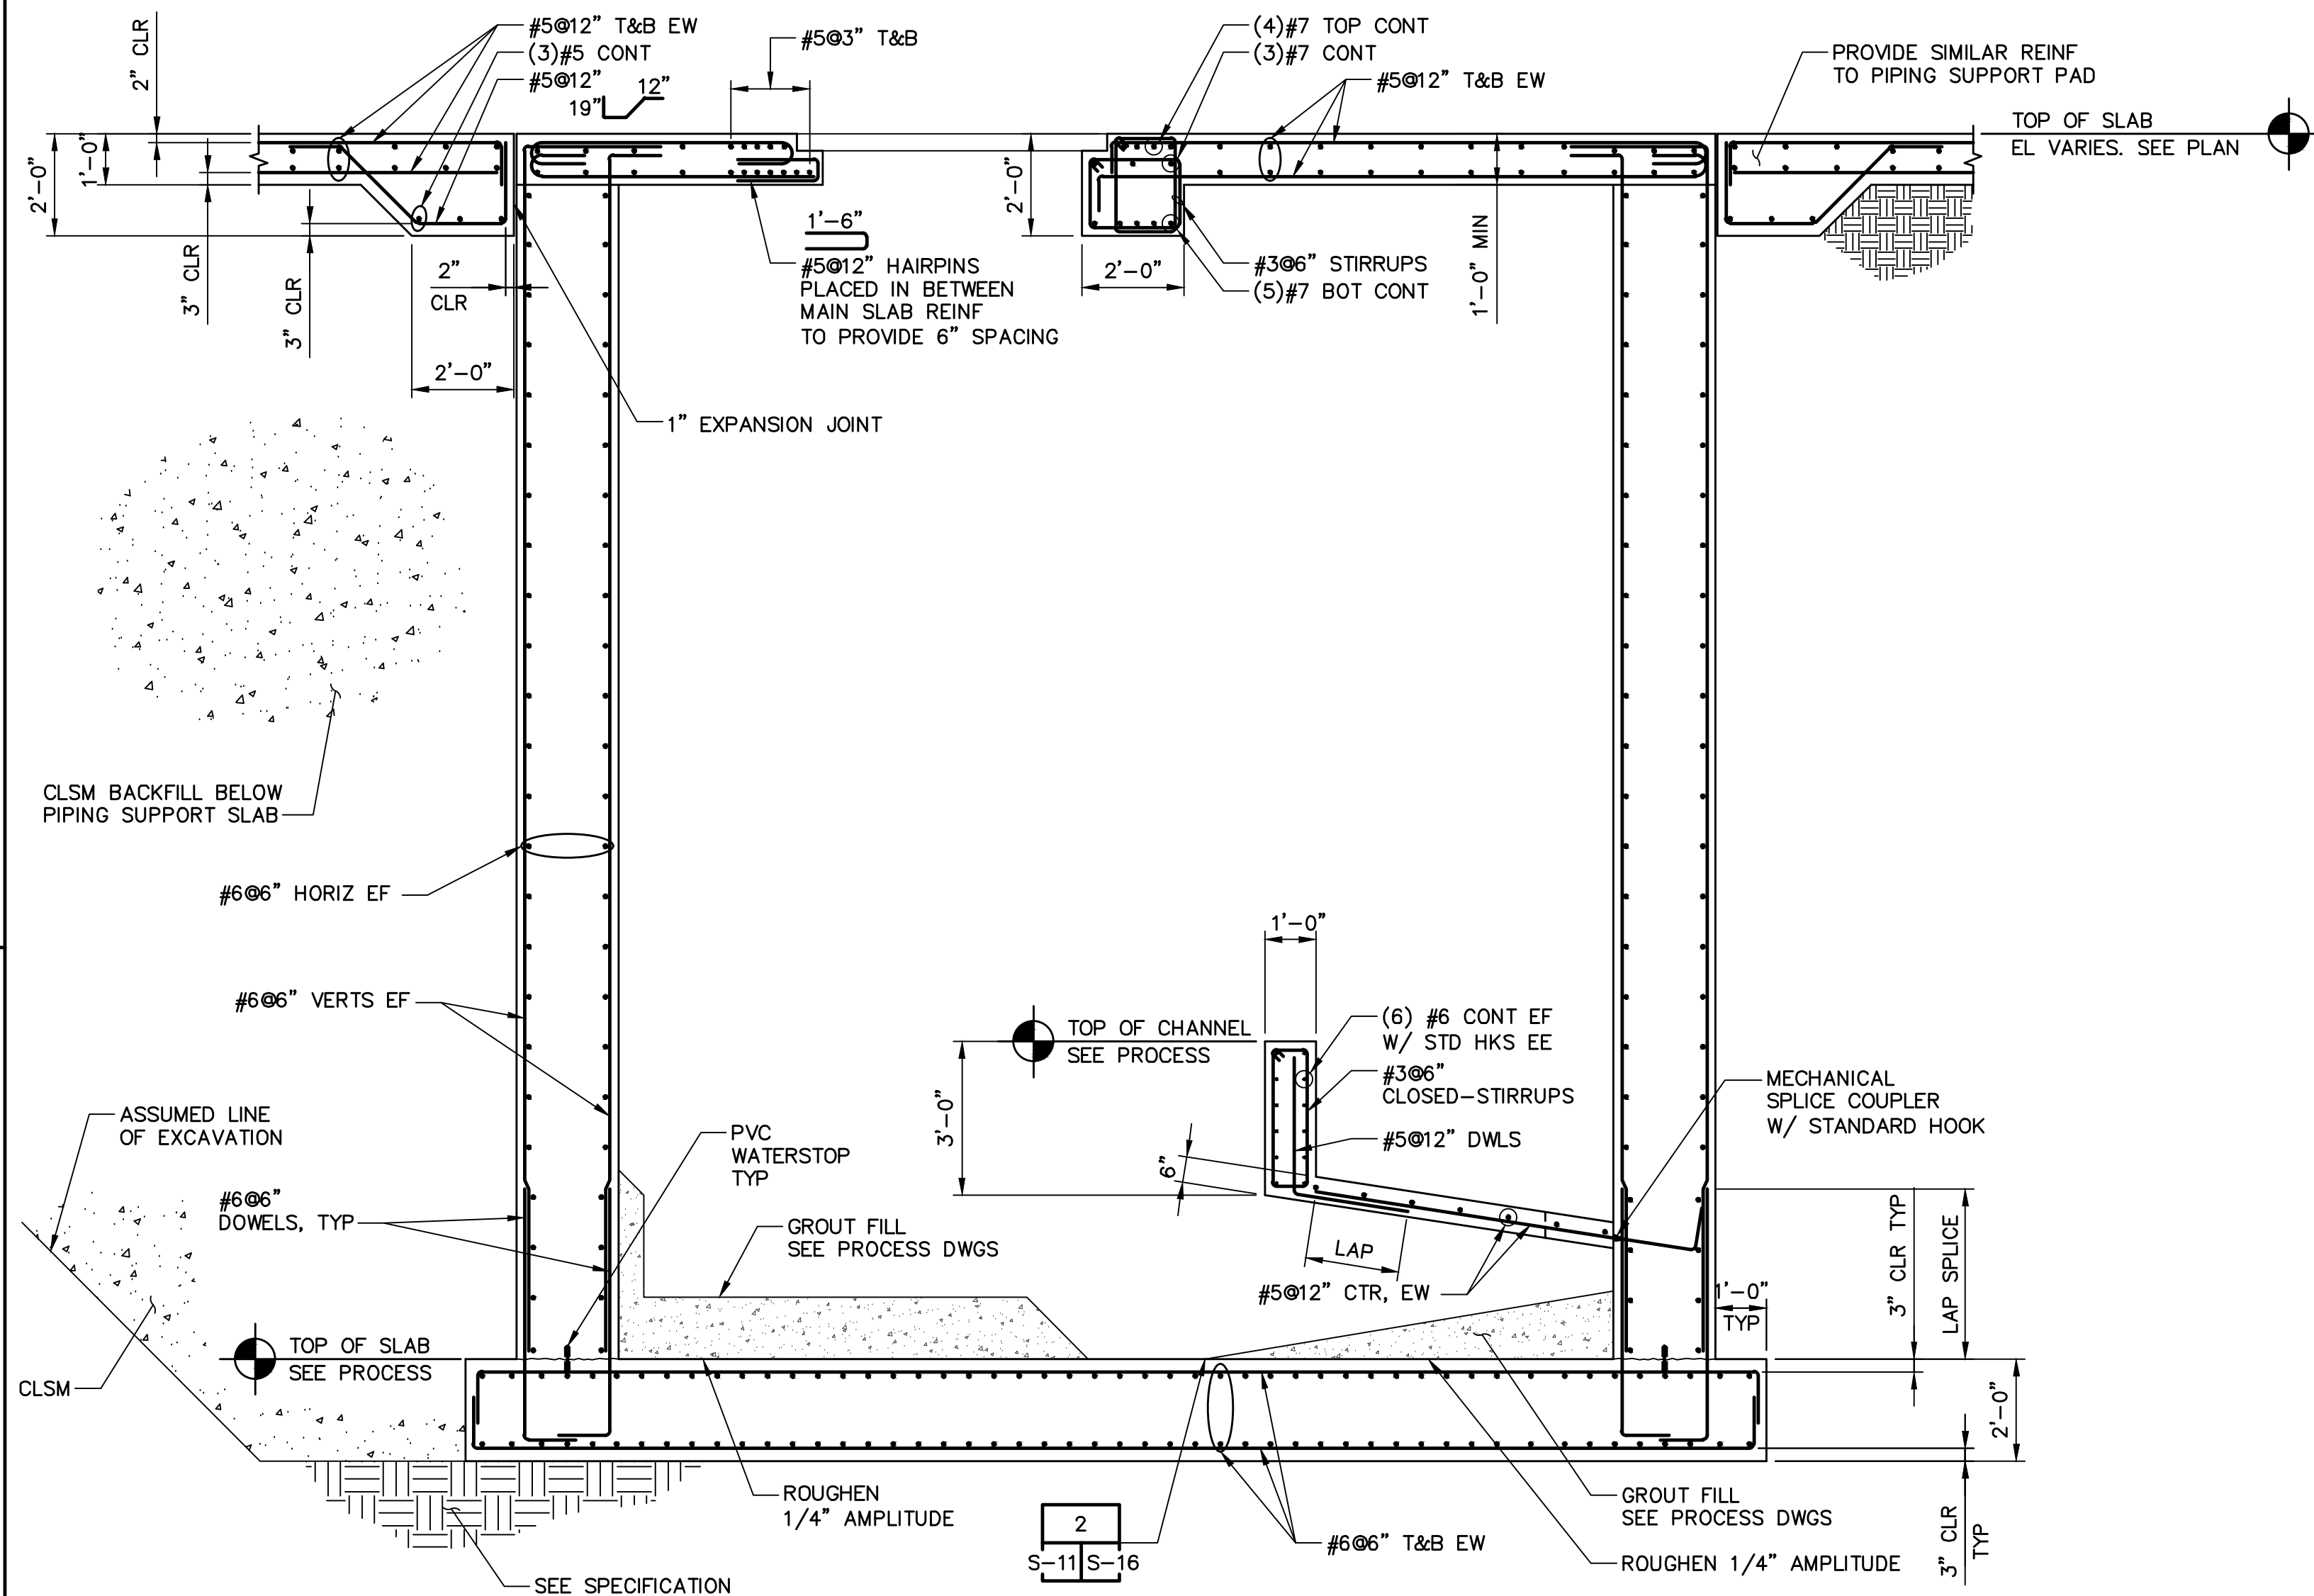


SECTION A  
S-11 S-09  
SCALE = 3/8" = 1'-0"

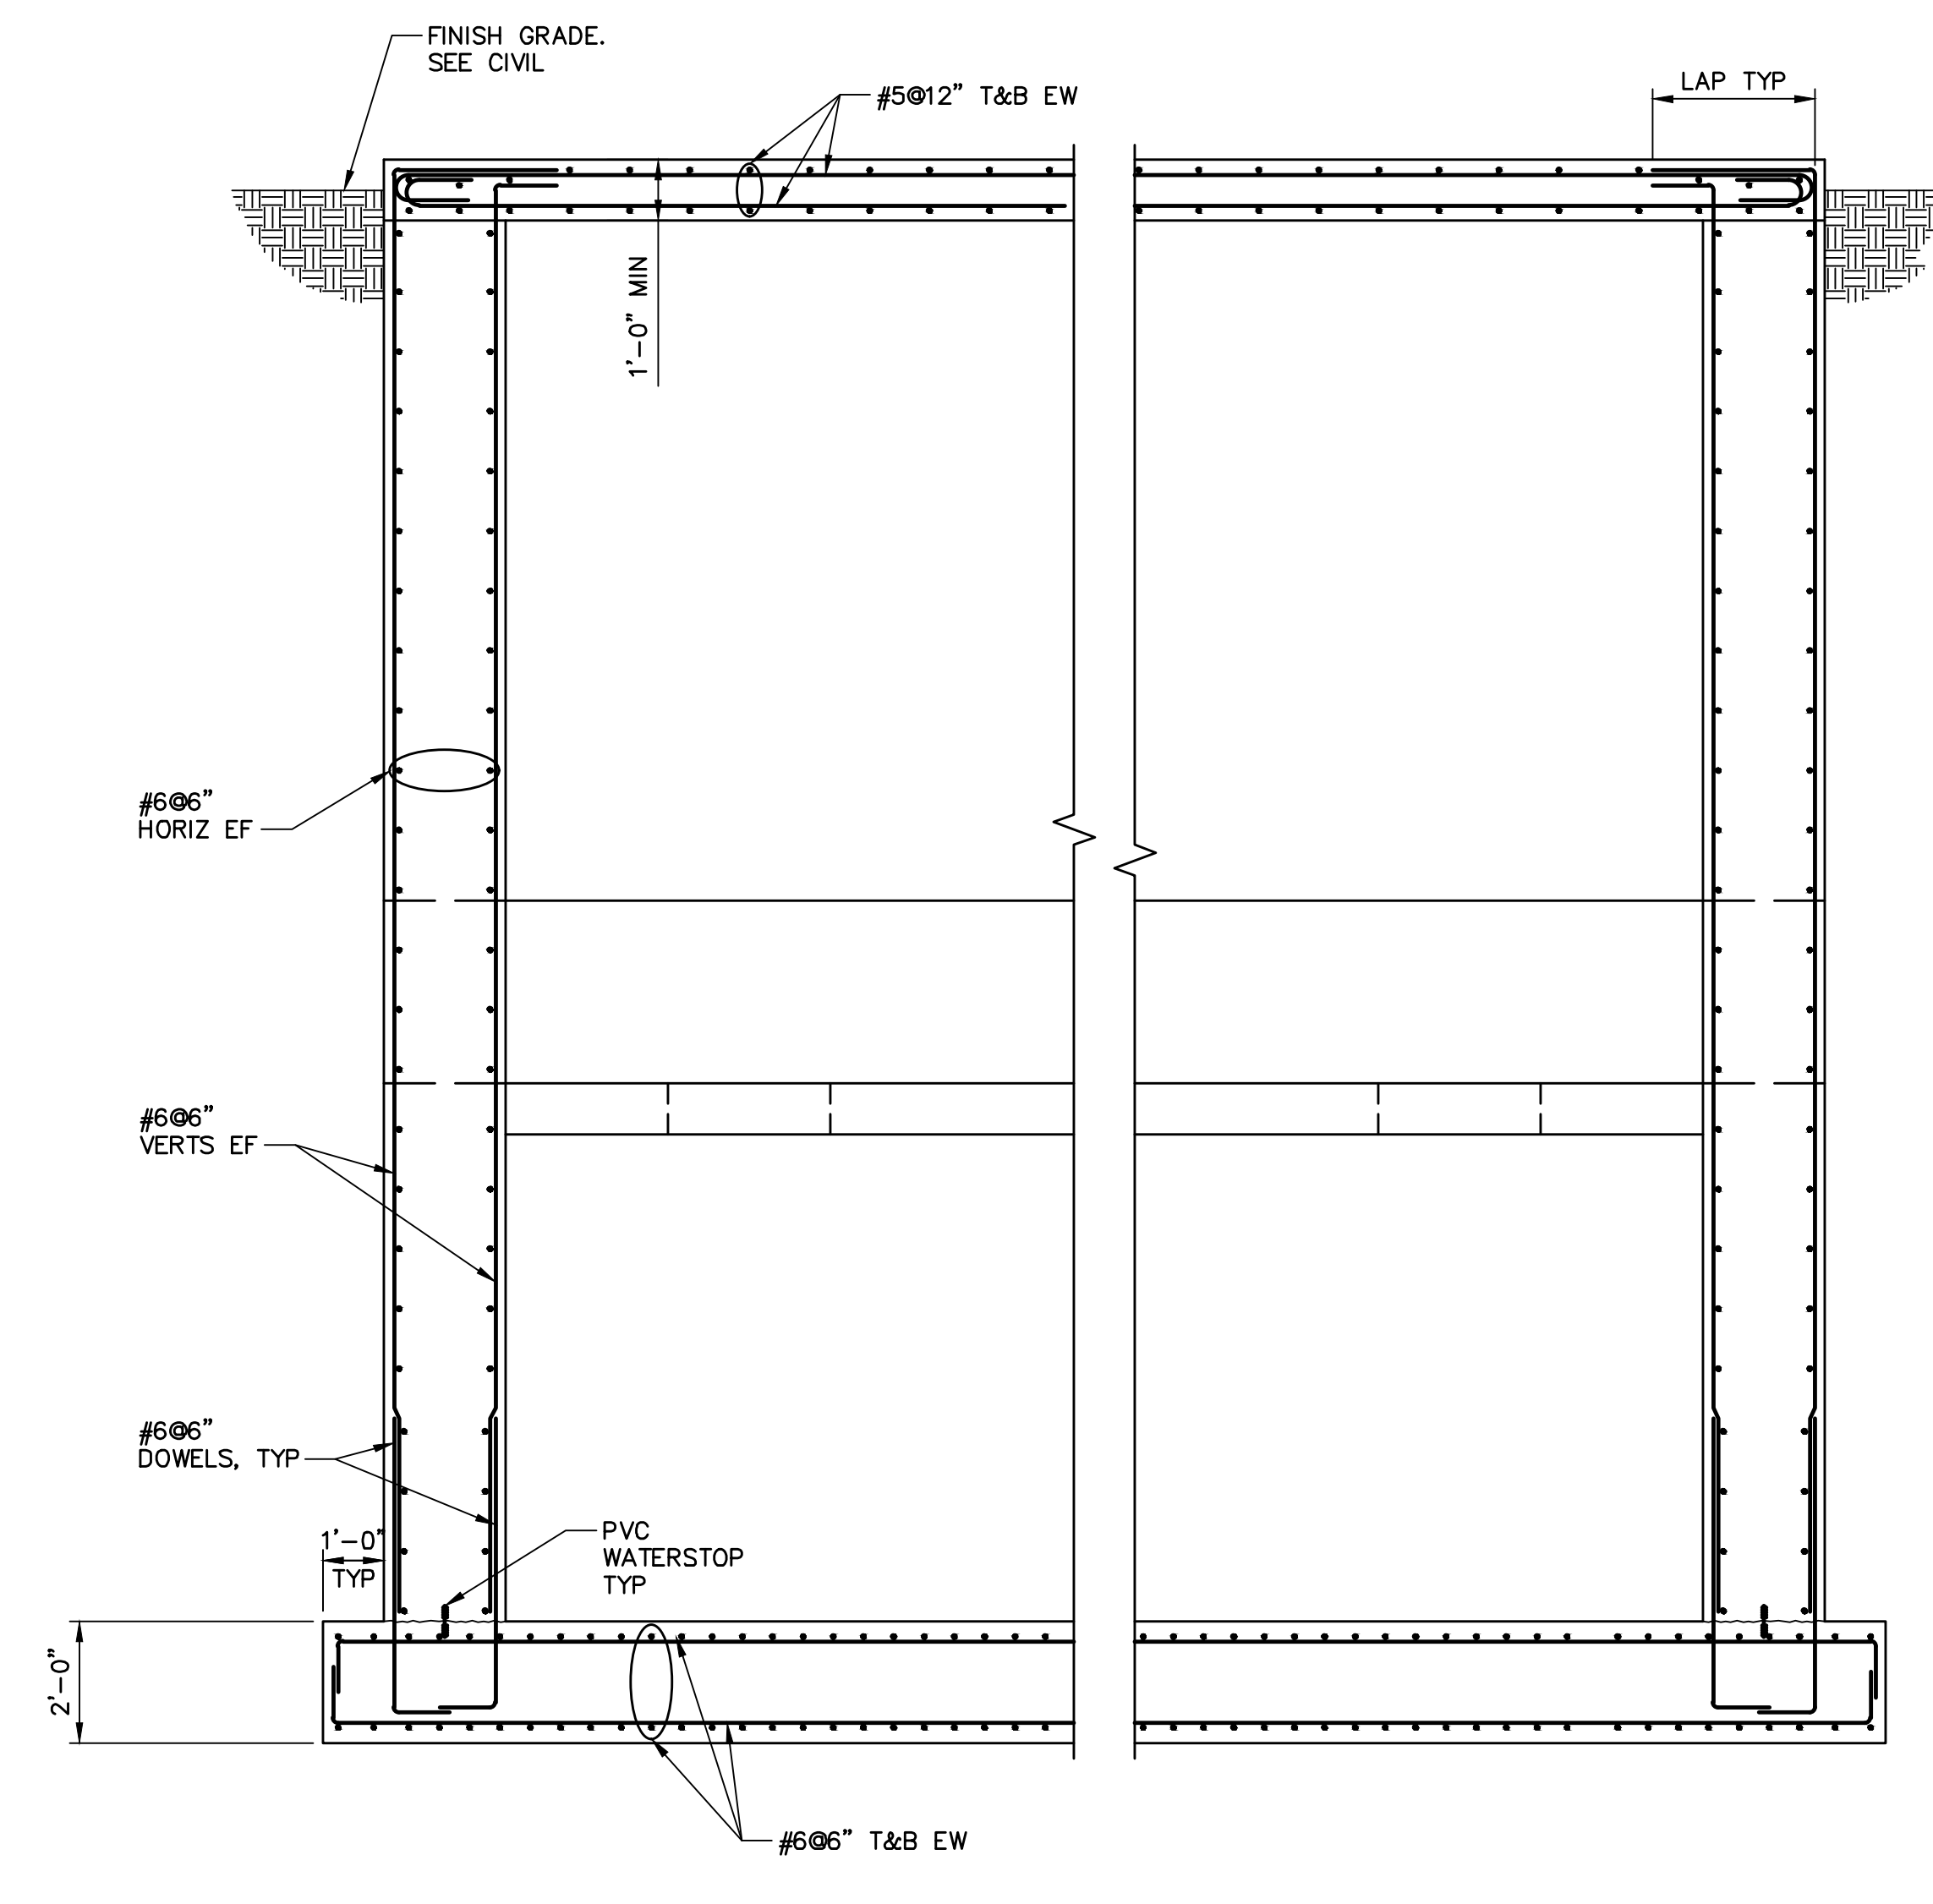


SECTION B  
S-11 S-09  
SCALE = 3/8" = 1'-0"

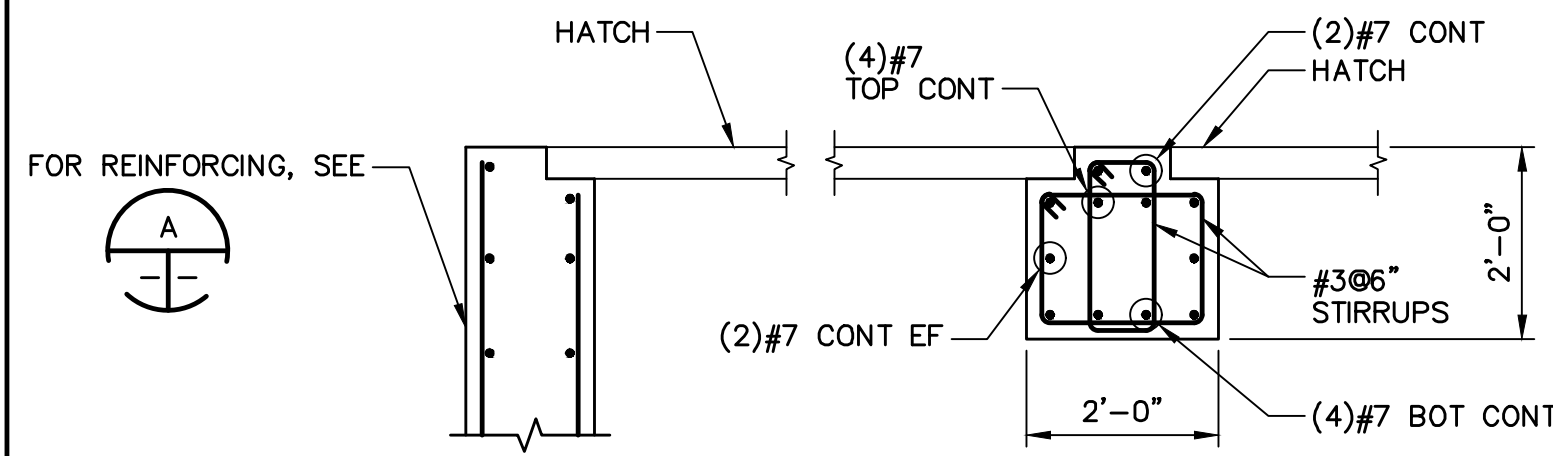

SECTION C  
S-11 S-10  
SCALE = 1/2" = 1'-0"

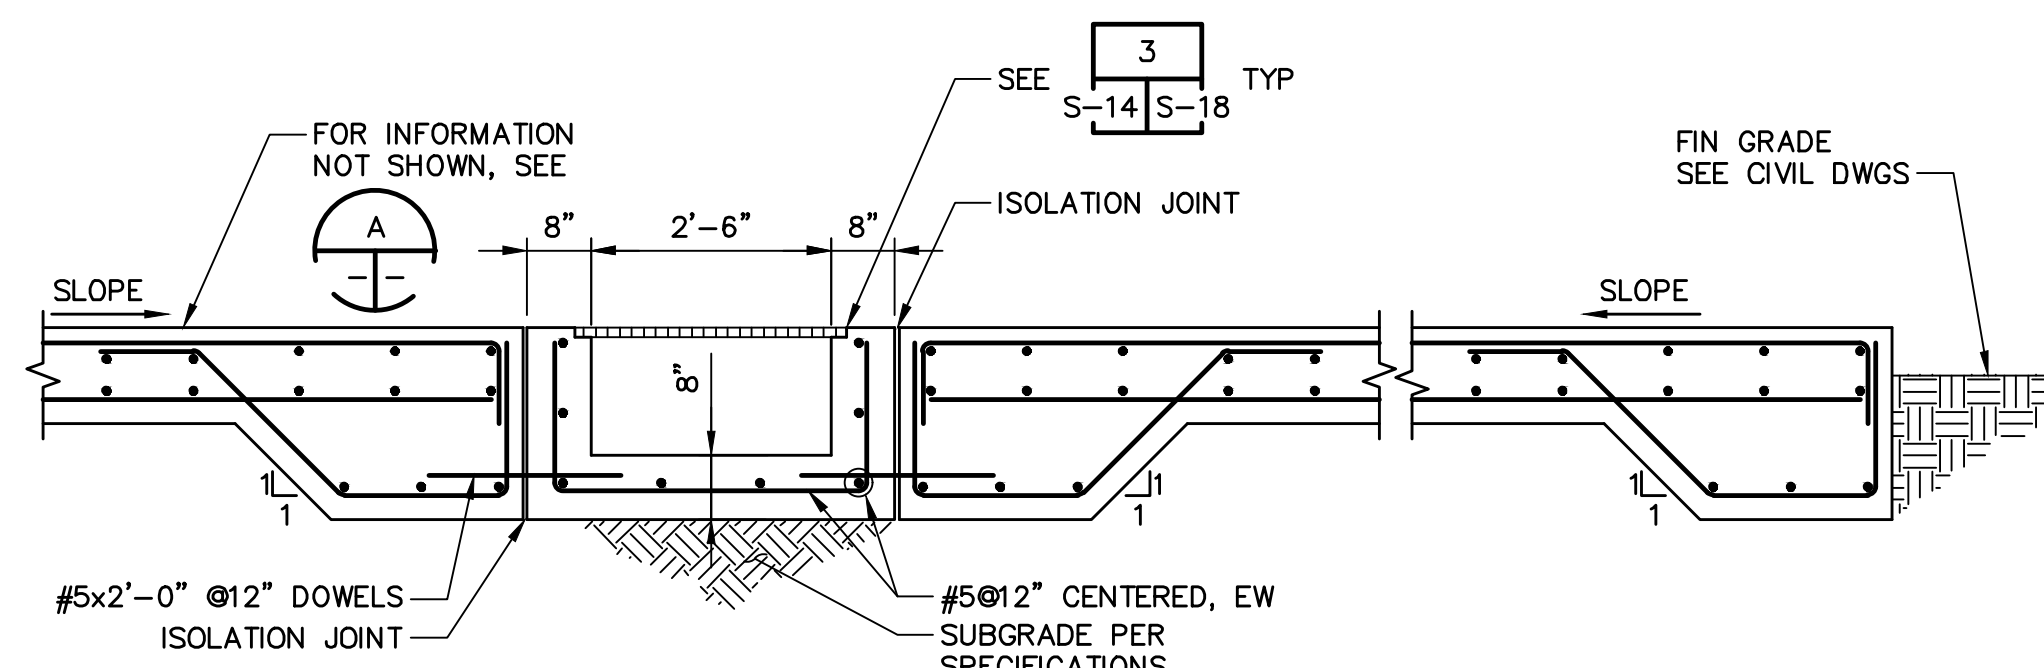


SECTION D  
S-11 S-10  
SCALE = 1/2" = 1'-0"

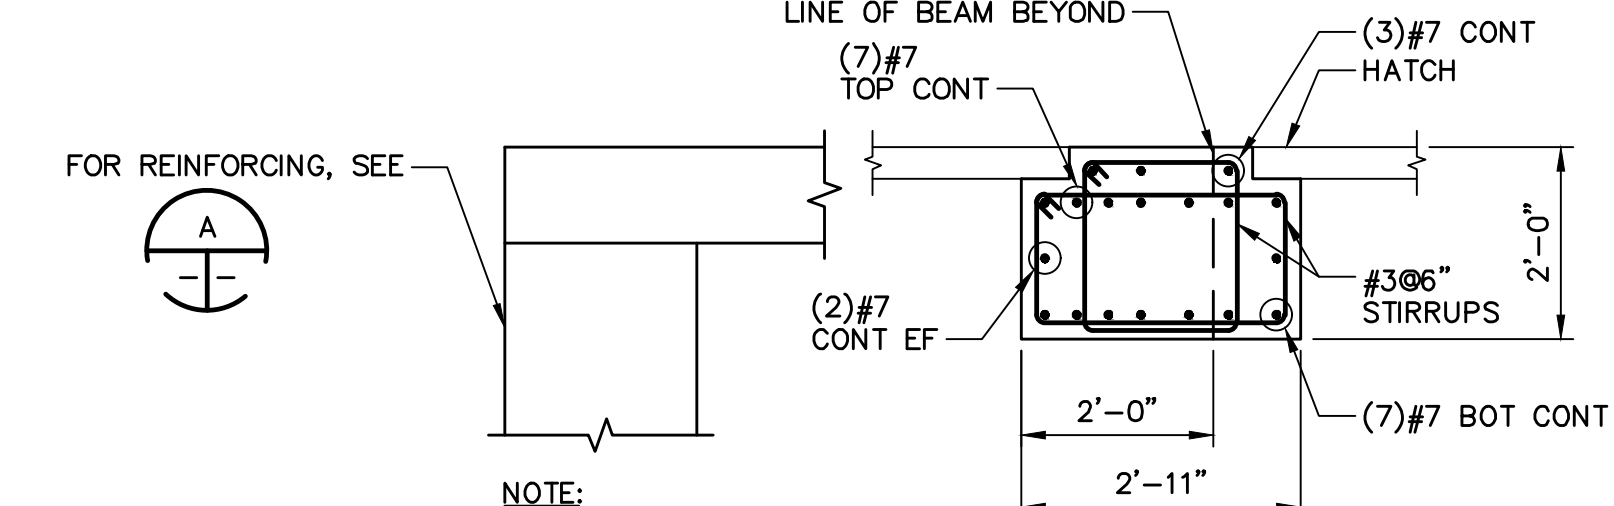


SECTION E  
S-11 S-10  
SCALE = 1/2" = 1'-0"

NOTE:  
1. COORDINATE CONFIGURATION OF BEAM LONGITUDINAL REINFORCEMENT WITH THAT SHOWN IN SECTION A ON THIS SHEET.

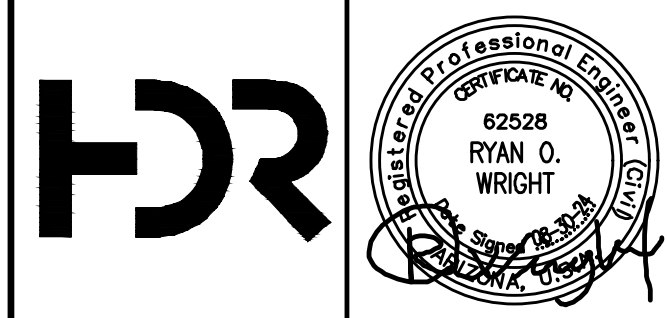

REVISIONS				
NO.	BY	DATE	CHKD	REMARKS
A	RW	01/2024	TH	90% SUBMITTAL
B	RW	04/2024	TH	AGENCY REVIEW
C	RW	08/2024	TH	ISSUED FOR CONSTRUCTION

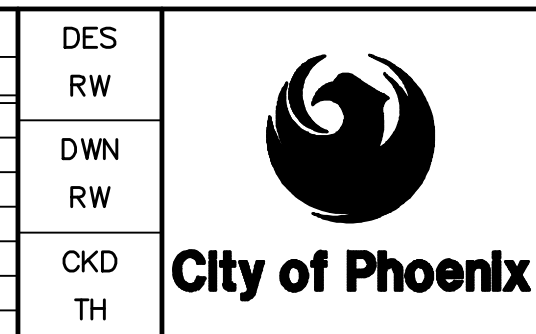

CITY OF PHOENIX  
WATER SERVICES DEPARTMENT  
  
LIFT STATION 40  
REFURBISHMENT

STRUCTURAL  
WET WELL  
SECTIONS AND DETAILS

COPYRIGHT © 2007-JANUARY  
CITY PROJECT NO. WS90400085  
DATE: 08/2024  
S-11 SHEET 67 OF 134  
CAD FILE: CSSL40Q02.dwg




FACILITY DRAWINGS  
This drawing was supplied by a Consultant Engineer from a past contractor. The City of Phoenix is not responsible for the accuracy of the information provided by the Contractor to provide the Record Drawing. The City does not warrant this drawing to be a complete and accurate portrayal of facilities as they exist in the field.

FOR CITY OF PHOENIX USE ONLY -	REFERENCE CID NUMBER: #	DATE	CAD FILE NAME	DWG NUMBER	REMARKS
REVISION ENGINEERING COMPANY	PROJECT NO.				
#					
#					

THIS DRAWING MUST BE FIELD VERIFIED BEFORE USE  
DRAWING NOT TO SCALE UNLESS SCALE BAR IS PRESENT

FOR CONSTRUCTION

"PER CITY OF PHOENIX CODE CHAPTER 2, SECTION 2-28, THESE PLANS ARE FOR OFFICIAL USE ONLY AND MAY NOT BE SHARED WITH OTHERS EXCEPT AS REQUIRED TO FULFILL THE OBLIGATIONS OF THE CONTRACTOR'S CONTRACT WITH THE CITY OF PHOENIX."  
THIS DOCUMENT MUST BE KEPT SECURE AT ALL TIMES.

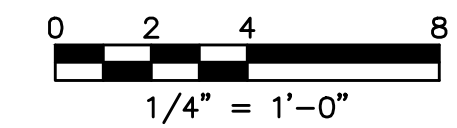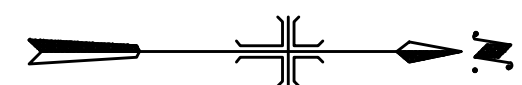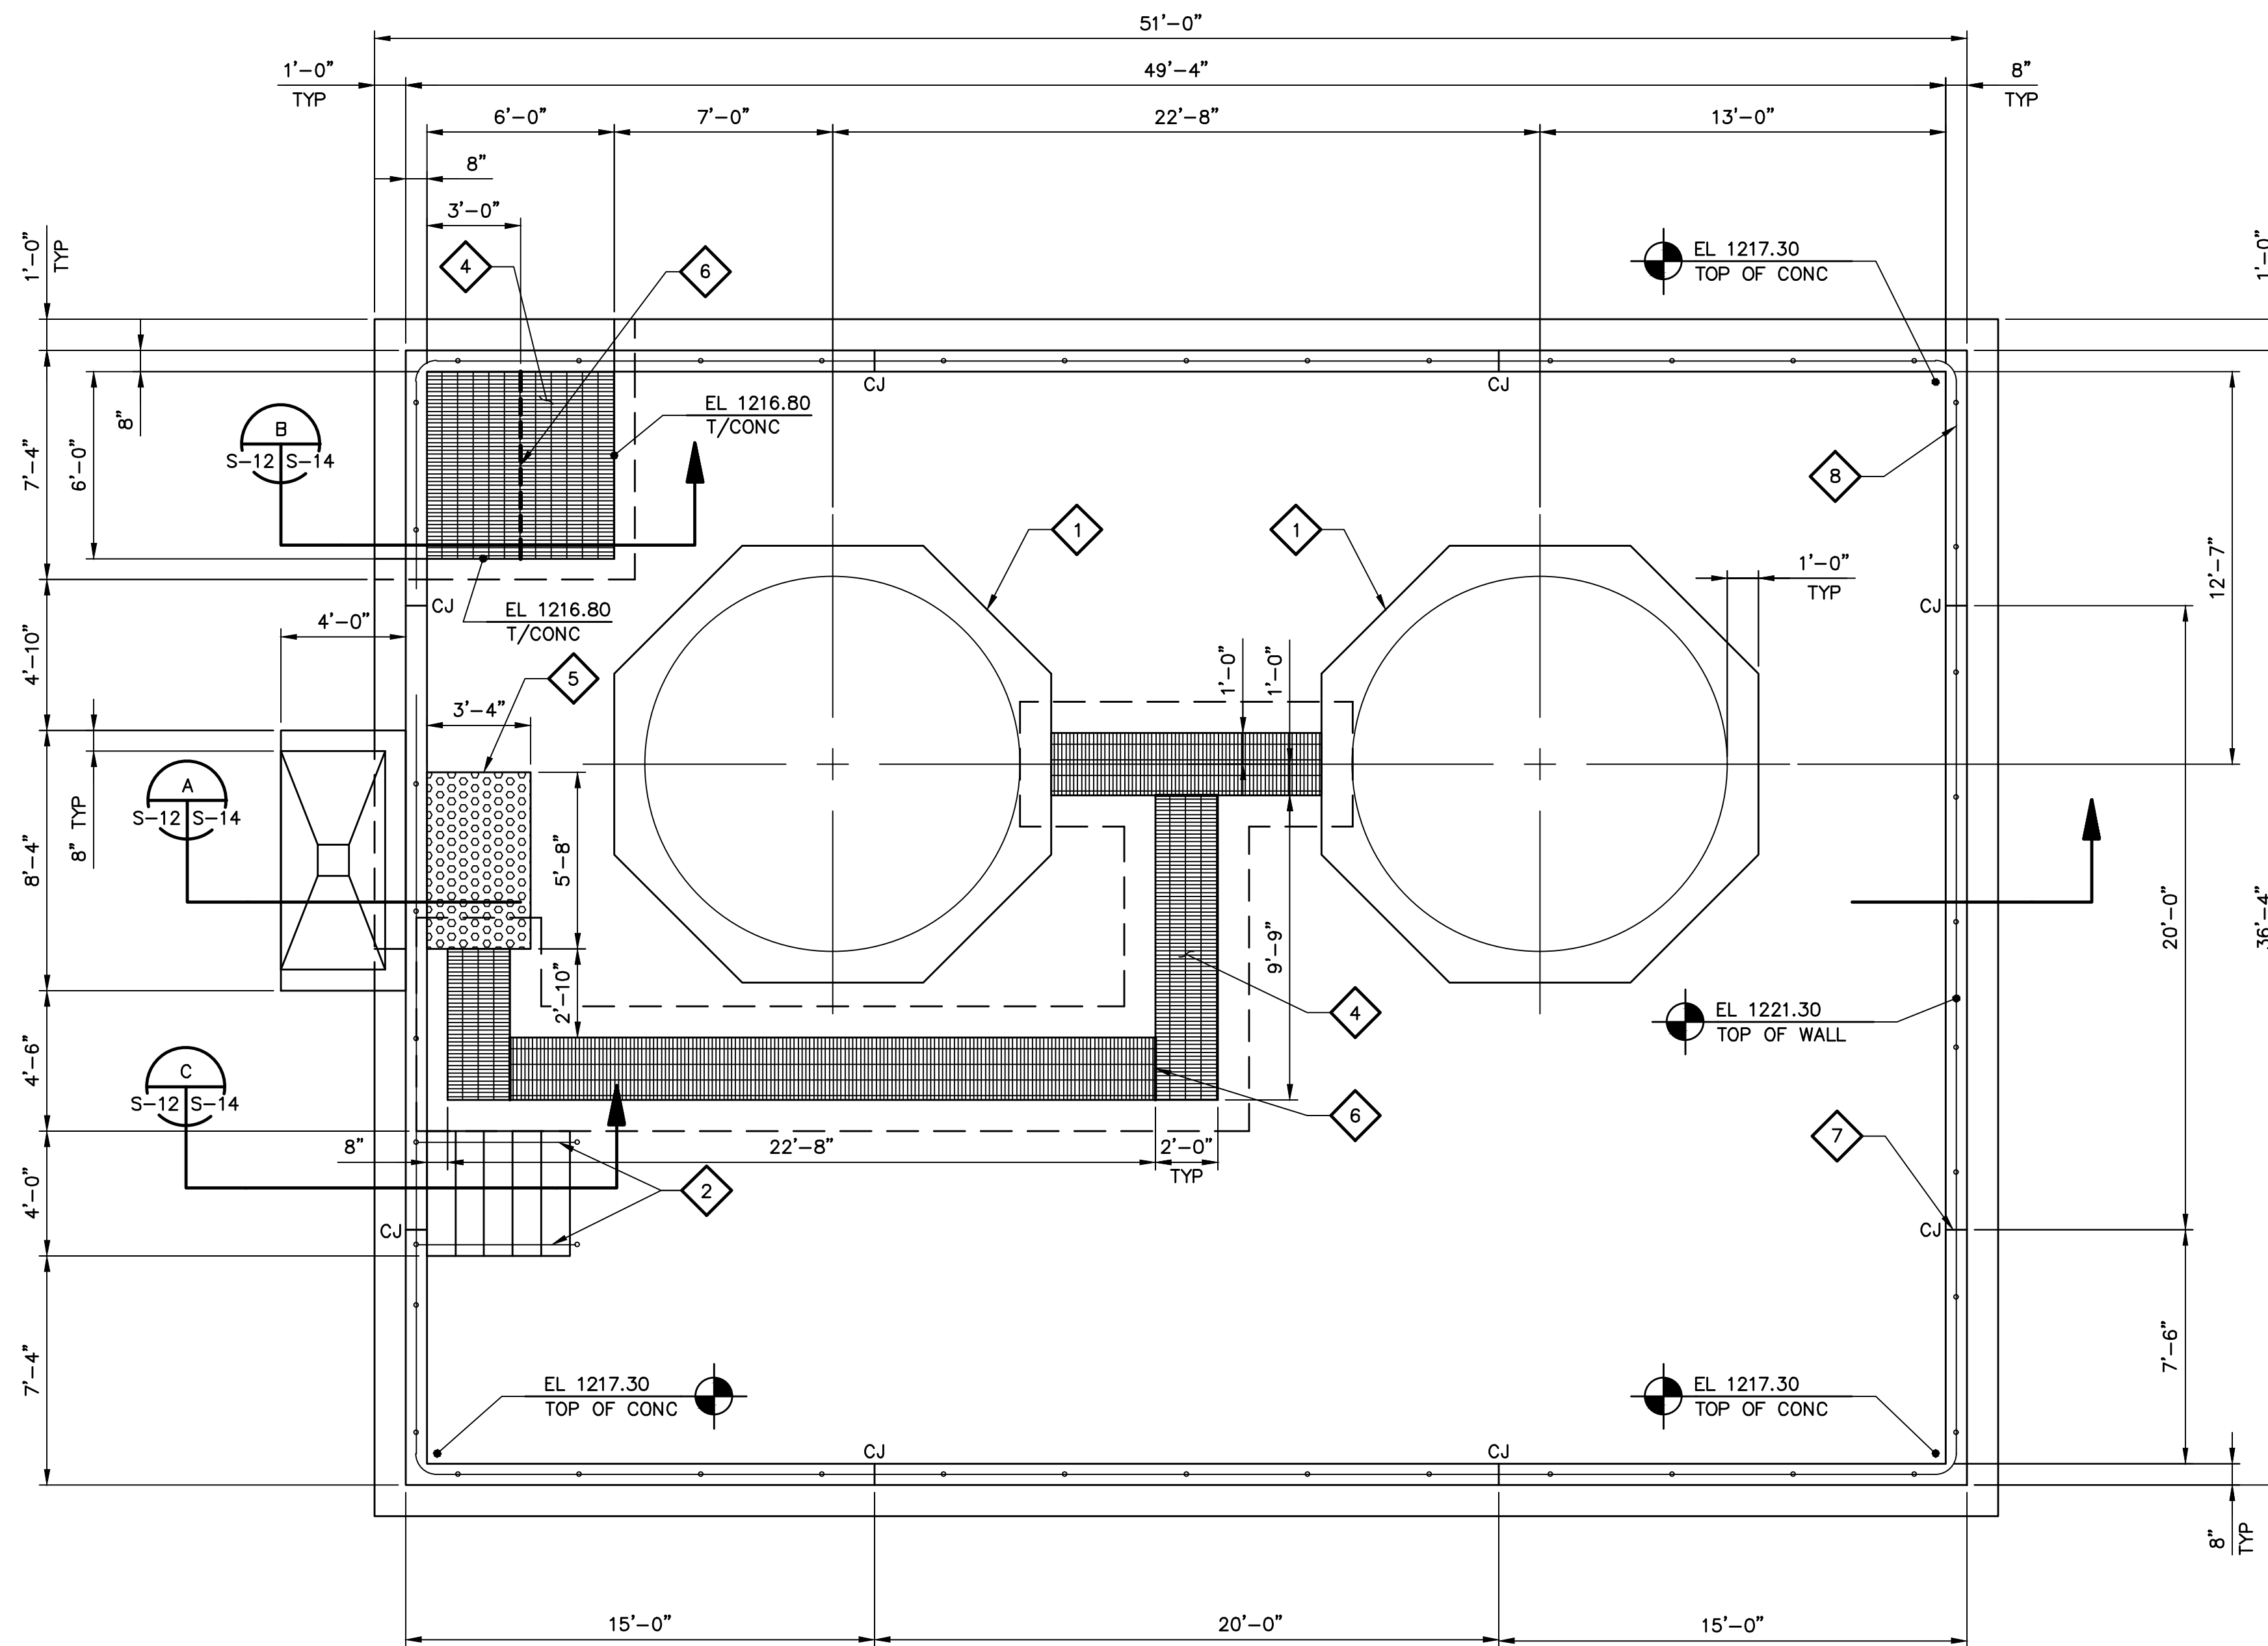

**GENERAL NOTES**

1. STRUCTURAL DESIGN CRITERIA SHALL BE IN ACCORDANCE WITH THE REQUIREMENTS SHOWN ON SHEETS S-01.
2. COORDINATE LOCATION AND SIZE OF EQUIPMENT PADS PRIOR TO CONCRETE PLACEMENT.
3. SEE CIVIL DRAWINGS FOR STRUCTURE LOCATION AND COORDINATE POINTS.
4. SEE PROCESS DRAWINGS FOR PIPING AND PIPE SUPPORT INFORMATION.
5. FOR SLAB REINFORCEMENT, SEE SECTIONS.
6. COORDINATE ANCHOR BOLT LOCATIONS FOR THE EQUIPMENT SUPPLIED. ANCHORAGE DETAIL DRAWINGS AND DESIGN CALCULATIONS SHALL BE SUBMITTED BY THE CONTRACTOR TO THE ENGINEER OF RECORD FOR REVIEW AND APPROVAL PRIOR TO CONSTRUCTION. THE SUBMITTED DRAWINGS AND CALCULATIONS SHALL BE SIGNED AND SEALED BY A PROFESSIONAL ENGINEER REGISTERED IN THE STATE OF ARIZONA.

FACILITY DRAWINGS  
 This drawing was supplied by a Consultant Engineer from a past contractor. The City of Phoenix is not responsible for the accuracy of information provided by the Contractor to provide the Record Drawing. The City does not warrant this drawing to be a complete and accurate portrayal of facilities as they exist in the field.

**KEY NOTES**


- 1. CHEMICAL STORAGE TANK CONCRETE SUPPORT PAD, TYPICAL. SEE GENERAL SHEET NOTE 6. FOR REINFORCEMENT, SEE 6 S-12 S-04
- 2. ALUMINUM HANDRAILS. SEE 1 AND 2 S-12 S-17 S-12 S-17
- 3. NOT USED
- 4. FRP GRATING AND SUPPORTS PER STANDARD DETAIL. SEE SPECIFICATION SECTION 06 74 13 FOR ADDITIONAL INFORMATION.
- 5. FILTER TANK SKID. SEE PROCESS.
- 6. W4x13 SST BEAM TO SUPPORT GRATING. SEE 8 S-12 S-17
- 7. VERTICAL CONSTRUCTION JOINT IN WALL WITH WATERSTOP, TYPICAL. SEE 6 S-09 S-03
- 8. ALUMINUM GUARDRAIL. TYPICAL. SEE 10 S-12 S-17

FOR CITY OF PHOENIX USE ONLY - REFERENCE CID NUMBER: #  
 REVISION ENGINEERING COMPANY PROJECT NO. PROJECT NAME DATE  
 # # # # #



NO.	BY	DATE	CKD	REVISIONS	REMARKS
A	RW	01/2024	TH	90% SUBMITTAL	
B	RW	04/2024	TH	AGENCY REVIEW	
C	RW	08/2024	TH	ISSUED FOR CONSTRUCTION	

DES	DES	DES
RW	RW	RW
DWN	RW	RW
CKD	TH	TH

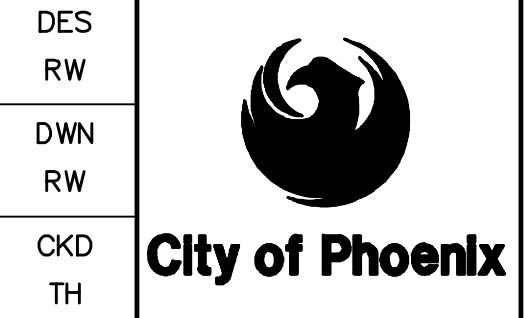

CITY OF PHOENIX  
WATER SERVICES DEPARTMENT  
  
LIFT STATION 40  
REFURBISHMENT

STRUCTURAL  
  
CHEMICAL CONTAINMENT AREA  
FOUNDATION PLAN

COPYRIGHT © 2007-JANUARY  
CITY PROJECT NO. WS90400085  
DATE: 08/2024  
S-12 SHEET 68 OF 134  
CAD FILE: CSSL40P05.dwg

USER: RWRIGHT FILE: C:\pwworking\west01\03411832\CSSL40P05.dwg DATE: 8/28/24 TIME: 05:00pm

THIS DRAWING MUST BE FIELD VERIFIED BEFORE USE  
DRAWING NOT TO SCALE UNLESS SCALE BAR IS PRESENT

**FOR CONSTRUCTION**

"PER CITY OF PHOENIX CODE CHAPTER 2, SECTION 2-28, THESE PLANS ARE FOR OFFICIAL USE ONLY AND MAY NOT BE SHARED WITH OTHERS EXCEPT AS REQUIRED TO FULFILL THE OBLIGATIONS OF THE CONTRACTOR'S CONTRACT WITH THE CITY OF PHOENIX."  
THIS DOCUMENT MUST BE KEPT SECURE AT ALL TIMES.


NOT IN CONTRACT

GENERAL NOTES

FACILITY DRAWINGS  
This drawing was supplied by a Consultant Engineer from a past contractor and is not intended to be used for construction. The information provided by the Contractor to provide the Record Drawing. The City does not warrant this drawing to be a complete and accurate portrayal of facilities as they exist in the field.

KEY NOTES

REVISION #	DATE	PROJECT NAME	CAD FILE NAME	DWG NUMBER	REMARKS

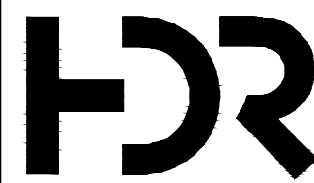

REVISIONS				
NO.	BY	DATE	CKD	REMARKS
A	RW	01/2024	TH	90% SUBMITTAL
B	RW	04/2024	TH	AGENCY REVIEW
C	RW	08/2024	TH	ISSUED FOR CONSTRUCTION

DES  
RW  
DWN  
RW  
CKD  
TH



CITY OF PHOENIX  
WATER SERVICES DEPARTMENT  
  
LIFT STATION 40  
REFURBISHMENT


STRUCTURAL  
  
CHEMICAL CONTAINMENT AREA  
ROOF FRAMING PLAN

COPYRIGHT © 2007--JANUARY  
CITY PROJECT NO. WS90400085  
DATE: 08/2024  
S-13 SHEET 69 OF 134  
CAD FILE: CSSL40P06.dwg


THIS DRAWING MUST BE FIELD VERIFIED BEFORE USE  
DRAWING NOT TO SCALE UNLESS SCALE BAR IS PRESENT

FOR CONSTRUCTION


"PER CITY OF PHOENIX CODE CHAPTER 2, SECTION 2-28, THESE PLANS ARE FOR OFFICIAL USE ONLY AND MAY NOT BE SHARED WITH OTHERS EXCEPT AS REQUIRED TO FULFILL THE OBLIGATIONS OF THE CONTRACTOR'S CONTRACT WITH THE CITY OF PHOENIX." THIS DOCUMENT MUST BE KEPT SECURE AT ALL TIMES.

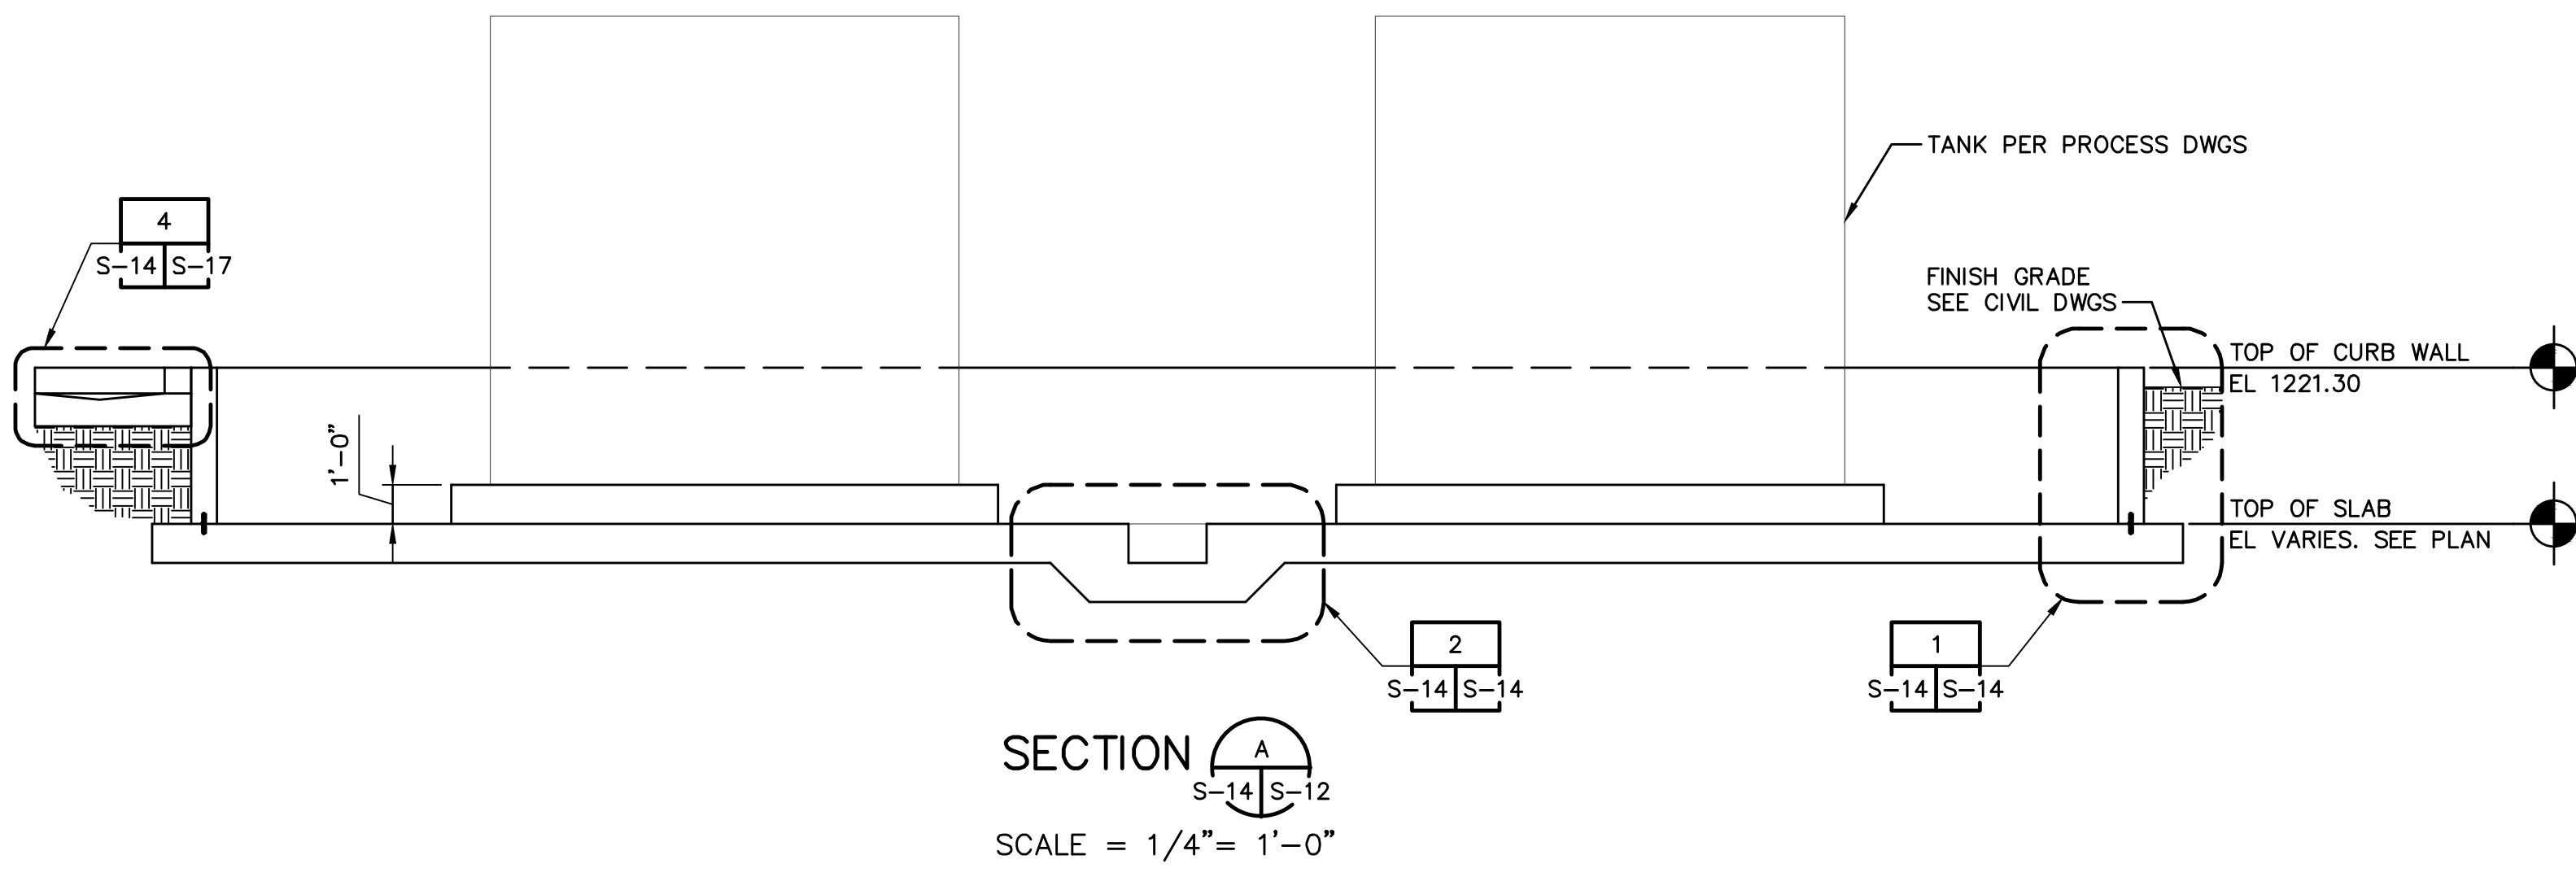


SECTION A  
S-14 S-12  
SCALE = 1/4" = 1'-0"

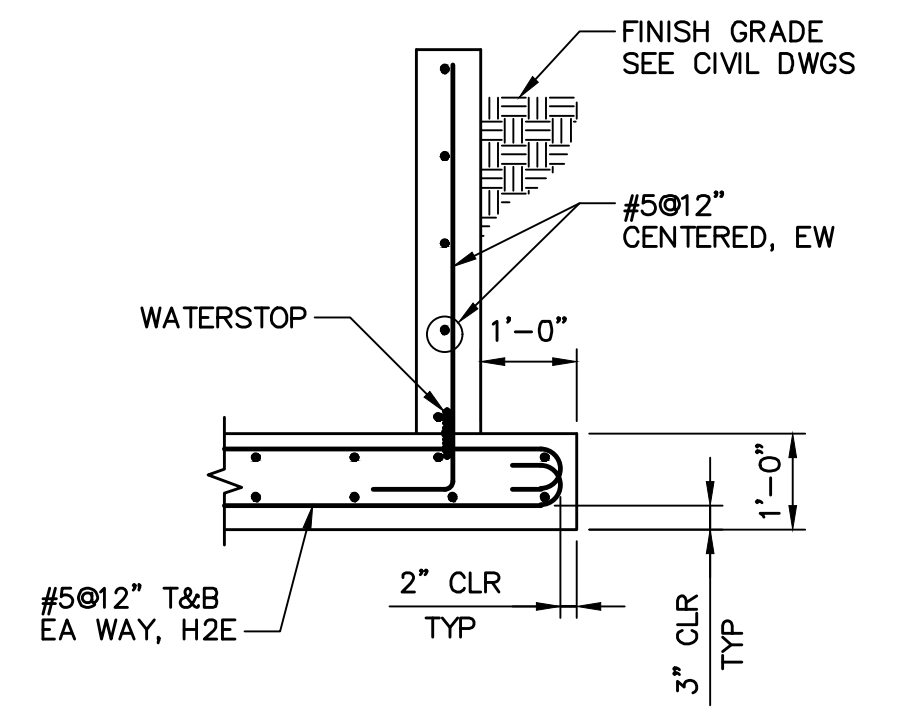


DETAIL 1  
S-14 S-14  
SCALE = 1/2" = 1'-0"

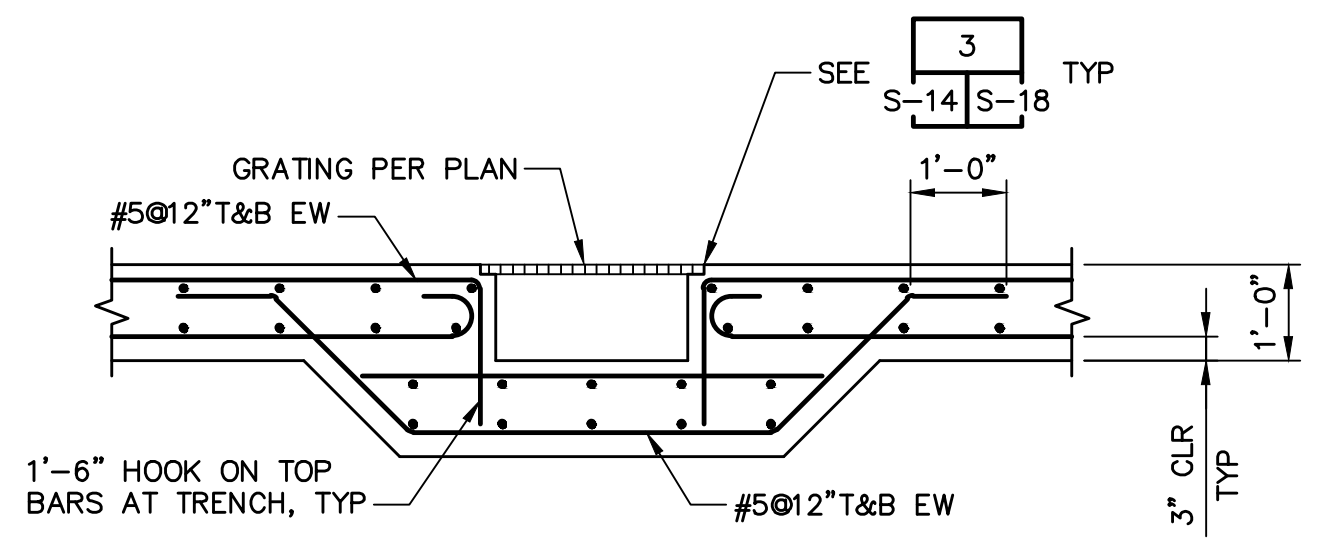

DETAIL 2  
S-14 S-14  
SCALE = 1/2" = 1'-0"

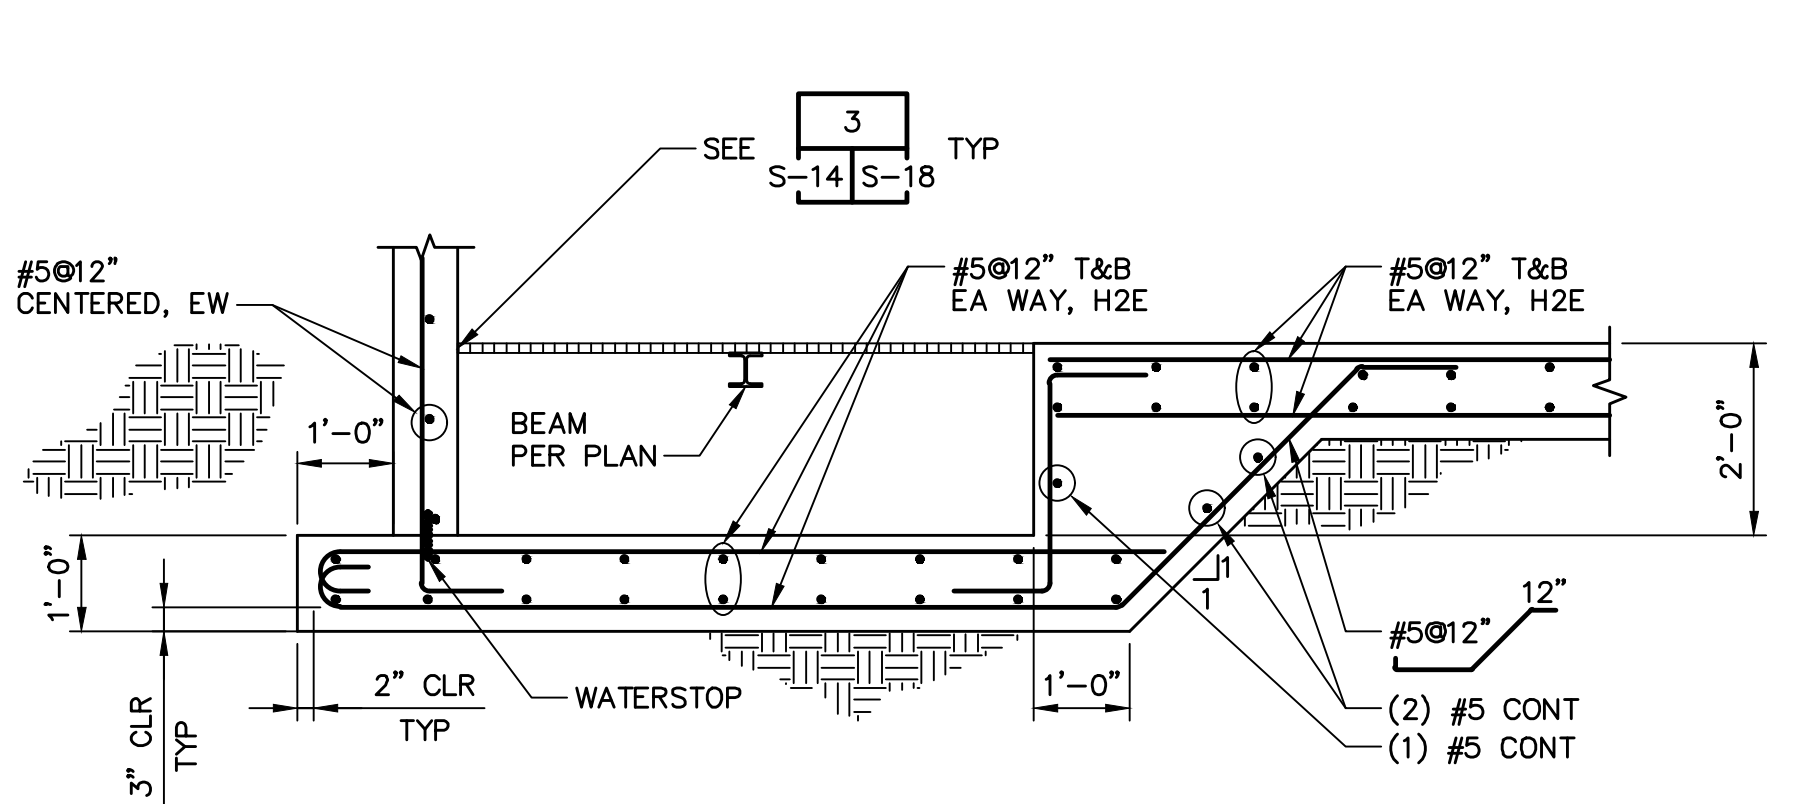

SECTION B  
S-14 S-12  
SCALE = 1/2" = 1'-0"

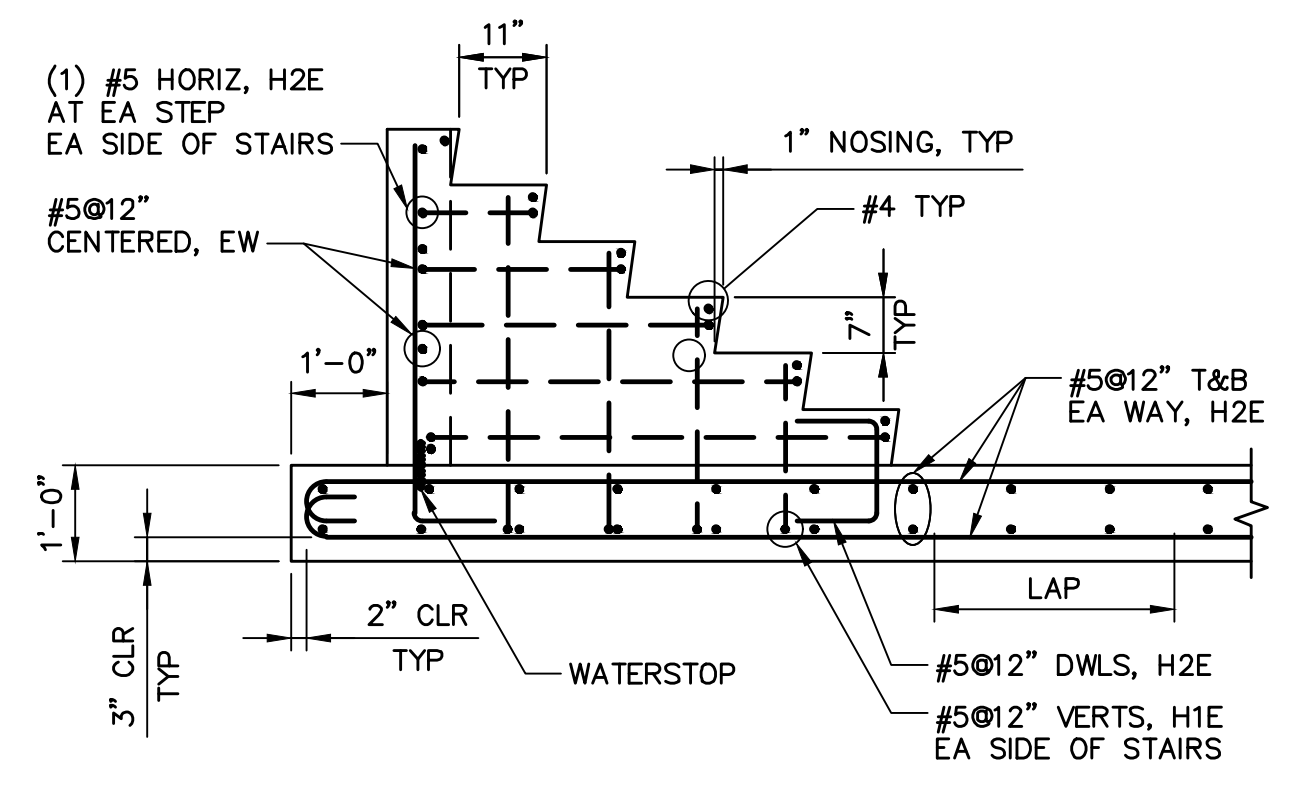


SECTION C  
S-14 S-12  
SCALE = 1/2" = 1'-0"

FACILITY DRAWINGS  
This drawing was supplied by a Consultant Engineer from a past contractor and is provided for information only. The City does not warrant the accuracy of the information provided by the Contractor to provide the Record Drawing. The City does not warrant this drawing to be a complete and accurate portrayal of facilities as they exist in the field.

REVISION	DATE	PROJECT NAME	DWG NUMBER	REMARKS



REVISIONS				
NO.	BY	DATE	CKD	REMARKS
A	RW	01/2024	TH	90% SUBMITTAL
B	RW	04/2024	TH	AGENCY REVIEW
C	RW	08/2024	TH	ISSUED FOR CONSTRUCTION

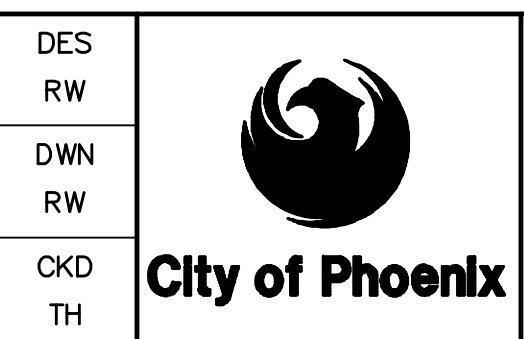

CITY OF PHOENIX  
WATER SERVICES DEPARTMENT  
  
LIFT STATION 40  
REFURBISHMENT

STRUCTURAL  
  
CHEMICAL CONTAINMENT AREA  
SECTIONS AND DETAILS


COPYRIGHT © 2007-JANUARY  
CITY PROJECT NO. WS90400085  
DATE: 08/2024  
S-14 SHEET 70 OF 134  
CAD FILE: CSSL40Q03.dwg

USER: RWRIGHT FILE: C:\pwworking\west01\35411632\CSSL40Q03.dwg DATE: 8/28/24 TIME: 05:07pm

THIS DRAWING MUST BE FIELD VERIFIED BEFORE USE  
DRAWING NOT TO SCALE UNLESS SCALE BAR IS PRESENT

FOR CONSTRUCTION


"PER CITY OF PHOENIX CODE CHAPTER 2-28, THESE PLANS ARE FOR OFFICIAL USE ONLY AND MAY NOT BE SHARED WITH OTHERS EXCEPT AS REQUIRED TO FULFILL THE OBLIGATIONS OF THE CONTRACTOR'S CONTRACT WITH THE CITY OF PHOENIX."  
THIS DOCUMENT MUST BE KEPT SECURE AT ALL TIMES.

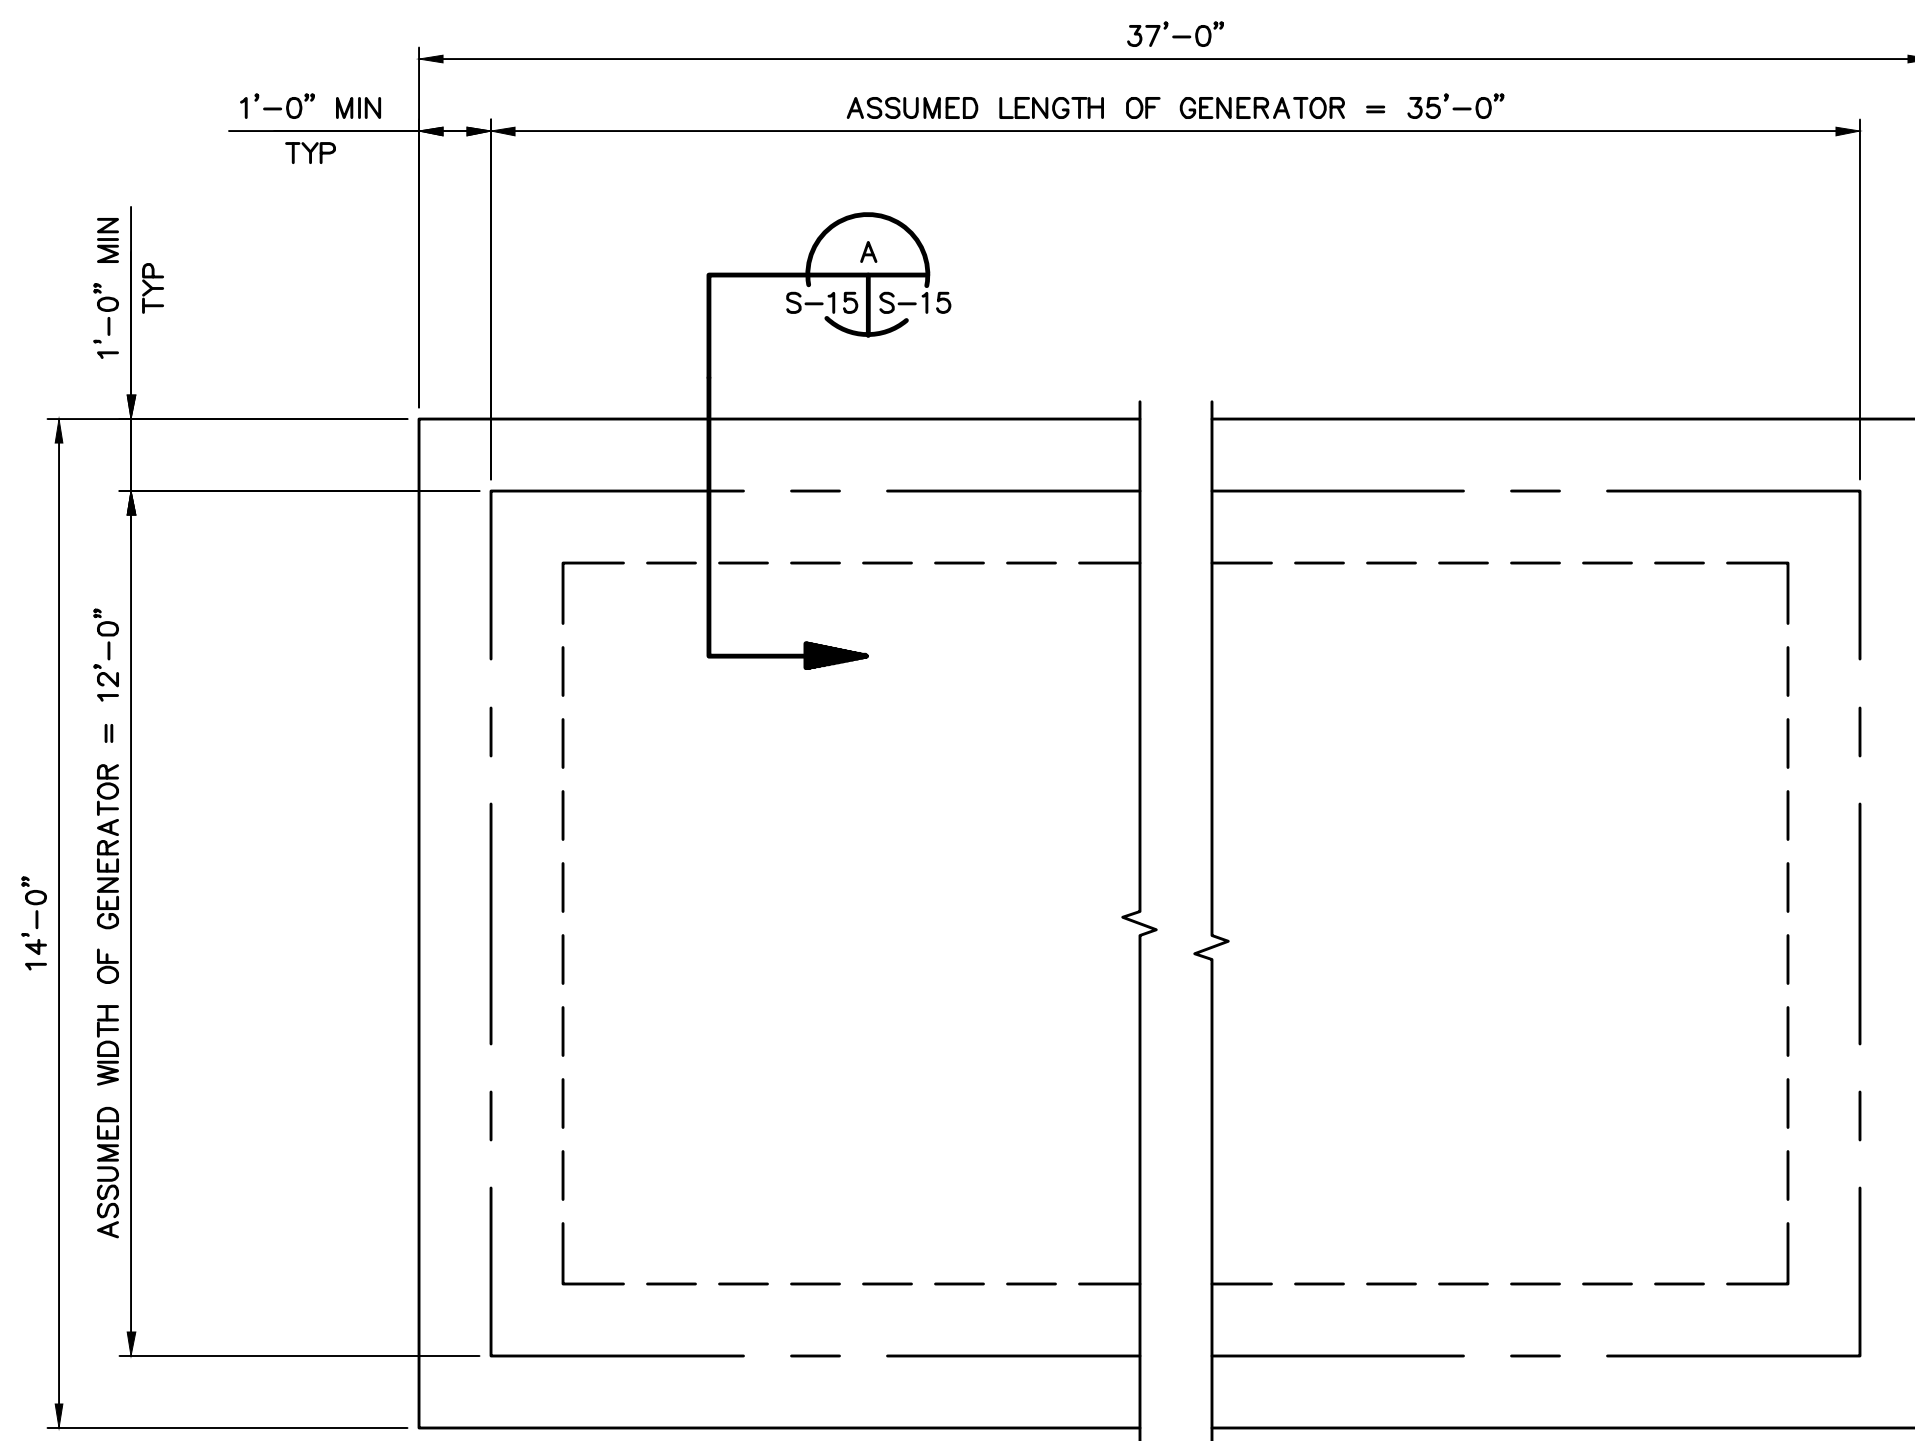


**NOTES:**

1. GENERATOR NOT SHOWN FOR CLARITY. SEE ELECTRICAL DRAWINGS FOR ADDITIONAL INFORMATION.
2. GENERATOR MANUFACTURER TO COORDINATE ANCHOR BOLT LOCATIONS WITH CONTRACTOR PRIOR TO CONSTRUCTION. SEE GENERAL NOTE 5 FOR ADDITIONAL INFORMATION.
3. GENERATOR FOUNDATION PLAN DIMENSIONS SHALL BE VERIFIED AND MODIFIED AS NECESSARY BASED ON ACTUAL GENERATOR SELECTED BY CONTRACTOR. PROVIDE 1'-0" MINIMUM EDGE DISTANCE TO GENERATOR AS SHOWN IN PLAN. SEE GENERAL NOTE 4 FOR ADDITIONAL INFORMATION.
4. PAVING AROUND GENERATOR PAD FOUNDATION NOT SHOWN FOR CLARITY. SEE CIVIL DRAWINGS FOR ADDITIONAL INFORMATION.
5. REFER TO GENERAL STRUCTURAL NOTE G5 ON SHEET S-01 FOR OPENING REQUIREMENTS.


GENERATOR PAD FOUNDATION PLAN 1  
SCALE: 3/8" = 1'-0"

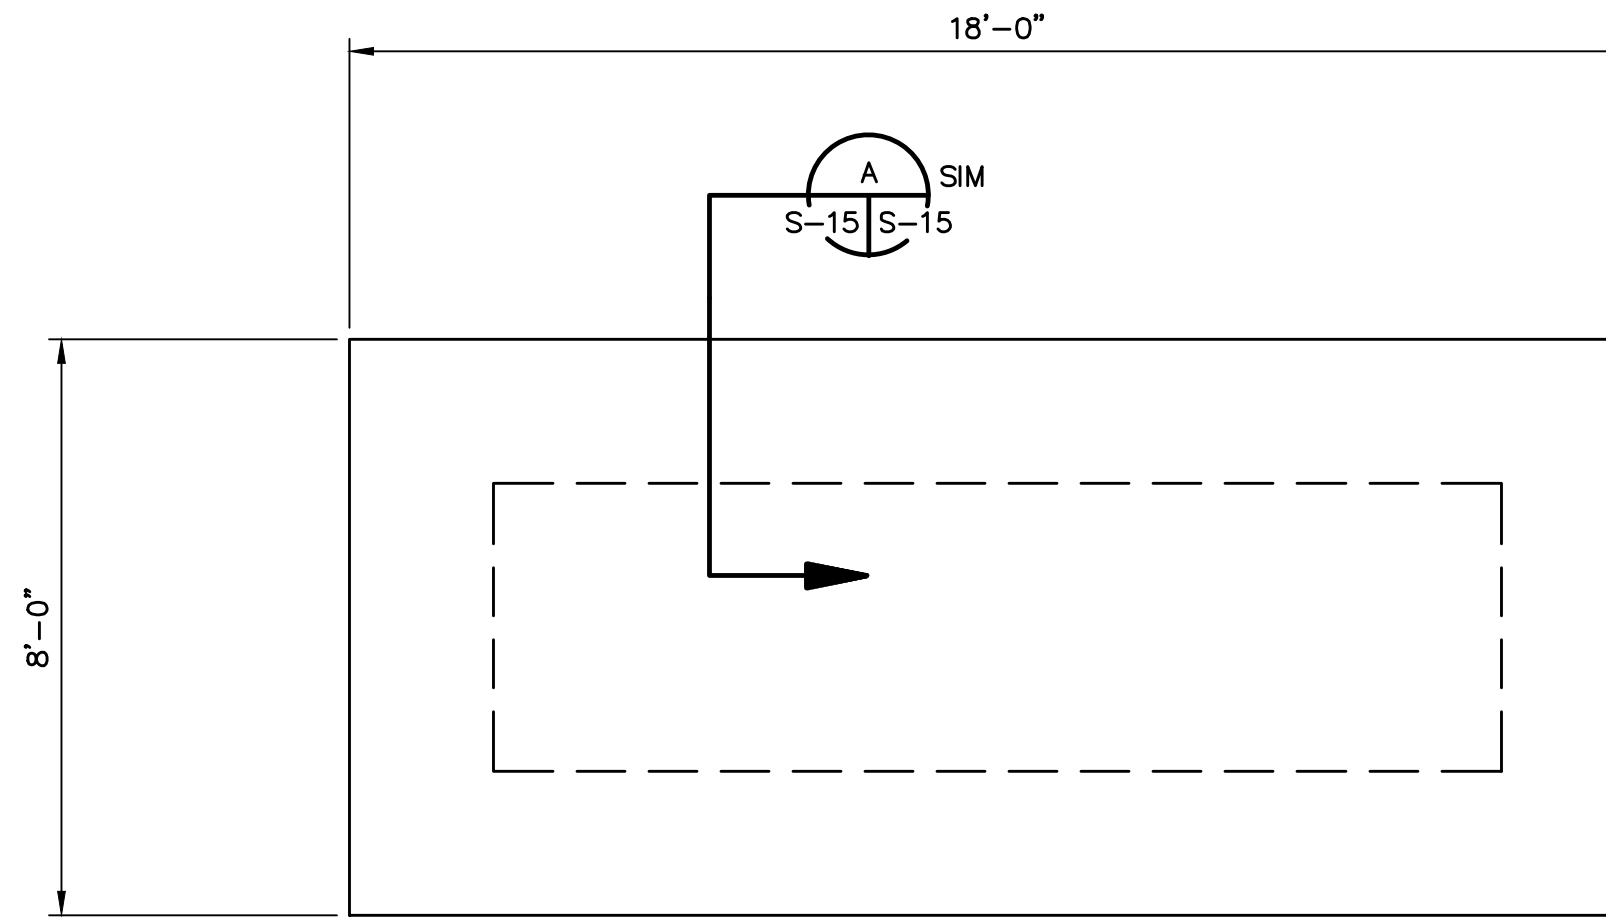

PIG LAUNCHING PAD FOUNDATION PLAN 2  
SCALE: 3/8" = 1'-0"

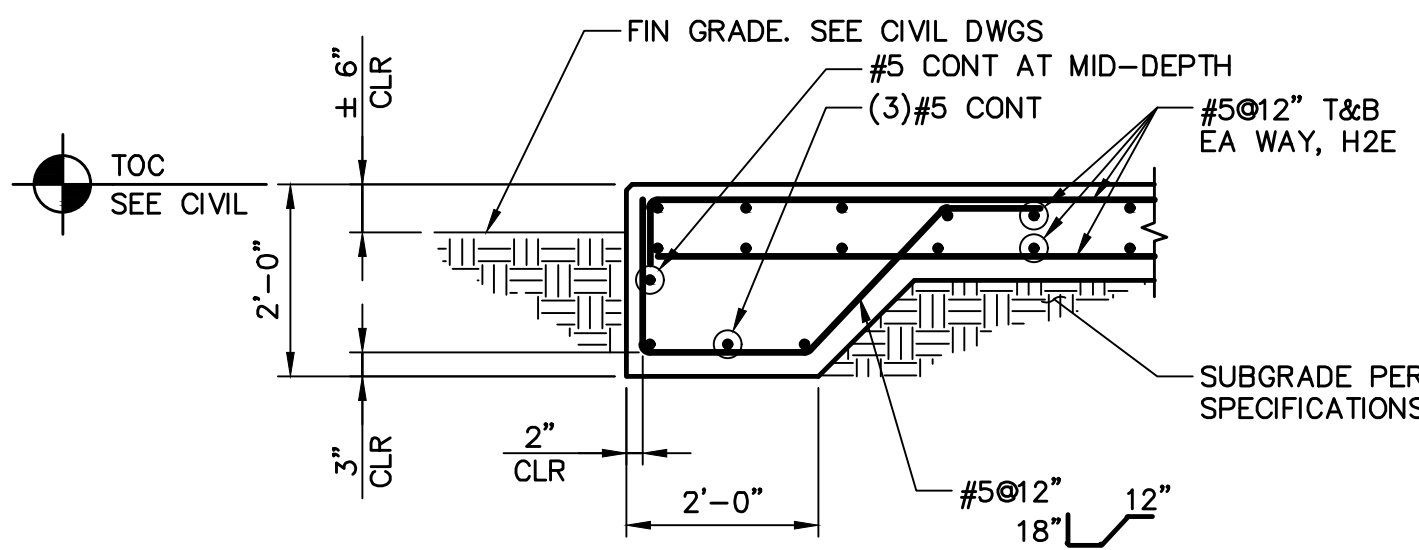

SECTION A  
SCALE = 1/2" = 1'-0"

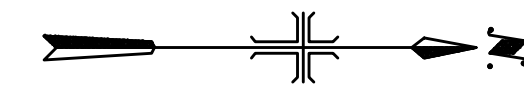


**GENERAL NOTES**

1. STRUCTURAL DESIGN CRITERIA SHALL BE IN ACCORDANCE WITH THE REQUIREMENTS SHOWN ON SHEETS S-01.
2. SEE CIVIL DRAWINGS FOR STRUCTURE LOCATION AND COORDINATE POINTS.
3. DIMENSIONS SHOWN ARE BASED ON ASSUMED EQUIPMENT SIZES, WEIGHTS, AND ANCHORAGES. CONTRACTOR TO SUBMIT FOR REVIEW ALL EQUIPMENT SIZES, OPERATING WEIGHTS, VIBRATION FORCES, SUPPORT LOCATIONS, ANCHORAGE REQUIREMENTS, ALONG WITH ANY FOUNDATION OPENINGS, NOTCHES AND RECESSES REQUIRED BY THE SUBMITTED EQUIPMENT. FOUNDATION DIMENSIONS AND DESIGN ARE SUBJECT TO CHANGE BASED ON THE ACTUAL SIZE OF THE SUBMITTED EQUIPMENT.
4. COORDINATE ANCHOR BOLT LOCATIONS FOR THE EQUIPMENT SUPPLIED. ANCHORAGE DETAIL DRAWINGS AND DESIGN CALCULATIONS SHALL BE SUBMITTED BY THE CONTRACTOR TO THE ENGINEER OF RECORD FOR REVIEW AND APPROVAL PRIOR TO CONSTRUCTION. THE SUBMITTED DRAWINGS AND CALCULATIONS SHALL BE SIGNED AND SEALED BY A PROFESSIONAL ENGINEER REGISTERED IN THE STATE OF ARIZONA.


FACILITY DRAWINGS  
This drawing was supplied by a Consultant Engineer from a past contract. The City does not warrant the accuracy of the information provided by the Contractor to provide the Record Drawing. The City does not warrant this drawing to be a complete and accurate portrayal of facilities as they exist in the field.

REVISION	NO.	DATE	PROJECT NO.	PROJECT NAME	DATE	CAD FILE NAME	DWG NUMBER	REMARKS
#								

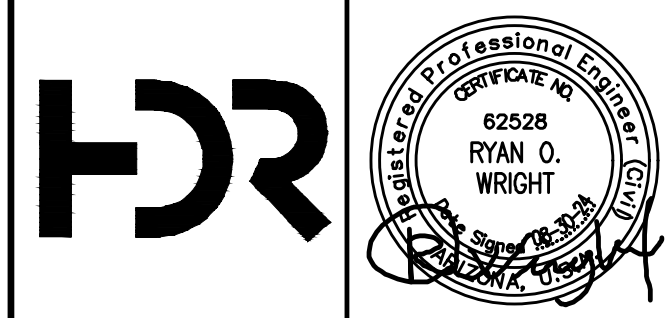

NO.	BY	DATE	CKD	REVISIONS	REMARKS
A	RW	01/2024	TH	90% SUBMITTAL	
B	RW	04/2024	TH	AGENCY REVIEW	
C	RW	08/2024	TH	ISSUED FOR CONSTRUCTION	

DES	NO.	BY	DATE	CKD	REVISIONS	REMARKS
RW						
DWN						
RW						
CKD						
TH						

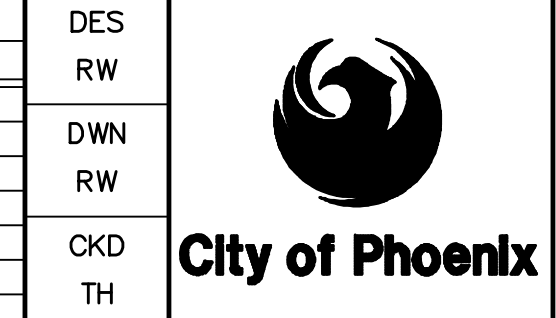

CITY OF PHOENIX  
WATER SERVICES DEPARTMENT  
  
LIFT STATION 40  
REFURBISHMENT


STRUCTURAL  
  
GENERATOR & PIG LAUNCHING PAD FOUNDATION  
PLANS AND SECTION

COPYRIGHT © 2007-JANUARY  
CITY PROJECT NO. WS90400085  
DATE: 08/2024  
S-15 SHEET 71 OF 134  
CAD FILE: CSSL40P07.dwg

THIS DRAWING MUST BE FIELD VERIFIED BEFORE USE  
DRAWING NOT TO SCALE UNLESS SCALE BAR IS PRESENT


FOR CONSTRUCTION

\*PER CITY OF PHOENIX CODE CHAPTER 2-28, THESE PLANS ARE FOR OFFICIAL USE ONLY AND MAY NOT BE SHARED WITH OTHERS EXCEPT AS REQUIRED TO FULFILL THE OBLIGATIONS OF THE CONTRACTOR'S CONTRACT WITH THE CITY OF PHOENIX. THIS DOCUMENT MUST BE KEPT SECURE AT ALL TIMES.

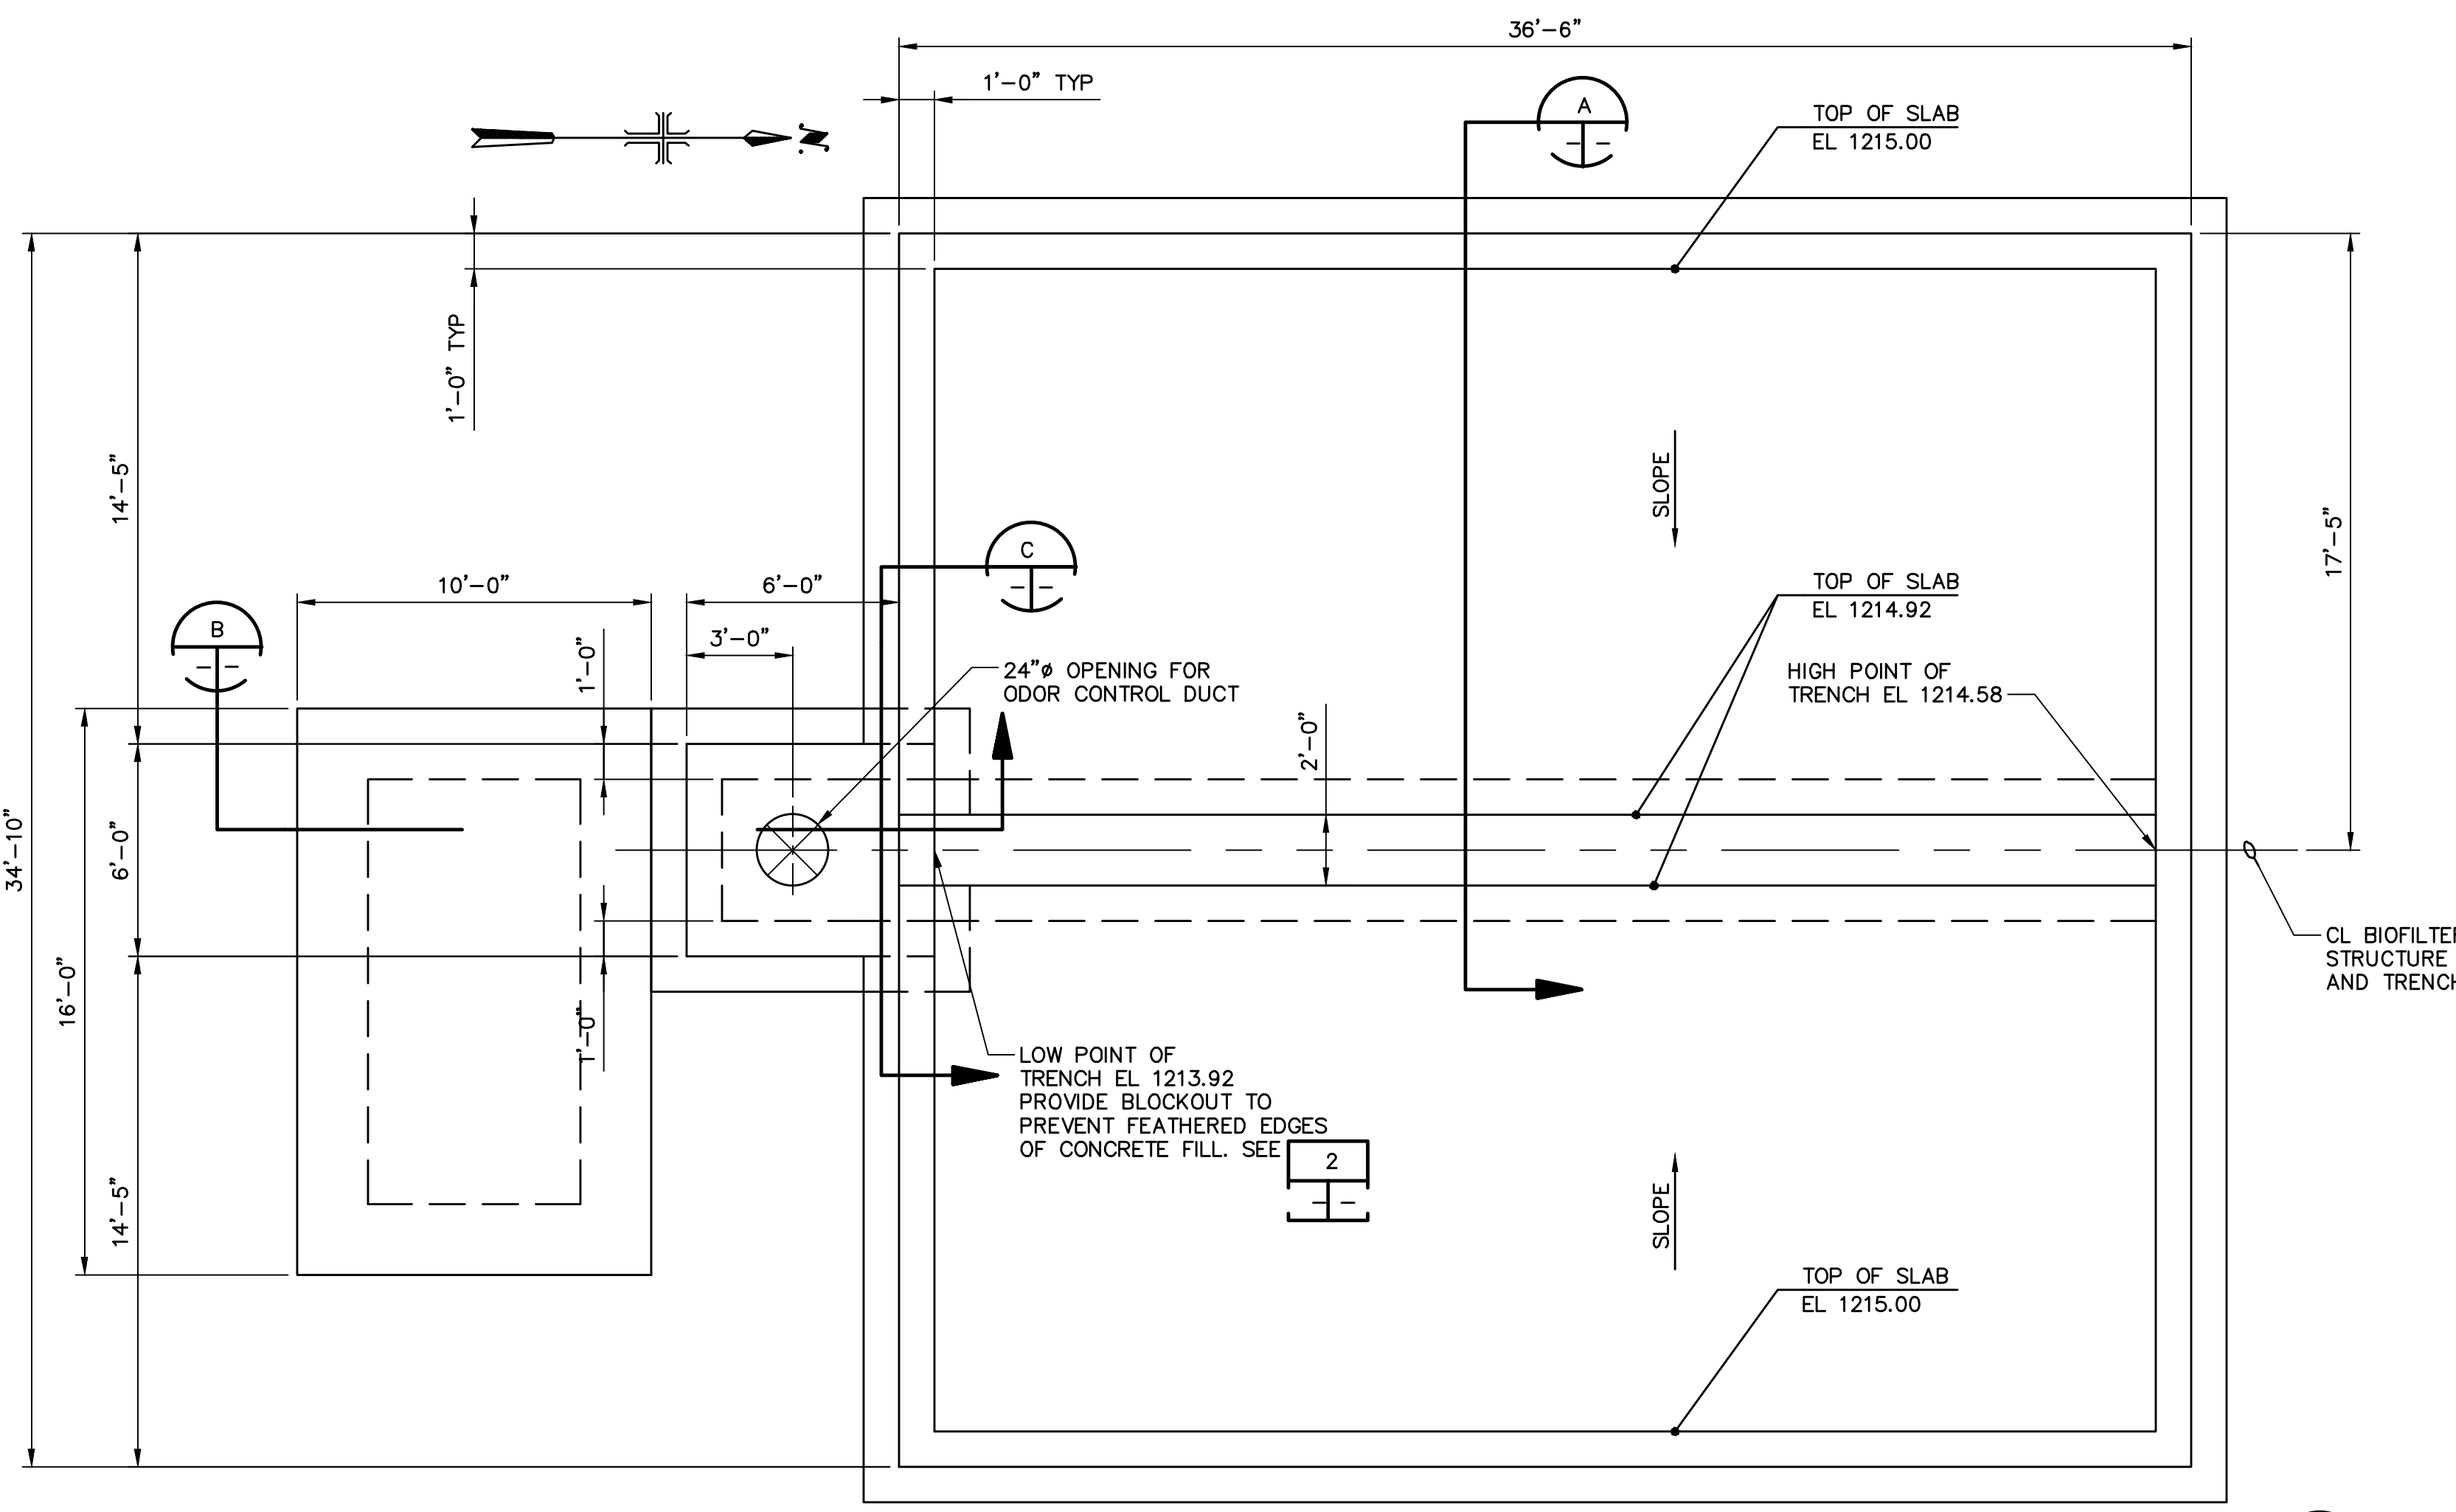


BIOFILTER FOUNDATION PLAN

SCALE: 1/4" = 1'-0"

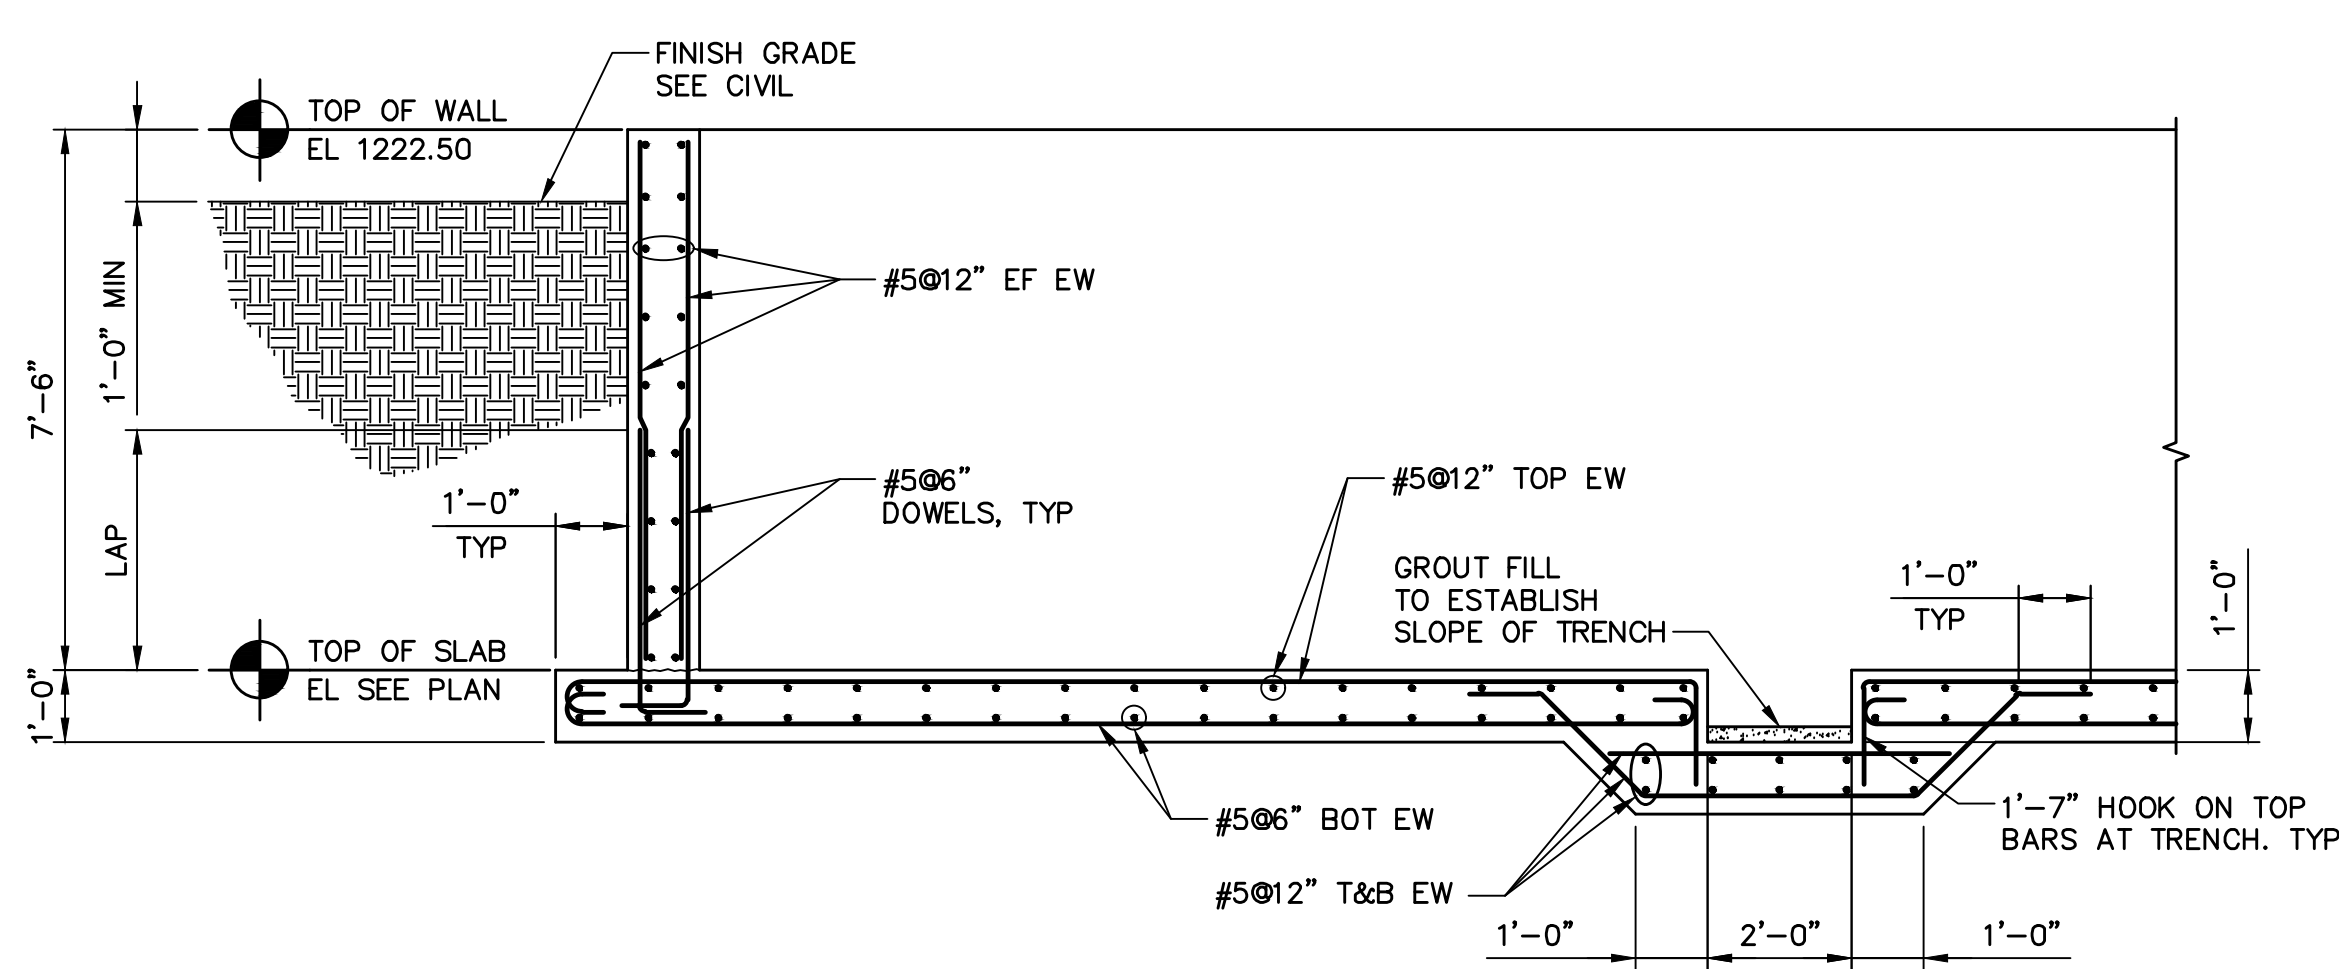


SECTION A

SCALE = 3/8" = 1'-0"

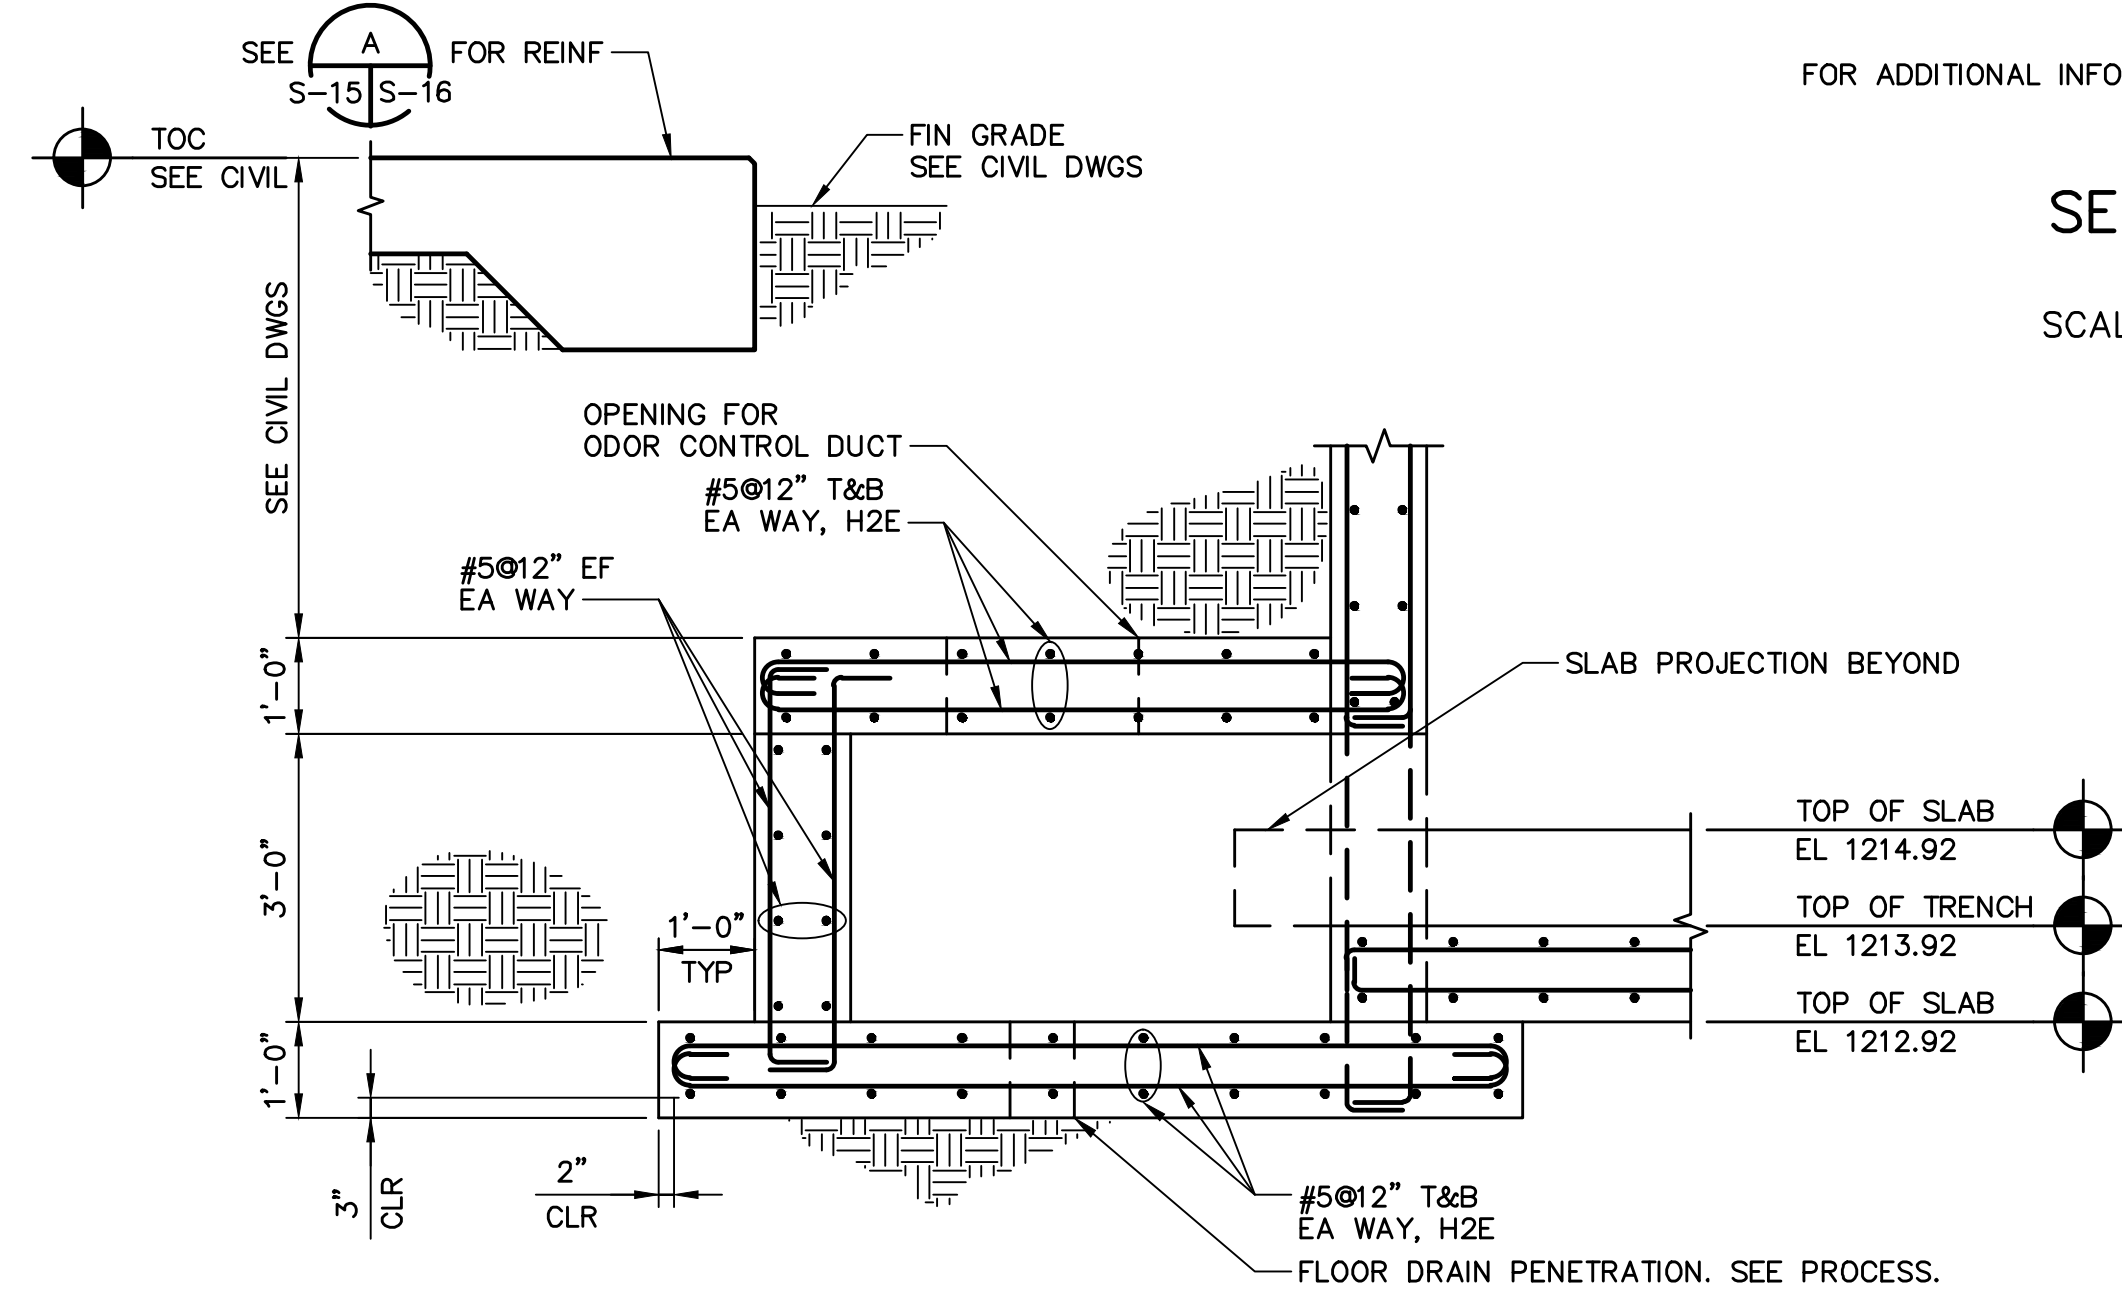


SECTION B

SCALE = 1/2" = 1'-0"

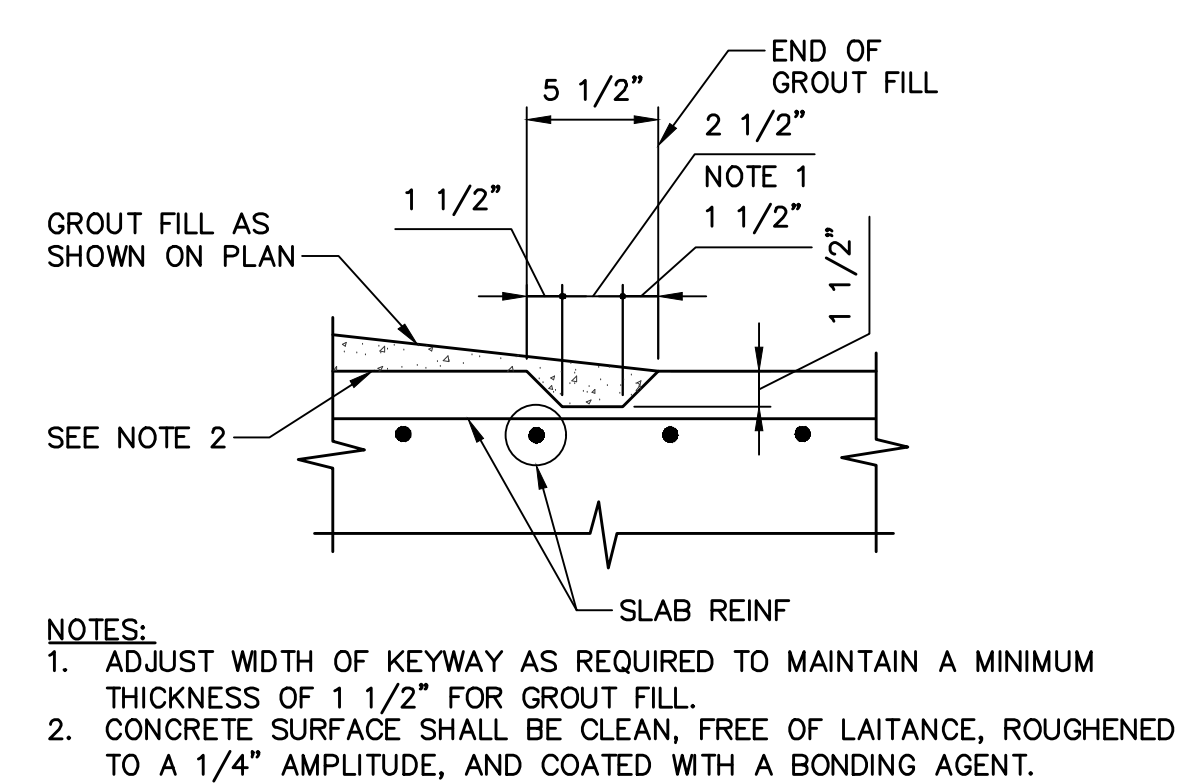

KEYWAY FOR GROUT FILL

SCALE: 1 1/2" = 1'-0"

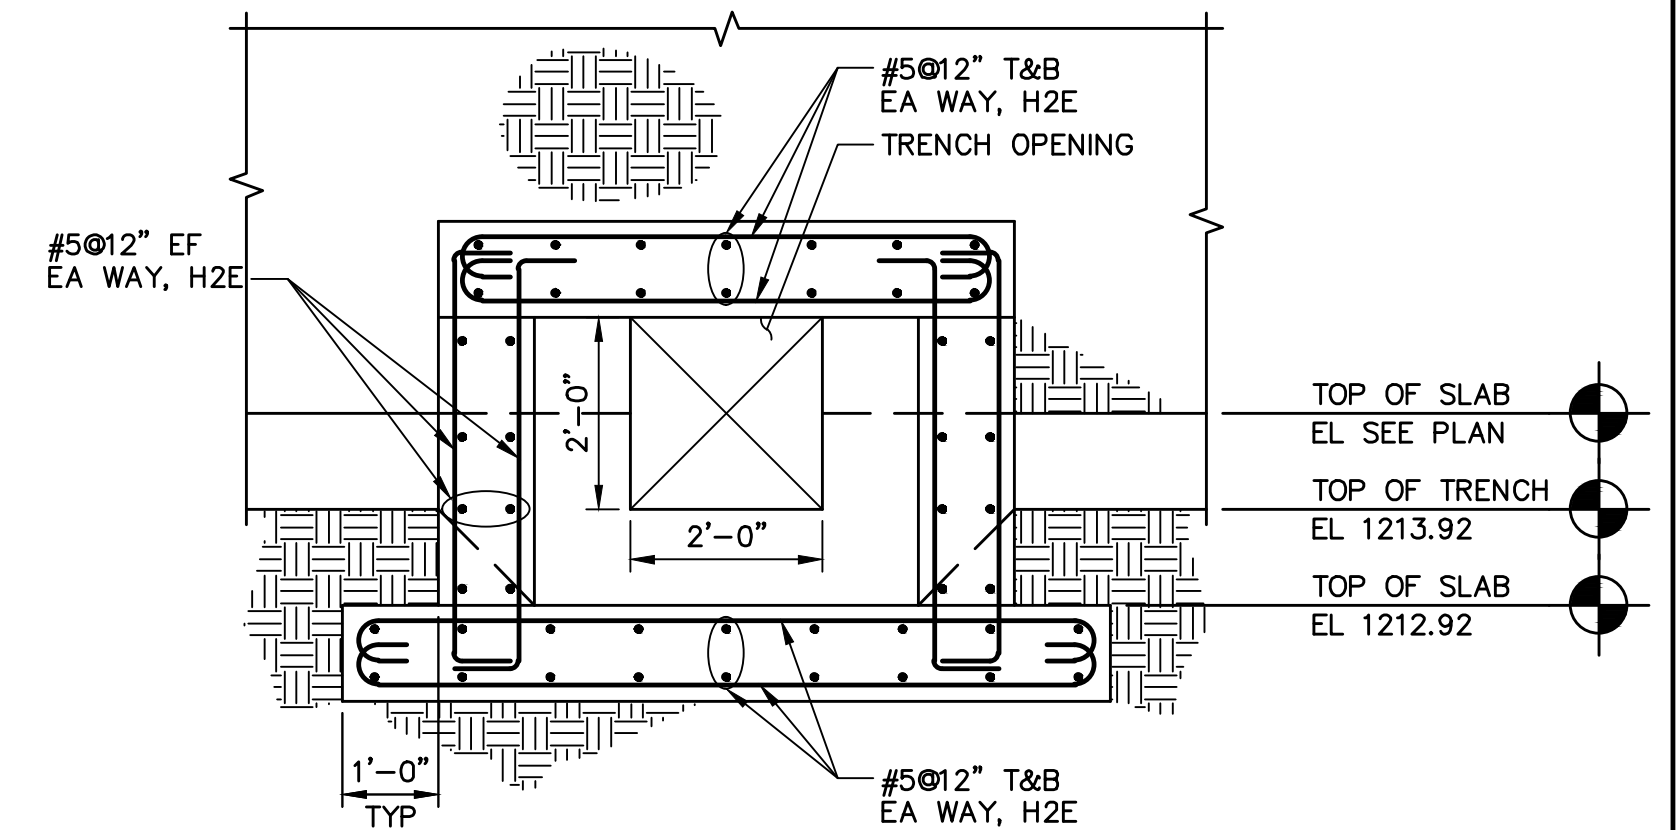

FOR ADDITIONAL INFORMATION, SEE SECTION C

SECTION C

SCALE = 1/2" = 1'-0"

REVISIONS				
NO.	BY	DATE	CKD	REMARKS
A	RW	01/2024	TH	90% SUBMITTAL
B	RW	04/2024	TH	AGENCY REVIEW
C	RW	08/2024	TH	ISSUED FOR CONSTRUCTION

DES  
RW  
DWN  
RW  
CKD  
TH



CITY OF PHOENIX  
WATER SERVICES DEPARTMENT  
  
LIFT STATION 40  
REFURBISHMENT

STRUCTURAL  
  
BIOFILTER FOUNDATION PLAN,  
SECTIONS AND DETAILS

COPYRIGHT © 2007-JANUARY  
CITY PROJECT NO. WS90400085  
DATE: 08/2024  
S-16 SHEET 72 OF 134  
CAD FILE: CSSL40004.dwg

FACILITY DRAWINGS  
This drawing was supplied by a Consultant Engineer from a past contractor and is not intended to be used for construction. The City does not warrant this drawing to be a complete and accurate portrayal of facilities as they exist in the field.

REVISION	DATE	PROJECT NO.	PROJECT NAME	DWG NUMBER	REMARKS






THIS DRAWING MUST BE FIELD VERIFIED BEFORE USE  
DRAWING NOT TO SCALE UNLESS SCALE BAR IS PRESENT


FOR CONSTRUCTION

PER CITY OF PHOENIX CODE CHAPTER 2, SECTION 2-28, THESE PLANS ARE  
FOR OFFICIAL USE ONLY AND MAY NOT BE SHARED WITH OTHERS EXCEPT AS  
REQUIRED TO FULFILL THE OBLIGATIONS OF THE CONTRACTOR'S CONTRACT  
THIS DOCUMENT MUST BE KEPT SECURE AT ALL TIMES.

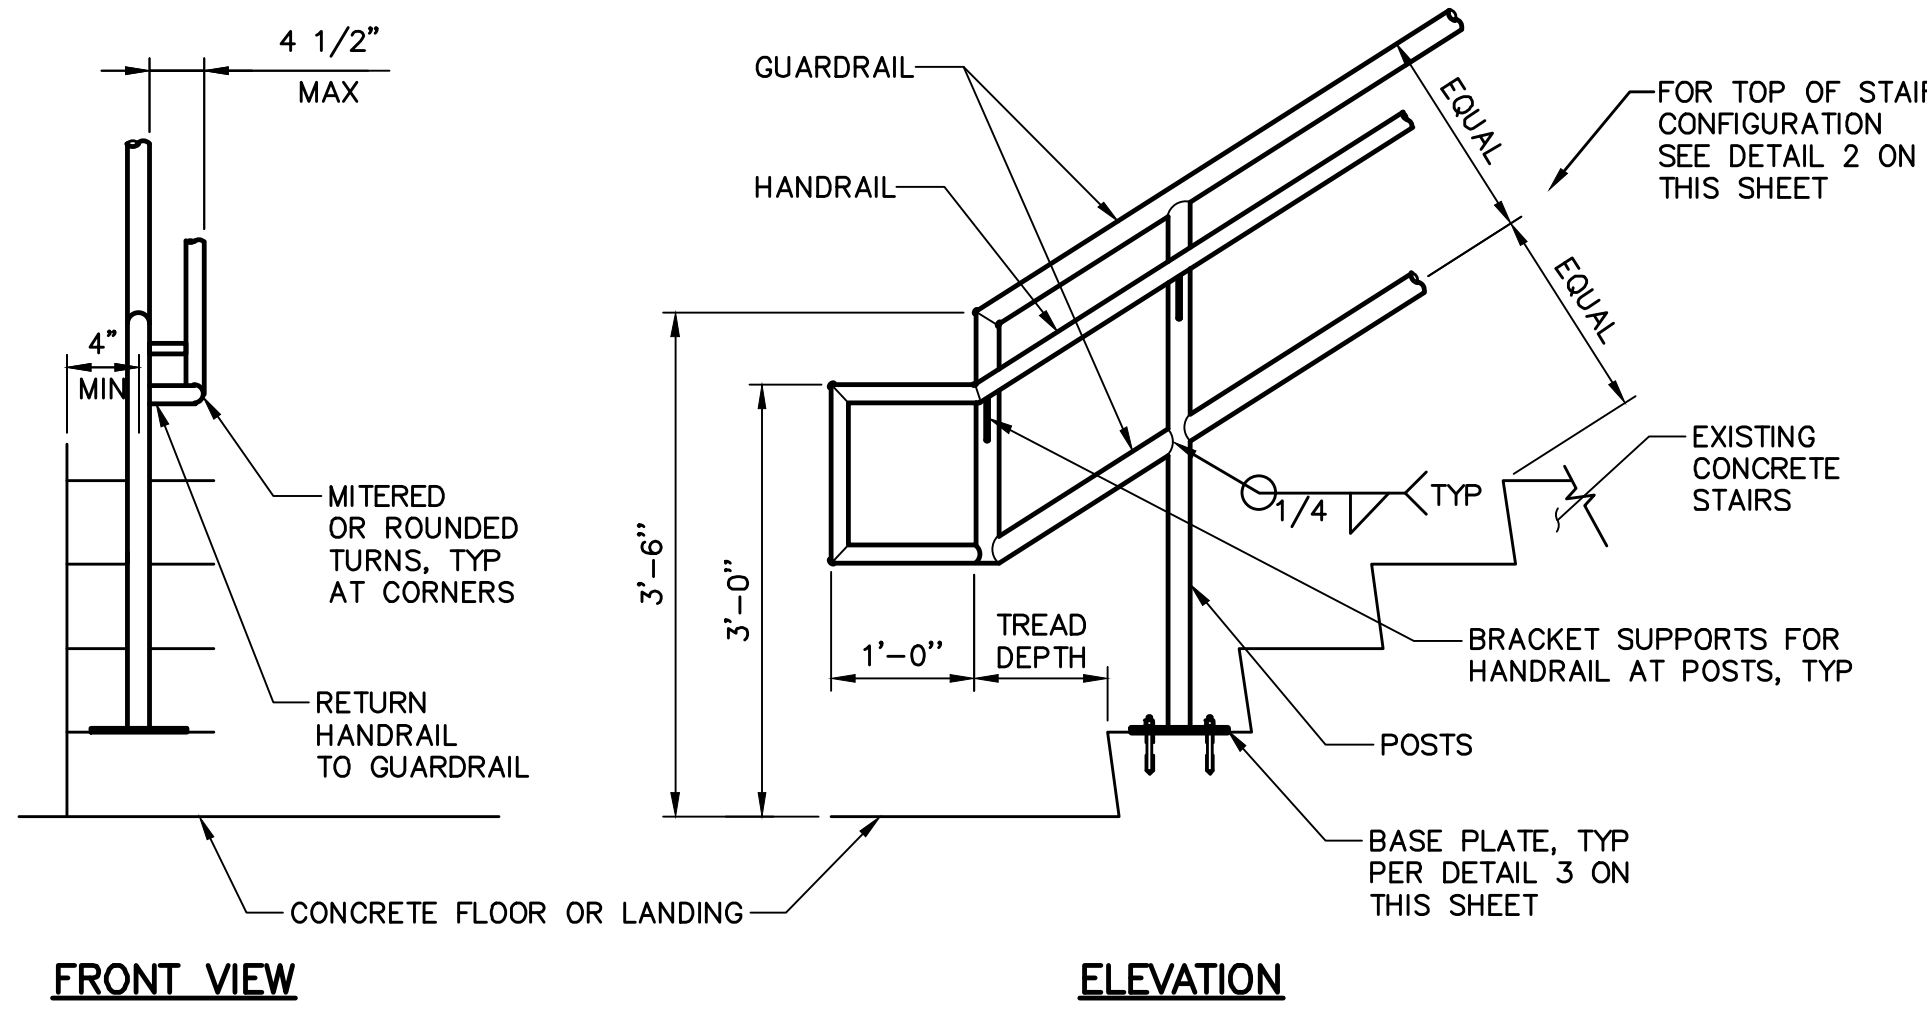


**FRONT VIEW**  
**ELEVATION**

NOTES:  
1. REFER TO SPECIFICATION SECTION 05 52 00.15 FOR ADDITIONAL INFORMATION.  
2. ALL COMPONENTS SHALL BE ALUMINUM, UNO.  
3. PROVIDE GALVANIC BREAK BETWEEN ALUMINUM AND DISSIMILAR METALS/CONCRETE PER SPECIFICATION 09900.

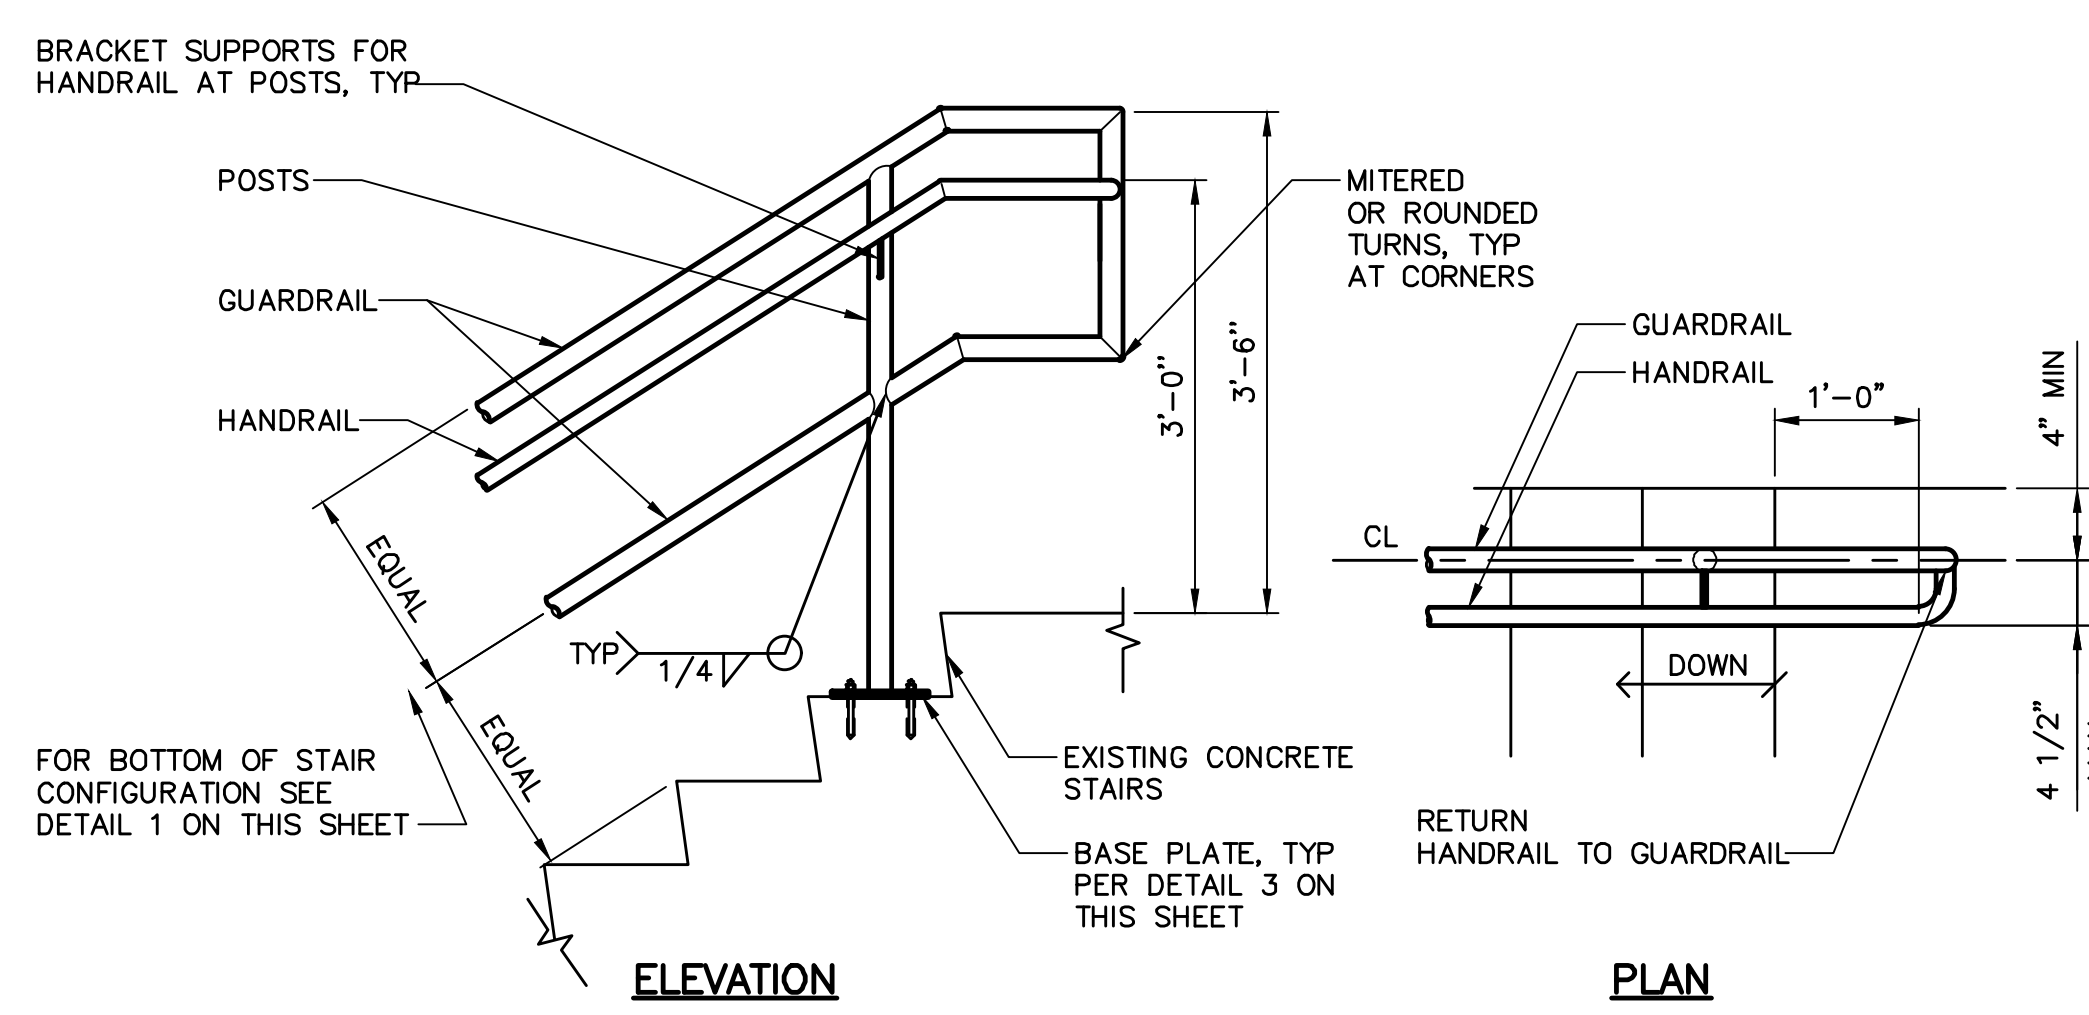


**ELEVATION**  
**PLAN**

NOTES:  
1. REFER TO SPECIFICATION SECTION 05 52 00.15 FOR ADDITIONAL INFORMATION.  
2. ALL COMPONENTS SHALL BE ALUMINUM, UNO.  
3. PROVIDE GALVANIC BREAK BETWEEN ALUMINUM AND DISSIMILAR METALS/CONCRETE PER SPECIFICATION 09900.

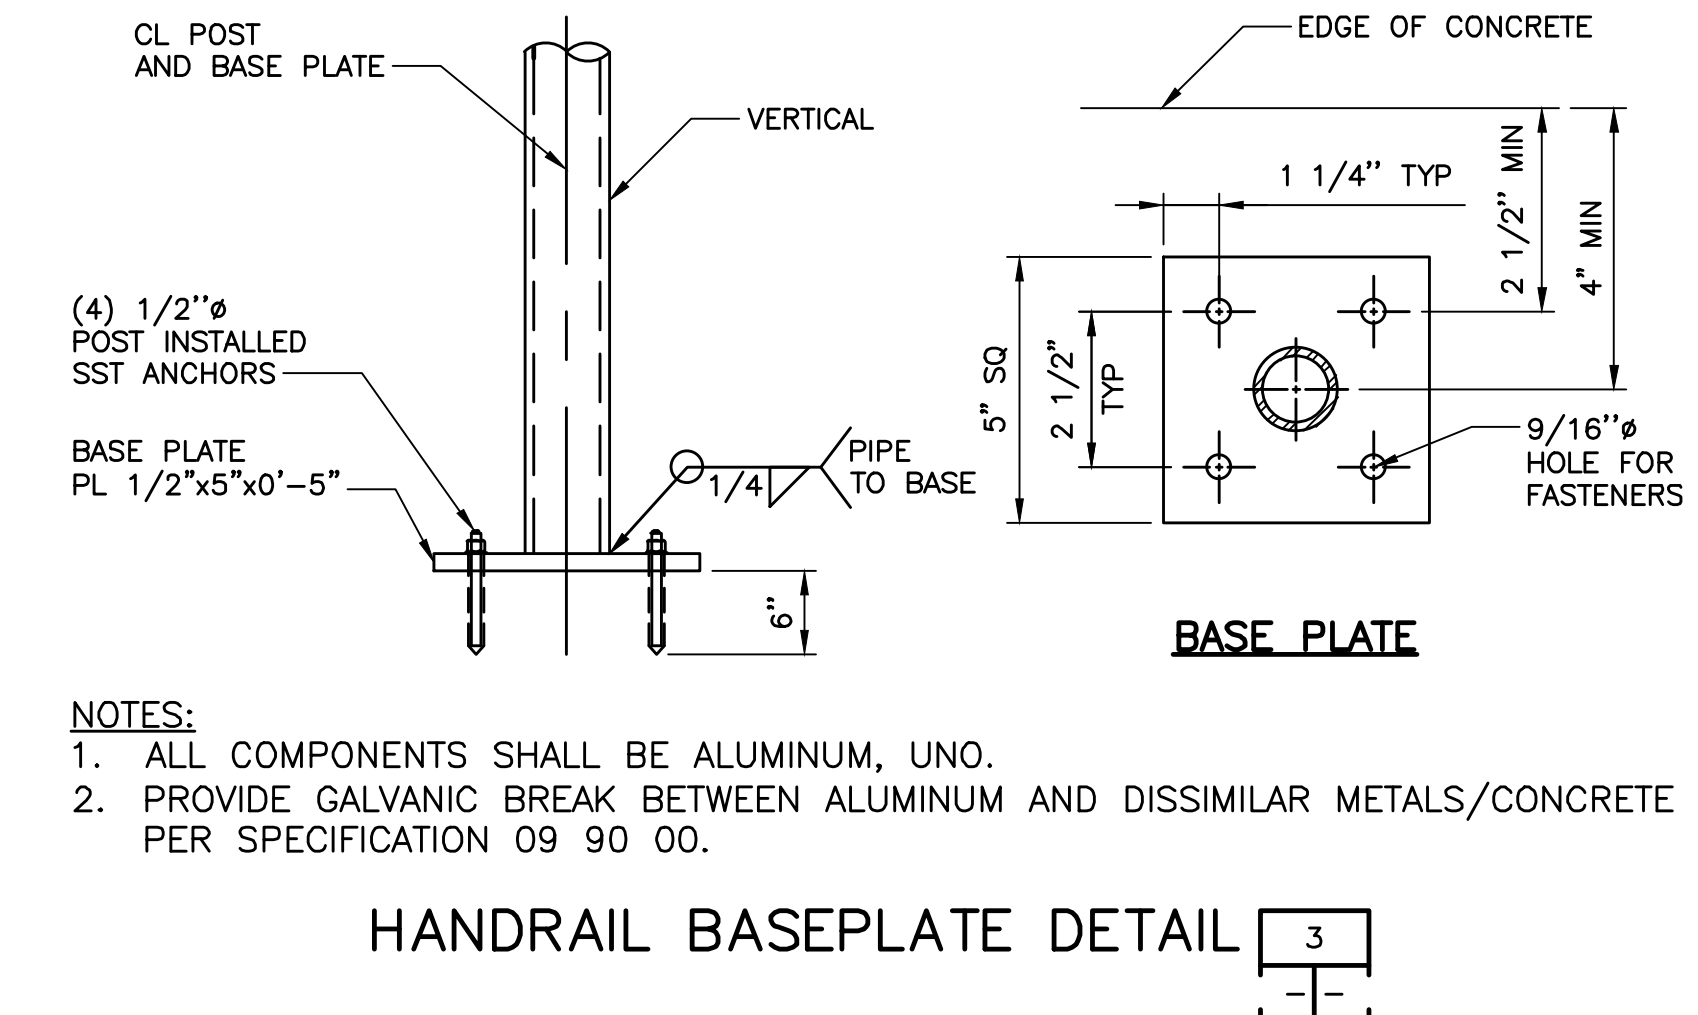


**HANDRAIL BASEPLATE DETAIL**

NOTES:  
1. ALL COMPONENTS SHALL BE ALUMINUM, UNO.  
2. PROVIDE GALVANIC BREAK BETWEEN ALUMINUM AND DISSIMILAR METALS/CONCRETE PER SPECIFICATION 09 90 00.

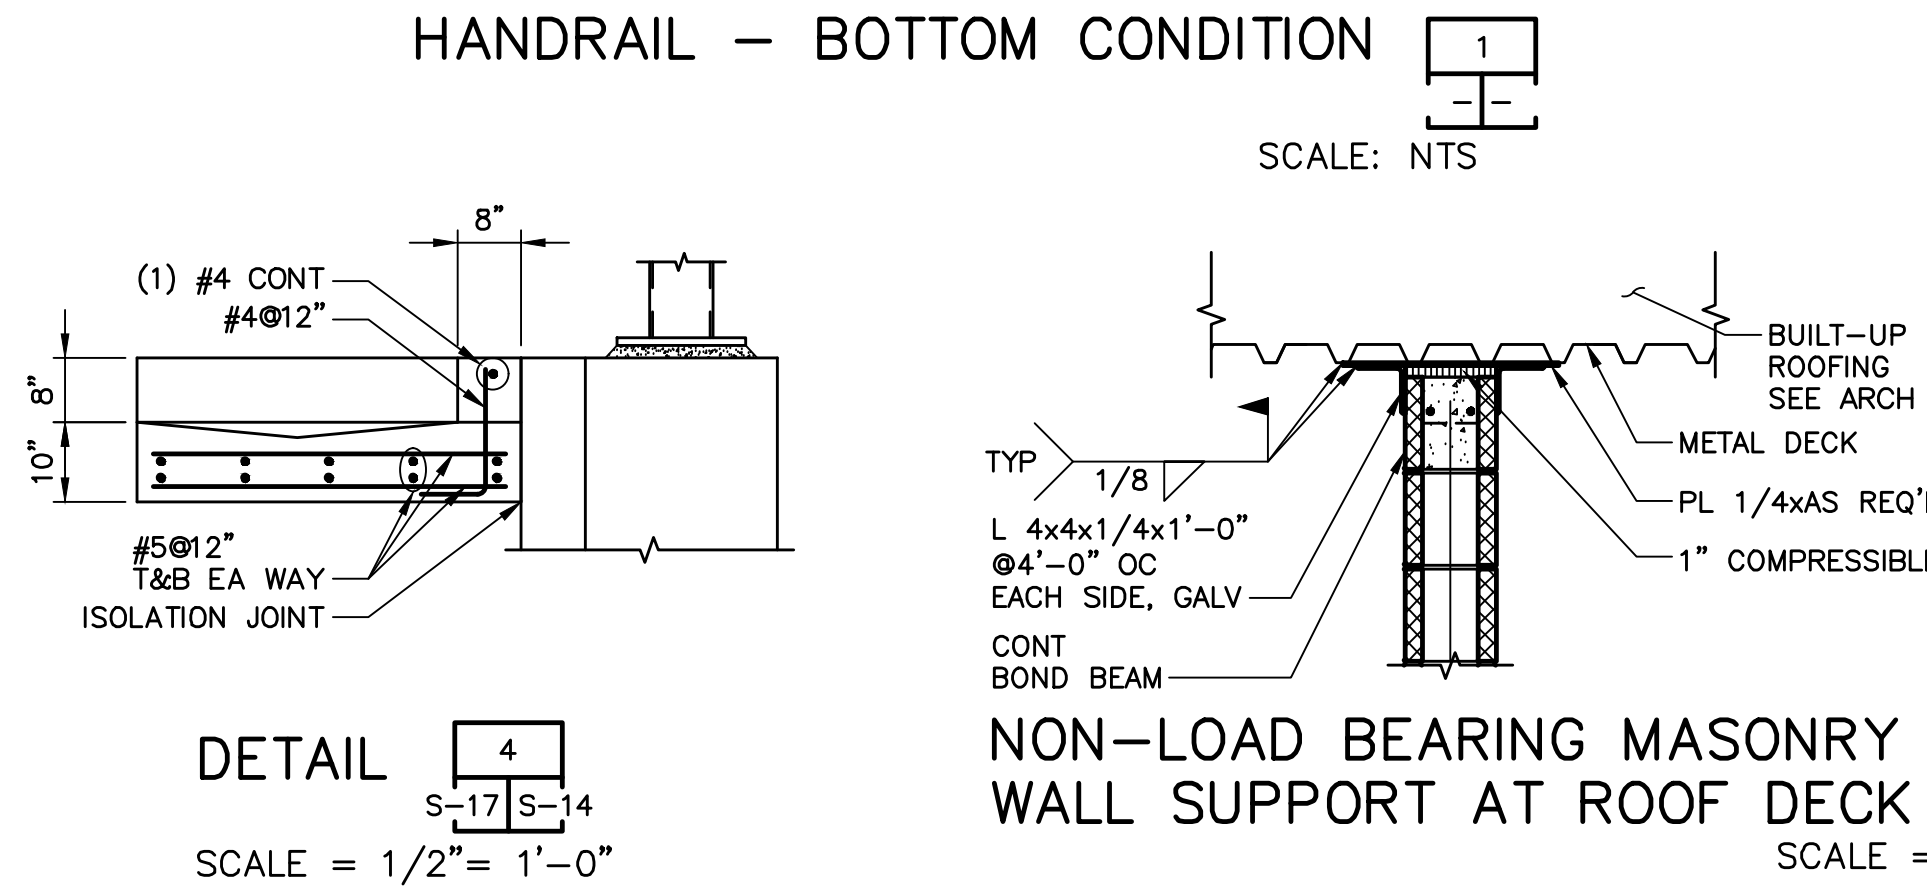


**HANDRAIL - BOTTOM CONDITION**

SCALE: NTS

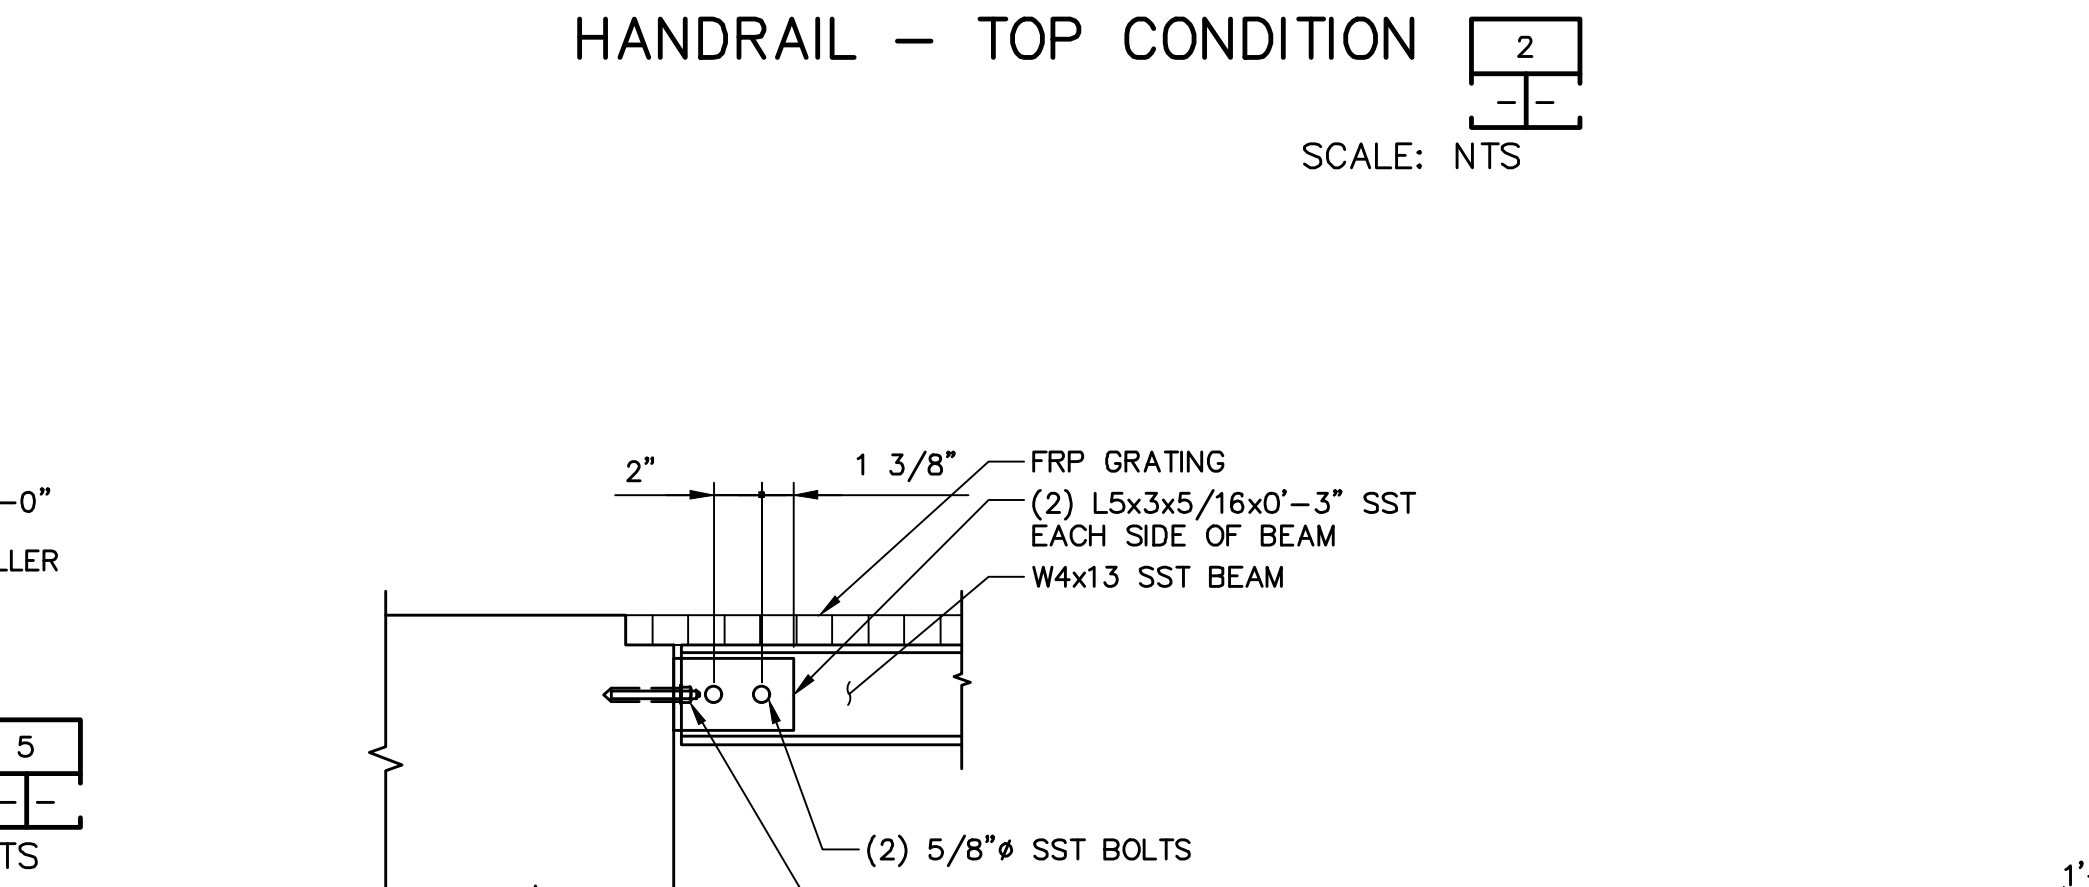


**HANDRAIL - TOP CONDITION**

SCALE: NTS

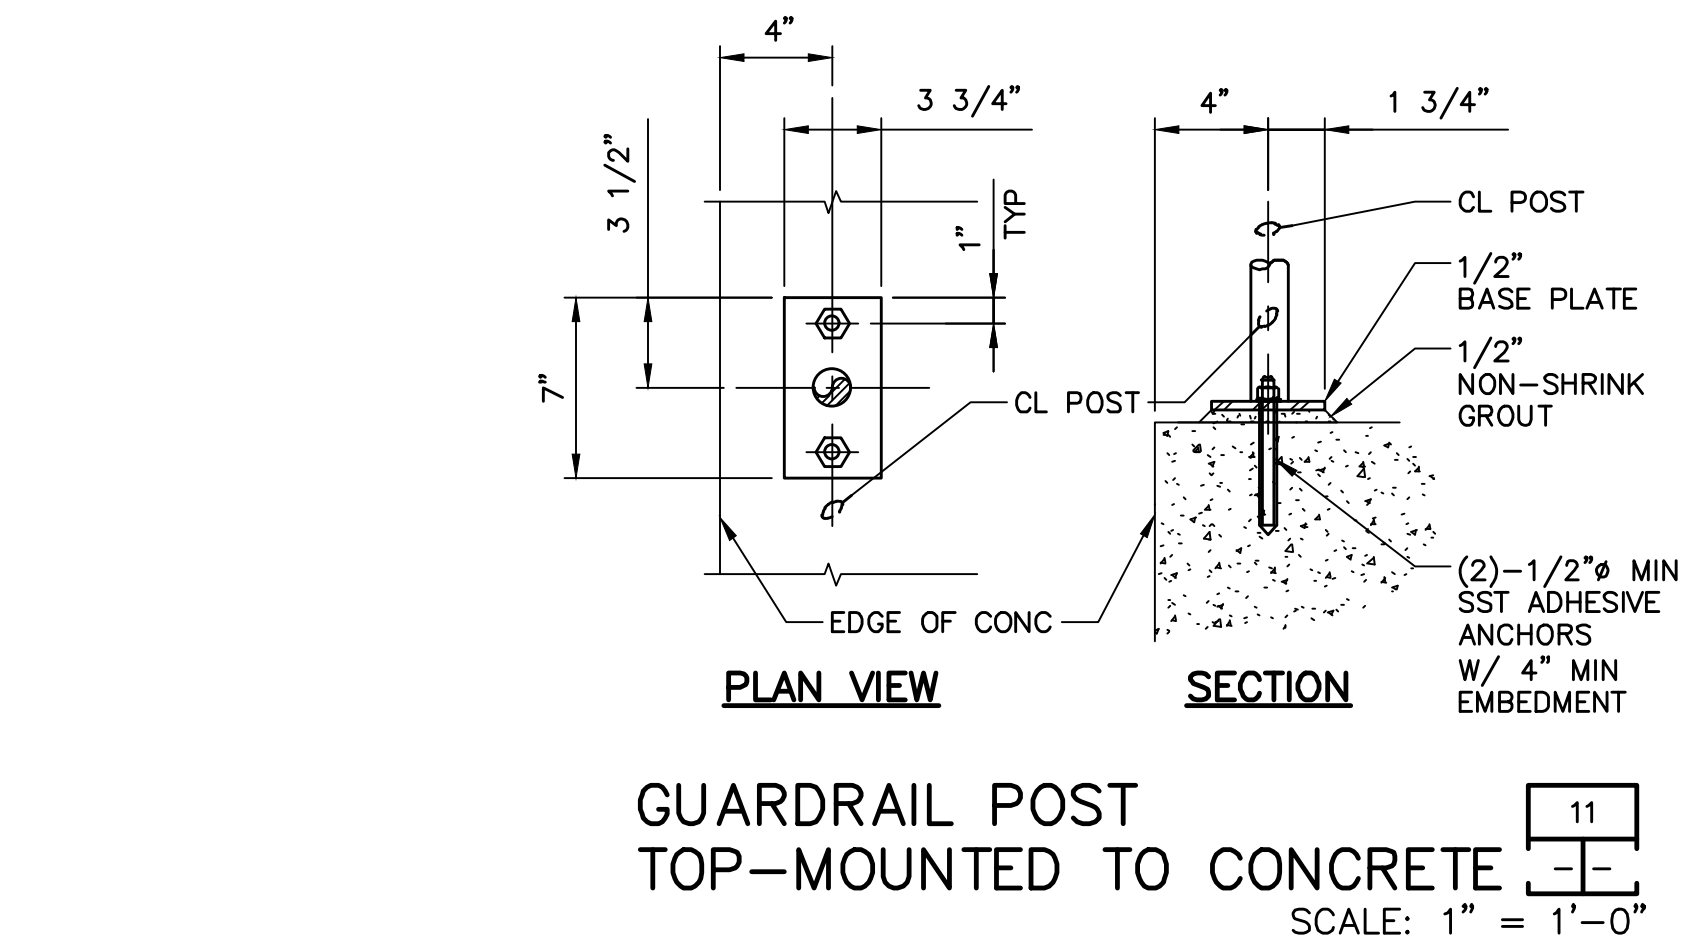


**GUARDRAIL POST TOP-MOUNTED TO CONCRETE**

SCALE: 1" = 1'-0"

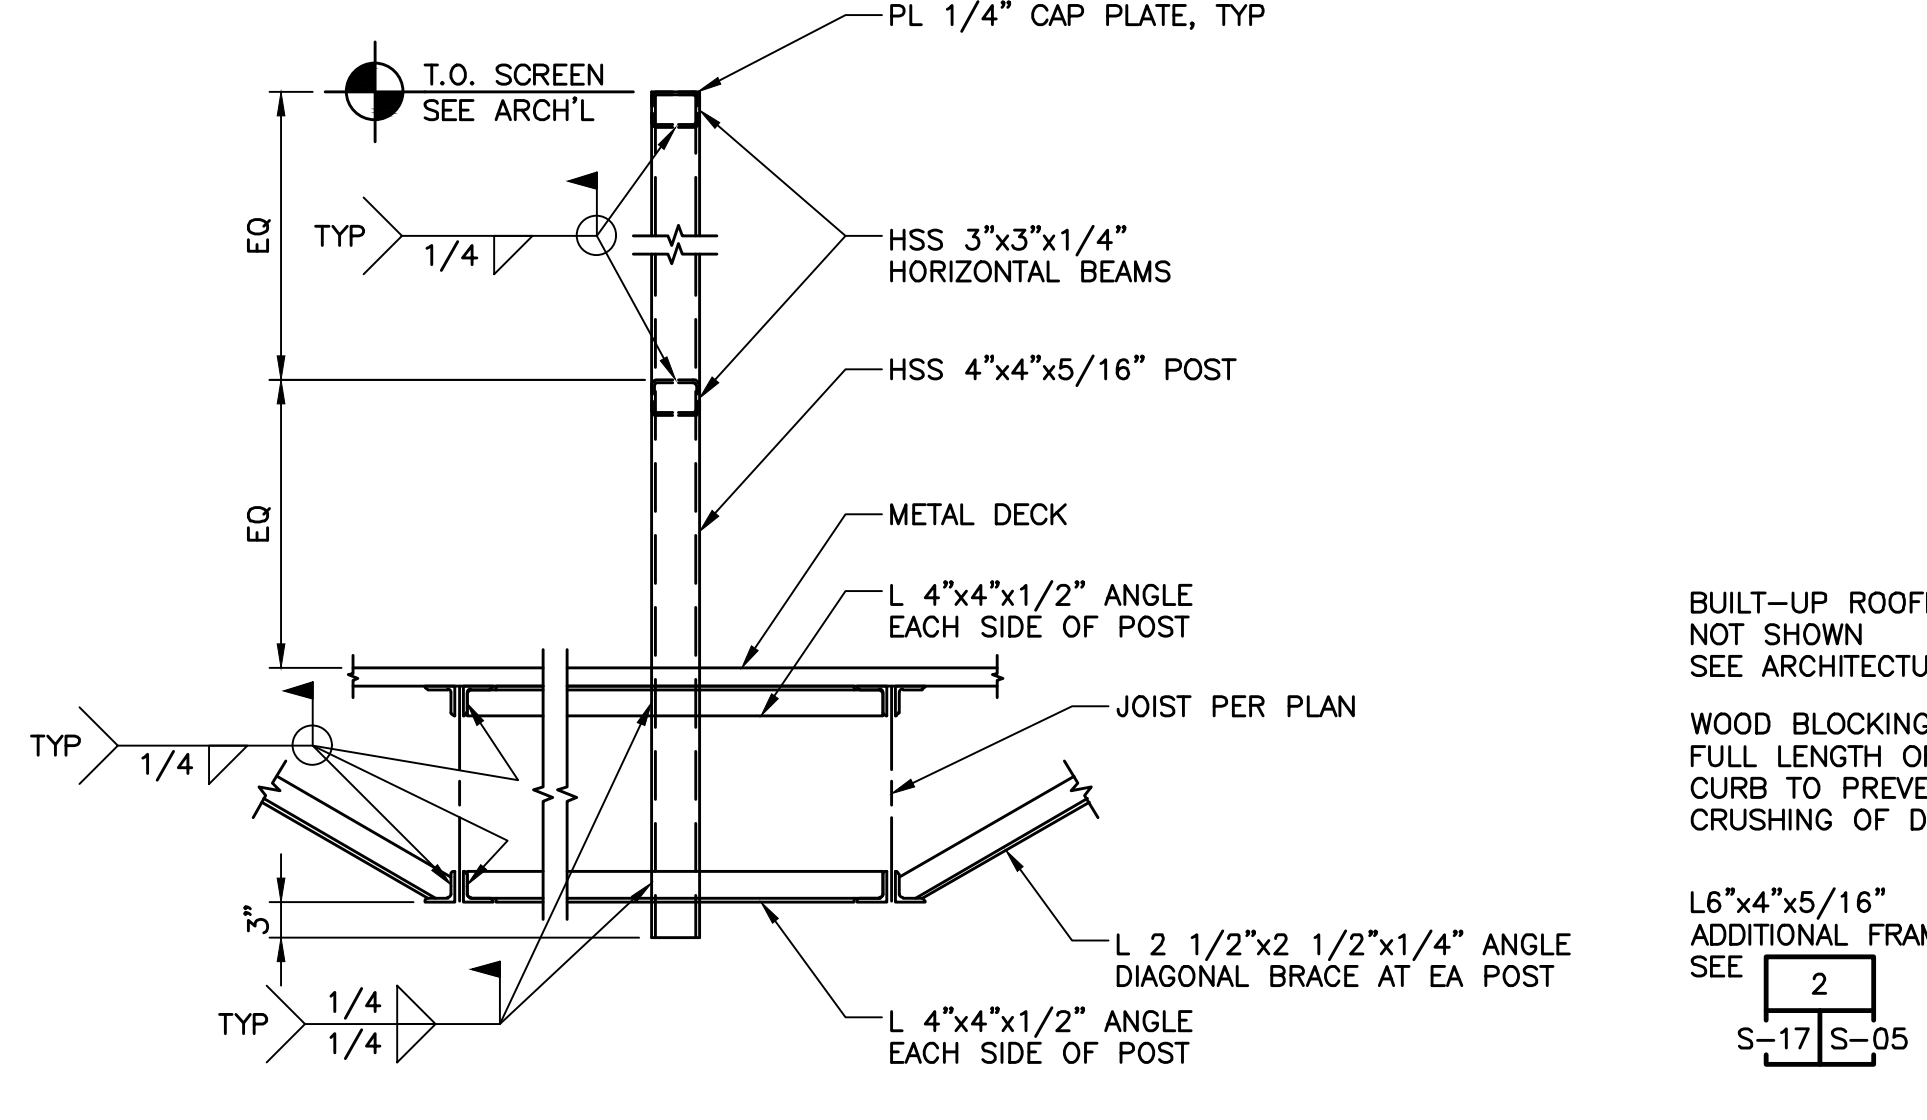


**MECHANICAL SCREEN SUPPORTS**

SCALE = NTS

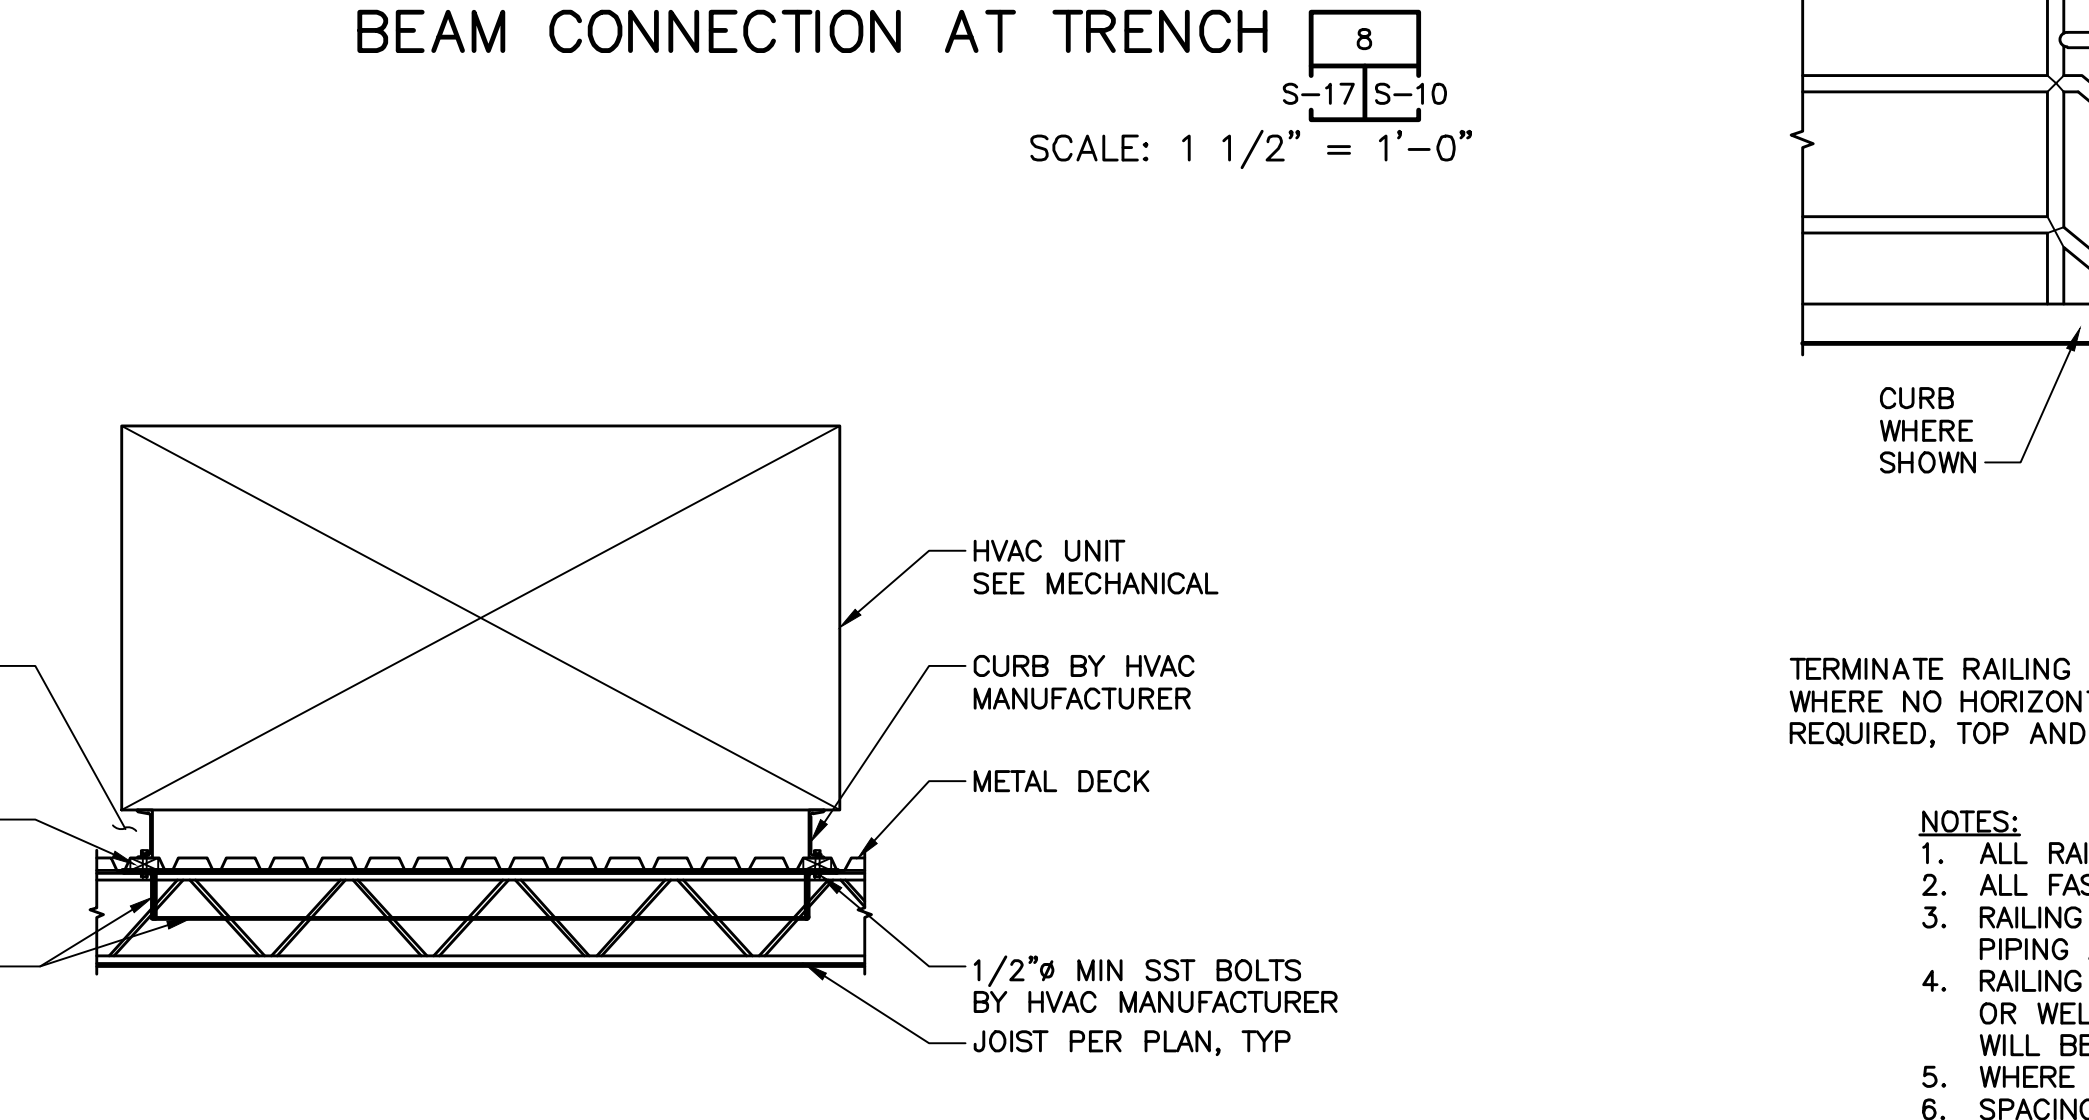

**BEAM CONNECTION AT TRENCH**

SCALE: 1 1/2" = 1'-0"

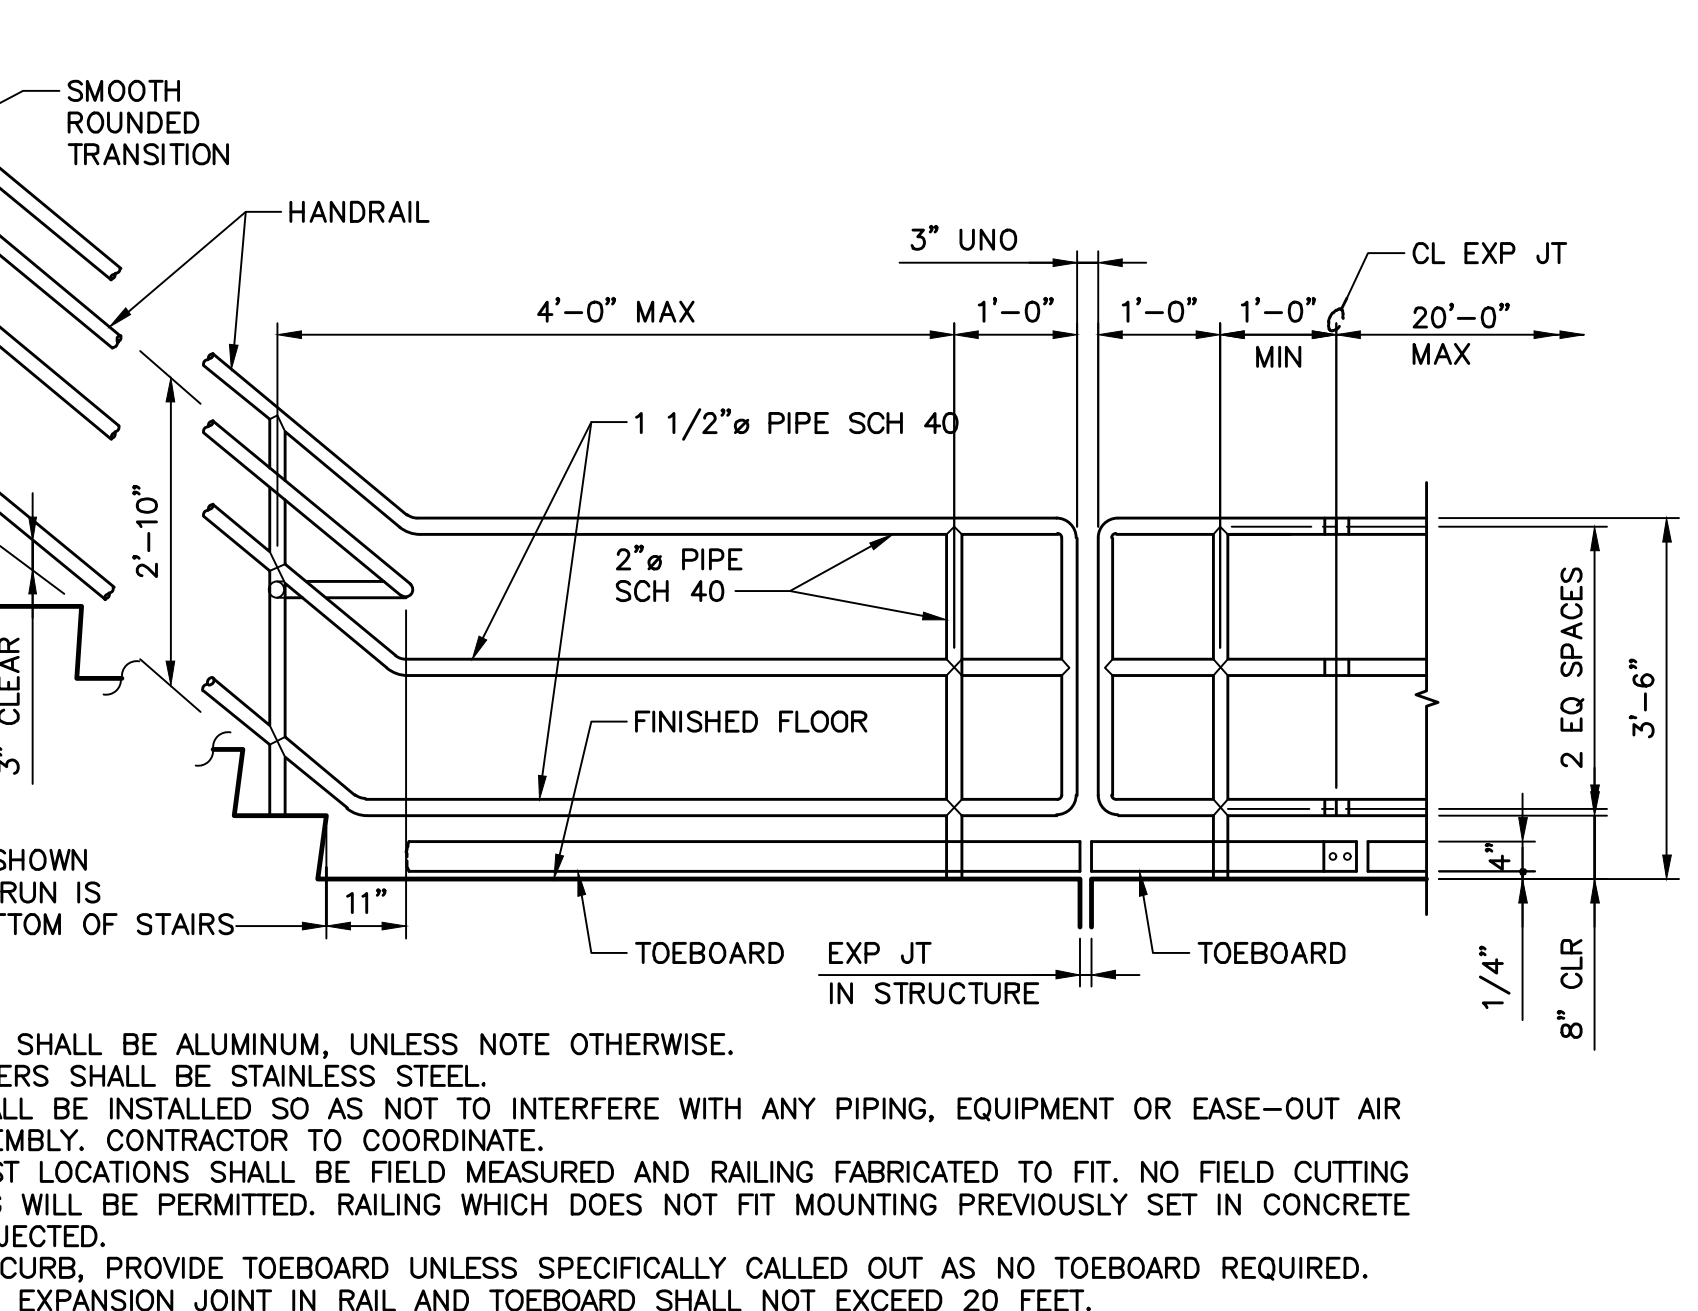

**ALUMINUM GUARDRAIL**


SCALE: 1" = 1'-0"

NOTES:  
1. ALL RAILING SHALL BE ALUMINUM, UNLESS NOTE OTHERWISE.  
2. ALL FASTENERS SHALL BE STAINLESS STEEL.  
3. RAILING SHALL BE INSTALLED SO AS NOT TO INTERFERE WITH ANY PIPING, EQUIPMENT OR EASE-OUT AIR PIPING ASSEMBLY. CONTRACTOR TO COORDINATE.  
4. RAILING POST LOCATIONS SHALL BE FIELD MEASURED AND RAILING FABRICATED TO FIT. NO FIELD CUTTING OR WELDING WILL BE PERMITTED. RAILING WHICH DOES NOT FIT MOUNTED PREVIOUSLY SET IN CONCRETE WILL BE REJECTED.  
5. WHERE NO CURB, PROVIDE TOEBOARD UNLESS SPECIFICALLY CALLED OUT AS NO TOEBOARD REQUIRED.  
6. SPACING OF EXPANSION JOINT IN RAIL AND TOEBOARD SHALL NOT EXCEED 20 FEET.  
7. RAILING POST TO BE EVENLY SPACED.



**ADDITIONAL FRAMING AT MECHANICAL UNIT**

SCALE: NTS

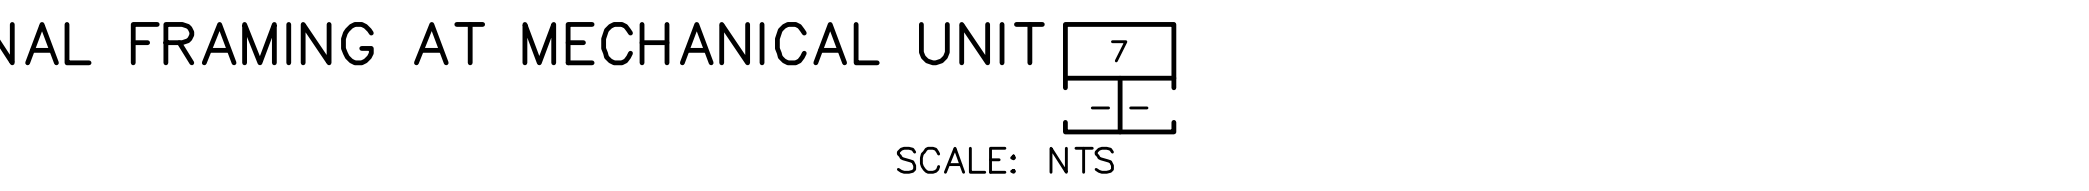

**MECHANICAL UNIT**

SCALE: NTS

REVISIONS				
NO.	BY	DATE	CHKD	REMARKS
A	RW	01/2024	TH	90% SUBMITTAL
B	RW	04/2024	TH	AGENCY REVIEW
C	RW	08/2024	TH	ISSUED FOR CONSTRUCTION

CITY OF PHOENIX  
WATER SERVICES DEPARTMENT

LIFT STATION 40  
REFURBISHMENT

STRUCTURAL

STRUCTURAL  
SECTIONS AND DETAILS 1

COPYRIGHT © 2007-JANUARY

CITY PROJECT NO. WS90400085

DATE: 08/2024

S-17 SHEET 73 OF 134


CAD FILE: CSSL40005.dwg

FACILITY DRAWINGS  
This drawing was supplied by a Consultant Engineer from a past contractor and is provided for informational purposes only. The City does not warrant this drawing to be a complete and accurate portrayal of facilities as they exist in the field.

REVISION	ENGINEERING COMPANY	PROJECT NO.	PROJECT NAME	DATE	CAD FILE NAME	REMARKS

FOR CITY OF PHOENIX USE ONLY - REFERENCE CID NUMBER: #  
DATE: 8/28/24 TIME: 05:15pm  
USER: RWRIGHT FILE: C:\gwworking\wss\01\35411832\CSSL40005.dwg

THIS DRAWING MUST BE FIELD VERIFIED BEFORE USE  
DRAWING NOT TO SCALE UNLESS SCALE BAR IS PRESENT

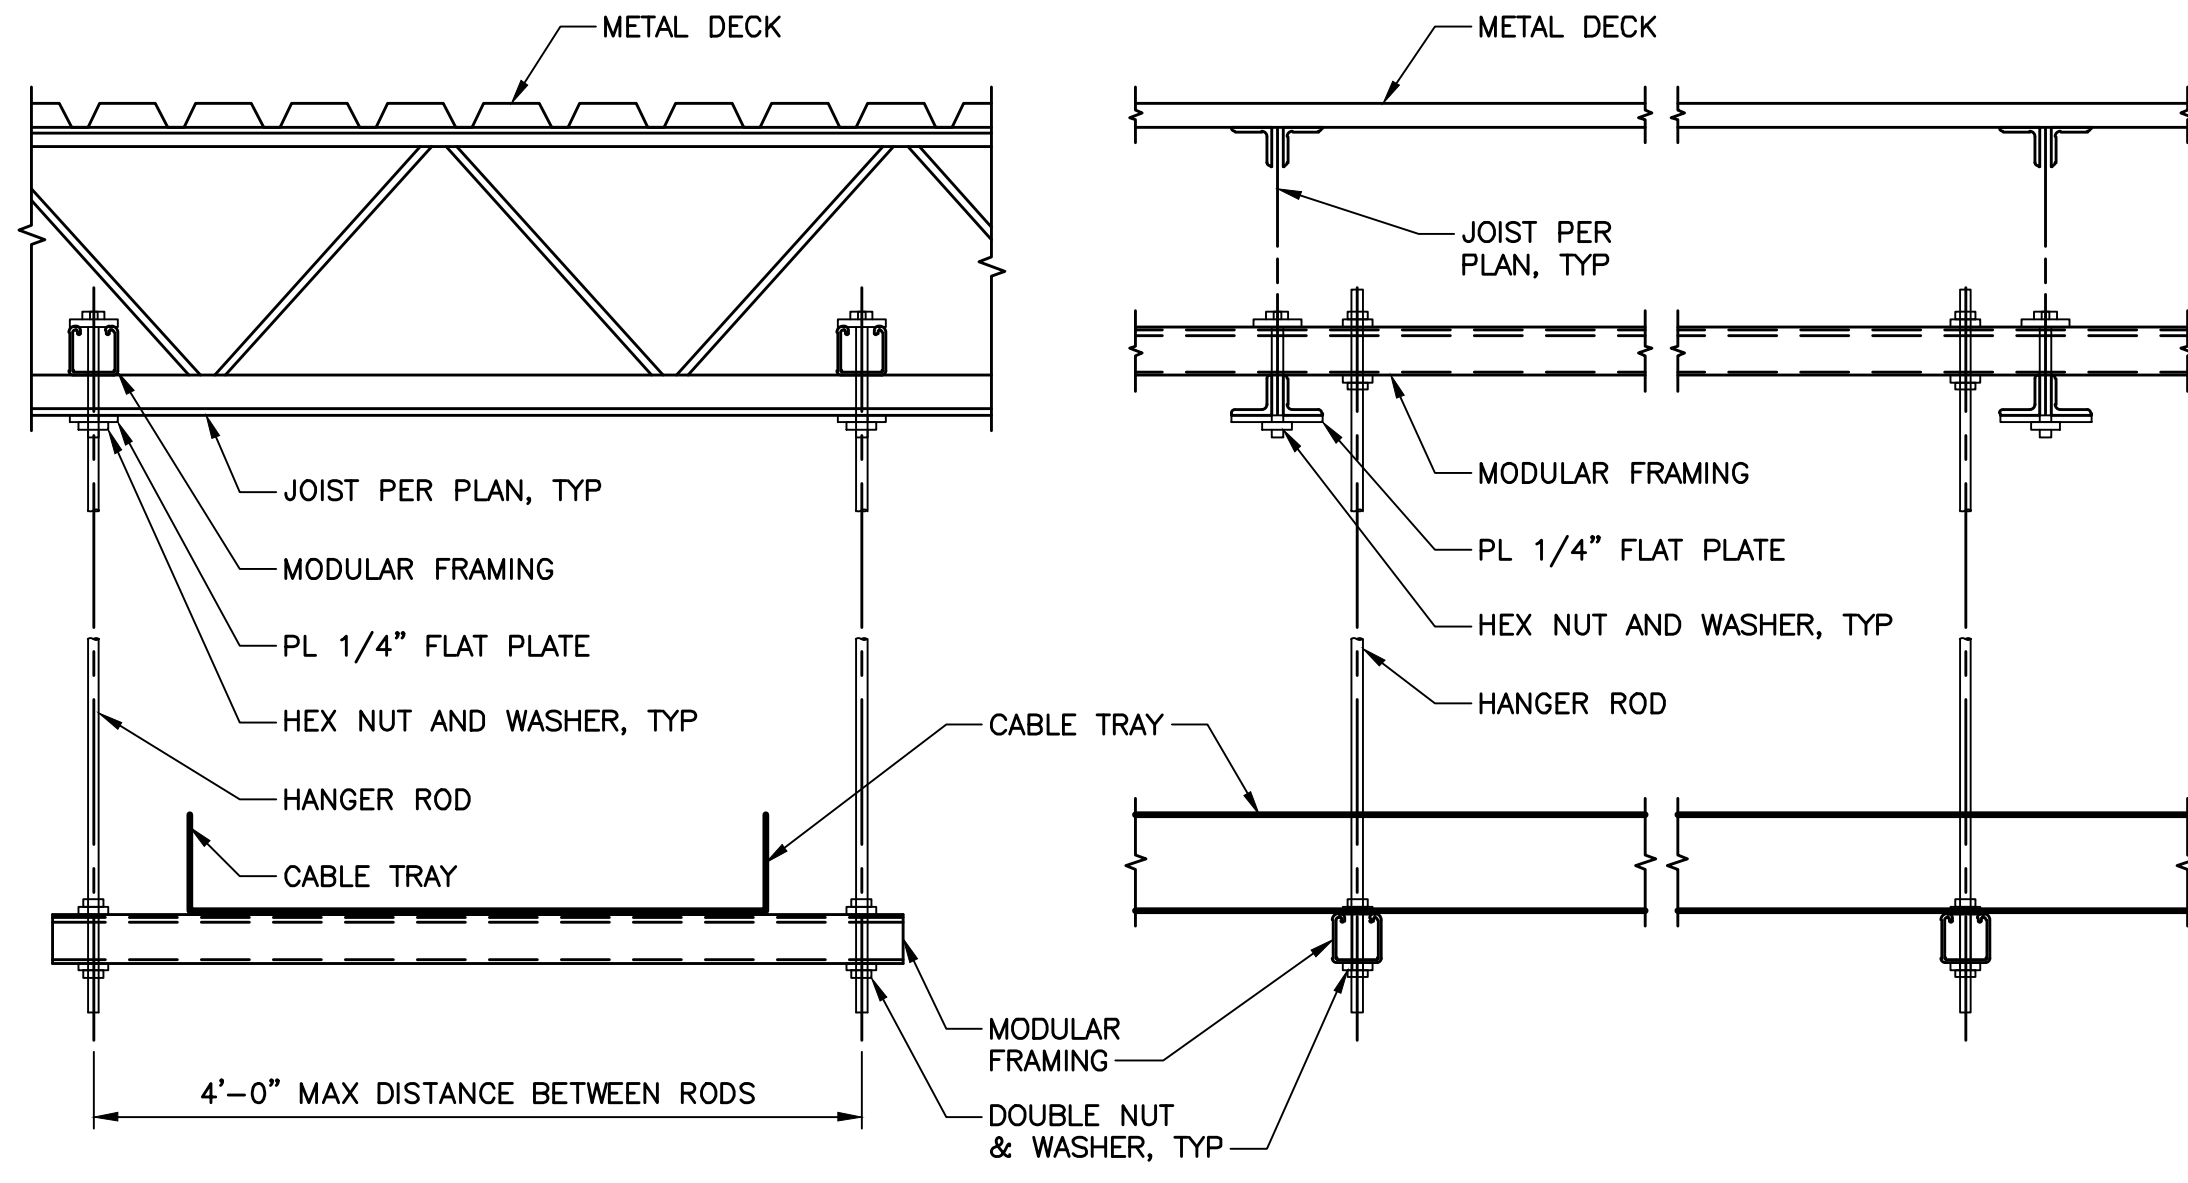


ELEVATION

SECTION


- NOTES:**
1. MATERIAL FOR ALL COMPONENTS SHALL BE HOT DIPPED GALVANIZED AFTER FABRICATION UNLESS NOTED OTHERWISE.
  2. INSTALL ALL PARTS AND COMPONENTS IN ACCORDANCE WITH MANUFACTURER'S INSTALLATION INSTRUCTIONS.
  3. DETAIL SHOWN FOR REPRESENTATION OF SYSTEM AND FOR BID PURPOSES ONLY. CONTRACTOR TO PROVIDE STRUCTURAL DESIGN INCLUDING CALCULATIONS FOR MODULAR FRAMING. CONTRACTOR TO SUBMIT SHOP DRAWINGS AND CALCULATIONS TO THE ENGINEER OF RECORD FOR REVIEW AND APPROVAL PRIOR TO CONSTRUCTION. THE SUBMITTED DRAWINGS AND CALCULATIONS SHALL BE SIGNED AND SEALED BY A PROFESSIONAL ENGINEER REGISTERED IN THE STATE OF ARIZONA.
  4. REFERENCE THE STANDARD JOIST DETAILS FOR ADDITIONAL INFORMATION.
  5. REFERENCE SPECIFICATION SECTIONS 05 50 00 AND 26 05 36 FOR ADDITIONAL INFORMATION.

CABLE TRAY SUPPORT 1  
SCALE: NTS

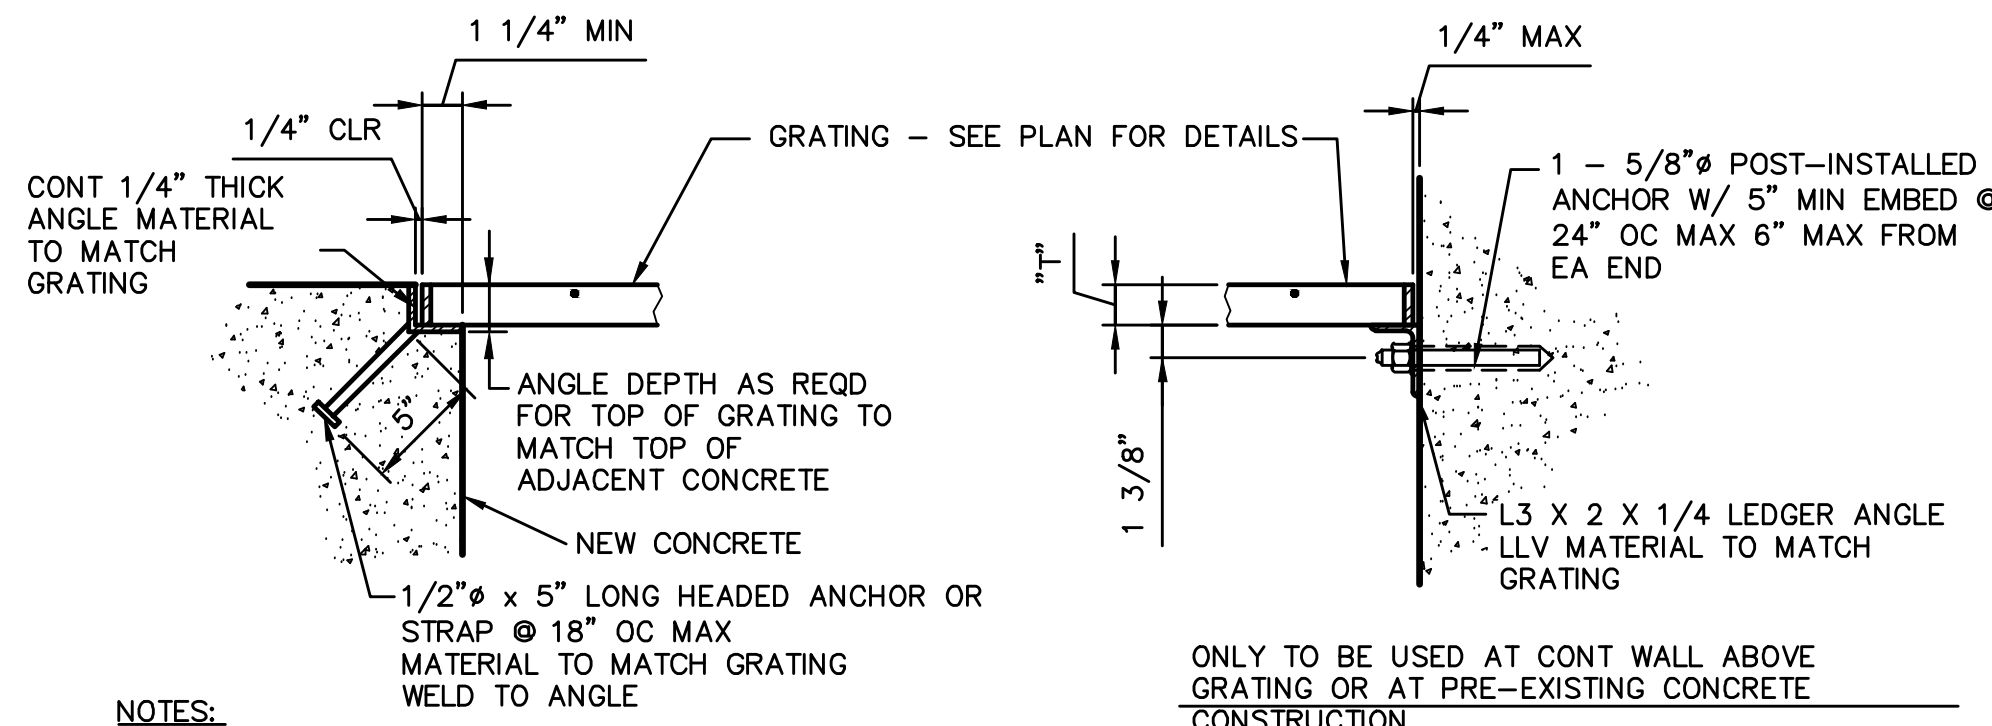


- NOTES:**
1. GRATING SIZE PER CONTRACT DOCUMENTS.
  2. ALL ENDS AND OPENINGS SHALL BE BANDED, SEE SPECIFICATION.
  3. ATTACH GRATING TO ALL SUPPORT ANGLES WITH BOLTED CLIPS, SPACED AT 2'-0" MAX CENTERS.
  4. PROVIDE DISSIMILAR MATERIAL PROTECTION FOR ALUMINUM IN CONTACT WITH CONCRETE PER SPECIFICATION.

GRATING AND SUPPORT DETAIL 3  
SCALE: NTS

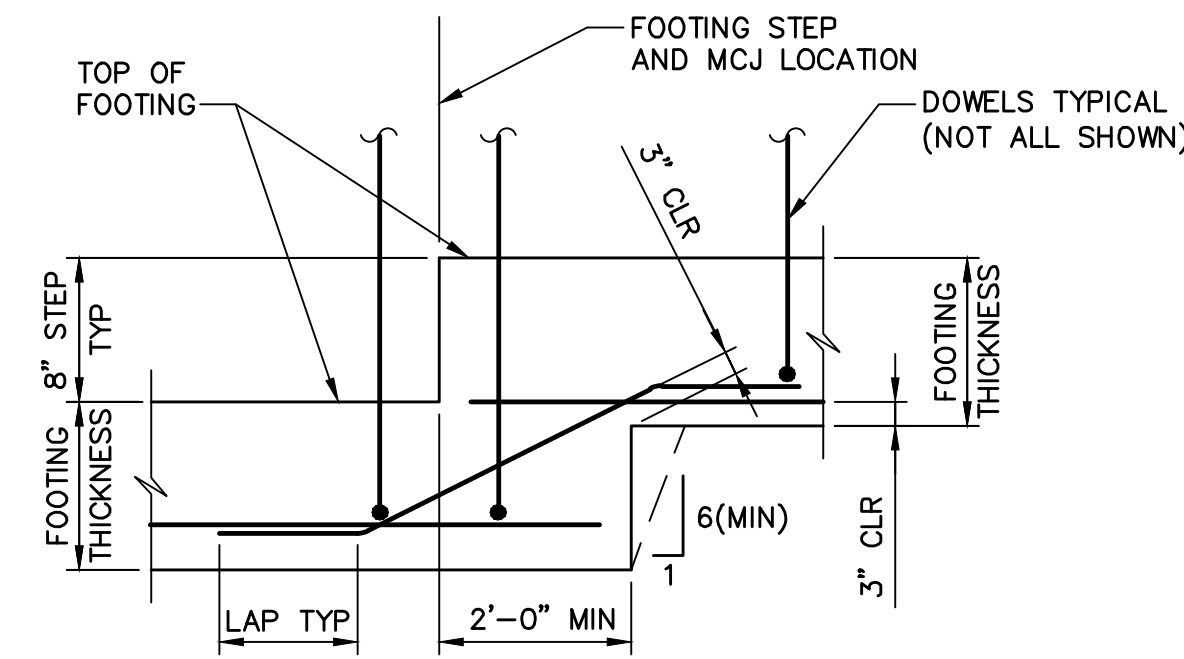

- NOTES:**
1. THIS DETAIL SHALL BE USED AS REQUIRED TO MAINTAIN FOOTING DEPTHS SHOWN ON DETAILS AND MAY NOT SPECIFICALLY BE REFERENCED.
  2. SEE DETAIL 4 ON THIS SHEET FOR REINFORCING AND FOOTING SIZE.
  3. BOTTOM OF FOOTINGS SHALL BE STEPPED. SLOPING OF FOOTING BOTTOM IS NOT PERMITTED.

STEPPED CONCRETE FOOTING AT MASONRY WALL 2  
SCALE: NTS

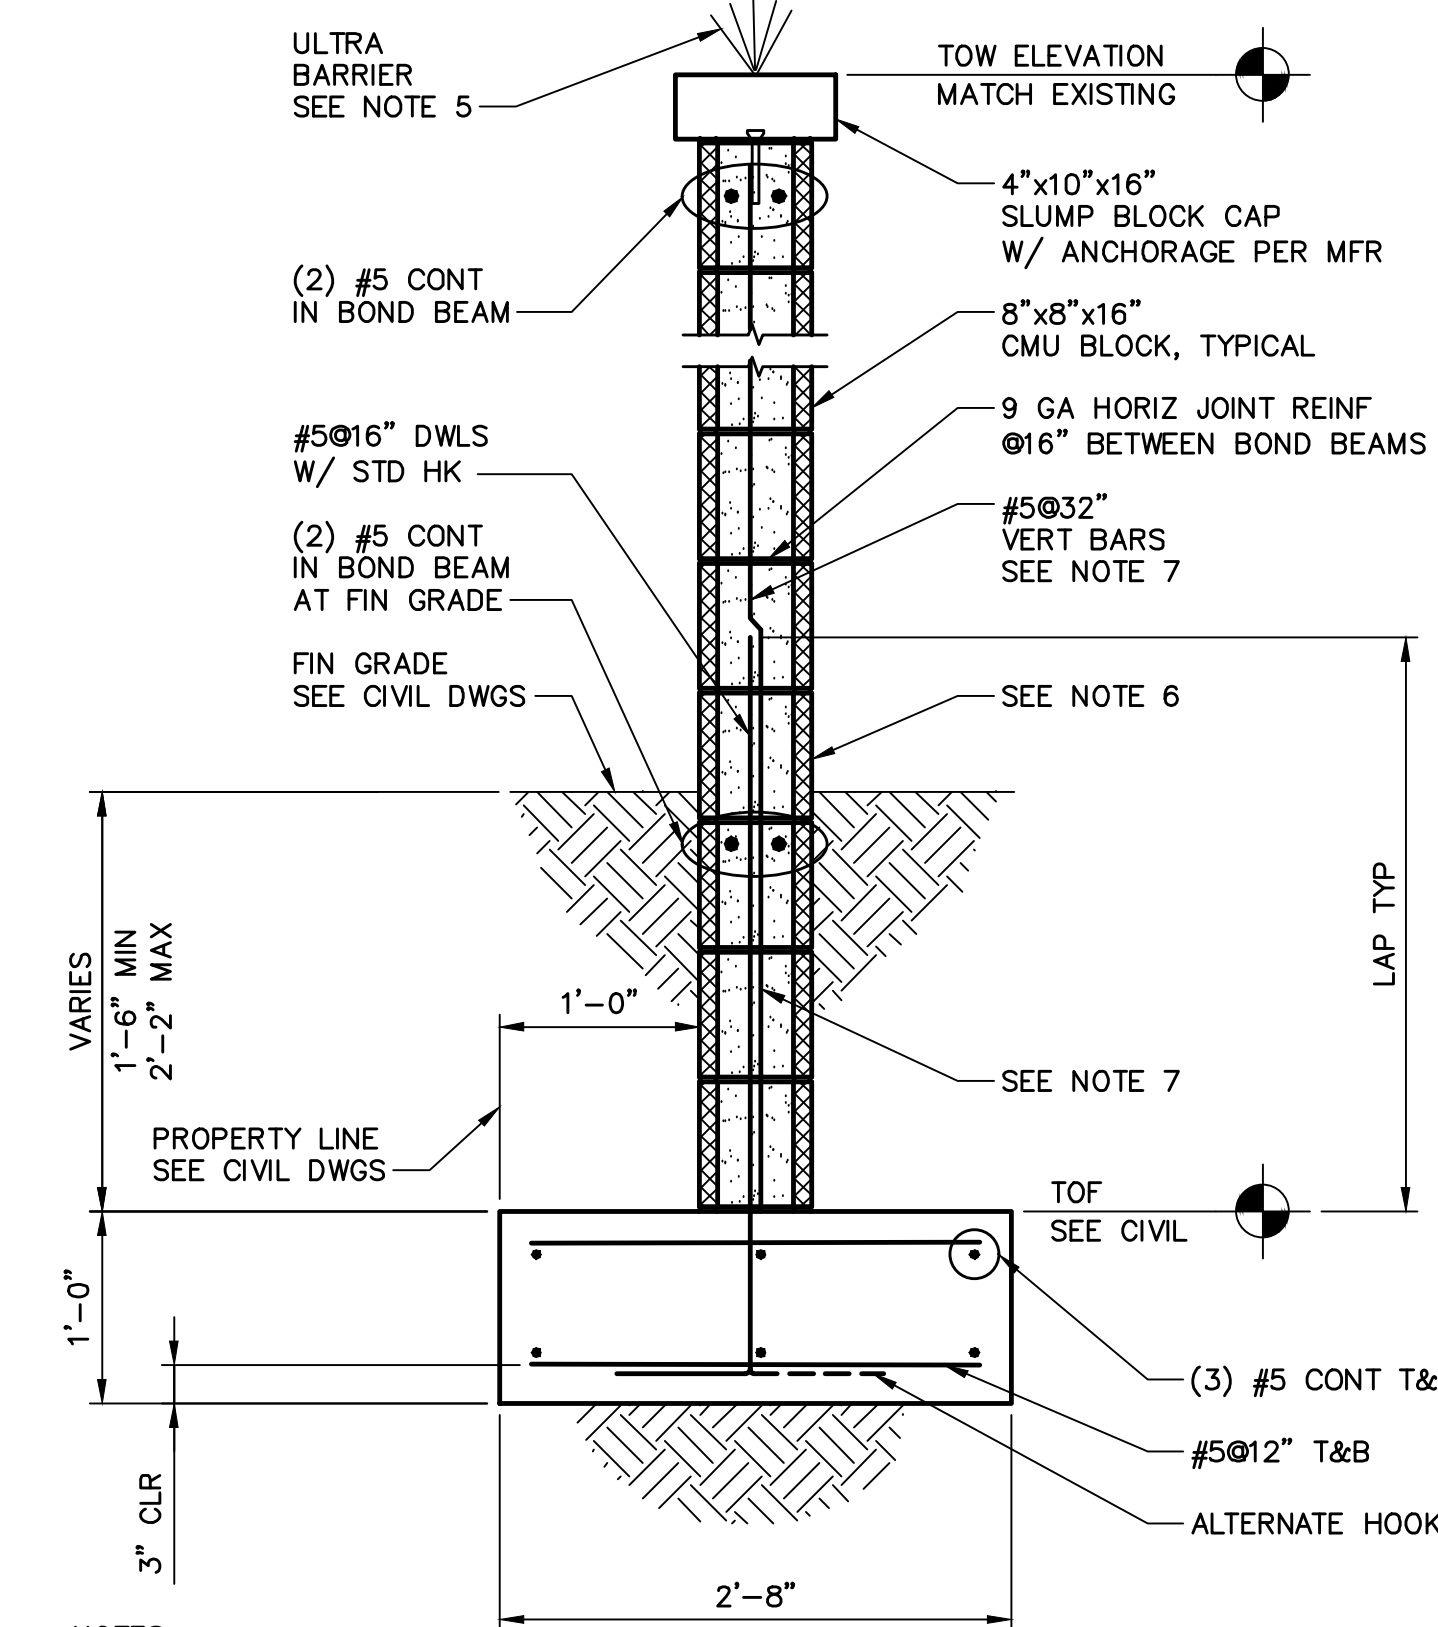

- NOTES:**
1. REFER TO CIVIL SHEETS FOR WALL LOCATIONS.
  2. CONTRACTOR TO SUBMIT WALL PROFILE DEPICTING FINISHED GRADE, TOP OF WALL AND TOP OF FOOTING ELEVATIONS ALONG WITH FOOTING/WALL STEP LOCATIONS FOR ENGINEER'S REVIEW AND APPROVAL.
  3. EXTEND FOOTING 1'-0" MINIMUM BEYOND END OF WALL.
  4. SEE SHEET S-05 FOR ADDITIONAL CMU REINFORCING REQUIREMENTS.
  5. FURNISH AND INSTALL ULTRA-BARRIER PER DETAIL 11 ON SHEET C-04. INSTALL PER MANUFACTURER'S PRINTED INSTALLATION INSTRUCTIONS.
  6. PROVIDE DRAIN HOLES IN SITE WALLS AT GRADE. SPACE DRAIN HOLES AT 64 INCHES ON CENTER MAXIMUM. AT CONTRACTOR'S OPTION, FORM DRAIN HOLES BY PLACING A FULL BLOCK HORIZONTALLY, REMOVING A HALF BLOCK, OR REPLACING A FULL BLOCK WITH TWO BRICK-SIZED SOLID BLOCKS SET SOLDIER COURSE. SEE CIVIL DRAWINGS FOR LOCATION OF SITE WALLS.
  7. GROUT SOLID ONLY CELLS WITH REINFORCING ABOVE GRADE AND ALL CELLS BELOW GRADE

TYPICAL CMU SITE WALL 4  
SCALE: NTS

"PER CITY OF PHOENIX CODE CHAPTER 2-28, THESE PLANS ARE FOR OFFICIAL USE ONLY AND MAY NOT BE SHARED WITH OTHERS EXCEPT AS REQUIRED TO FULFILL THE OBLIGATIONS OF THE CONTRACTOR'S CONTRACT WITH THE CITY OF PHOENIX." THIS DOCUMENT MUST BE KEPT SECURE AT ALL TIMES.


FOR CONSTRUCTION

FACILITY DRAWINGS  
This drawing was supplied by a Consultant Engineer from a past contract and is being provided to the Contractor for information only. The City does not warrant this drawing to be a complete and accurate portrayal of facilities as they exist in the field.

REVISION	ENGINEERING COMPANY	PROJECT NO.	PROJECT NAME	DATE	CAD FILE NAME	DWG NUMBER	REMARKS



REVISIONS				
NO.	BY	DATE	CKD	REMARKS
A	RW	01/2024	TH	90% SUBMITTAL
B	RW	04/2024	TH	AGENCY REVIEW
C	RW	08/2024	TH	ISSUED FOR CONSTRUCTION

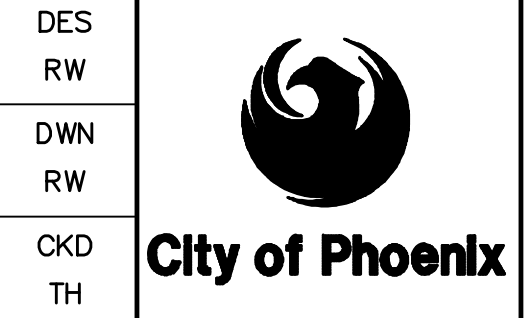

CITY OF PHOENIX  
WATER SERVICES DEPARTMENT  
  
LIFT STATION 40  
REFURBISHMENT

STRUCTURAL  
  
STRUCTURAL  
SECTIONS AND DETAILS 2





COPYRIGHT © 2007-JANUARY  
CITY PROJECT NO. WS90400085  
DATE: 08/2024  
S-18 SHEET 74 OF 134  
CAD FILE: CSSL40006.dwg

USER: RWRIGHT FILE: C:\pwworking\west01\35411532\CSSL40006.dwg DATE: 8/28/24 TIME: 05:16pm


**FOR CONSTRUCTION**

"PER CITY OF PHOENIX CODE CHAPTER 2, SECTION 2-28, THESE PLANS ARE FOR OFFICIAL USE ONLY AND MAY NOT BE SHARED WITH OTHERS EXCEPT AS REQUIRED TO FULFILL THE OBLIGATIONS OF THE CONTRACTOR'S CONTRACT WITH THE CITY OF PHOENIX." THIS DOCUMENT MUST BE KEPT SECURE AT ALL TIMES.



THIS DRAWING MUST BE FIELD VERIFIED BEFORE USE DRAWING NOT TO SCALE UNLESS SCALE BAR IS PRESENT

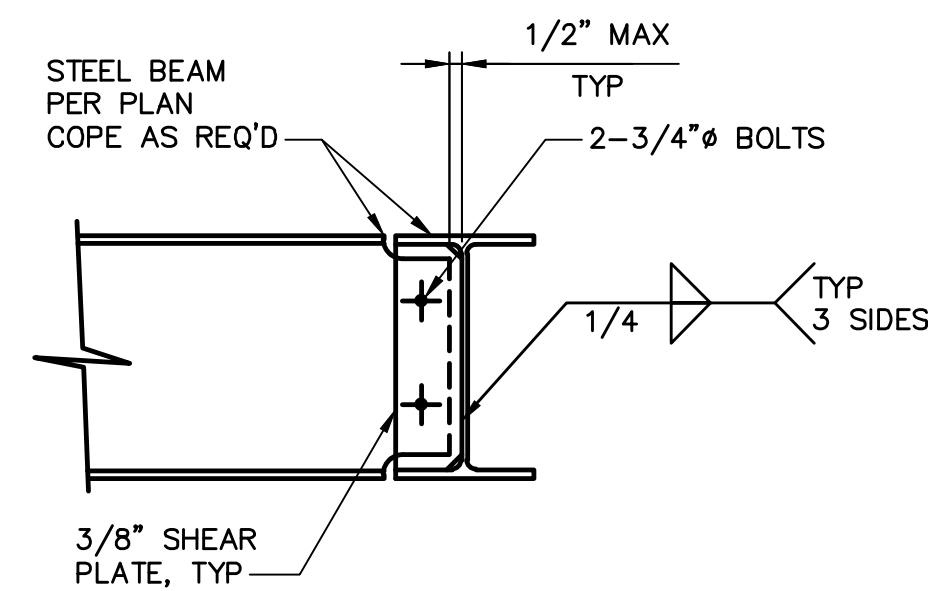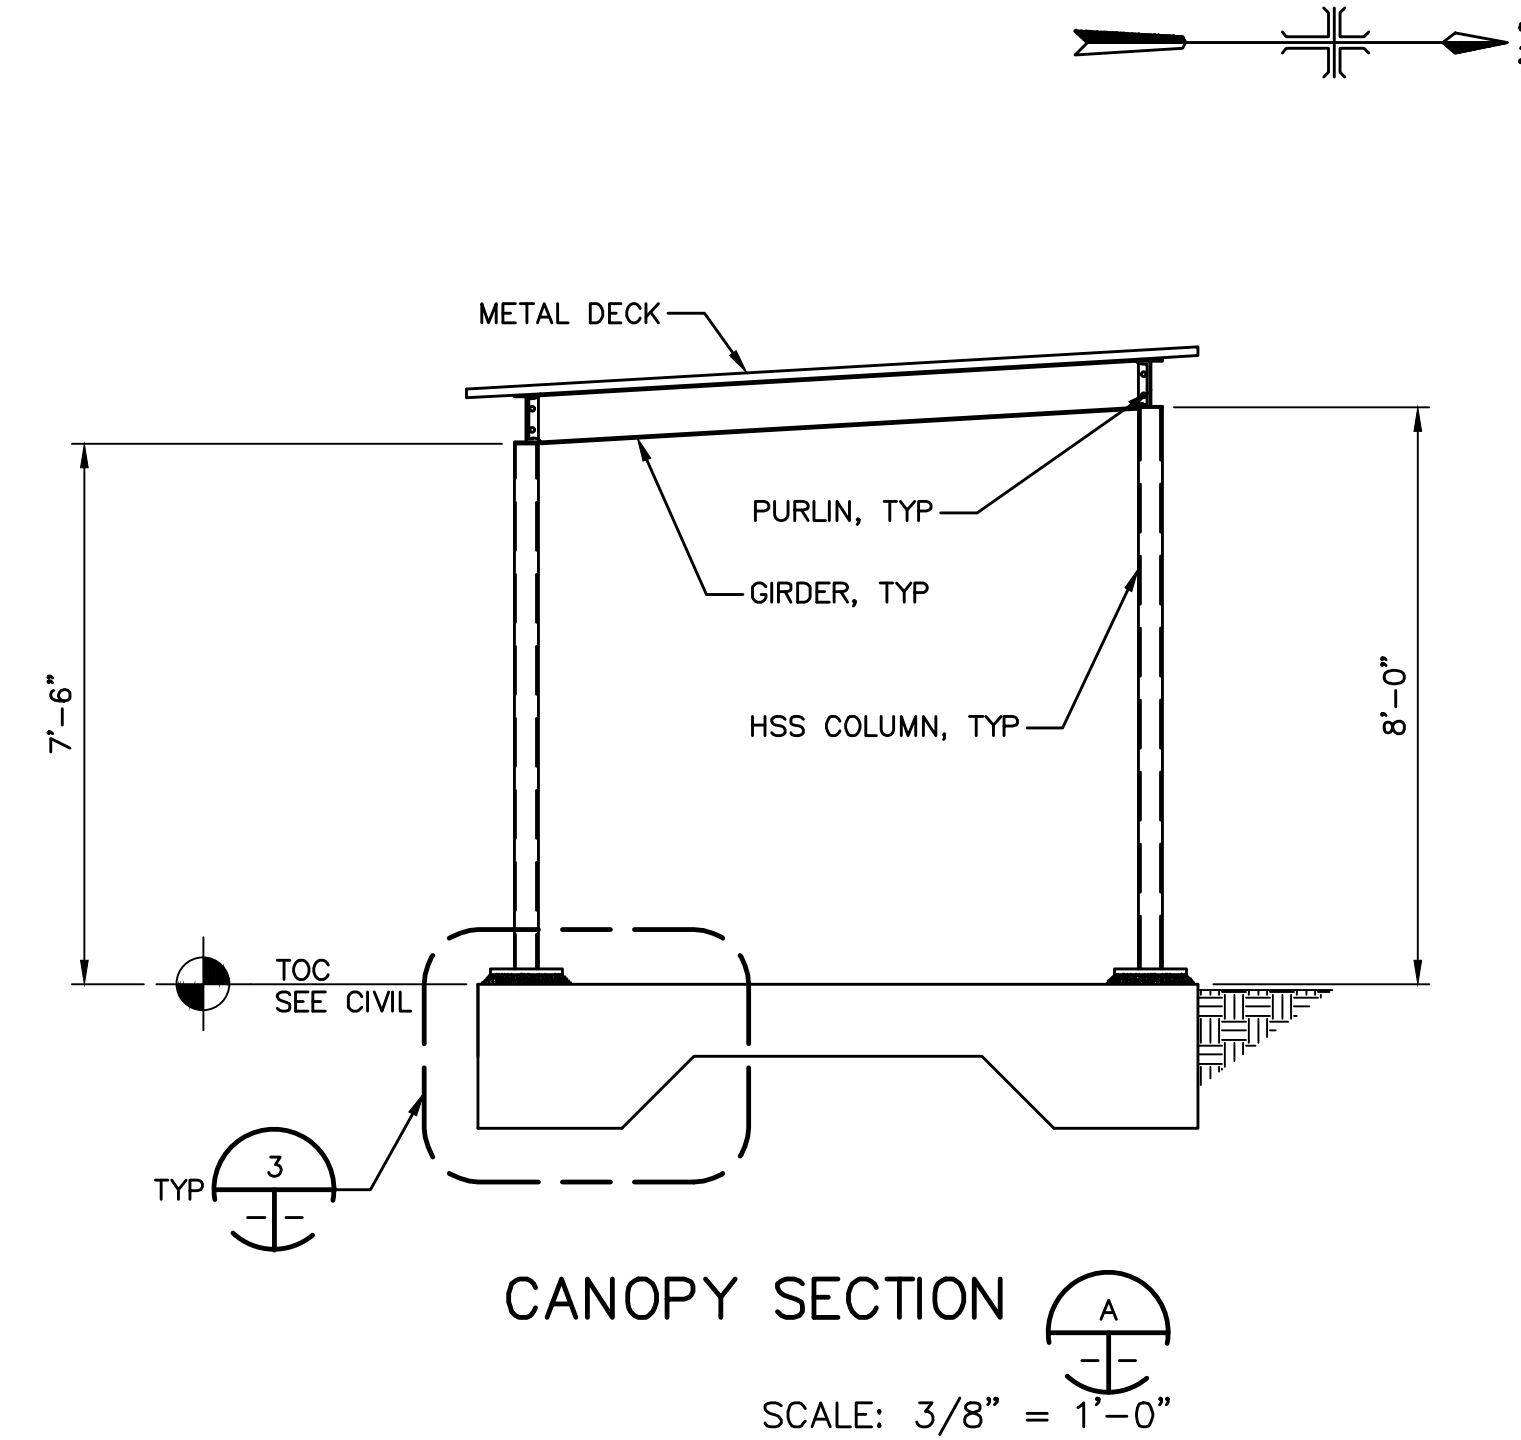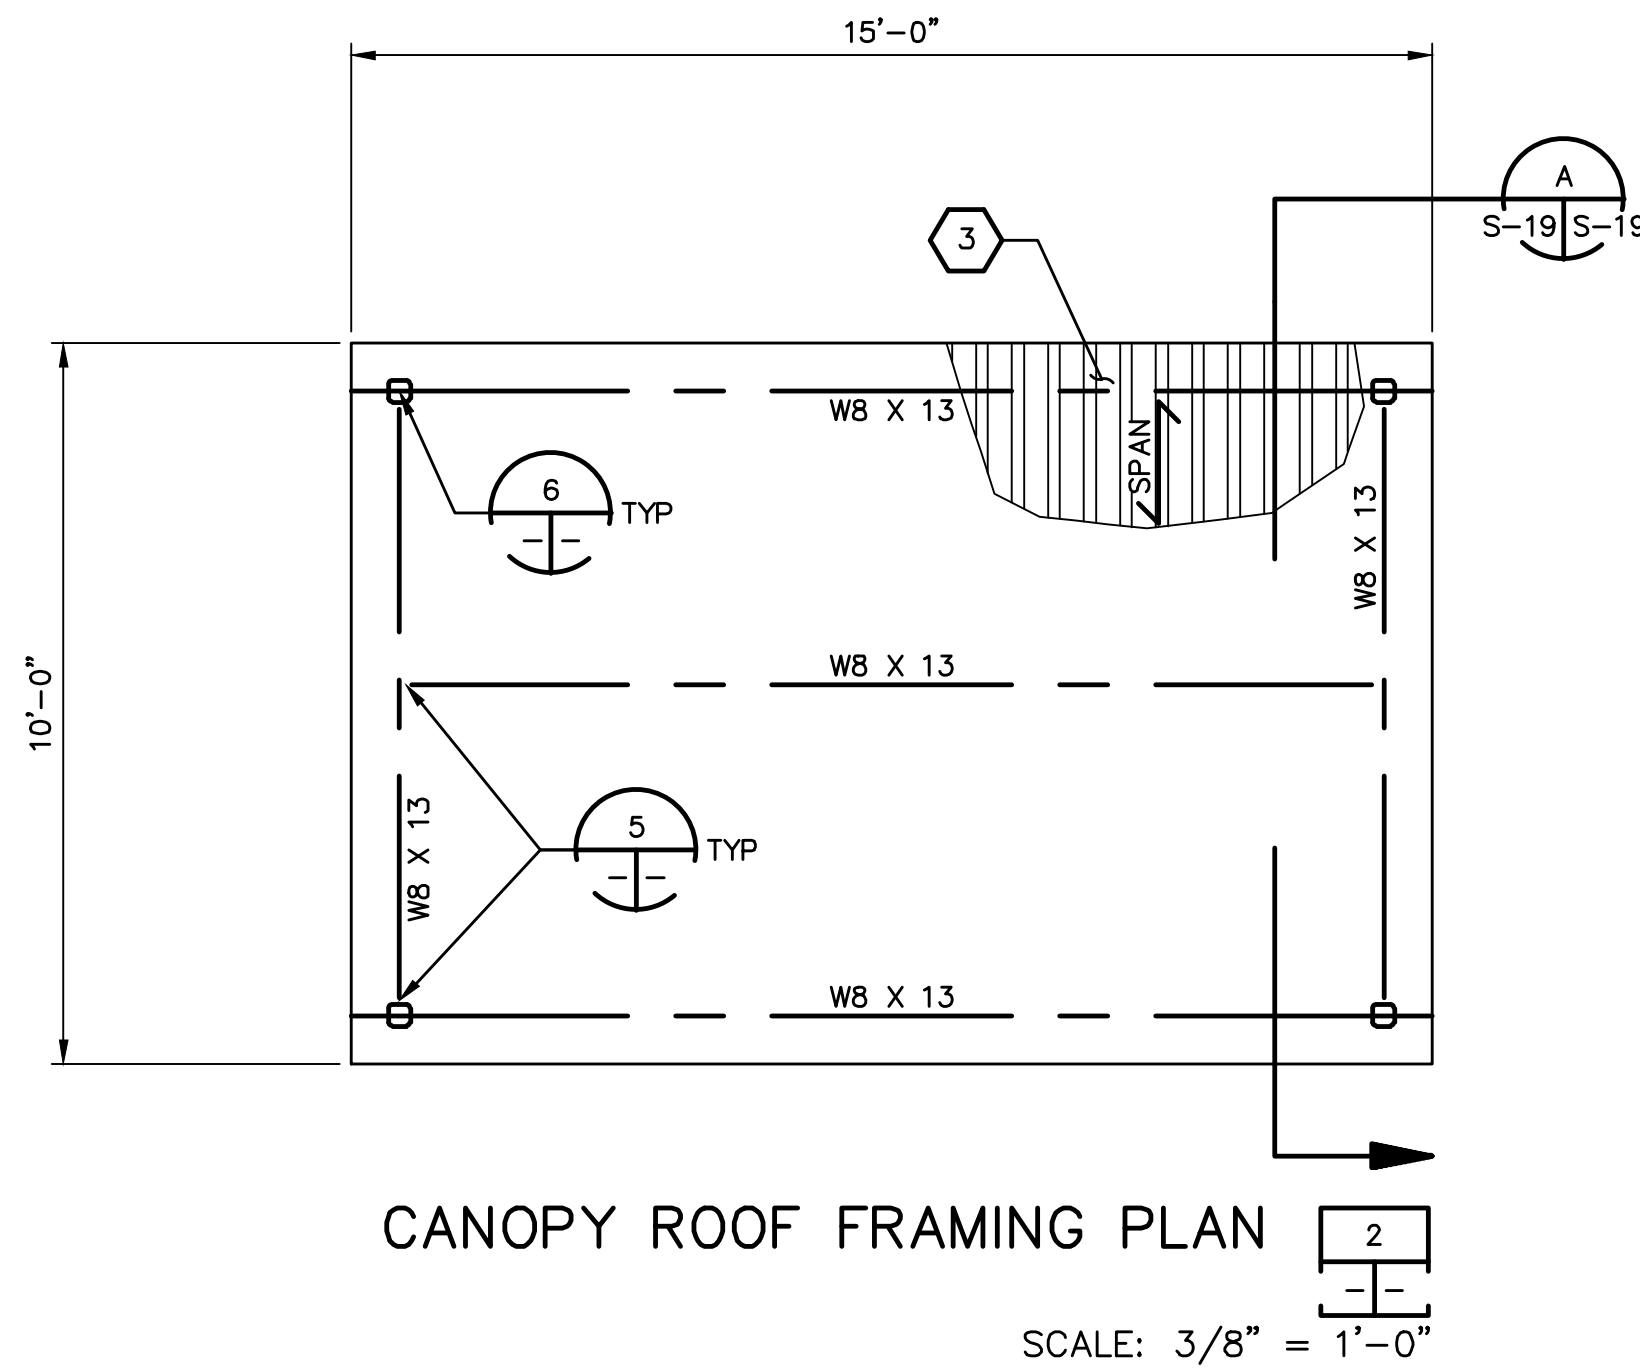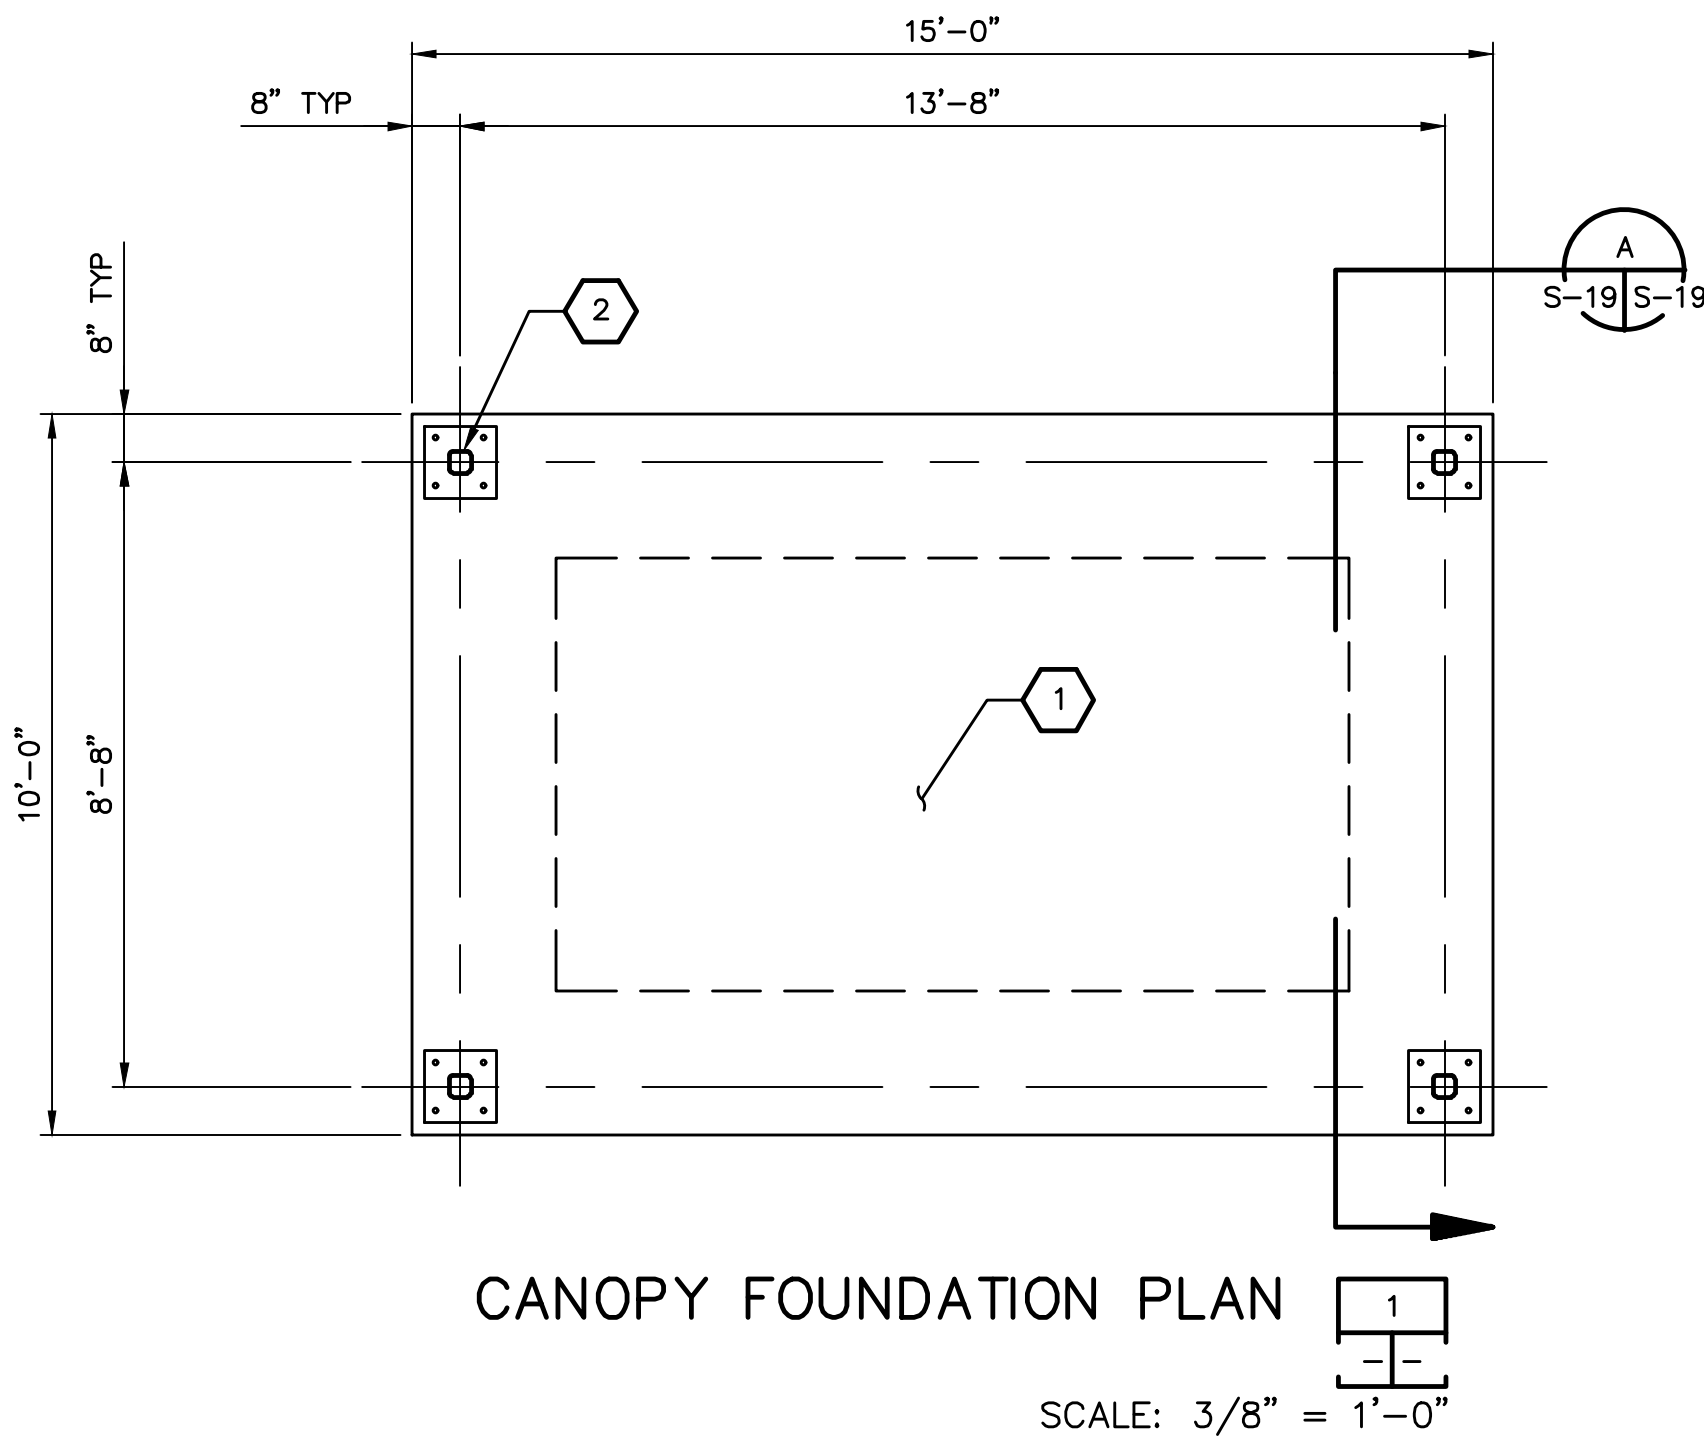

**BEAM-TO-BEAM CONNECTION**  
NOT TO SCALE

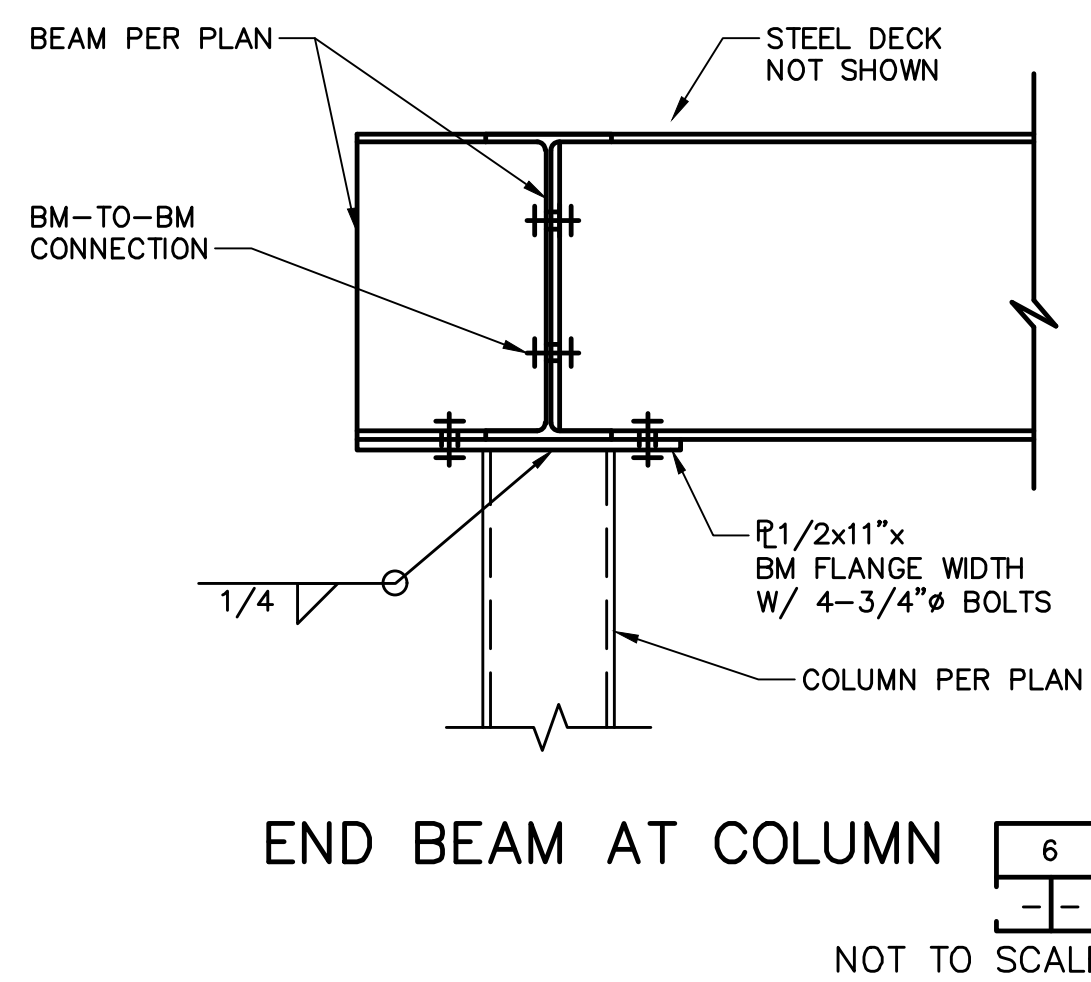

**END BEAM AT COLUMN**  
NOT TO SCALE

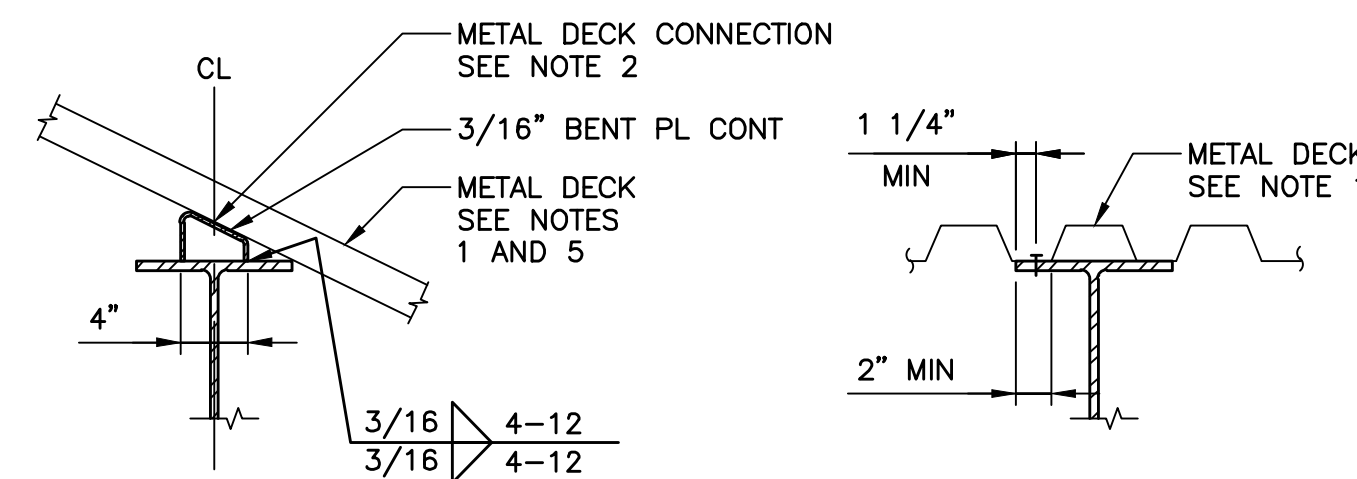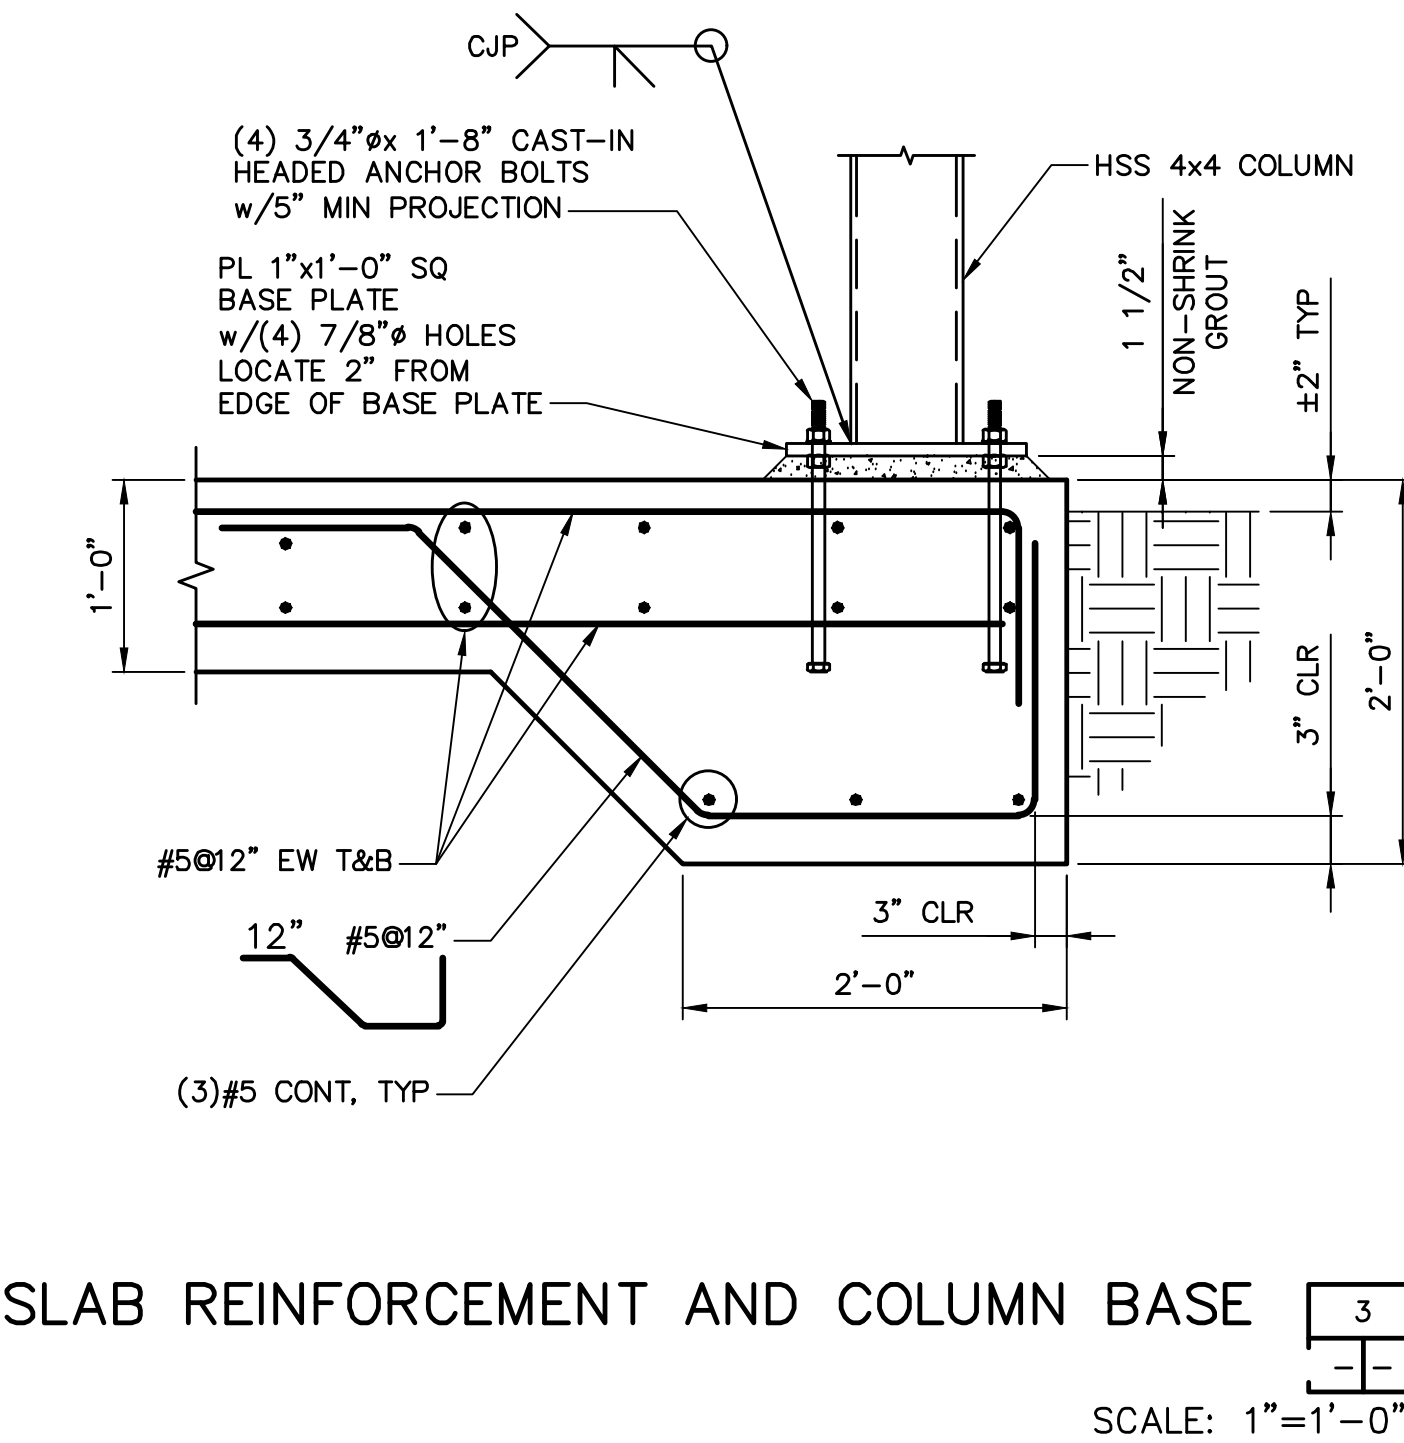

**METAL DECK CONNECTION**  
NOT TO SCALE

**NOTES:**

1. PROVIDE 36" WIDE X 1 1/2" DEEP 20 GA STEEL DECKING ATTACHED TO STRUCTURAL FRAMING PER THE SPECIFICATIONS.
2. EXTEND DECK 8" BEYOND OUTSIDE FACE OF BEAM AT TYPICAL EAVE CONDITION.
3. SEE SPECIFICATION SECTION 05 30 00 FOR ADDITIONAL INFORMATION.

**GENERAL NOTES**

1. STRUCTURAL DESIGN CRITERIA SHALL BE IN ACCORDANCE WITH THE REQUIREMENTS SHOWN ON SHEETS S-01.
2. SEE CIVIL DRAWINGS FOR STRUCTURE LOCATION AND COORDINATE POINTS.

FACILITY DRAWINGS  
This drawing was supplied by a Consultant Engineer from a past contractor and is not intended to be used for construction. The City does not warrant this drawing to be a complete and accurate portrayal of facilities as they exist in the field.

**KEY NOTES**

- 1 SHADE CANOPY FOUNDATION.
- 2 HSS 4x4x3/8 STEEL COLUMN AND BASE PLATE, TYPICAL. SEE 3 S-19 S-19
- 3 1 1/2" COATED METAL DECK PER SPECIFICATION SECTIONS 05 30 00 AND 09 96 00. ARROW ON PLAN INDICATES SPAN DIRECTION. FOR REQUIRED ATTACHMENT, SEE 4 S-19 S-19

REVISIONS					
NO.	BY	DATE	CKD	REMARKS	
A	RW	01/2024	TH	90% SUBMITTAL	DES RW
B	RW	04/2024	TH	AGENCY REVIEW	DWN
C	RW	08/2024	TH	ISSUED FOR CONSTRUCTION	RW
					CKD
					TH



CITY OF PHOENIX  
WATER SERVICES DEPARTMENT  
  
LIFT STATION 40  
REFURBISHMENT

STRUCTURAL  
  
STRUCTURAL  
SECTIONS AND DETAILS 3

COPYRIGHT © 2007--JANUARY  
CITY PROJECT NO. WS90400085  
DATE: 08/2024  
S-19 SHEET 75 OF 134  
CAD FILE: CSSL40007.dwg



USER: RWRIGHT FILE: C:\pwworking\west01\35411632\CSSL40007.dwg DATE: 8/28/24 TIME: 05:21pm

THIS DRAWING MUST BE FIELD VERIFIED BEFORE USE. DRAWING NOT TO SCALE UNLESS SCALE BAR IS PRESENT.

FOR CONSTRUCTION

\*PER CITY OF PHOENIX CODE CHAPTER 2-28, THESE PLANS ARE FOR OFFICIAL USE ONLY AND MAY NOT BE SHARED WITH OTHERS EXCEPT AS REQUIRED TO FULFILL THE OBLIGATIONS OF THE CONTRACTOR'S CONTRACT WITH THE CITY OF PHOENIX. THIS DOCUMENT MUST BE KEPT SECURE AT ALL TIMES.

**CODE ANALYSIS**

THIS PROJECT INVOLVES THE CONSTRUCTION OF A NEW ELECTRICAL EQUIPMENT BUILDING, OFFICE, AND UNISEX RESTROOM. THE FOLLOWING CODE ANALYSIS IS PROVIDED TO SERVE AS A BASIS OF UNDERSTANDING FOR THE DEVELOPMENT OF THE DESIGN, DRAWINGS AND SPECIFICATIONS FOR THIS PROJECT.

**REFERENCED CODES AND STANDARDS**

- INTERNATIONAL BUILDING CODE, 2018
- INTERNATIONAL PLUMBING CODE, 2018
- INTERNATIONAL MECHANICAL CODE, 2018
- NATIONAL ELECTRIC CODE, 2017
- INTERNATIONAL FIRE CODE, 2018
- INTERNATIONAL ENERGY CONSERVATION CODE, 2018

**BUILDING DESCRIPTION - PROVIDED**

TYPE IIB CONSTRUCTION (IBC)	IBC §602 & TABLE 601
TOTAL BUILDING AREA: APPROXIMATELY 1829 SQUARE FEET (SF)	IBC §502 BUILDING AREA DEFINITION
BUILDING HEIGHT AND STORIES: 16 FT AND 1 STORY	IBC §502 BUILDING HEIGHT DEFINITION

**BUILDING OCCUPANCY CLASSIFICATION**

IBC OCCUPANCY CLASSIFICATION	
GROUP U - UTILITY AND MISCELLANEOUS	IBC §312
NFPA OCCUPANCY CLASSIFICATION	
SPECIAL-PURPOSE INDUSTRIAL (LOW HAZZARD, LOW EMPLOYEE POPULATION, MUCH OF THE AREA OCCUPIED BY EQUIPMENT AND MACHINERY.)	NFPA CHAPTER 40.1.2.1.1

**SPECIAL OCCUPANCY REQUIREMENTS**

NONE	IBC §
------	-------

**ALLOWABLE IBC BUILDING HEIGHT AND FLOOR AREA:** (SEE BUILDING DESCRIPTION)

ALLOWABLE GROSS SQUARE FEET OF BUILDING: 8,500 SF (TYPE IIB, GROUP U, NON-SPRINKLERED)	IBC §506, TABLE 506.1
ALLOWABLE HEIGHT: 55 FEET AND 2 STORIES (TYPE IIB, GROUP U, NON-SPRINKLERED)	IBC §504.1 TABLES 504.3 & 504.4

**FIRE RESISTANCE REQUIREMENTS**

**IBC STRUCTURAL ELEMENTS: TYPE IIB**

BEARING WALLS EXTERIOR	0 HOUR	IBC §01 & TABLE 602 ALL ALLOWABLE COMBUSTIBLE MATERIALS AS DEFINED IN SECTION 603
BEARING WALLS INTERIOR	0 HOUR	
NONBEARING WALLS & PARTITIONS - INTERIOR	0 HOUR	
ROOF CONSTRUCTION (INCLUDING SUPPORTING BEAMS AND JOISTS)	0 HOUR	

NOTE: BASED UPON FIRE AREA GREATER THAN 30' FROM OTHER BUILDINGS(& PERIMETER BLOCK WALL), PER TABLE 602

**COMBUSTIBLE MATERIAL IN TYPES I & II CONSTRUCTION**

FIRE-RETARDANT-TREATED WOOD REQUIRED	IBC §603.1.1.1.3
--------------------------------------	------------------

**MEANS OF EGRESS**

HEADROOM-PROTRUDING OBJECTS MIN HEADROOM 80" FOR LESS THAN 50% OF PATH, 90" CLEAR OTHERWISE	IBC §1003.3.1
MIN EXIT PASSAGE AS COMPONENT OF MEANS OF EGRESS = WIDTH 36" CLEAR	IBC §1024.2

OCCUPANT COUNT: ROOM #	GROSS SF	PERSONS:
ELECTRICAL EQUIPMENT ROOM 100	1,300 GROSS	1,659
TOILET 101	40	0
<b>BUILDING CONSTRUCTION TOTAL:</b>	<b>1,699</b>	<b>6</b>

EQUIPMENT ROOM - EXIT TRAVEL DISTANCE WITH 2 EXITS= 200'	IBC §TABLE 1017.2
--	-------------------

**ACCESSIBILITY**

SPACE FREQUENTED ONLY BY SERVICE PERSONNEL FOR MAINTENANCE, REPAIR OR OCCASIONAL MONITORING OF EQUIPMENT ARE NOT REQUIRED TO COMPLY WITH ACCESSIBILITY CHAPTER 11.	IBC §1103.2.9
--	---------------

**FIRE PROTECTION SYSTEMS**

FIRE ALARM SYSTEM IS NOT REQUIRED	IBC §907.2.4
TYPE ABC MODERATE - PORTABLE FIRE EXTINGUISHERS REQUIRED, MINIMUM = 2 50' MAX TRAVEL DISTANCE	IBC TABLE §906.3(2); IBC §906.3.3
AUTOMATIC SPRINKLER SYSTEM IS NOT REQUIRED	IBC §903.2.4



**FIRE DEPARTMENT ACCESS & FIRE FLOW SITE REQUIREMENTS**

FIRE FLOW REQUIREMENTS	1,500 GPM (@20psi) - 2 HR DURATION	IFC TABLE §B105.1(2)
FIRE HYDRANT DISTANCE <= 600' FROM THE BUILDING		IFC §507.5.1, EXCEPTION 1
APPROVED FIRE APPARATUS ACCESS ROADS		IFC §503.1.1

**ENERGY CODE COMPLIANCE-2018 IECC**

CLIMATE ZONE 2 TABLE C402.1.3. R-VALUE TABLE C402.1.4 U-FACTOR ALL OTHER	
ROOF INSULATION ENTIRELY ABOVE DECK	R-25ci
WALLS - ABOVE GRADE MASS	SUB-NOTE c. AMINOPLAST MASONRY FOAM INSULATION = 0.217 THERMAL CONDUCTIVITY
WALLS - BELOW GRADE	NR
FLOORS - SLAB ON GRADE UNHEATED SLABS	NR
DOORS (OPAQUE) SWINGING	U-0.83 IECC TABLE 402.4

NOTE: SEE COMcheck REPORT  
SUB-NOTE c. R-5.7ci IS ALLOWED TO BE SUBSTITUTED WITH CONCRETE BLOCK WALLS COMPLYING WITH ATSM C90, UNGROUTED OR PARTIALLY GROUTED AT 32" OR LESS ON CENTER VERTICALLY AND 48" OR LESS ON CENTER HORIZONTALLY, WITH UNGROUTED CORES FILLED WITH MATERIALS HAVING A MAXIMUM THERMAL CONDUCTIVITY OF 0.44 Btu-in/h-(SQUARED) DEGREES FARENHEIGHT.

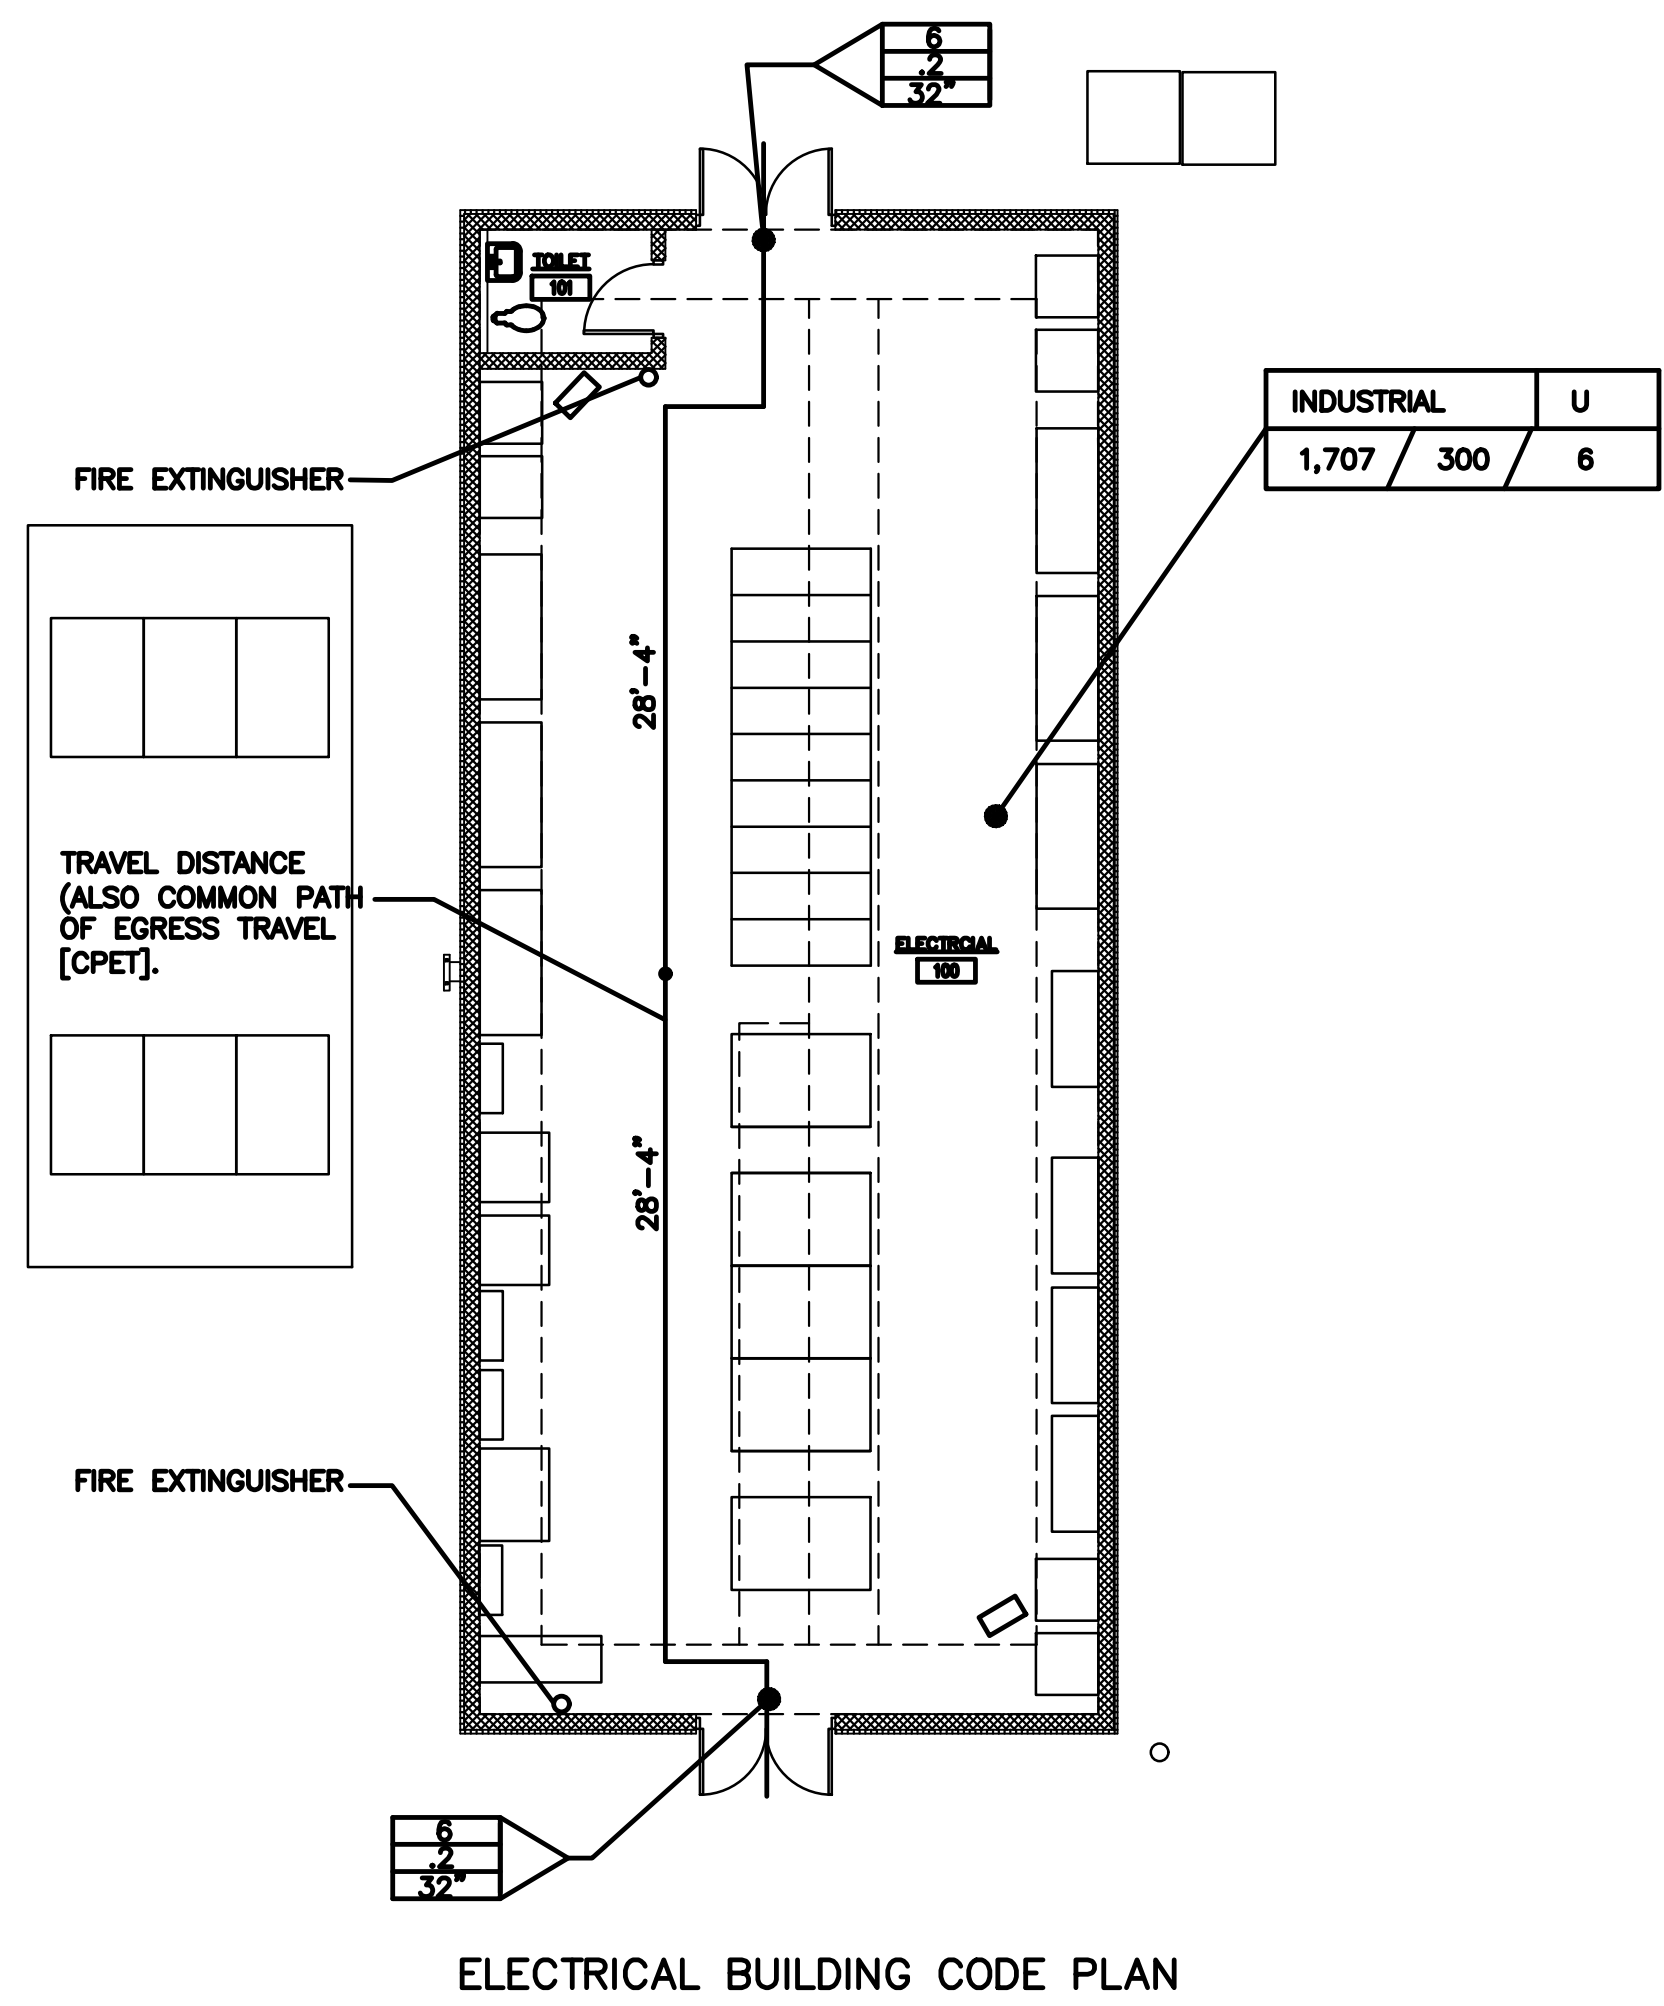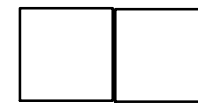


ELECTRICAL BUILDING CODE PLAN


**GENERAL NOTES**

- SEE A-09 FOR ROOM FINISH AND DOOR SCHEDULES.
- SEE STRUCTURAL PLANS FOR FLOOR ELEVATIONS.
- SEE EXTERIOR ELEVATIONS FOR FINISH, CONTROL JOINTS AND REVEAL LOCATIONS.
- ALL DIMENSIONS ARE ACTUAL AND ARE FACE OF MASONRY UNLESS NOTED OTHERWISE. ALL DIMENSIONS ARE FOR BIDDING PURPOSES ONLY. ACTUAL FIELD DIMENSIONS SHALL BE VERIFIED PRIOR TO SUBMITTAL OF SHOP DRAWINGS, ORDERING RELATED MATERIALS AND PERFORMING CONSTRUCTION WORK.
- VERIFY MECHANICAL AND ELECTRICAL DRAWINGS FOR SCOPE AND INTERFACE. CONTRACTOR SHALL COORDINATE LOCATION FOR ALL MECHANICAL AND ELECTRICAL ITEMS WITH GENERAL CONSTRUCTION REVIEW. NOTIFY ENGINEER WITH ANY DISCREPANCIES.
- LOCATE CONTROL JOINTS WHERE SHOWN ON THE PLANS AND ELEVATIONS. LOCATE CONTROL JOINTS AS SPECIFICALLY NOTED OR PER INDUSTRY STANDARDS.
- ARCHITECTURAL FINISH FLOOR FOR REFERENCE IS 100.00'.
- ALL ANGLES ON PLAN ARE 90 DEGREES UNLESS NOTED OTHERWISE.
- CONTRACTOR SHALL FIELD VERIFY ALL CONDITIONS BEFORE ORDERING MATERIALS.
- CONTRACTOR SHALL NOTIFY ENGINEER OF DISCREPANCIES OR UNKNOWN FOUND CONDITIONS.

FACILITY DRAWINGS  
This drawing was supplied by a Consultant Engineer from a project construction unless noted otherwise. All information provided by the Contractor to provide the Record Drawing. The City does not warrant this drawing to be a complete and accurate portrayal of facilities as they exist in the field.

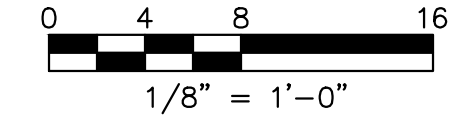

REVISIONS					
NO.	BY	DATE	CKD	REMARKS	
B	JWG	1/2024	JWG	90% SUBMITTAL	DES JWG
C	JWG	04/2024	JWG	AGENCY REVIEW	DWN
D	JWG	8/2024	JWG	ISSUED FOR CONSTRUCTION	JRL
*					CKD
*					JWG

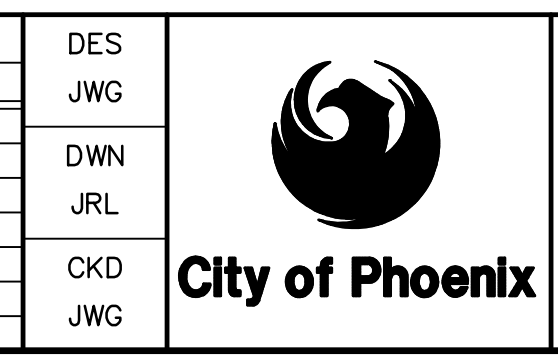

CITY OF PHOENIX  
WATER SERVICES DEPARTMENT  
  
LIFT STATION 40  
REFURBISHMENT

ARCHITECTURAL  
  
ELECTRICAL BUILDING  
LIFE SAFETY AND CODES

COPYRIGHT © 2007 - JANUARY  
CITY PROJECT NO. WS90400085  
DATE: 04/2024  
A-01 SHEET 76 OF 134  
CAD FILE: CSAL40A01.DWG


USER: JGRIFFIN FILE: C:\WORKING\west01\36304\6666\CSAL40A01.dwg DATE: 8/28/24 TIME: 08:17am

THIS DRAWING MUST BE FIELD VERIFIED BEFORE USE  
DRAWING NOT TO SCALE UNLESS SCALE BAR IS PRESENT


FOR CONSTRUCTION

"PER CITY OF PHOENIX CODE CHAPTER 2, SECTION 2-28, THESE PLANS ARE FOR OFFICIAL USE ONLY AND MAY NOT BE SHARED WITH OTHERS EXCEPT AS REQUIRED TO FULFILL THE OBLIGATIONS OF THE CONTRACTOR'S CONTRACT WITH THE CITY OF PHOENIX."  
THIS DOCUMENT MUST BE KEPT SECURE AT ALL TIMES.

**1 FLOOR PLAN**  
SCALE: 1/4" = 1'-0"

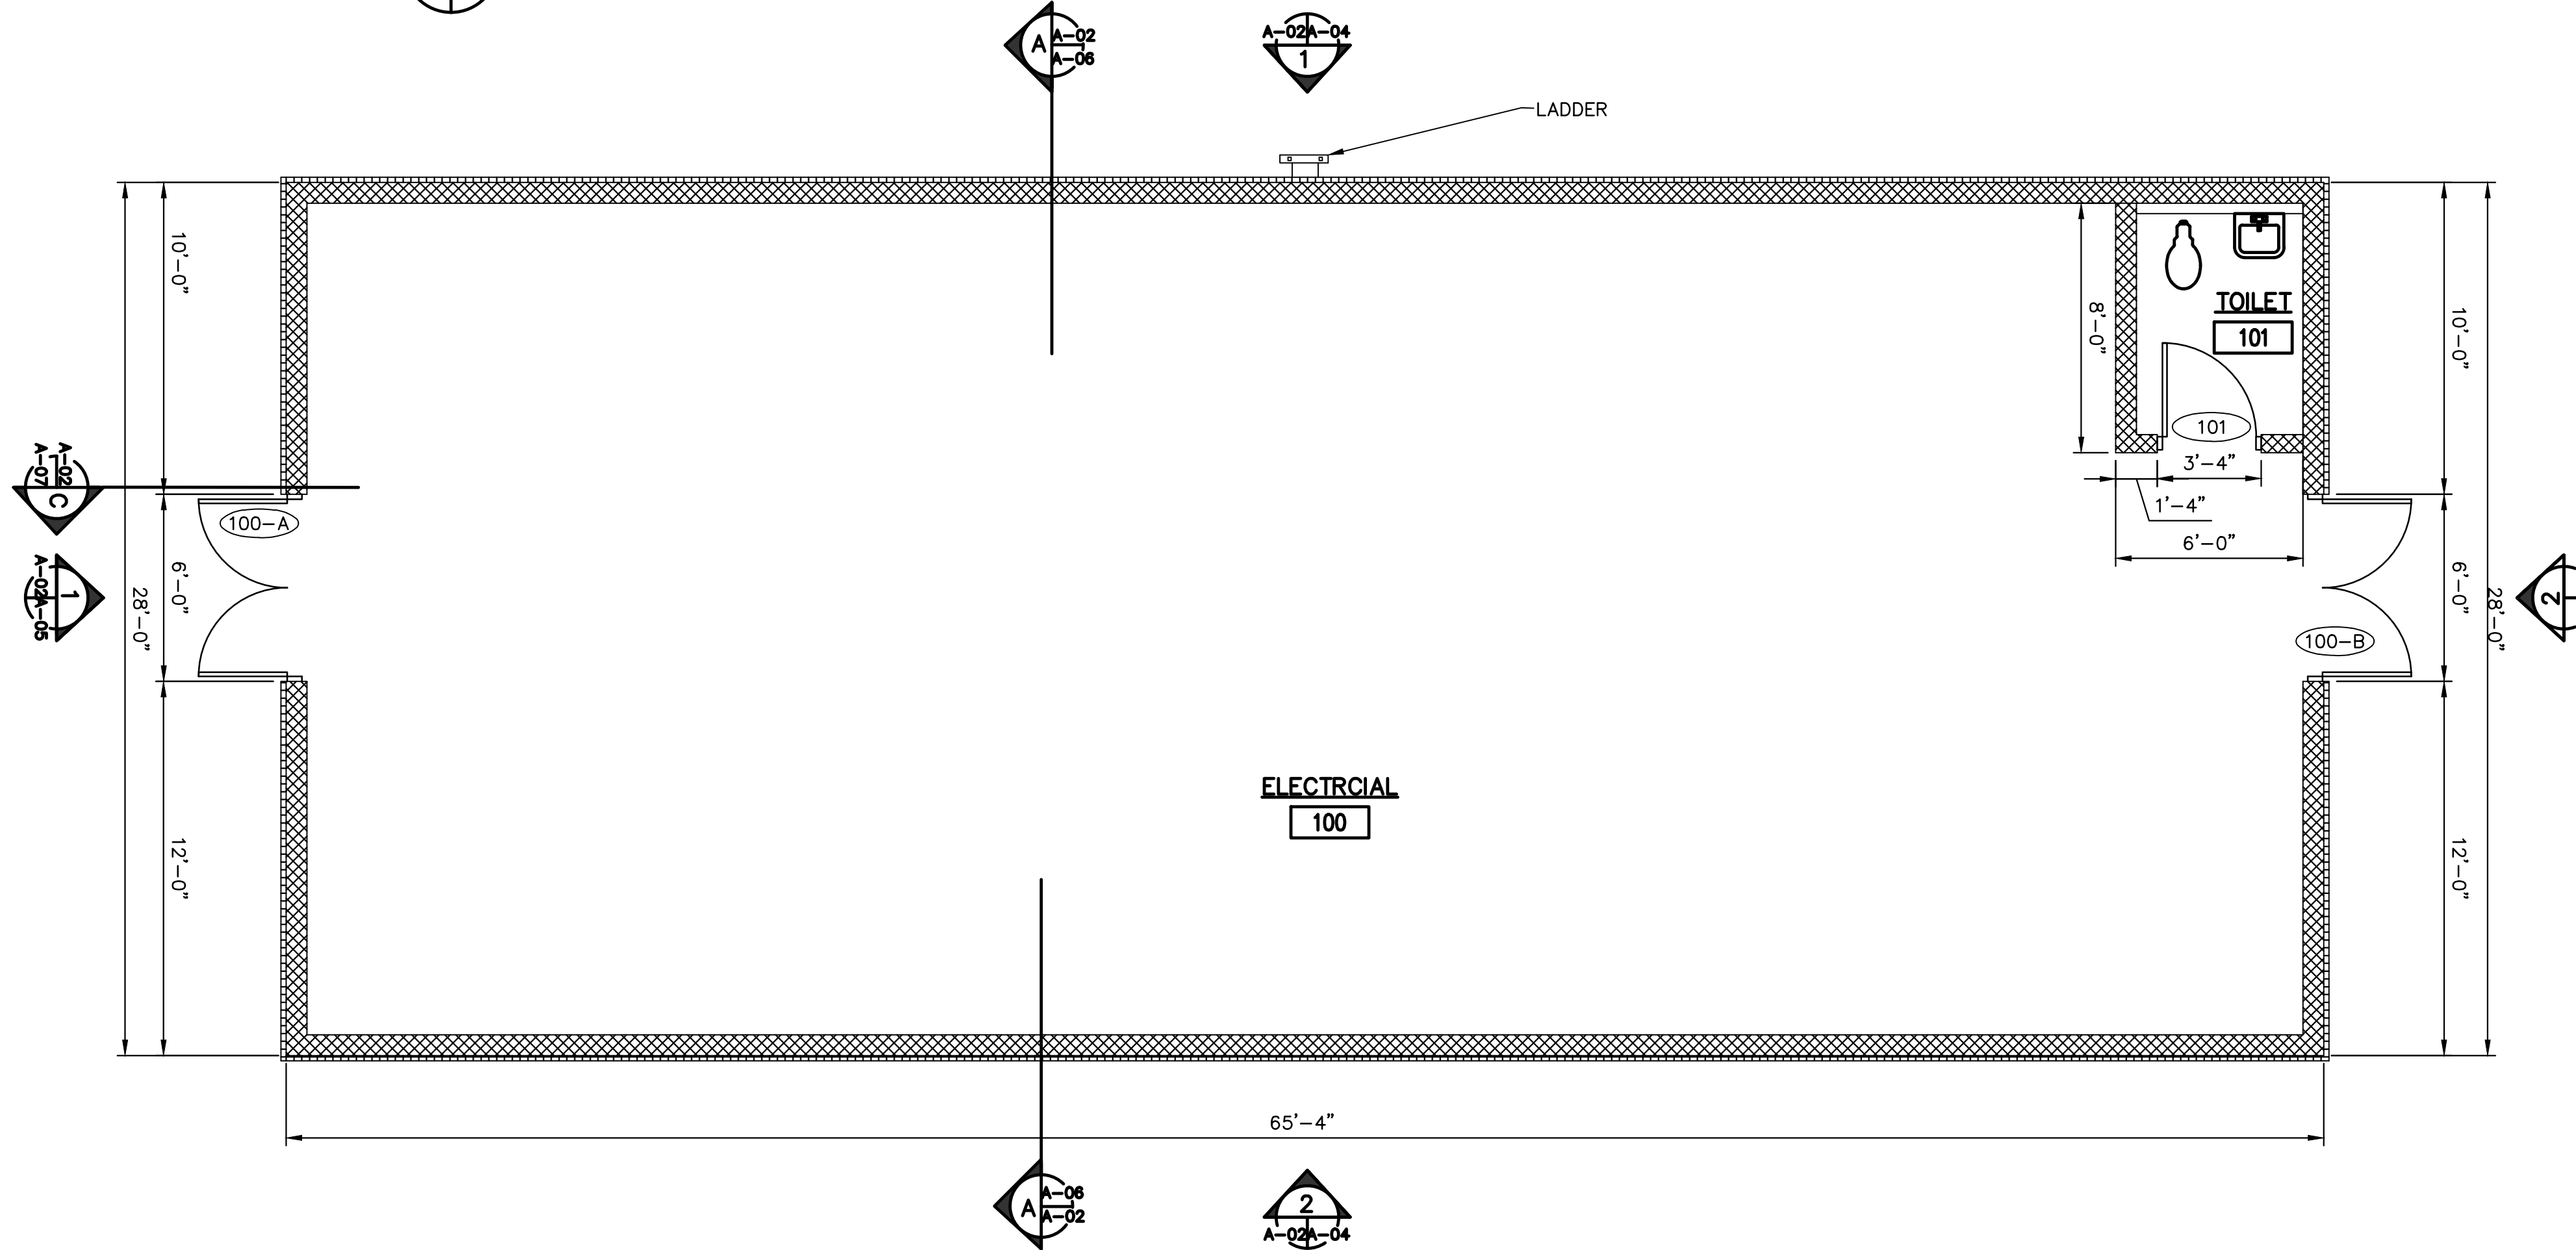


**2 TOILET ELEVATIONS**  
SCALE: 1/4" = 1'-0"

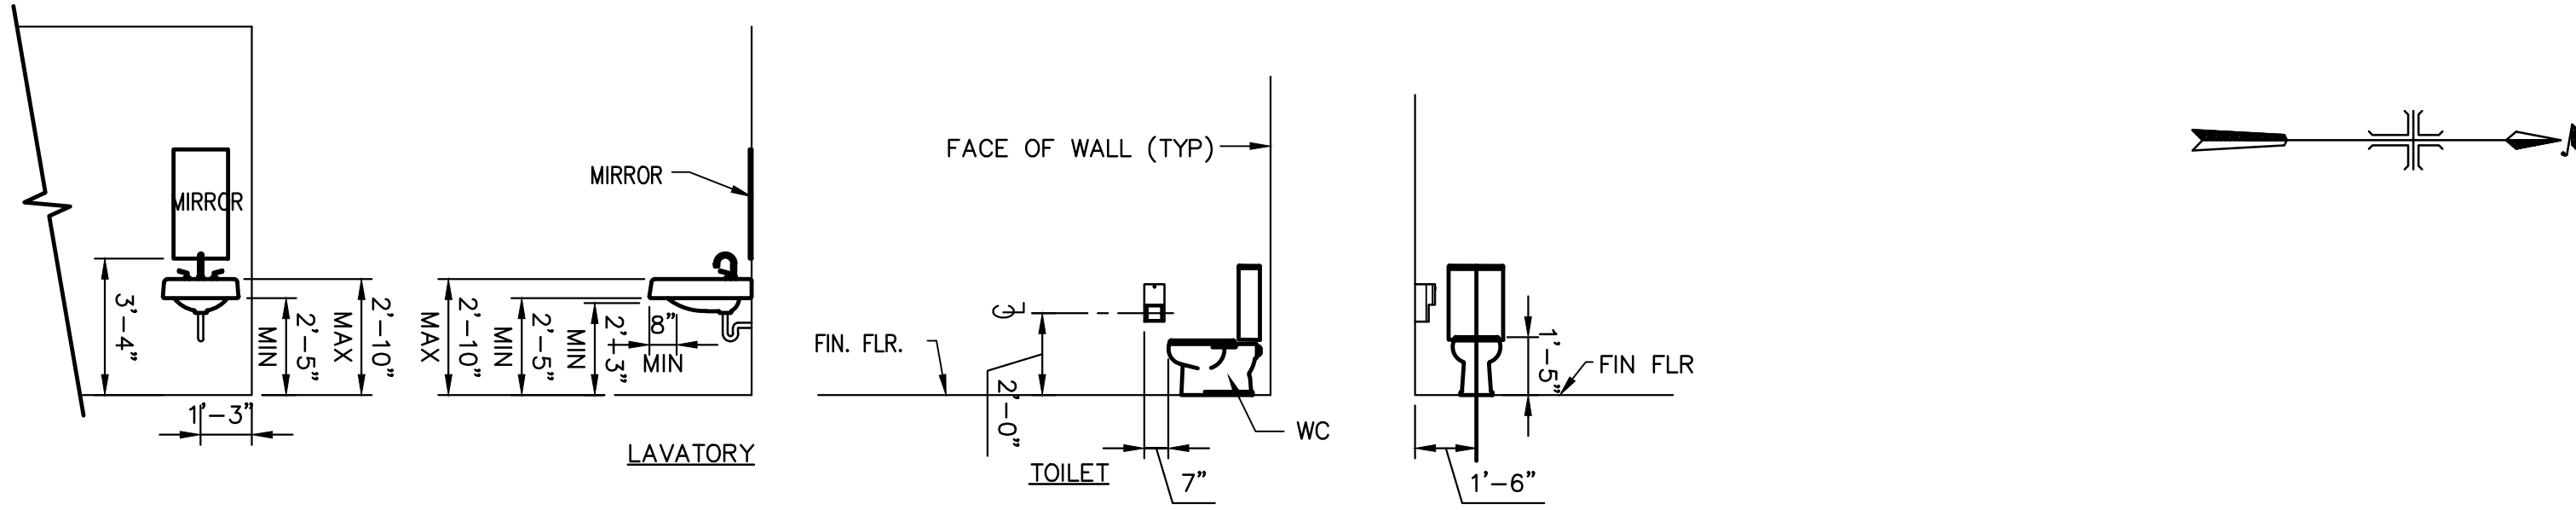

GENERAL NOTES

- SEE A-09 FOR ROOM FINISH AND DOOR SCHEDULES.
- SEE STRUCTURAL PLANS FOR FLOOR ELEVATIONS.
- SEE EXTERIOR ELEVATIONS FOR FINISH, CONTROL JOINTS AND REVEAL LOCATIONS.
- ALL DIMENSIONS ARE ACTUAL AND ARE FACE OF MASONRY UNLESS NOTED OTHERWISE. ALL DIMENSIONS ARE FOR BIDDING PURPOSES ONLY. ACTUAL FIELD DIMENSIONS SHALL BE VERIFIED PRIOR TO SUBMITTAL OF SHOP DRAWINGS, ORDERING RELATED MATERIALS AND PERFORMING CONSTRUCTION WORK.
- VERIFY MECHANICAL AND ELECTRICAL DRAWINGS FOR SCOPE AND INTERFACE. CONTRACTOR SHALL COORDINATE LOCATION FOR ALL MECHANICAL AND ELECTRICAL ITEMS WITH GENERAL CONSTRUCTION REVIEW, NOTIFY ENGINEER WITH ANY DISCREPANCIES
- LOCATE CONTROL JOINTS WHERE SHOWN ON THE PLANS AND ELEVATIONS. LOCATE CONTROL JOINTS AS SPECIFICALLY NOTED OR PER INDUSTRY STANDARDS.
- ARCHITECTURAL FINISH FLOOR FOR REFERENCE IS 100.00'.
- ALL ANGLES ON PLAN ARE 90 DEGREES UNLESS NOTED OTHERWISE.
- CONTRACTOR SHALL FIELD VERIFY ALL CONDITIONS BEFORE ORDERING MATERIALS.
- CONTRACTOR SHALL NOTIFY ENGINEER OF DISCREPANCIES OR UNKNOWN FOUND CONDITIONS.
- MECHANICAL AND ELECTRICAL EQUIPMENT IS SHOWN FOR REFERENCE ONLY. SEE MECHANICAL AND ELECTRICAL SHEETS

FACILITY DRAWINGS  
This drawing was supplied by a Consultant Engineer from a past project. The Consultant Engineer is not responsible for the accuracy of the information provided by the Contractor to provide the Record Drawing. The City does not warrant this drawing to be a complete and accurate portrayal of facilities as they exist in the field.

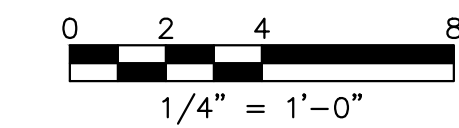

REVISION #	FOR CITY OF PHOENIX USE ONLY	COMPANY	PROJECT NO.	PROJECT NAME	DATE	CAD FILE NAME	DWG NUMBER	REMARKS
1								
2								



REVISIONS					DES
NO.	BY	DATE	CKD	REMARKS	JWG
B	JWG	1/2024	JWG	90% SUBMITTAL	DWN
C	JWG	04/2024	JWG	AGENCY REVIEW	JRL
D	JWG	8/2024	JWG	ISSUED FOR CONSTRUCTION	CKD
*					JWG
*					
*					



CITY OF PHOENIX  
WATER SERVICES DEPARTMENT  
  
LIFT STATION 40  
REFURBISHMENT

ARCHITECTURAL  
ELECTRICAL BUILDING  
FLOOR PLAN



COPYRIGHT © 2007 - JANUARY  
CITY PROJECT NO. WS90400085  
DATE: 04/2024  
A-02 SHEET 77 OF 134  
CAD FILE: CSALS40P02.DWG

THIS DRAWING MUST BE FIELD VERIFIED BEFORE USE  
DRAWING NOT TO SCALE UNLESS SCALE BAR IS PRESENT

FOR CONSTRUCTION

\*PER CITY OF PHOENIX CODE CHAPTER 2, SECTION 2-28, THESE PLANS ARE FOR OFFICIAL USE ONLY AND MAY NOT BE SHARED WITH OTHERS EXCEPT AS REQUIRED TO FULFILL THE OBLIGATIONS OF THE CONTRACTOR'S CONTRACT WITH THE CITY OF PHOENIX. THIS DOCUMENT MUST BE KEPT SECURE AT ALL TIMES.

1 ROOF PLAN  
A03 SCALE: 1/4" = 1'-0"

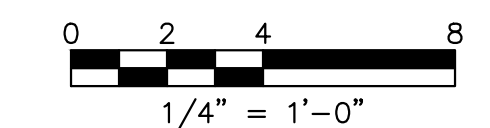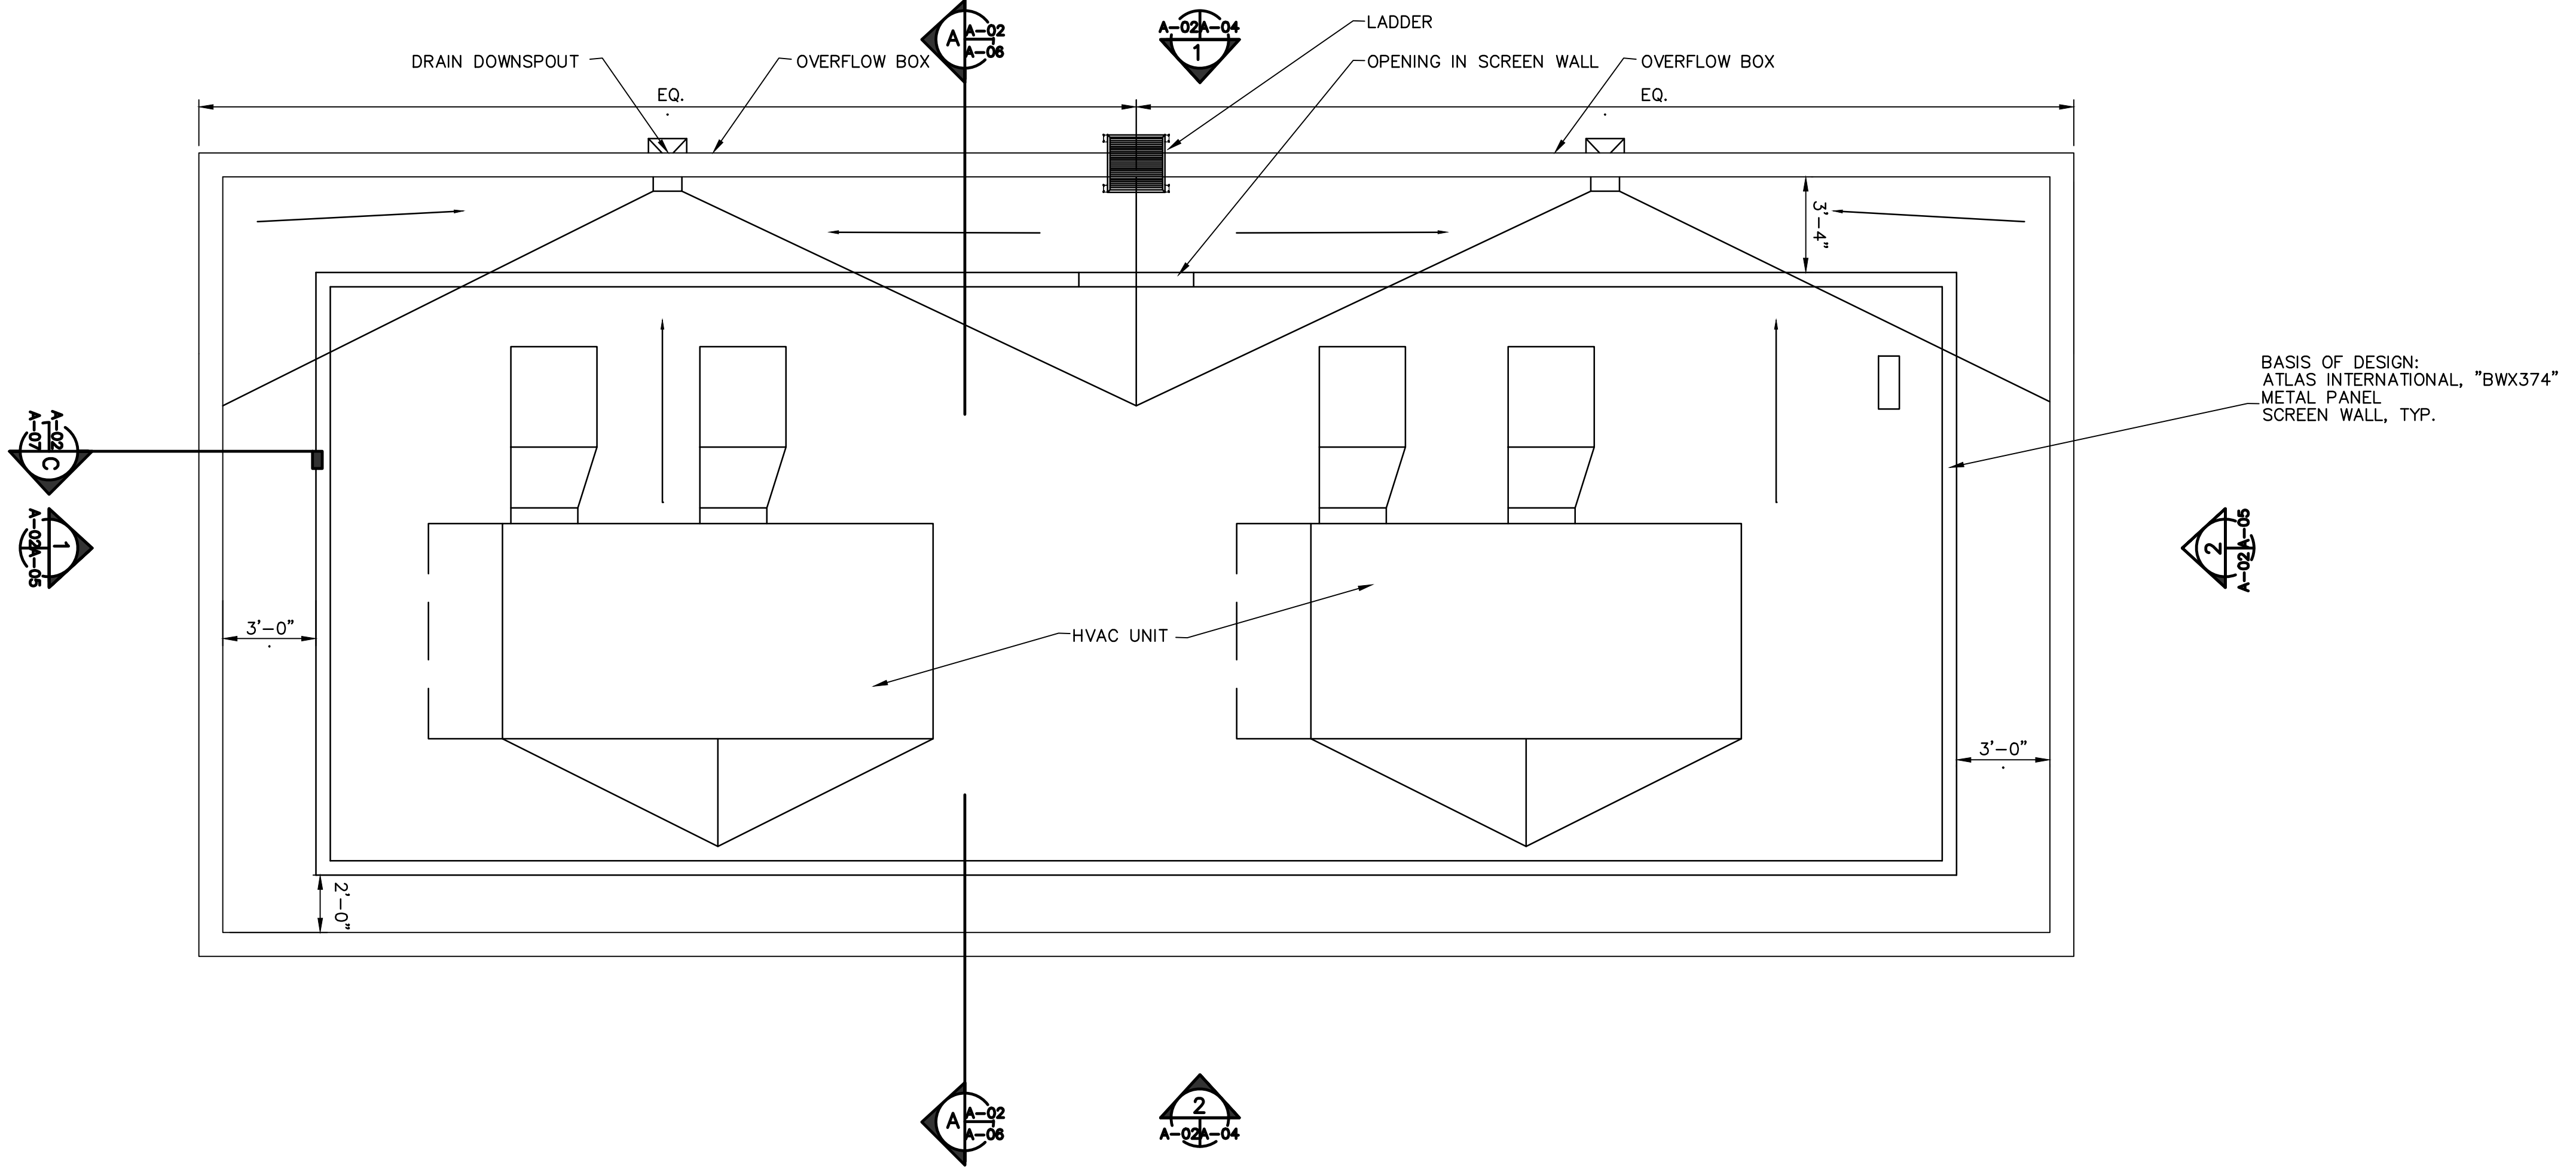

GENERAL NOTES


- SEE A-09 FOR ROOM FINISH AND DOOR SCHEDULES.
- SEE STRUCTURAL PLANS FOR FLOOR ELEVATIONS.
- SEE EXTERIOR ELEVATIONS FOR FINISH, CONTROL JOINTS AND REVEAL LOCATIONS.
- ALL DIMENSIONS ARE ACTUAL AND ARE FACE OF MASONRY UNLESS NOTED OTHERWISE. ALL DIMENSIONS ARE FOR BIDDING PURPOSES ONLY. ACTUAL FIELD DIMENSIONS SHALL BE VERIFIED PRIOR TO SUBMITTAL OF SHOP DRAWINGS. ORDERING RELATED MATERIALS AND PERFORMING CONSTRUCTION WORK.
- VERIFY MECHANICAL AND ELECTRICAL DRAWINGS FOR SCOPE AND INTERFACE. CONTRACTOR SHALL COORDINATE LOCATION FOR ALL MECHANICAL AND ELECTRICAL ITEMS WITH GENERAL CONSTRUCTION REVIEW, NOTIFY ENGINEER WITH ANY DISCREPANCIES
- LOCATE CONTROL JOINTS WHERE SHOWN ON THE PLANS AND ELEVATIONS. LOCATE CONTROL JOINTS AS SPECIFICALLY NOTED OR PER INDUSTRY STANDARDS.
- ARCHITECTURAL FINISH FLOOR FOR REFERENCE IS 100.00'.
- ALL ANGLES ON PLAN ARE 90 DEGREES UNLESS NOTED OTHERWISE.
- CONTRACTOR SHALL FIELD VERIFY ALL CONDITIONS BEFORE ORDERING MATERIALS.
- CONTRACTOR SHALL NOTIFY ENGINEER OF DISCREPANCIES OR UNKNOWN FOUND CONDITIONS.

FACILITY DRAWINGS  
This drawing was supplied by a Consultant, Engineer, from a past construction project. It is based on information provided by the Contractor to provide a complete and accurate portrayal of facilities as they exist in the field.  
The City does not warrant this drawing to be a complete and accurate

REVISION	DATE	CAD FILE NAME	DWG NUMBER	REMARKS



REVISIONS				
NO.	BY	DATE	CKD	REMARKS
B	JWG	1/2024	JWG	90% SUBMITTAL
C	JWG	04/2024	JWG	AGENCY REVIEW
D	JWG	6/2024	JWG	ISSUED FOR CONSTRUCTION

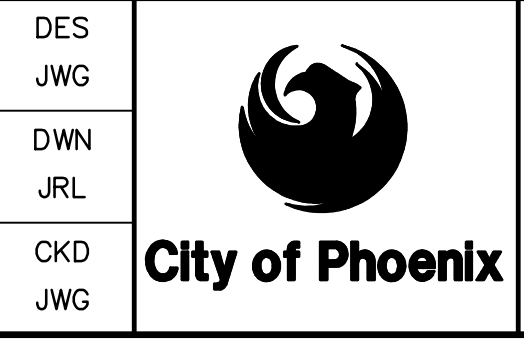

CITY OF PHOENIX  
WATER SERVICES DEPARTMENT  
  
LIFT STATION 40  
REFURBISHMENT

ARCHITECTURAL  
  
ELECTRICAL BUILDING  
ROOF PLAN  
  
COPYRIGHT © 2007-JANUARY  
CITY PROJECT NO. WS90400085  
DATE: 04/2024  
A-03 SHEET 78 OF 134  
CAD FILE: CSALS40P03.DWG

USER: JGRIFFIN FILE: C:\P\WORKING\west01\cs418688\CSALS40P03.dwg DATE: 8/28/24 TIME: 08:23am

THIS DRAWING MUST BE FIELD VERIFIED BEFORE USE  
DRAWING NOT TO SCALE UNLESS SCALE BAR IS PRESENT

FOR CONSTRUCTION


\*PER CITY OF PHOENIX CODE CHAPTER 2, SECTION 2-28, THESE PLANS ARE FOR OFFICIAL USE ONLY AND MAY NOT BE SHARED WITH OTHERS EXCEPT AS REQUIRED TO FULFILL THE OBLIGATIONS OF THE CONTRACTOR'S CONTRACT WITH THE CITY OF PHOENIX. THIS DOCUMENT MUST BE KEPT SECURE AT ALL TIMES.

EIFS COLOR KEY		
#	HATCH	MATERIAL TYPE
①		SW7572 LOTUS
②		SW2803 ROCK WOOD TERRA


GENERAL NOTES

- SEE A-09 FOR ROOM FINISH AND DOOR SCHEDULES.
- SEE STRUCTURAL PLANS FOR FLOOR ELEVATIONS.
- SEE EXTERIOR ELEVATIONS FOR FINISH, CONTROL JOINTS AND REVEAL LOCATIONS.
- ALL DIMENSIONS ARE ACTUAL AND ARE FACE OF MASONRY UNLESS NOTED OTHERWISE. ALL DIMENSIONS ARE FOR BIDDING PURPOSES ONLY. ACTUAL FIELD DIMENSIONS SHALL BE VERIFIED PRIOR TO SUBMITTAL OF SHOP DRAWINGS, ORDERING RELATED MATERIALS AND PERFORMING CONSTRUCTION WORK.
- VERIFY MECHANICAL AND ELECTRICAL DRAWINGS FOR SCOPE AND INTERFACE. CONTRACTOR SHALL COORDINATE LOCATION FOR ALL MECHANICAL AND ELECTRICAL ITEMS WITH GENERAL CONSTRUCTION REVIEW. NOTIFY ENGINEER WITH ANY DISCREPANCIES
- LOCATE CONTROL JOINTS WHERE SHOWN ON THE PLANS AND ELEVATIONS. LOCATE CONTROL JOINTS AS SPECIFICALLY NOTED OR PER INDUSTRY STANDARDS.
- ARCHITECTURAL FINISH FLOOR FOR REFERENCE IS 100.00'.
- ALL ANGLES ON PLAN ARE 90 DEGREES UNLESS NOTED OTHERWISE.
- CONTRACTOR SHALL FIELD VERIFY ALL CONDITIONS BEFORE ORDERING MATERIALS.
- CONTRACTOR SHALL NOTIFY ENGINEER OF DISCREPANCIES OR UNKNOWN FOUND CONDITIONS.


FACILITY DRAWINGS  
This drawing was supplied by a Consultant Engineer from a past construction project. The original construction drawing was modified based on information provided by the Contractor to provide the Record Drawing. The City does not warrant the accuracy and completeness of the drawings and accuracy of facilities as they exist in the field.

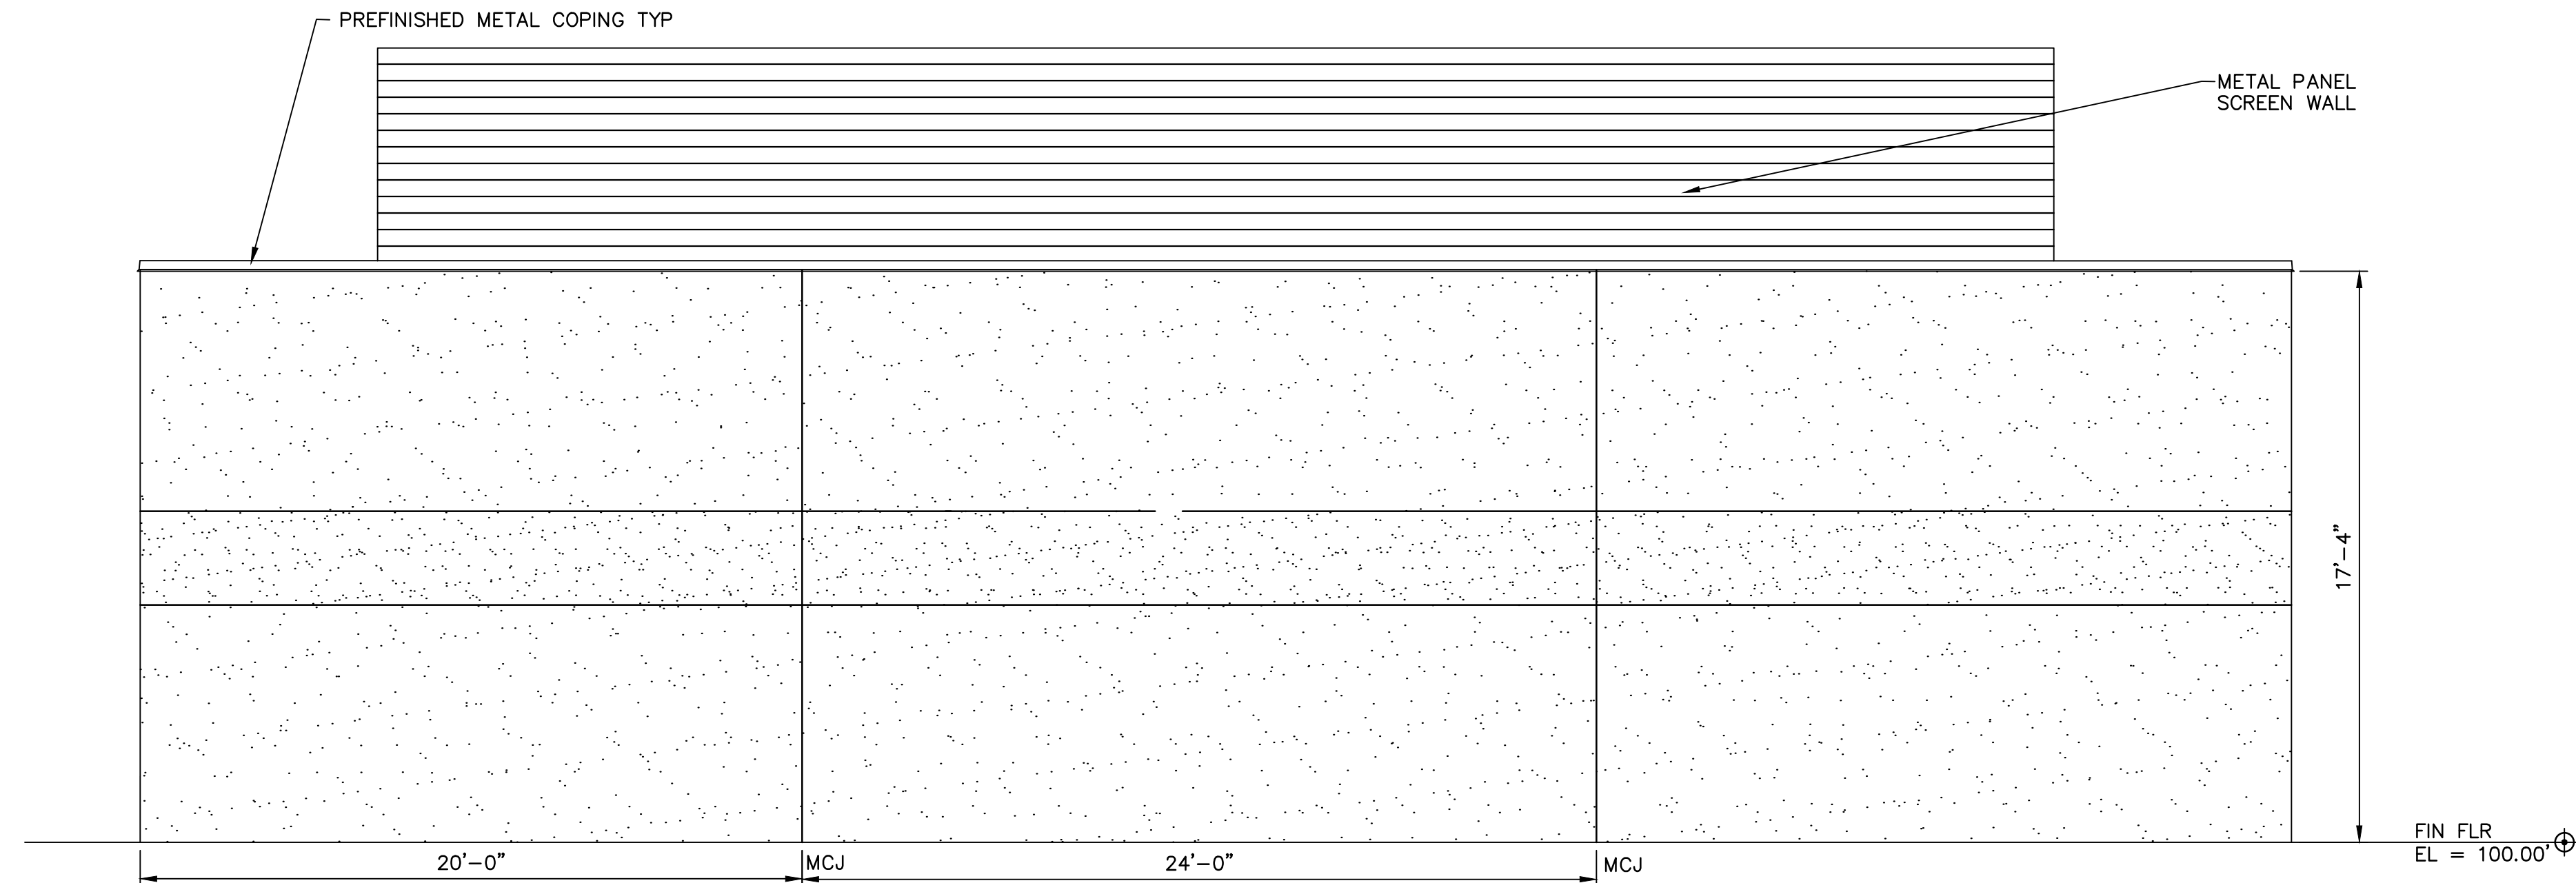


2 EAST ELEVATION  
SCALE: 1/4" = 1'-0"

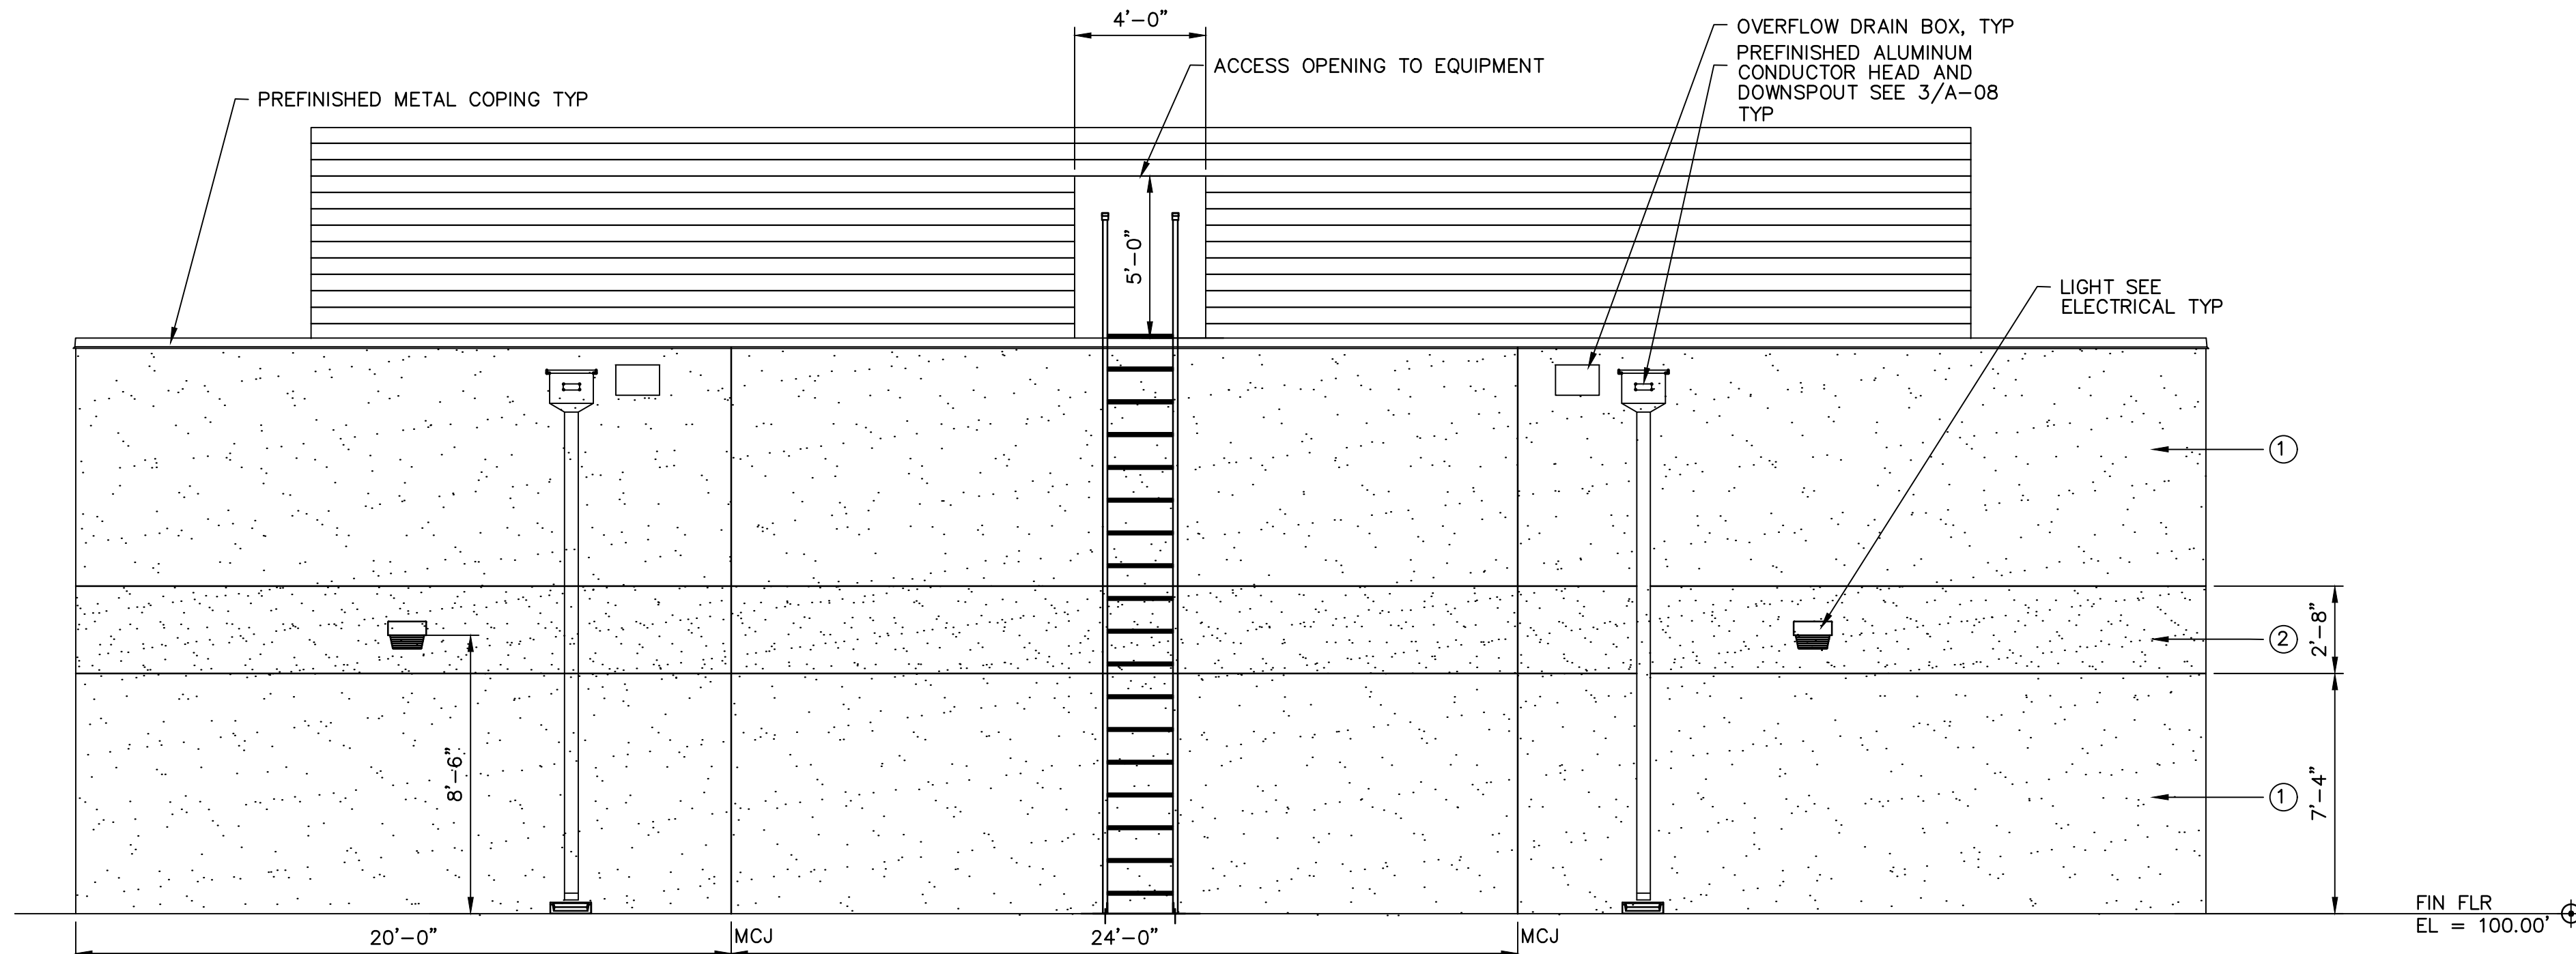

1 WEST ELEVATION  
SCALE: 1/4" = 1'-0"

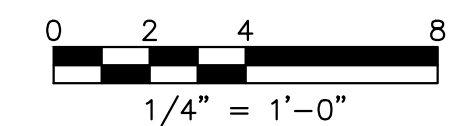

REVISION	DATE	CAD FILE NAME	DWG NUMBER	REMARKS

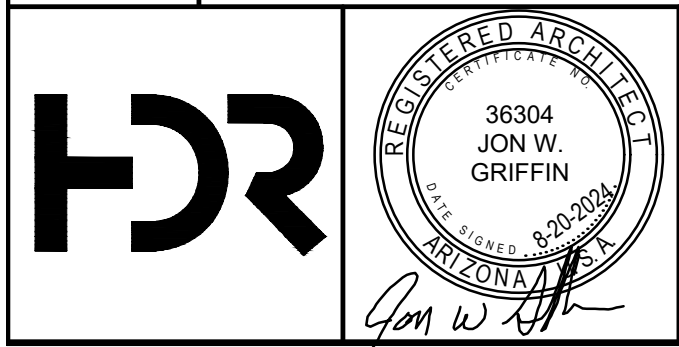

REVISIONS				
NO.	BY	DATE	CHKD	REMARKS
B	JWG	1/2024	JWG	90% SUBMITTAL
C	JWG	04/2024	JWG	AGENCY REVIEW
D	JWG	8/2024	JWG	ISSUED FOR CONSTRUCTION
*				
*				
*				

DES  
JWG

DWN  
JRL

CKD  
JWG

CITY OF PHOENIX  
WATER SERVICES DEPARTMENT

LIFT STATION 40  
REFURBISHMENT

ARCHITECTURAL

ELECTRICAL BUILDING  
EXTERIOR ELEVATIONS

COPYRIGHT © 2007-JANUARY

CITY PROJECT NO. WS90400085

DATE: 04/2024

A-04 SHEET 79 OF 134

CAD FILE: CSALS40E04

THIS DRAWING MUST BE FIELD VERIFIED BEFORE USE  
DRAWING NOT TO SCALE UNLESS SCALE BAR IS PRESENT

FOR CONSTRUCTION


"PER CITY OF PHOENIX CODE CHAPTER 2, SECTION 2-28, THESE PLANS ARE FOR OFFICIAL USE ONLY AND MAY NOT BE SHARED WITH OTHERS EXCEPT AS REQUIRED TO FULFILL THE OBLIGATIONS OF THE CONTRACTOR'S CONTRACT WITH THE CITY OF PHOENIX." THIS DOCUMENT MUST BE KEPT SECURE AT ALL TIMES.

EIFS COLOR KEY		
#	HATCH	MATERIAL TYPE
①		SW7572 LOTUS
②		SW2803 ROCK WOOD TERRA


GENERAL NOTES

- SEE A-09 FOR ROOM FINISH AND DOOR SCHEDULES.
- SEE STRUCTURAL PLANS FOR FLOOR ELEVATIONS.
- SEE EXTERIOR ELEVATIONS FOR FINISH, CONTROL JOINTS AND REVEAL LOCATIONS.
- ALL DIMENSIONS ARE ACTUAL AND ARE FACE OF MASONRY UNLESS NOTED OTHERWISE. ALL DIMENSIONS ARE FOR BIDDING PURPOSES ONLY. ACTUAL FIELD DIMENSIONS SHALL BE VERIFIED PRIOR TO SUBMITTAL OF SHOP DRAWINGS, ORDERING RELATED MATERIALS AND PERFORMING CONSTRUCTION WORK.
- VERIFY MECHANICAL AND ELECTRICAL DRAWINGS FOR SCOPE AND INTERFACE. CONTRACTOR SHALL COORDINATE LOCATION FOR ALL MECHANICAL AND ELECTRICAL ITEMS WITH GENERAL CONSTRUCTION REVIEW, NOTIFY ENGINEER WITH ANY DISCREPANCIES
- LOCATE CONTROL JOINTS WHERE SHOWN ON THE PLANS AND ELEVATIONS. LOCATE CONTROL JOINTS AS SPECIFICALLY NOTED OR PER INDUSTRY STANDARDS.
- ARCHITECTURAL FINISH FLOOR FOR REFERENCE IS 100.00'.
- ALL ANGLES ON PLAN ARE 90 DEGREES UNLESS NOTED OTHERWISE.
- CONTRACTOR SHALL FIELD VERIFY ALL CONDITIONS BEFORE ORDERING MATERIALS.
- CONTRACTOR SHALL NOTIFY ENGINEER OF DISCREPANCIES OR UNKNOWN FOUND CONDITIONS.

FACILITY DRAWINGS  
This drawing was supplied by a Consultant Engineer from a past project. The Consultant Engineer is not responsible for the accuracy of the information provided by the Contractor to provide the Record Drawing. The City does not warrant this drawing to be a complete and accurate portrayal of facilities as they exist in the field.

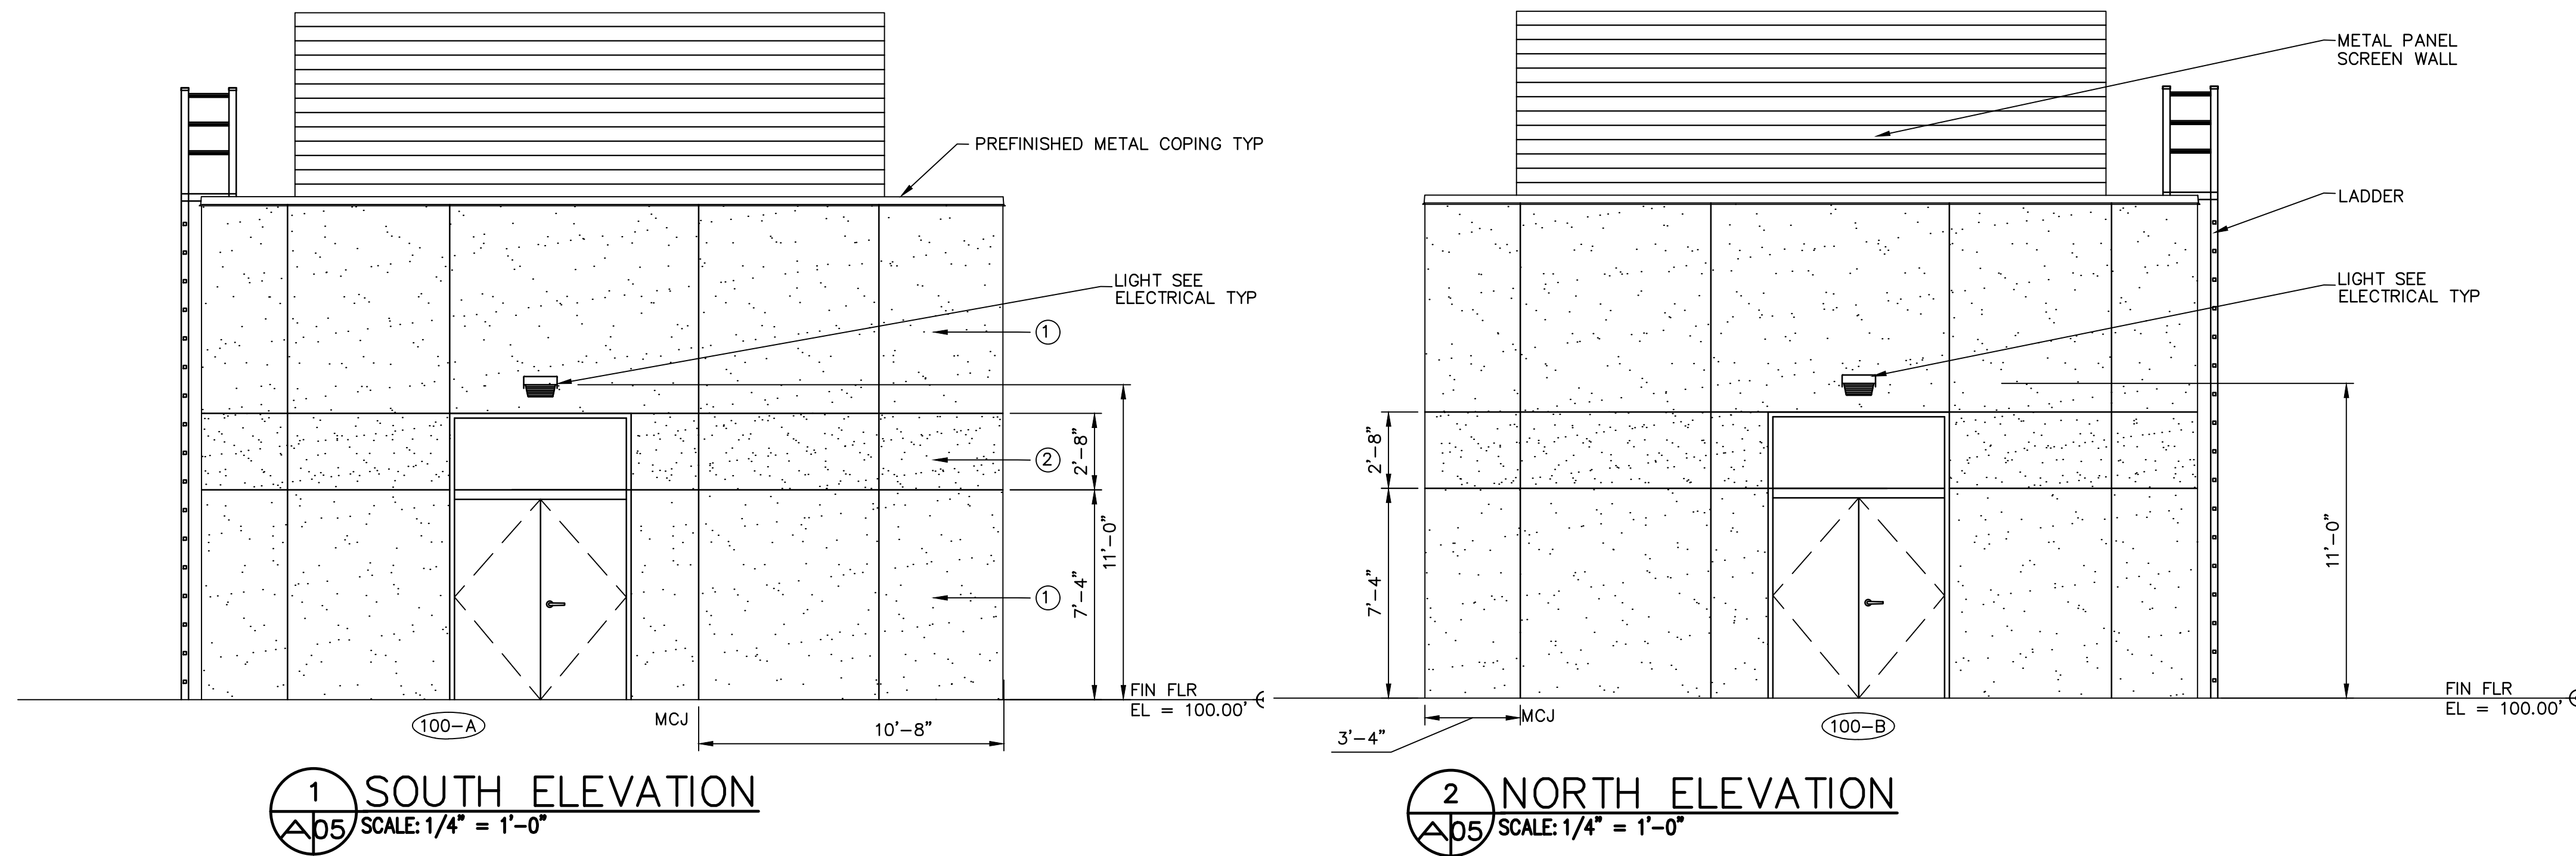

REVISION	NO.	DATE	PROJECT NO.	PROJECT NAME	DATE	CAD FILE NAME	DWG NUMBER	REMARKS

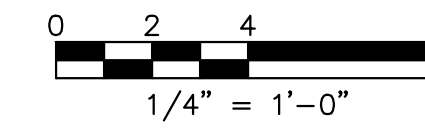

REVISIONS				
NO.	BY	DATE	CKD	REMARKS
B	JWG	1/2024	JWG	90% SUBMITTAL
C	JWG	04/2024	JWG	AGENCY REVIEW
D	JWG	8/2024	JWG	ISSUED FOR CONSTRUCTION
*				
*				
*				

DES  
JWG  
DWN  
JRL  
CKD  
JWG

City of Phoenix

CITY OF PHOENIX  
WATER SERVICES DEPARTMENT

LIFT STATION 40  
REFURBISHMENT

ARCHITECTURAL

ELECTRICAL BUILDING  
EXTERIOR ELEVATIONS

COPYRIGHT © 2007 - JANUARY

CITY PROJECT NO. WS90400085

DATE: 04/2024

A-05 SHEET 80 OF 134


CAD FILE: CSALS40E05



THIS DRAWING MUST BE FIELD VERIFIED BEFORE USE  
DRAWING NOT TO SCALE UNLESS SCALE BAR IS PRESENT

FOR CONSTRUCTION

\*PER CITY OF PHOENIX CODE CHAPTER 2, SECTION 2-28, THESE PLANS ARE FOR OFFICIAL USE ONLY AND MAY NOT BE SHARED WITH OTHERS EXCEPT AS REQUIRED TO FULFILL THE OBLIGATIONS OF THE CONTRACTOR'S CONTRACT WITH THE CITY OF PHOENIX. THIS DOCUMENT MUST BE KEPT SECURE AT ALL TIMES.

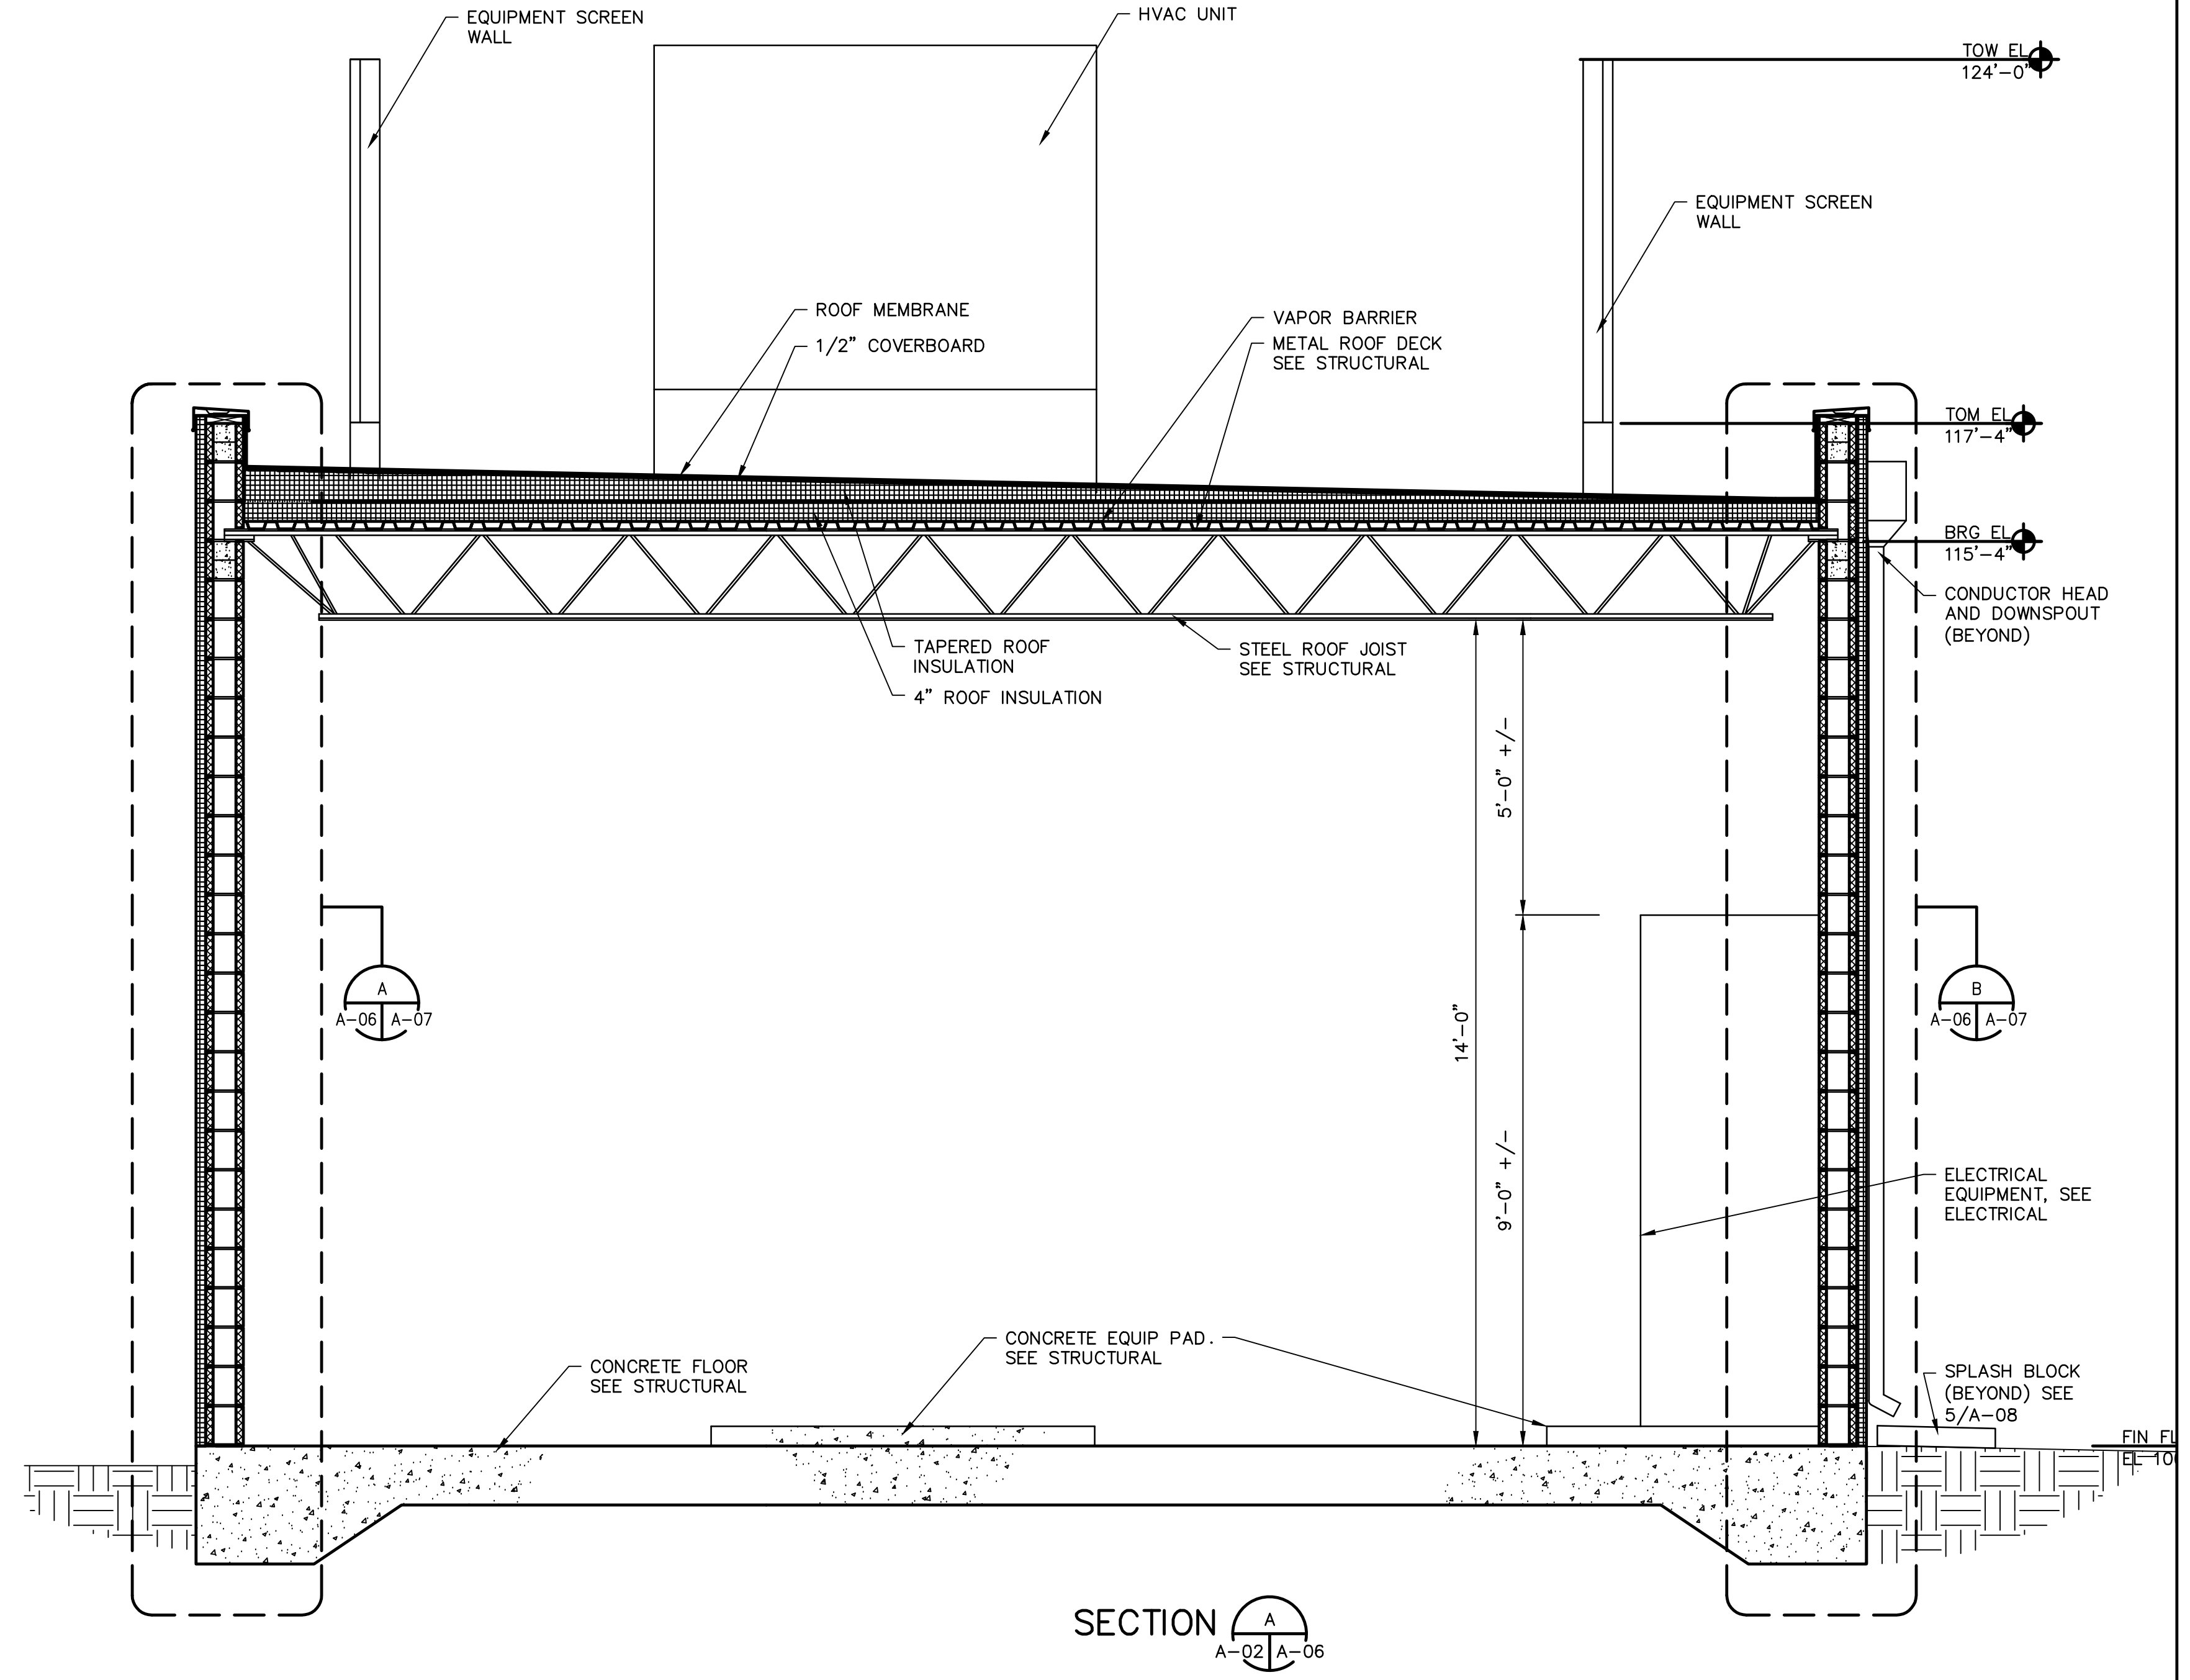


GENERAL NOTES

- SEE A-09 FOR ROOM FINISH AND DOOR SCHEDULES.
- SEE STRUCTURAL PLANS FOR FLOOR ELEVATIONS.
- SEE EXTERIOR ELEVATIONS FOR FINISH, CONTROL JOINTS AND REVEAL LOCATIONS.
- ALL DIMENSIONS ARE ACTUAL AND ARE FACE OF MASONRY UNLESS NOTED OTHERWISE. ALL DIMENSIONS ARE FOR BIDDING PURPOSES ONLY. ACTUAL FIELD DIMENSIONS SHALL BE VERIFIED PRIOR TO SUBMITTAL OF SHOP DRAWINGS. ORDERING RELATED MATERIALS AND PERFORMING CONSTRUCTION WORK.
- VERIFY MECHANICAL AND ELECTRICAL DRAWINGS FOR SCOPE AND INTERFACE. CONTRACTOR SHALL COORDINATE LOCATION FOR ALL MECHANICAL AND ELECTRICAL ITEMS WITH GENERAL CONSTRUCTION REVIEW, NOTIFY ENGINEER WITH ANY DISCREPANCIES
- LOCATE CONTROL JOINTS WHERE SHOWN ON THE PLANS AND ELEVATIONS. LOCATE CONTROL JOINTS AS SPECIFICALLY NOTED OR PER INDUSTRY STANDARDS.
- ARCHITECTURAL FINISH FLOOR FOR REFERENCE IS 100.00'.
- ALL ANGLES ON PLAN ARE 90 DEGREES UNLESS NOTED OTHERWISE.
- CONTRACTOR SHALL FIELD VERIFY ALL CONDITIONS BEFORE ORDERING MATERIALS.
- CONTRACTOR SHALL NOTIFY ENGINEER OF DISCREPANCIES OR UNKNOWN FOUND CONDITIONS.

FACILITY DRAWINGS  
This drawing was supplied by a Consultant, Engineer, from a past construction project. It is based on information provided by the Contractor to provide the Record Drawing. The City does not warrant this drawing to be a complete and accurate portrayal of facilities as they exist in the field.

REVISION	DATE	PROJECT NAME	PROJECT NO.	PROJECT NUMBER	CAD FILE NAME	DWG NUMBER	REMARKS

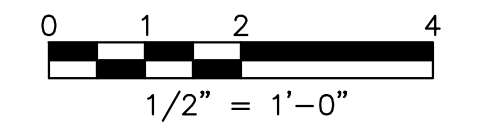

NO.	BY	DATE	CKD	REMARKS
B	JWG	1/2024	JWG	90% SUBMITTAL
C	JWG	04/2024	JWG	AGENCY REVIEW
D	JWG	6/2024	JWG	ISSUED FOR CONSTRUCTION

DES	
JWG	
DWN	
JRL	
CKD	
JWG	

CITY OF PHOENIX  
WATER SERVICES DEPARTMENT

LIFT STATION 40  
REFURBISHMENT

ARCHITECTURAL  
ELECTRICAL BUILDING  
EXTERIOR ELEVATIONS AND BUILDING SECTION

ARCHITECTURAL  
ELECTRICAL BUILDING  
EXTERIOR ELEVATIONS AND BUILDING SECTION




DATE: 04/2024  
A-06 SHEET 81 OF 134  
CAD FILE: CSALS40V06.DWG

USER: JGRIFFIN FILE: C:\P\WORKING\west01\csals40v06.dwg DATE: 6/26/24 TIME: 08:24am

THIS DRAWING MUST BE FIELD VERIFIED BEFORE USE  
DRAWING NOT TO SCALE UNLESS SCALE BAR IS PRESENT

**FOR CONSTRUCTION**

"PER CITY OF PHOENIX CODE CHAPTER 2-28, THESE PLANS ARE FOR OFFICIAL USE ONLY AND MAY NOT BE SHARED WITH OTHERS EXCEPT AS REQUIRED TO FULFILL THE OBLIGATIONS OF THE CONTRACTOR'S CONTRACT WITH THE CITY OF PHOENIX." THIS DOCUMENT MUST BE KEPT SECURE AT ALL TIMES.

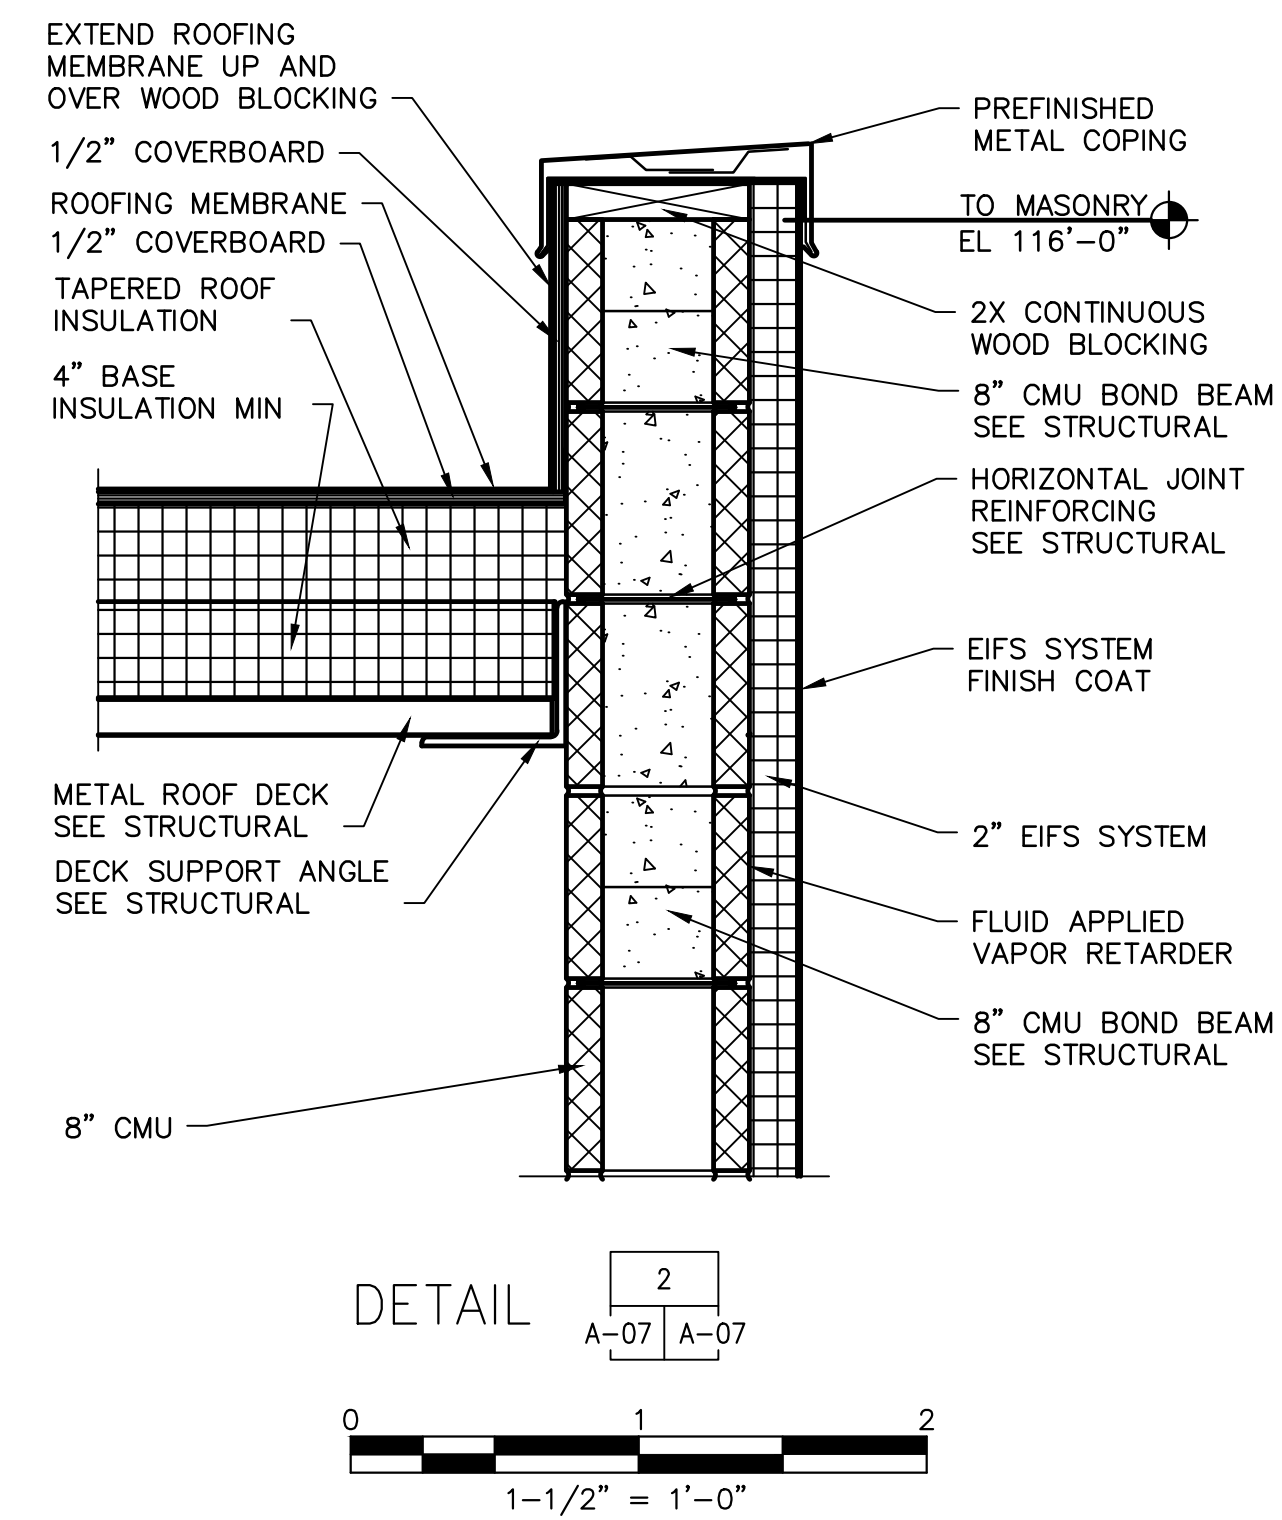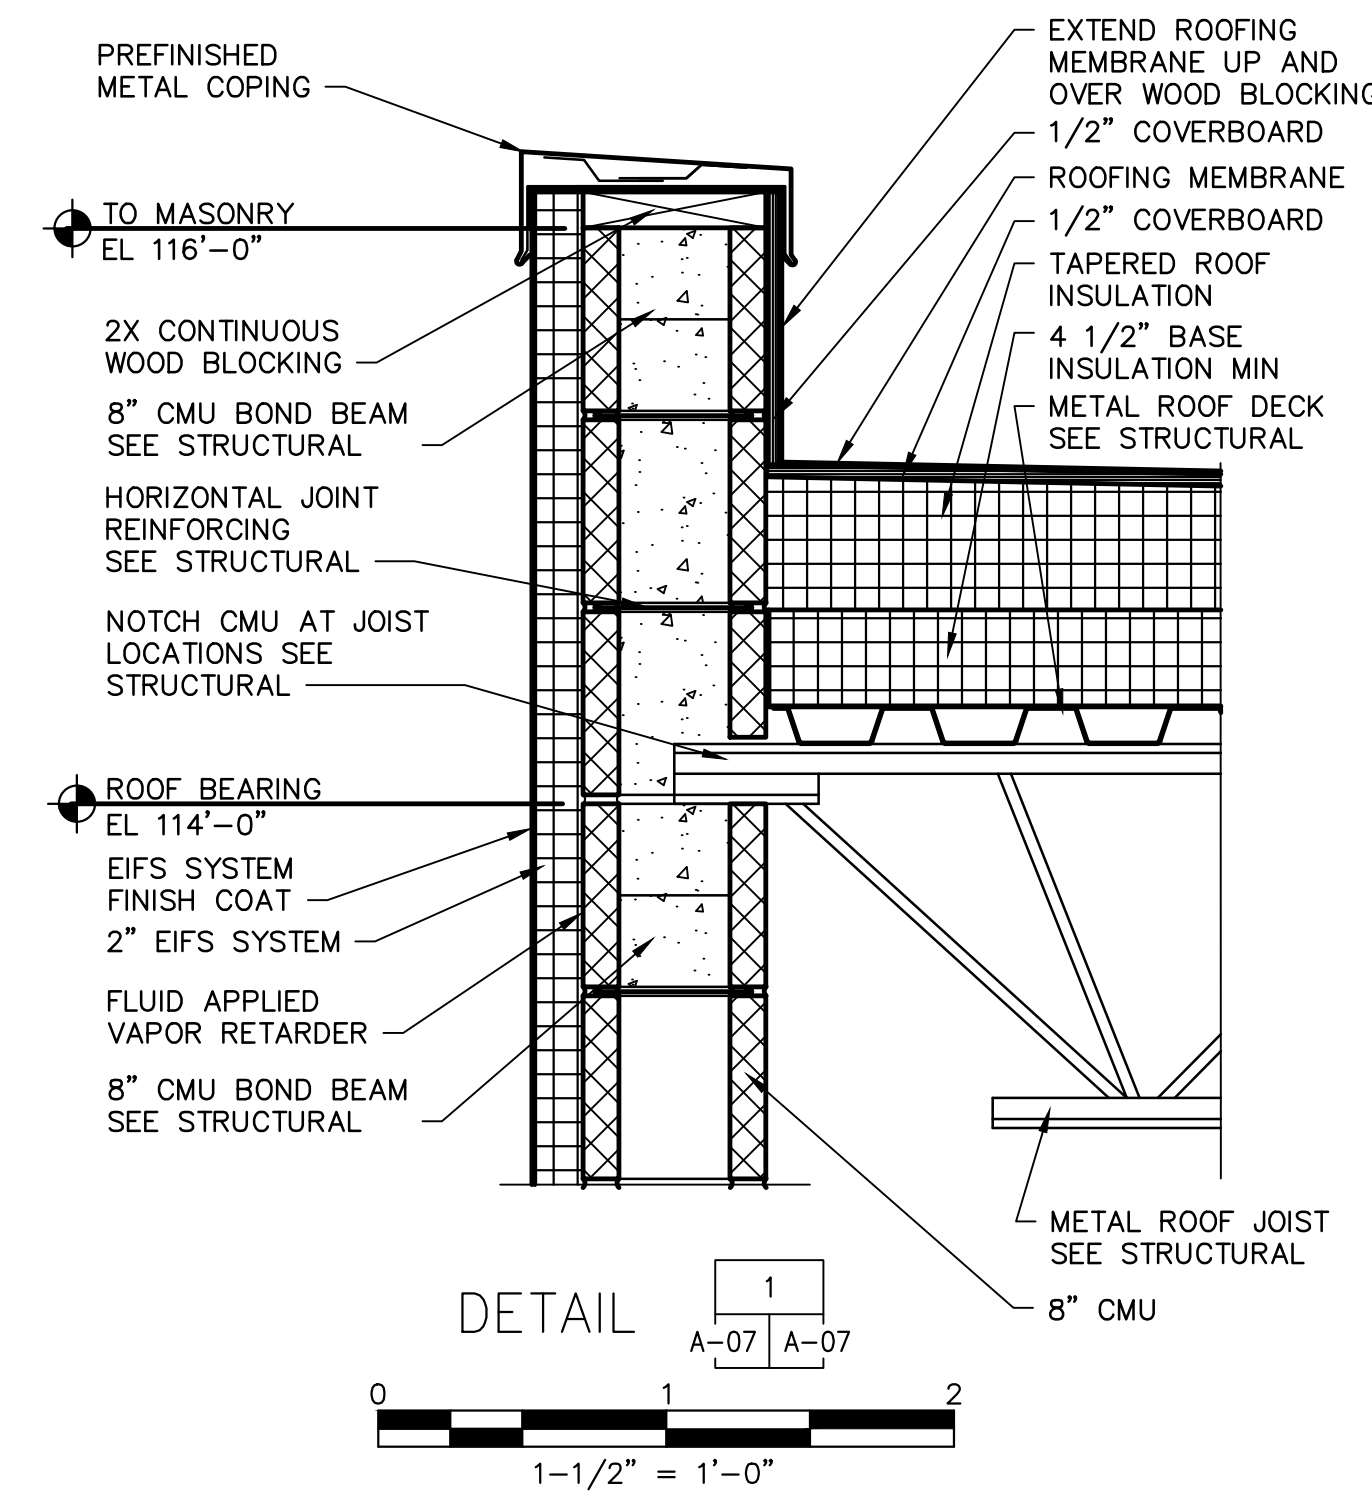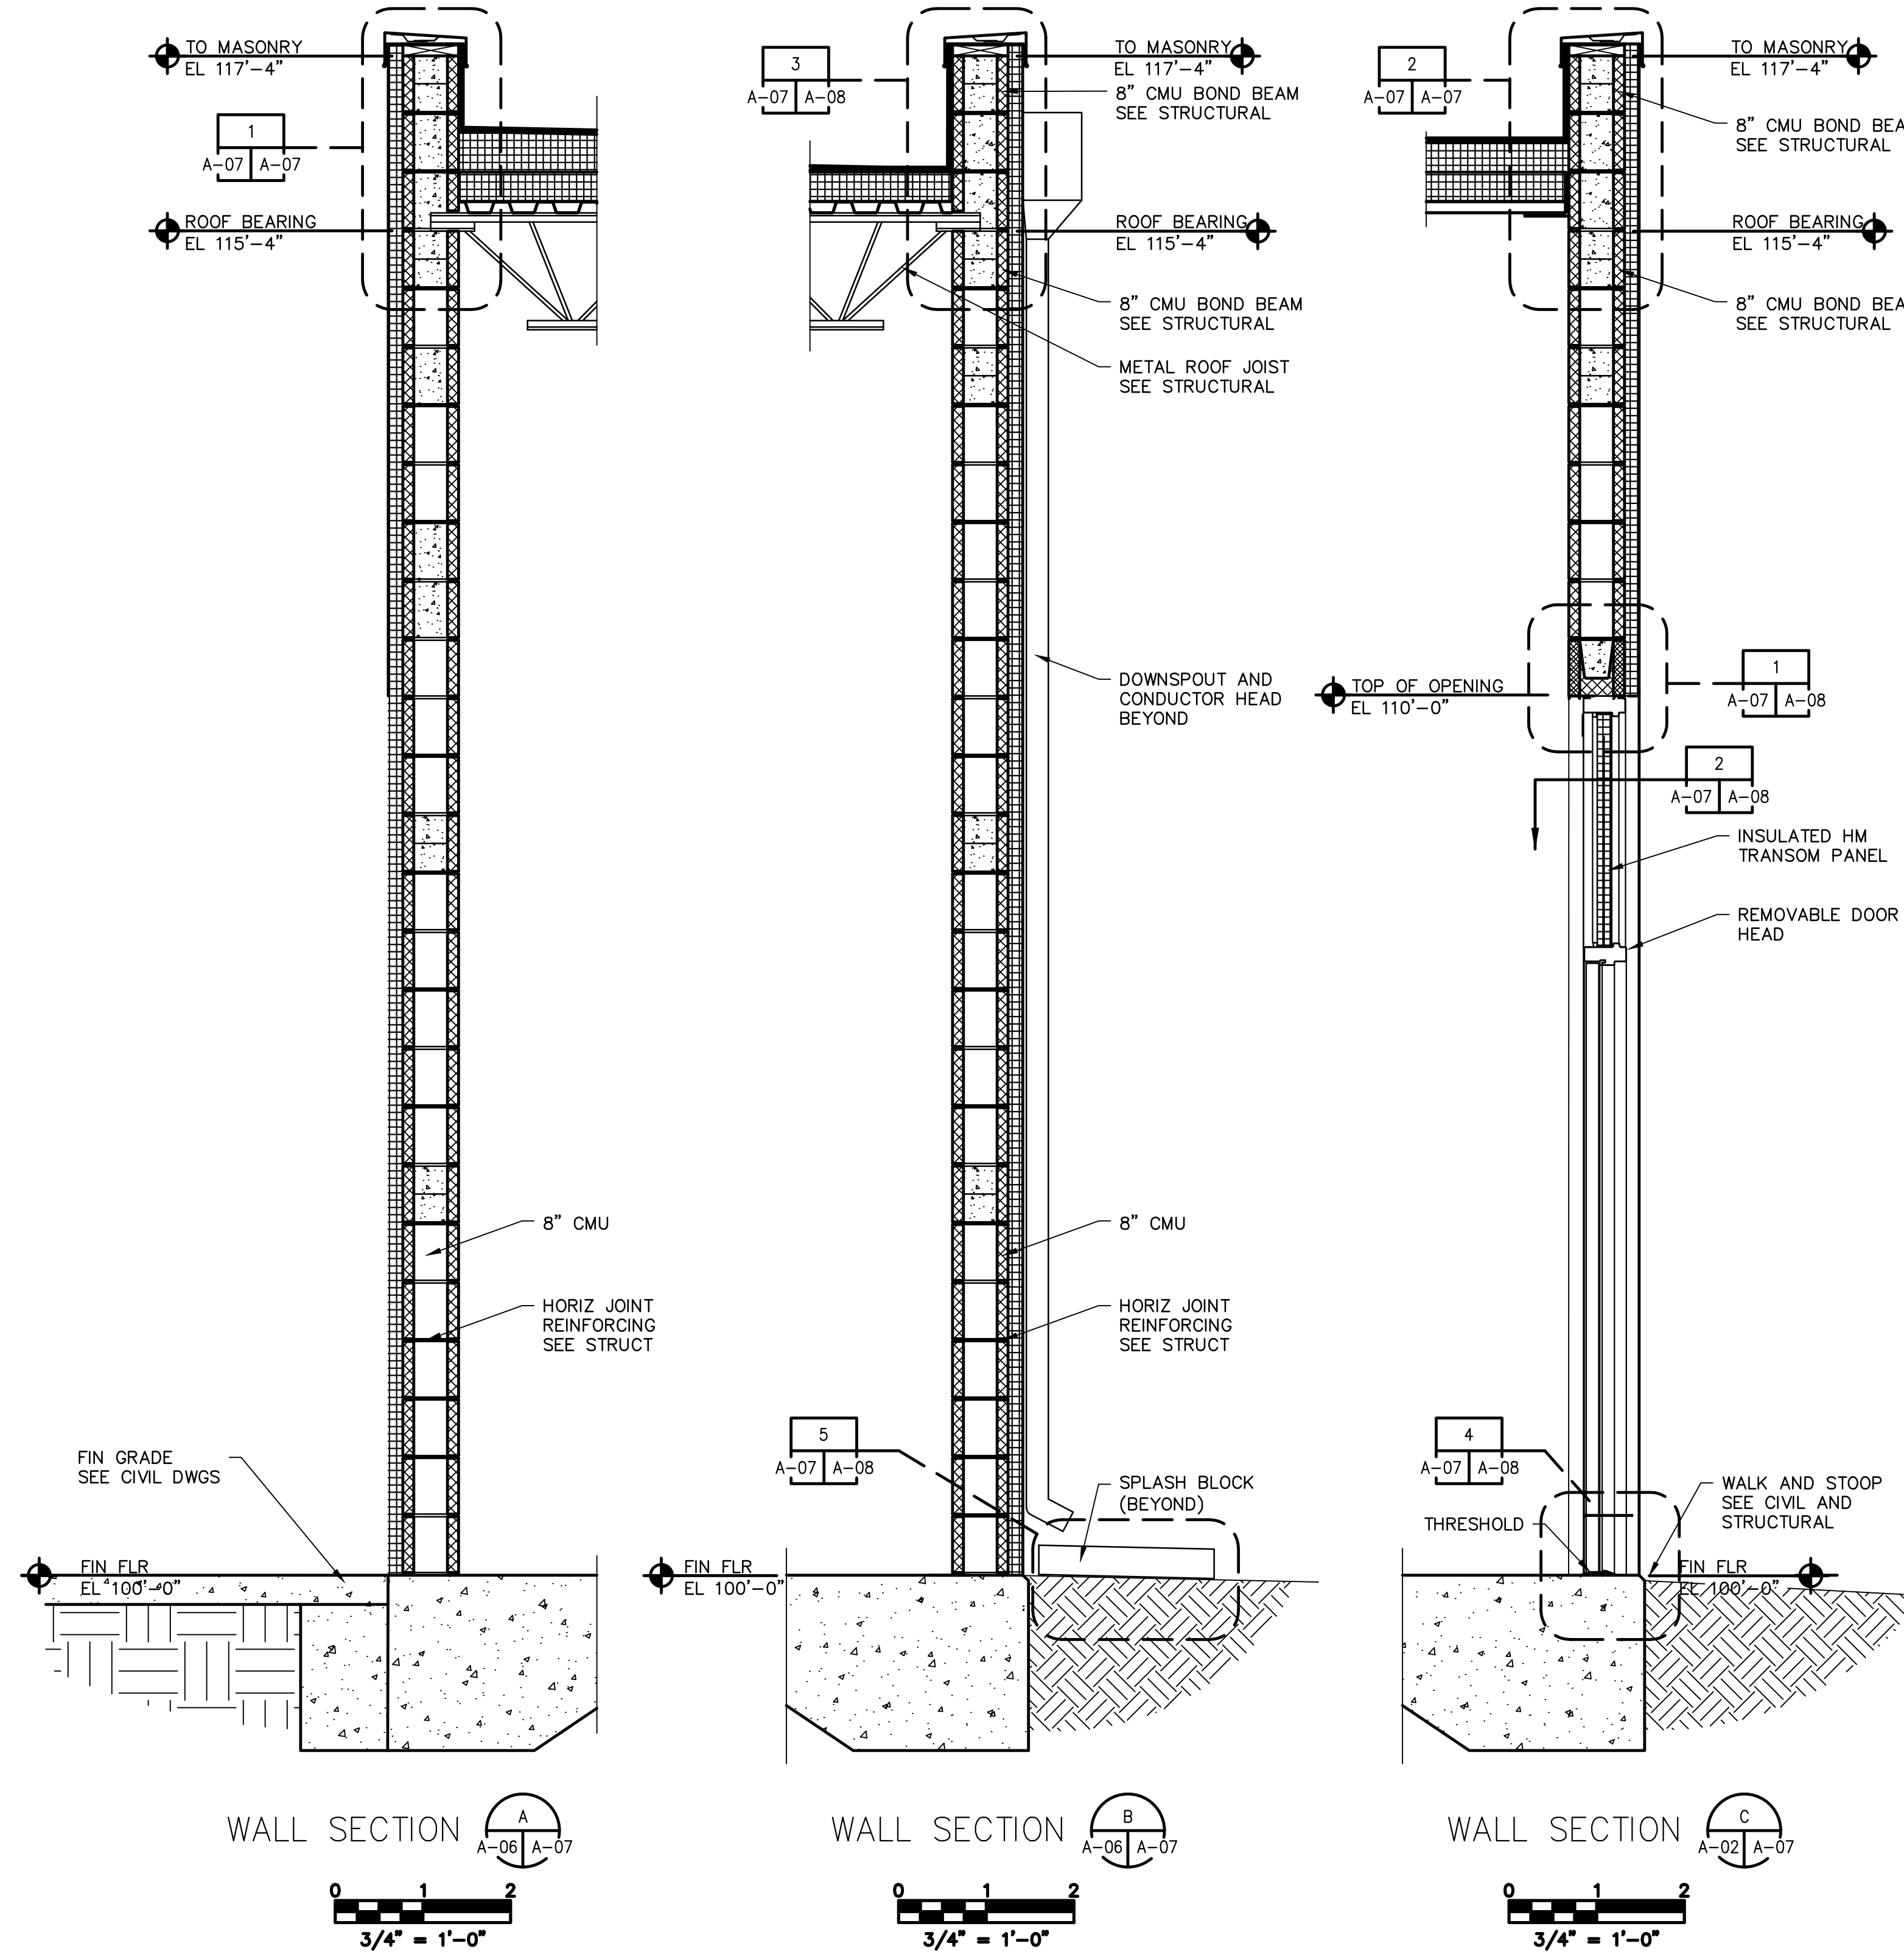

**GENERAL NOTES**

- SEE A-09 FOR ROOM FINISH AND DOOR SCHEDULES.
- SEE STRUCTURAL PLANS FOR FLOOR ELEVATIONS.
- SEE EXTERIOR ELEVATIONS FOR FINISH, CONTROL JOINTS AND REVEAL LOCATIONS.
- ALL DIMENSIONS ARE ACTUAL AND ARE FACE OF MASONRY UNLESS NOTED OTHERWISE. ALL DIMENSIONS ARE FOR BIDDING PURPOSES ONLY. ACTUAL FIELD DIMENSIONS SHALL BE VERIFIED PRIOR TO SUBMITTAL OF SHOP DRAWINGS, ORDERING RELATED MATERIALS AND PERFORMING CONSTRUCTION WORK.
- VERIFY MECHANICAL AND ELECTRICAL DRAWINGS FOR SCOPE AND INTERFACE. CONTRACTOR SHALL COORDINATE LOCATION FOR ALL MECHANICAL AND ELECTRICAL ITEMS WITH GENERAL CONSTRUCTION REVIEW. NOTIFY ENGINEER WITH ANY DISCREPANCIES.
- LOCATE CONTROL JOINTS WHERE SHOWN ON THE PLANS AND ELEVATIONS. LOCATE CONTROL JOINTS AS SPECIFICALLY NOTED OR PER INDUSTRY STANDARDS.
- ARCHITECTURAL FINISH FLOOR FOR REFERENCE IS 100.00'.
- ALL ANGLES ON PLAN ARE 90 DEGREES UNLESS NOTED OTHERWISE.
- CONTRACTOR SHALL FIELD VERIFY ALL CONDITIONS BEFORE ORDERING MATERIALS.
- CONTRACTOR SHALL NOTIFY ENGINEER OF DISCREPANCIES OR UNKNOWN FOUND CONDITIONS.


FACILITY DRAWINGS  
This drawing was supplied by a Consultant Engineer from a past project and is being provided for informational purposes only. The City does not warrant this drawing to be a complete and accurate portrayal of facilities as they exist in the field.

REVISION	NO.	DATE	BY	DESCRIPTION	DATE	CAD FILE NAME	DWG NUMBER	REMARKS



NO.	BY	DATE	CKD	REVISIONS	REMARKS
B	JWG	1/2024	JWG	90% SUBMITTAL	
C	JWG	04/2024	JWG	AGENCY REVIEW	
D	JWG	8/2024	JWG	ISSUED FOR CONSTRUCTION	

DES	JWG
DWN	
JRL	
CKD	
JWG	

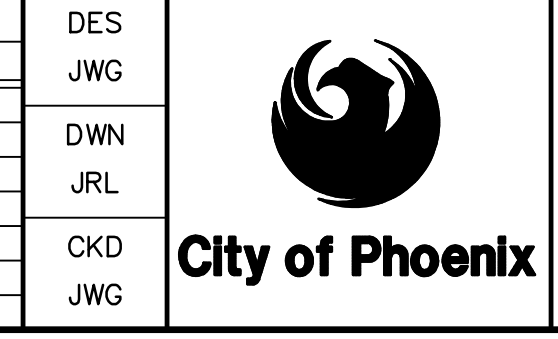

CITY OF PHOENIX  
WATER SERVICES DEPARTMENT  
  
LIFT STATION 40  
REFURBISHMENT

ARCHITECTURAL  
  
ELECTRICAL BUILDING  
WALL SECTIONS AND DETAILS


COPYRIGHT © 2007 - JANUARY  
CITY PROJECT NO. WS90400085  
DATE: 04/2024  
A-07 SHEET 82 OF 134  
CAD FILE: CSALS40V07.DWG

USER: J06RIFIN FILE: C:\WORKING\ves101\341666A\CSALS40V07.dwg DATE: 8/28/24 TIME: 08:25am



THIS DRAWING MUST BE FIELD VERIFIED BEFORE USE. DRAWING NOT TO SCALE UNLESS SCALE BAR IS PRESENT

FOR CONSTRUCTION



PER CITY OF PHOENIX CODE CHAPTER 2, SECTION 2-28, THESE PLANS ARE FOR OFFICIAL USE ONLY AND MAY NOT BE SHARED WITH OTHERS EXCEPT AS REQUIRED TO FULFILL THE OBLIGATIONS OF THE CONTRACTOR'S CONTRACT WITH THE CITY OF PHOENIX. THIS DOCUMENT MUST BE KEPT SECURE AT ALL TIMES.

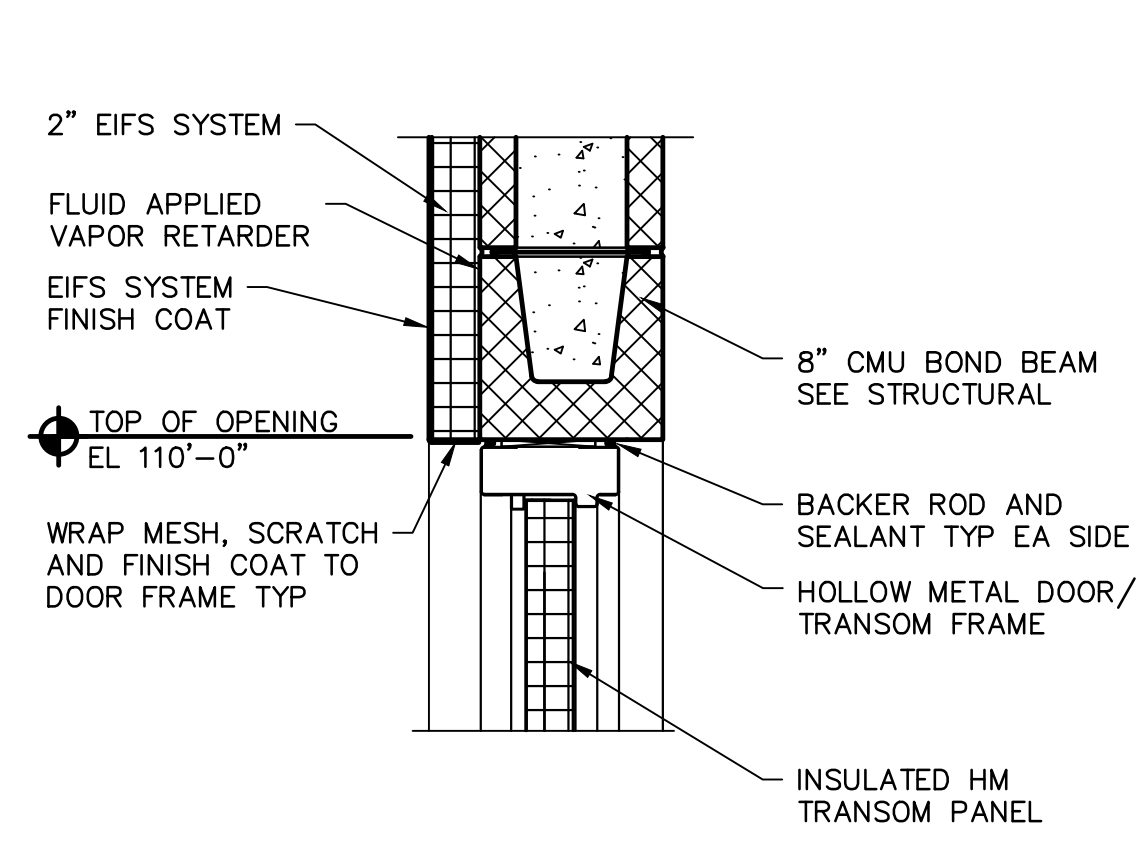



DETAIL 1  
A-07 A-08

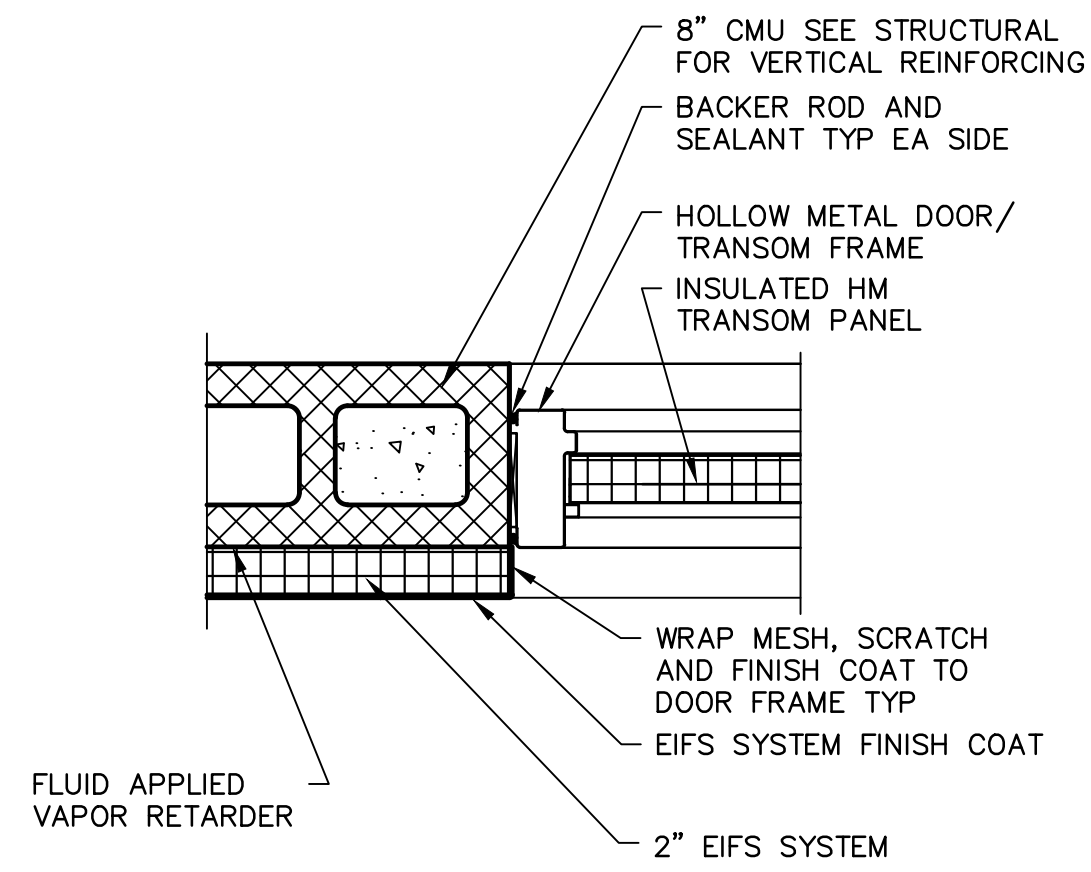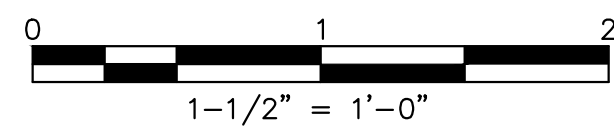



DETAIL 2  
A-07 A-08

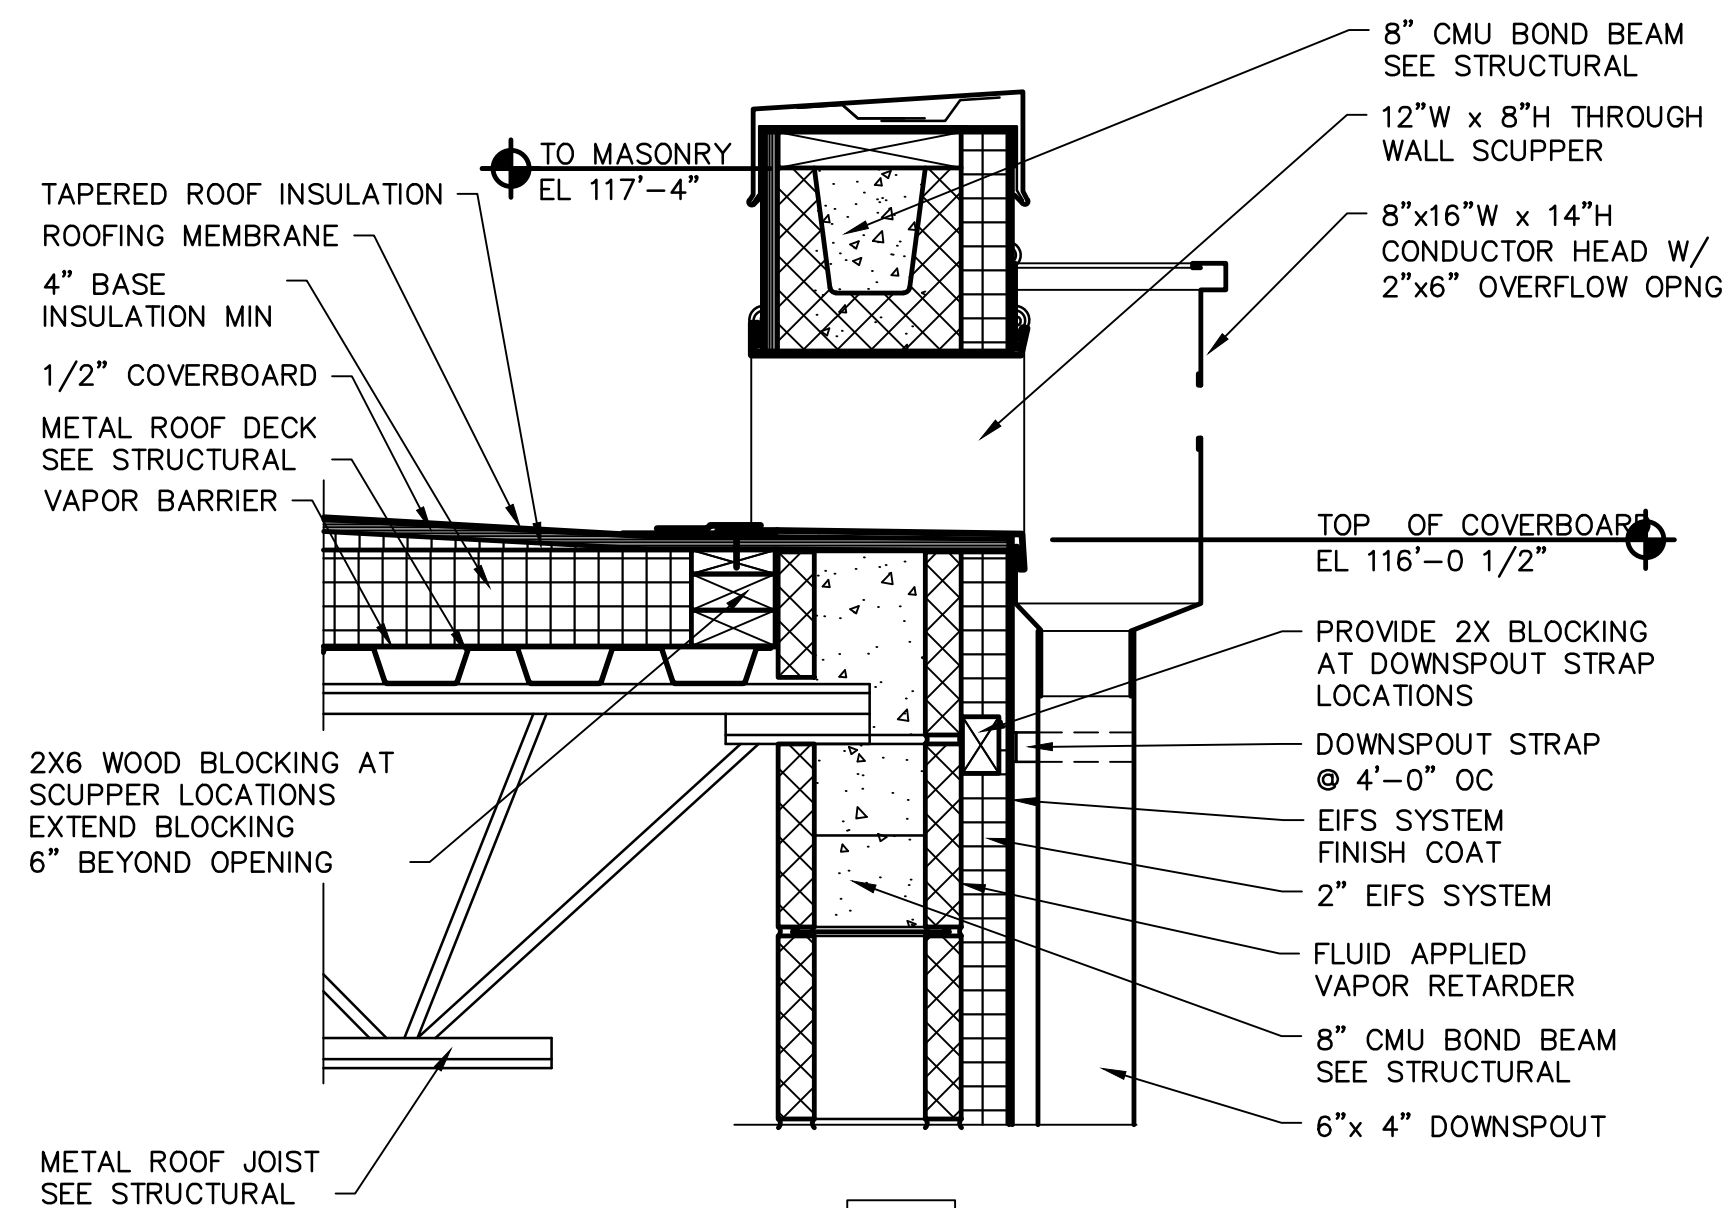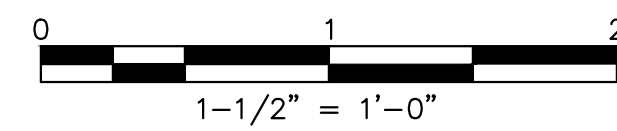


DETAIL 3  
A-07 A-08

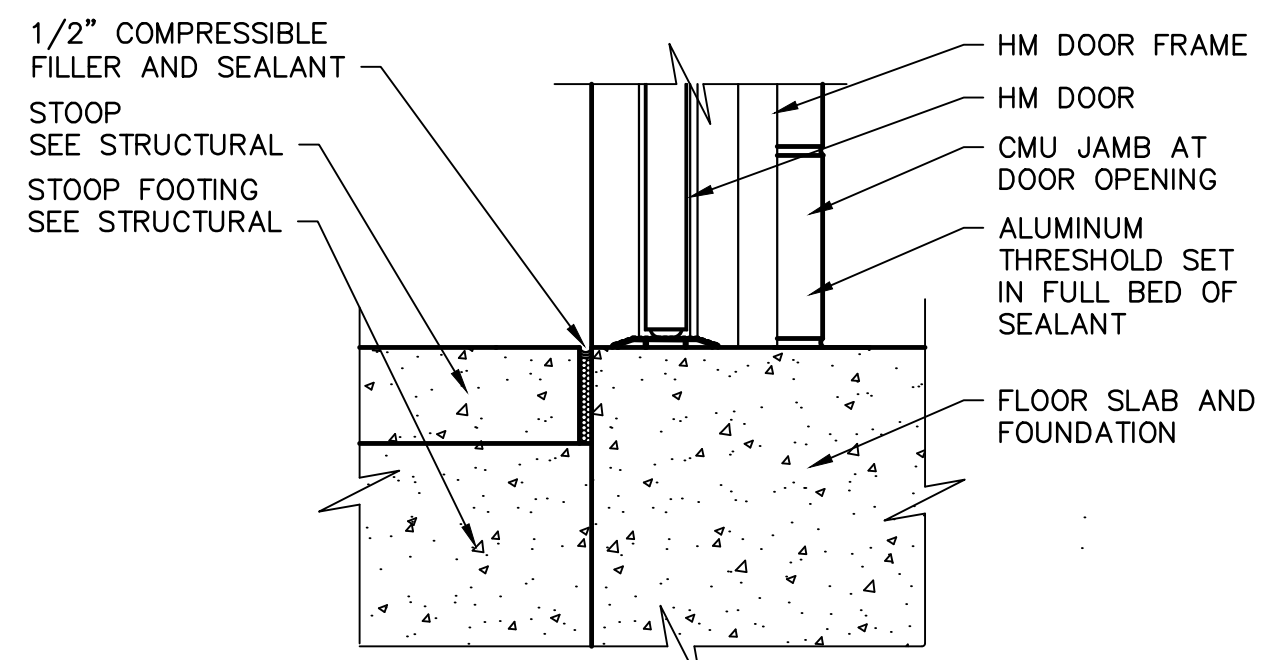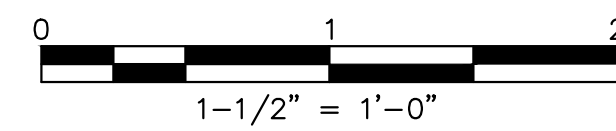

DETAIL 4  
A-07 A-08

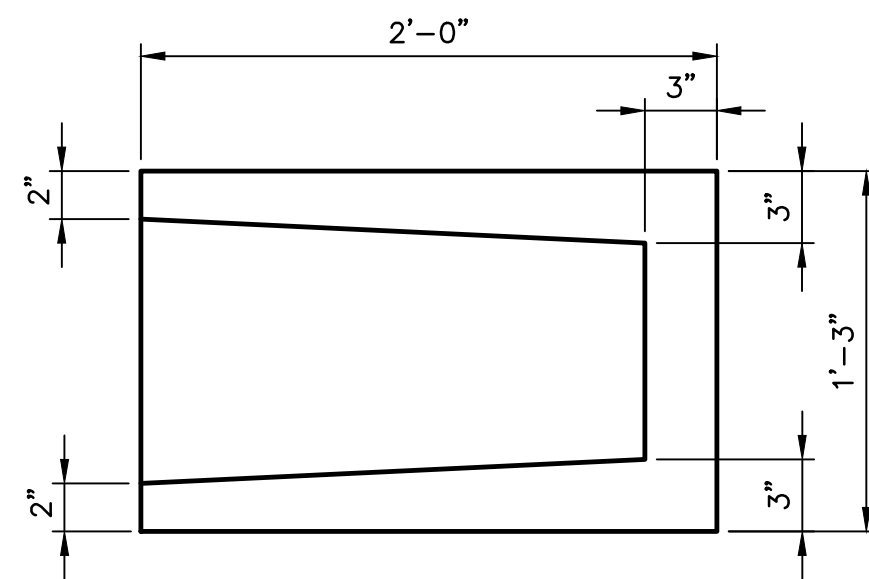
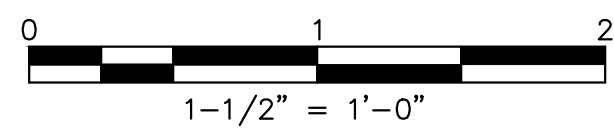


PLAN

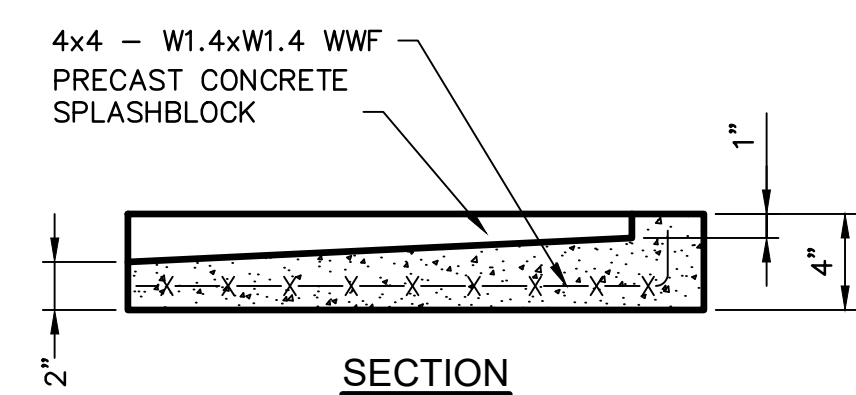



SECTION

DETAIL 5  
A-07 A-08

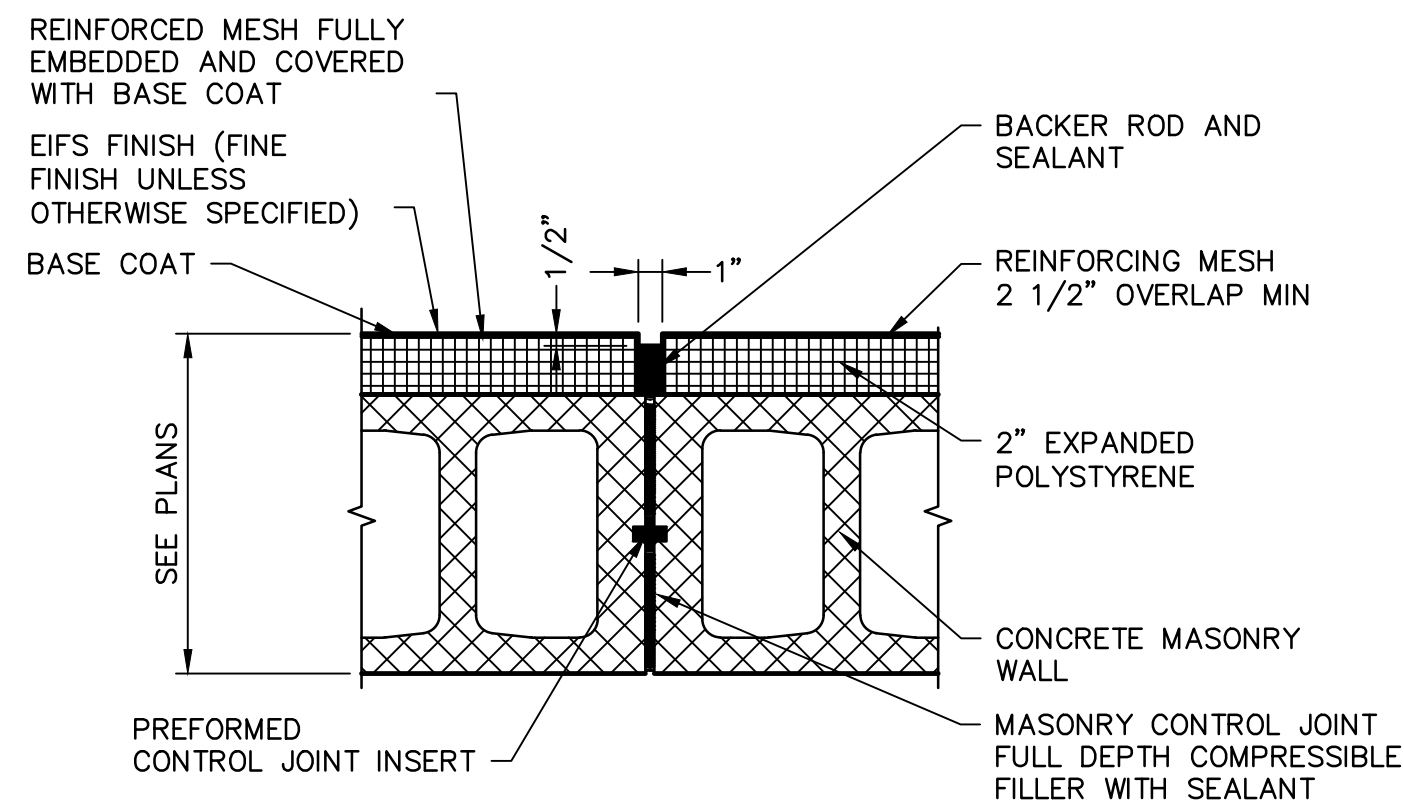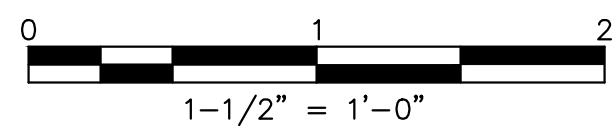


NOTE:  
1. SEE STRUCTURAL FOR VERTICAL WALL REINFORCEMENT.

DETAIL 6  
A-08

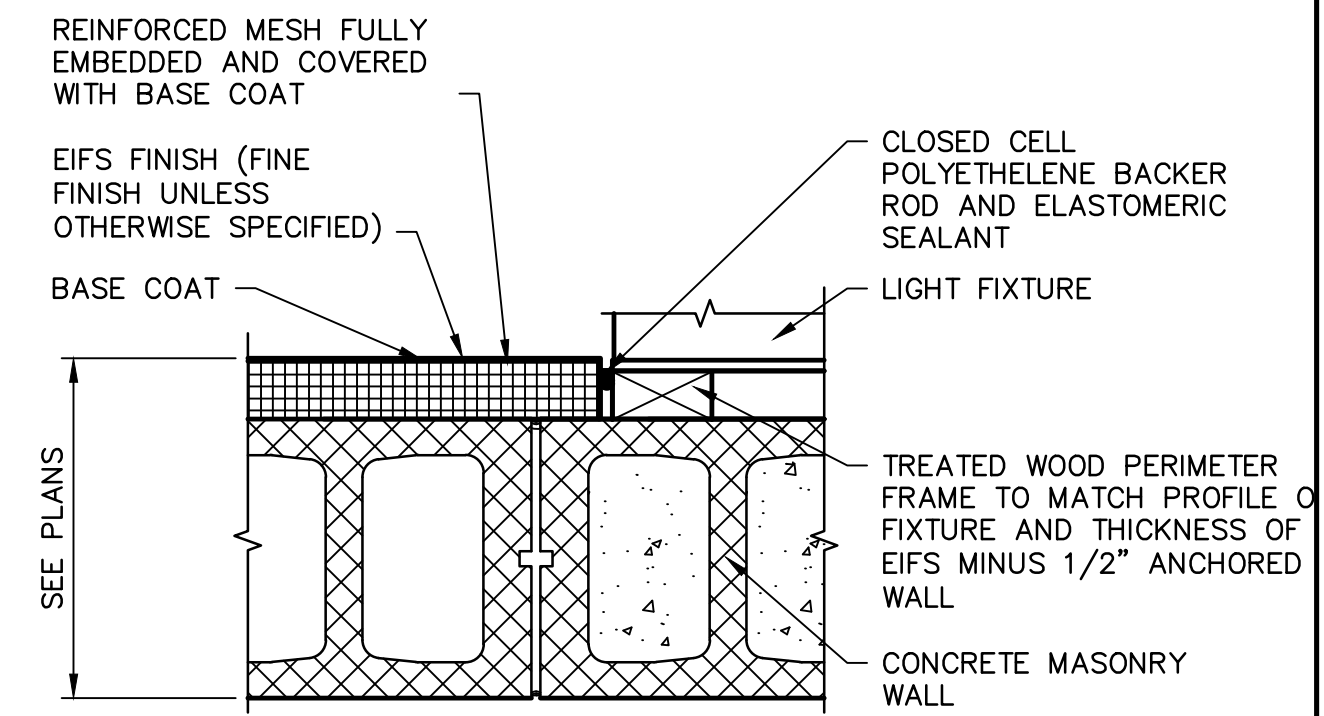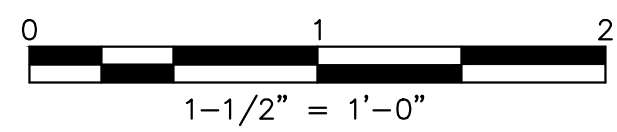

DETAIL 7  
A-07 A-08

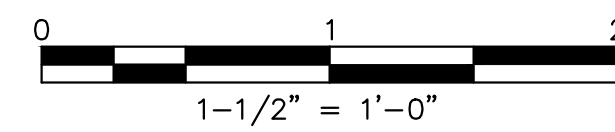

GENERAL NOTES

- SEE A-09 FOR ROOM FINISH AND DOOR SCHEDULES.
- SEE STRUCTURAL PLANS FOR FLOOR ELEVATIONS.
- SEE EXTERIOR ELEVATIONS FOR FINISH, CONTROL JOINTS AND REVEAL LOCATIONS.
- ALL DIMENSIONS ARE ACTUAL AND ARE FACE OF MASONRY UNLESS NOTED OTHERWISE. ALL DIMENSIONS ARE FOR BIDDING PURPOSES ONLY. ACTUAL FIELD DIMENSIONS SHALL BE VERIFIED PRIOR TO SUBMITTAL OF SHOP DRAWINGS, ORDERING RELATED MATERIALS AND PERFORMING CONSTRUCTION WORK.
- VERIFY MECHANICAL AND ELECTRICAL DRAWINGS FOR SCOPE AND INTERFACE. CONTRACTOR SHALL COORDINATE LOCATION FOR ALL MECHANICAL AND ELECTRICAL ITEMS WITH GENERAL CONSTRUCTION REVIEW, NOTIFY ENGINEER WITH ANY DISCREPANCIES.
- LOCATE CONTROL JOINTS WHERE SHOWN ON THE PLANS AND ELEVATIONS. LOCATE CONTROL JOINTS AS SPECIFICALLY NOTED OR PER INDUSTRY STANDARDS.
- ARCHITECTURAL FINISH FLOOR FOR REFERENCE IS 100.00'.
- ALL ANGLES ON PLAN ARE 90 DEGREES UNLESS NOTED OTHERWISE.
- CONTRACTOR SHALL FIELD VERIFY ALL CONDITIONS BEFORE ORDERING MATERIALS.
- CONTRACTOR SHALL NOTIFY ENGINEER OF DISCREPANCIES OR UNKNOWN FOUND CONDITIONS.


FACILITY DRAWINGS  
This drawing was supplied by a Consultant Engineer from a past project. The Consultant Engineer is not responsible for the construction information provided by the Contractor to provide the Record Drawing. The City does not warrant this drawing to be a complete and accurate portrayal of facilities as they exist in the field.

REVISION	NO.	DATE	PROJECT NO.	PROJECT NAME	DATE	CAD FILE NAME	DWG NUMBER	REMARKS



NO.	BY	DATE	CKD	REVISIONS	REMARKS
B	JWG	1/2024	JWG	90% SUBMITTAL	
C	JWG	04/2024	JWG	AGENCY REVIEW	
D	JWG	8/2024	JWG	ISSUED FOR CONSTRUCTION	
*					
*					
*					

DES	JWG	DWN	JRL	CKD	JWG

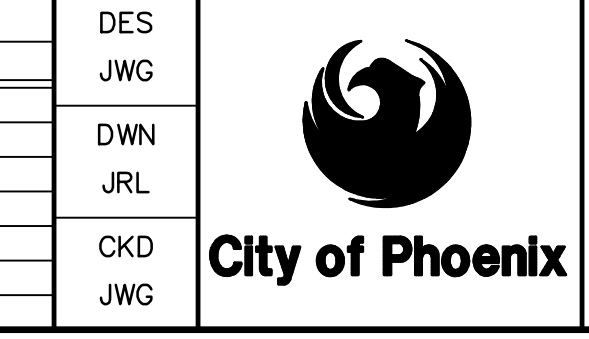

CITY OF PHOENIX  
WATER SERVICES DEPARTMENT  
LIFT STATION 40  
REFURBISHMENT

ARCHITECTURAL  
ELECTRICAL BUILDING  
DETAILS

COPYRIGHT © 2007 - JANUARY  
CITY PROJECT NO. WS90400085  
DATE: 04/2024  
A-08 SHEET 83 OF 134  
CAD FILE: CSALS40D08.DWG

THIS DRAWING MUST BE FIELD VERIFIED BEFORE USE. DRAWING NOT TO SCALE UNLESS SCALE BAR IS PRESENT.

FOR CONSTRUCTION

\*PER CITY OF PHOENIX CODE CHAPTER 2, SECTION 2-28, THESE PLANS ARE FOR OFFICIAL USE ONLY AND MAY NOT BE SHARED WITH OTHERS EXCEPT AS REQUIRED TO FULFILL THE OBLIGATIONS OF THE CONTRACTOR'S CONTRACT WITH THE CITY OF PHOENIX. THIS DOCUMENT MUST BE KEPT SECURE AT ALL TIMES.

DOOR SCHEDULE												
DOOR NUMBER	SIZE (W x H)	DRAWING NUMBER	DOOR			FRAME			HARDWARE SET	FIRE RATING	DETAILS	REMARKS
			TYPE	MATERIAL	FINISH	TYPE	MATERIAL	FINISH				
100A	PR 6'-0" x 7'-0"	A-02	F	HM	A	1	HM	A	HW-1		1, 2 AND 4/A-08	
100B	PR 6'-0" x 7'-0"	A-02	F	HM	A	2	HM	A	HW-1		1, 2 AND 4/A-08	
101	PR 3'-0" x 7'-0"	A-02	F	HM	A	2	HM	A	HW-4		1, 2 AND 4/A-08	

MATERIAL AND FINISH LEGEND			
MATERIAL		FINISH	
HM	HOLLOW METAL	A	PAINT

REMARKS



ROOM FINISH SCHEDULE											
ROOM NUMBER	ROOM NAME	DRAWING NUMBER	FLOOR	BASE	WALLS				CEILING		REMARKS
					NORTH	EAST	SOUTH	WEST	HEIGHT	FINISH	
100	ELECTRICAL ROOM	A-02	C	NA	CMU	CMU	CMU	CMU	14'-0"	ES	
101	TOILET ROOM	A-02	E	EB	CMU-P	CMU-P	CMU-P	GWB	8'-0"	GWB	

MATERIAL AND FINISH LEGEND			
FLOOR		BASE	
C	SEALED CONCRETE W/ HARDENER	NA	NONE
E	EPOXY	EB	EPOXY - 6" HIGH
WALLS		CEILING	
CMU	CONCRETE MASONRY WALLS - NO PAINT	ES	EXPOSED STRUCTURE - NO PAINT
CMU-P	CONCRETE MASONRY WALLS - EPOXY PAINT	GWB	GYPSUM WALL BOARD - EPOXY PAINT
GWB	GYPSUM WALL BOARD - EPOXY PAINT	ACT	ACOUSTICAL CEILING TILE - 2x2

REMARKS




- GENERAL NOTES**
- SEE A-09 FOR ROOM FINISH AND DOOR SCHEDULES.
  - SEE STRUCTURAL PLANS FOR FLOOR ELEVATIONS.
  - SEE EXTERIOR ELEVATIONS FOR FINISH, CONTROL JOINTS AND REVEAL LOCATIONS.
  - ALL DIMENSIONS ARE ACTUAL AND ARE FACE OF MASONRY UNLESS NOTED OTHERWISE. ALL DIMENSIONS ARE FOR BIDDING PURPOSES ONLY. ACTUAL FIELD DIMENSIONS SHALL BE VERIFIED PRIOR TO SUBMITTAL OF SHOP DRAWINGS. ORDERING RELATED MATERIALS AND PERFORMING CONSTRUCTION WORK.
  - VERIFY MECHANICAL AND ELECTRICAL DRAWINGS FOR SCOPE AND INTERFACE. CONTRACTOR SHALL COORDINATE LOCATION FOR ALL MECHANICAL AND ELECTRICAL ITEMS WITH GENERAL CONSTRUCTION REVIEW, NOTIFY ENGINEER WITH ANY DISCREPANCIES.
  - LOCATE CONTROL JOINTS WHERE SHOWN ON THE PLANS AND ELEVATIONS. LOCATE CONTROL JOINTS AS SPECIFICALLY NOTED OR PER INDUSTRY STANDARDS.
  - ARCHITECTURAL FINISH FLOOR FOR REFERENCE IS 100.00'.
  - ALL ANGLES ON PLAN ARE 90 DEGREES UNLESS NOTED OTHERWISE.
  - CONTRACTOR SHALL FIELD VERIFY ALL CONDITIONS BEFORE ORDERING MATERIALS.
  - CONTRACTOR SHALL NOTIFY ENGINEER OF DISCREPANCIES OR UNKNOWN FOUND CONDITIONS.

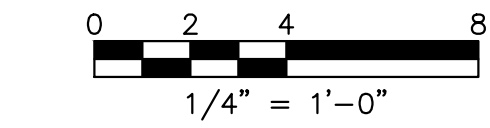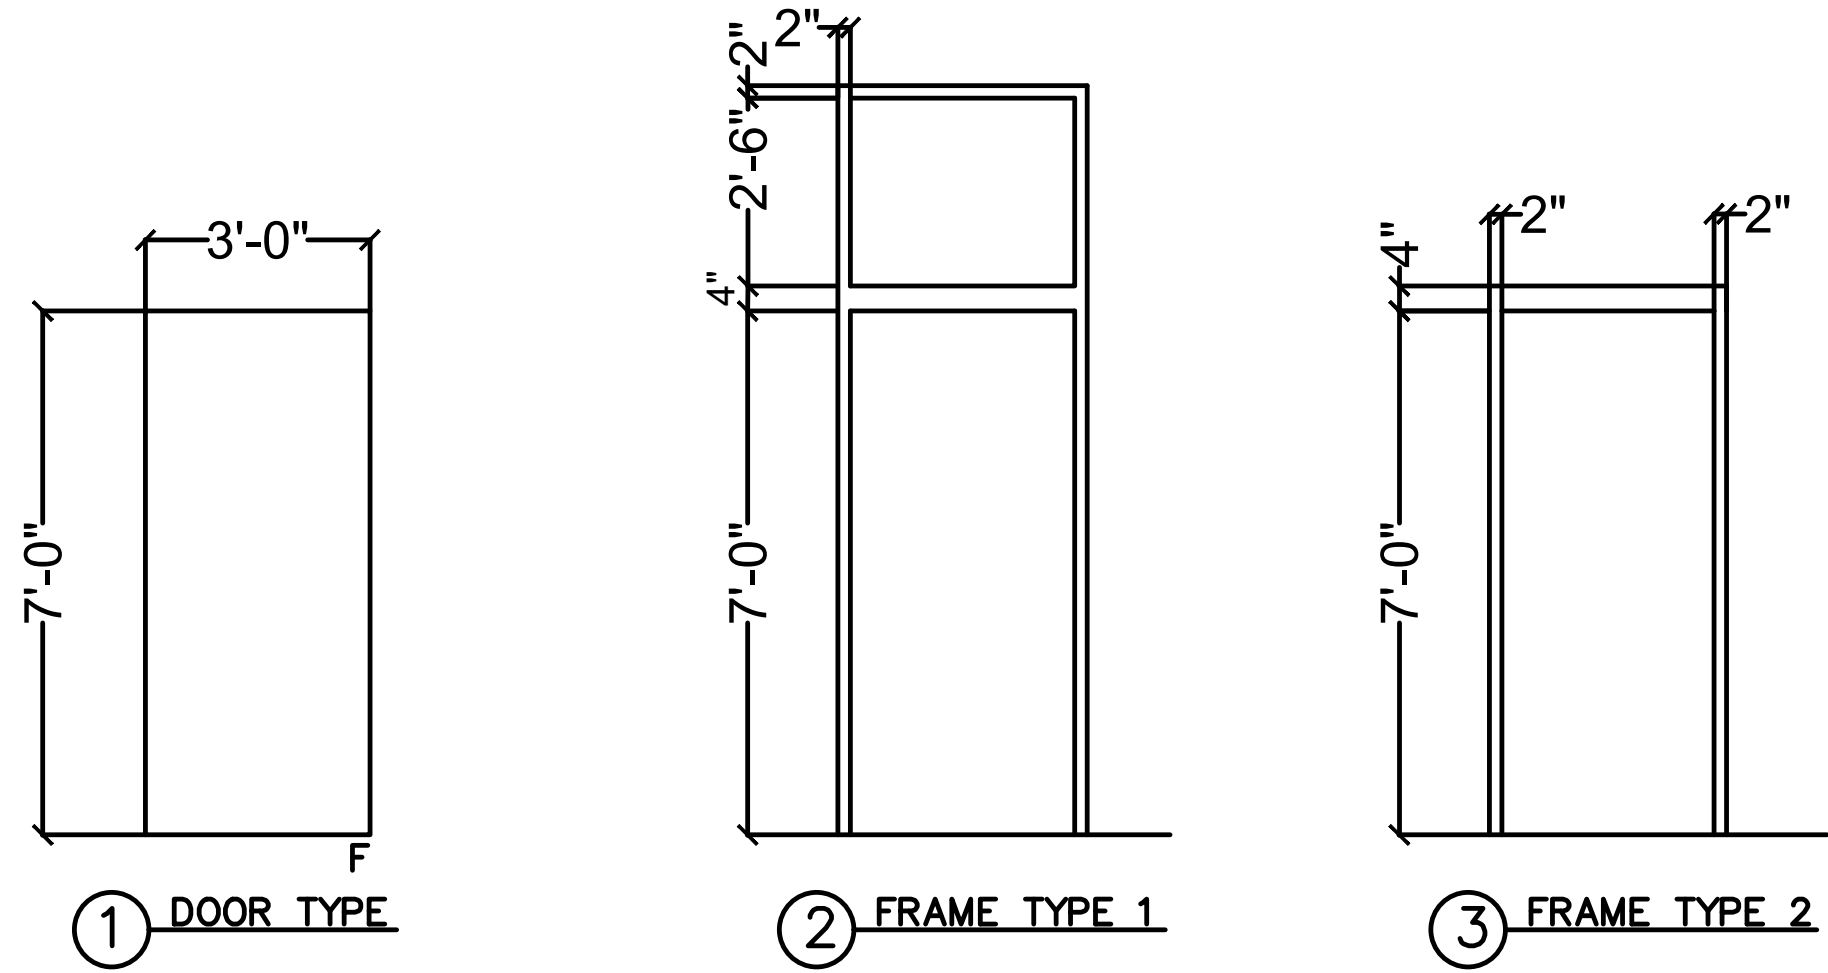FACILITY DRAWINGS  
This drawing was supplied by a Consultant, Engineer, from a project based on information provided by the Contractor to provide the Record Drawing. The City does not warrant this drawing to be a complete and accurate portrayal of facilities as they exist in the field.

REVISION	DATE	PROJECT NAME	CAD FILE NAME	DWG NUMBER	REMARKS



REVISIONS				
NO.	BY	DATE	CHKD	REMARKS
B	JWG	1/2024	JWG	90% SUBMITTAL
C	JWG	04/2024	JWG	AGENCY REVIEW
D	JWG	8/2024	JWG	ISSUED FOR CONSTRUCTION

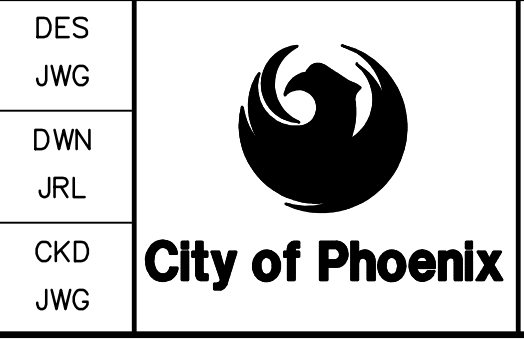

CITY OF PHOENIX  
WATER SERVICES DEPARTMENT  
  
LIFT STATION 40  
REFURBISHMENT

ARCHITECTURAL  
  
ELECTRICAL BUILDING  
SCHEDULES AND DETAILS

COPYRIGHT © 2007-JANUARY  
CITY PROJECT NO. WS90400085  
DATE: 04/2024  
A-09 SHEET 84 OF 134  
CAD FILE: CSAL40X09.DWG

THIS DRAWING MUST BE FIELD VERIFIED BEFORE USE  
DRAWING NOT TO SCALE UNLESS SCALE BAR IS PRESENT


**FOR CONSTRUCTION**

"PER CITY OF PHOENIX CODE CHAPTER 2, SECTION 2-2B, THESE PLANS ARE FOR OFFICIAL USE ONLY AND MAY NOT BE SHARED WITH OTHERS EXCEPT AS REQUIRED TO FULFILL THE OBLIGATIONS OF THE CONTRACTOR'S CONTRACT WITH THE CITY OF PHOENIX."  
THIS DOCUMENT MUST BE KEPT SECURE AT ALL TIMES.


HVAC SYMBOLGY		HVAC CONTROL SYMBOLGY		AIR FLOW SCHEMATIC AND TEMPERATURE CONTROL DIAGRAM SYMBOLGY	
	SUPPLY AIR OR OUTSIDE AIR DUCT UP (SECTION CUT, FIRST DIMENSION DUCT WIDTH)		FLEXIBLE CONNECTION		TEMPERATURE CONTROLLER
	SUPPLY AIR OR OUTSIDE AIR DUCT DOWN (NO SECTION CUT)		FLEXIBLE DUCT		TEMPERATURE TRANSMITTER
	RETURN AIR DUCT UP (SECTION CUT)		ACOUSTICAL LINING - DUCT DIMENSIONS FOR NET FREE AREA		TEMPERATURE SWITCH
	RETURN AIR DUCT DOWN (NO SECTION CUT)		SUPPLY AIR REGISTER OR EXTRACTOR - W/DUCT-MOUNTED EXTRACTOR		THERMOSTAT
	EXHAUST AIR DUCT UP (NO SECTION CUT)		EXHAUST AIR OR RETURN AIR REGISTER OR GRILLE		TEMPERATURE INDICATOR
	EXHAUST AIR DUCT DOWN (NO SECTION CUT)		EXHAUST AIR OR RETURN AIR REGISTER OR GRILLE		PERCENTAGE TIMER
	ROUND ELBOW UP		EXHAUST AIR OR RETURN AIR REGISTER OR GRILLE		RECEIVER CONTROLLER
	ROUND ELBOW DOWN		SUPPLY AIR ASSEMBLY SQUARE DIFFUSER		HAND-OFF-AUTO
	TRANSITION - DOUBLE SIDED		SUPPLY AIR ASSEMBLY ROUND DIFFUSER		MOTOR STARTER
	TRANSITION - ONE SIDED		WALL LOUVER		DAMPER ACTUATOR
	TRANSITION - RECTANGULAR TO ROUND DUCT		ACCESS DOOR		PRESSURE INDICATOR
	STANDARD BRANCH - FOR SUPPLY AIR W/EXTRACTOR AND RETURN AIR W/O EXTRACTOR		UNDERCUT DOOR 3/4"		FREEZE STAT
	ELBOW - W/TURNING VANE (RECTANGULAR)		ACCESS DOOR OR ACCESS PANEL IN DUCTWORK		FIRE STAT
	ELBOW - W/TURNING VANES (RECTANGULAR), SMOOTH RADIUS		INTAKE OR RELIEF HOOD		DIFFERENTIAL PRESSURE SWITCH
	GOOSENECK HOOD (COWL)		DOOR GRILLE		SMOKE DETECTOR
	RECTANGULAR DUCT OR OPENING SIZE - FIRST NUMBER INDICATES SIZE OF SIDE SHOWN		BACKDRAFT DAMPER		FLOW SWITCH
	ROUND DUCT SIZE		EXHAUST ROOF VENTILATOR PROPELLER OR CENTRIFUGAL TYPE		PRESSURE SWITCH
	RECTANGULAR DUCT INCLINE - RISE OR DROP IN RESPECT TO THE AIR FLOW		PROPELLER WALL FAN		TIME DELAY
	ROUND DUCT INCLINE - RISE OR DROP IN RESPECT TO THE AIR FLOW		ROOM AIR CONDITIONING UNIT		MINIMUM POSITION RELAY
	HIDDEN DUCT		INTAKE/EXHAUST LOUVER		SIGNAL
	DUCT ELEVATION TAG ABOVE FINISH FLOOR		SUPPLY, RETURN OR EXHAUST FAN		ANALOG OUTPUT
	PRESSURE/TEMPERATURE TEST PLUG (PETE PLUG OR EQUAL)		AIR FILTER		ANALOG INPUT
	SOUND ATTENUATOR				DIGITAL OUTPUT
	SPLITTER DAMPER				DIGITAL INPUT
	VD = VOLUME DAMPER BDD = BACKDRAFT DAMPER				COMMON PORT
	MOTOR OPERATED DAMPER				SIGNAL PORT
	FIRE DAMPER				NORMALLY OPEN
	SMOKE DAMPER				NORMALLY CLOSED
	SMOKE AND FIRE DAMPER				BALANCING VALVE
					RESISTANCE HEATING CONTACTOR
					TEST-AUTO
					TEST-OFF-AUTO
					ELECTRIC SIGNAL
					PIPING
					BULB-TYPE THERMOSTAT
<b>MISCELLANEOUS SYMBOLGY</b>					
			MIST ELIMINATOR		
			ACTIVATED CARBON OR CHEMICAL FILTER		
			CENTRIFUGAL PUMP		
			SPRAY NOZZLE/HUMIDIFIER		
<b>GENERAL NOTES:</b>					
1. THIS IS A STANDARD HVAC AND PLUMBING SYMBOLGY SHEET. ALL SYMBOLS ARE NOT NECESSARILY USED ON THIS PROJECT.					

FACILITY DRAWINGS  
This drawing was supplied by a Consultant Engineer from a past construction project. The original construction drawing was modified based on information provided by the Contractor to provide the Record Drawing. The City does not warrant the accuracy and reliability of the information and accuracy of the data as they exist in the field.

REVISION #	DATE	CAD FILE NAME	DWG NUMBER	REMARKS
1				
2				
3				
4				
5				
6				
7				
8				
9				
10				

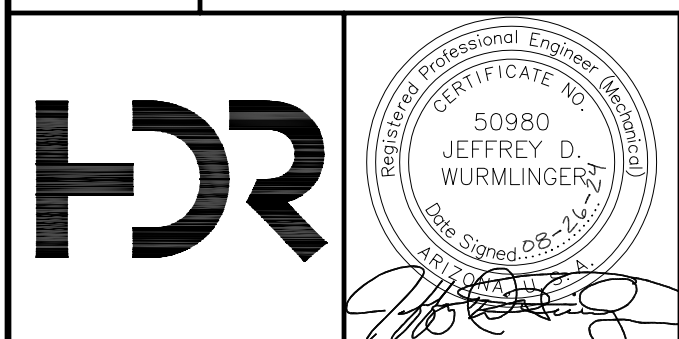

REVISIONS					DES
NO.	BY	DATE	CKD	REMARKS	JW
A	CM	01/2024	JW	90% SUBMITTAL	DWN
B	CM	04/2024	JW	AGENCY REVIEW	CM
C	CM	08/2024	JW	ISSUED FOR CONSTRUCTION	CKD

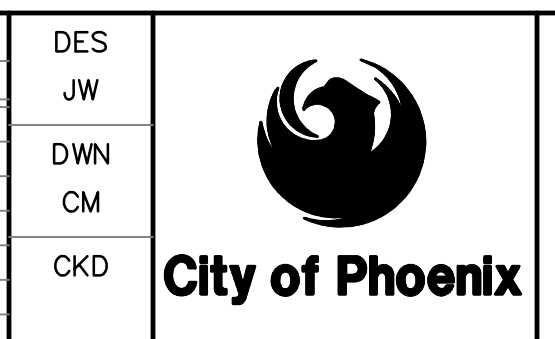

CITY OF PHOENIX  
WATER SERVICES DEPARTMENT  
**LIFT STATION 40  
REFURBISHMENT**

HVAC  
**LEGEND AND SYMBOLS**


COPYRIGHT © 2007-JANUARY  
CITY PROJECT NO. WS90400085  
DATE: 01/2024  
**H-01** SHEET 85 OF 134  
CAD FILE: CSMLS40A01.dwg

USER:CMCDONAL FILE:C:\PWORKING\west01\3441626\CSMLS40A01.dwg DATE:8/26/24 TIME:04:18pm


THIS DRAWING MUST BE FIELD VERIFIED BEFORE USE  
DRAWING NOT TO SCALE UNLESS SCALE BAR IS PRESENT

FOR CONSTRUCTION


"PER CITY OF PHOENIX CODE CHAPTER 2, SECTION 2-2B, THESE PLANS ARE FOR OFFICIAL USE ONLY AND MAY NOT BE SHARED WITH OTHERS EXCEPT AS REQUIRED TO FULFILL THE OBLIGATIONS OF THE CONTRACTOR'S CONTRACT WITH THE CITY OF PHOENIX."  
THIS DOCUMENT MUST BE KEPT SECURE AT ALL TIMES.

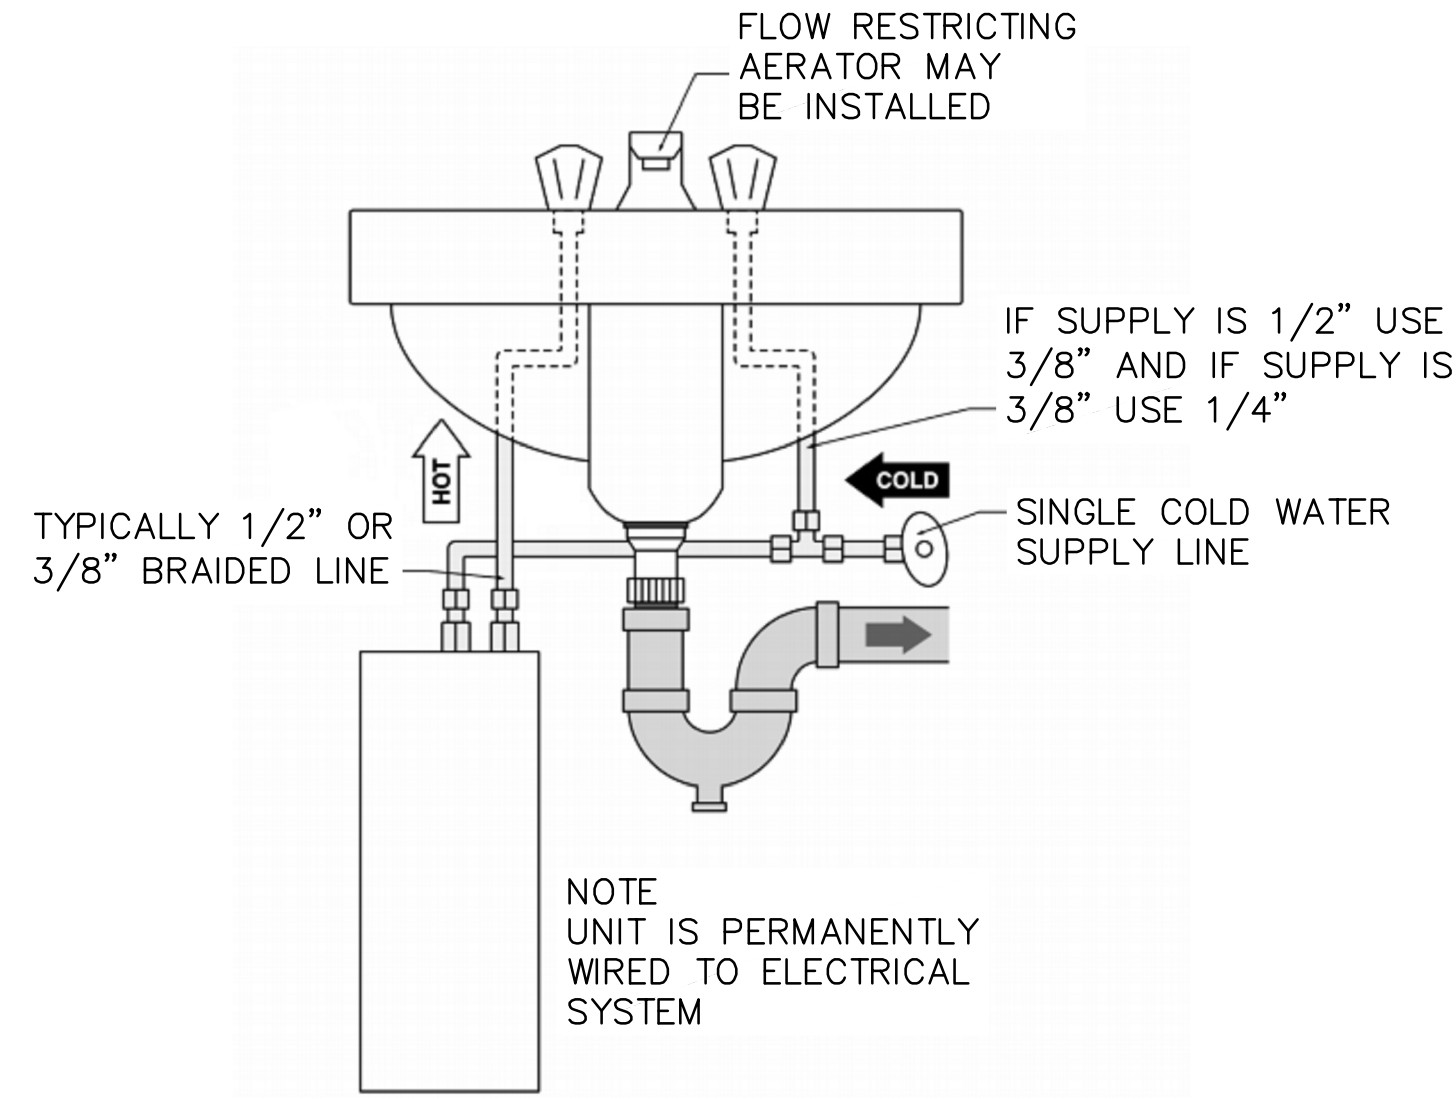


UNDERSINK INSTANT WATER HEATER DETAIL 3  
SCALE: NTS

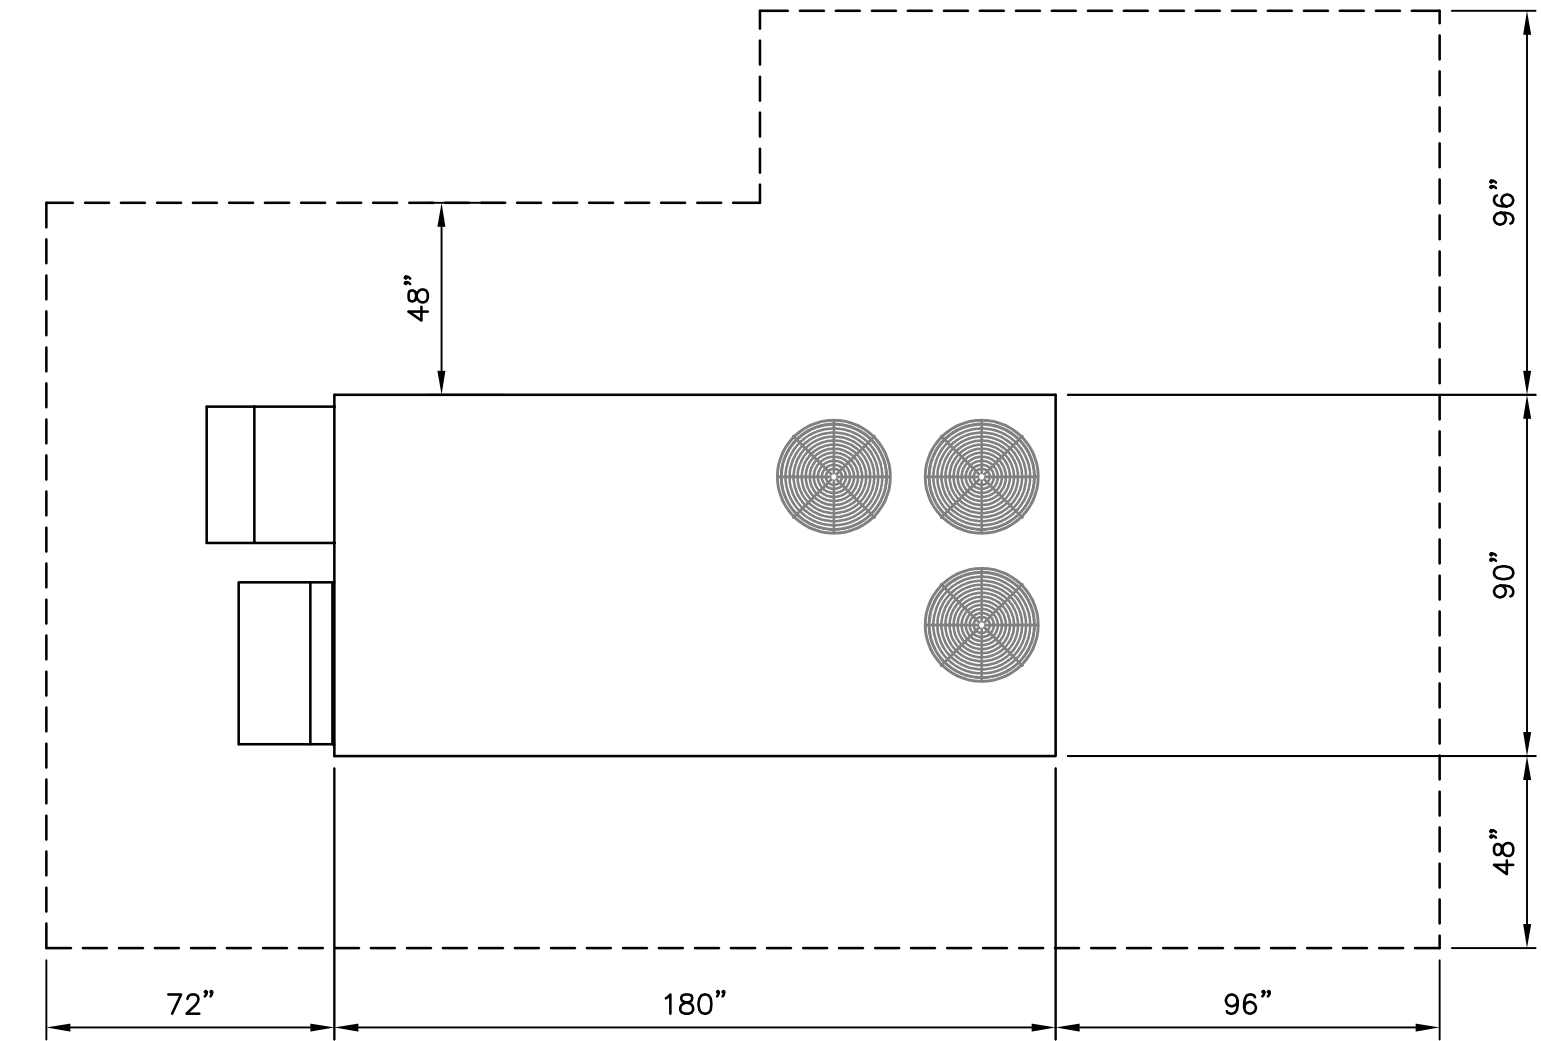

AIR HANDLING UNIT DETAIL 1  
SCALE: NTS

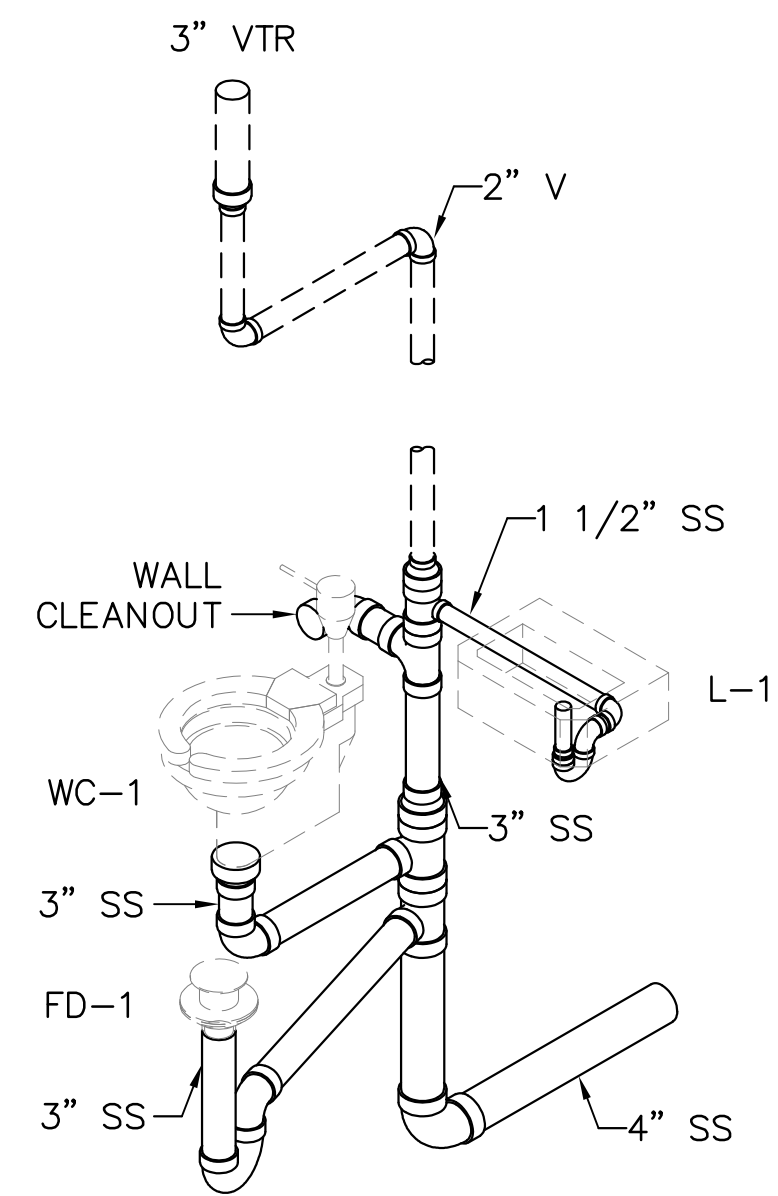

PLUMBING RISER DIAGRAM DETAIL 4  
SCALE: NTS

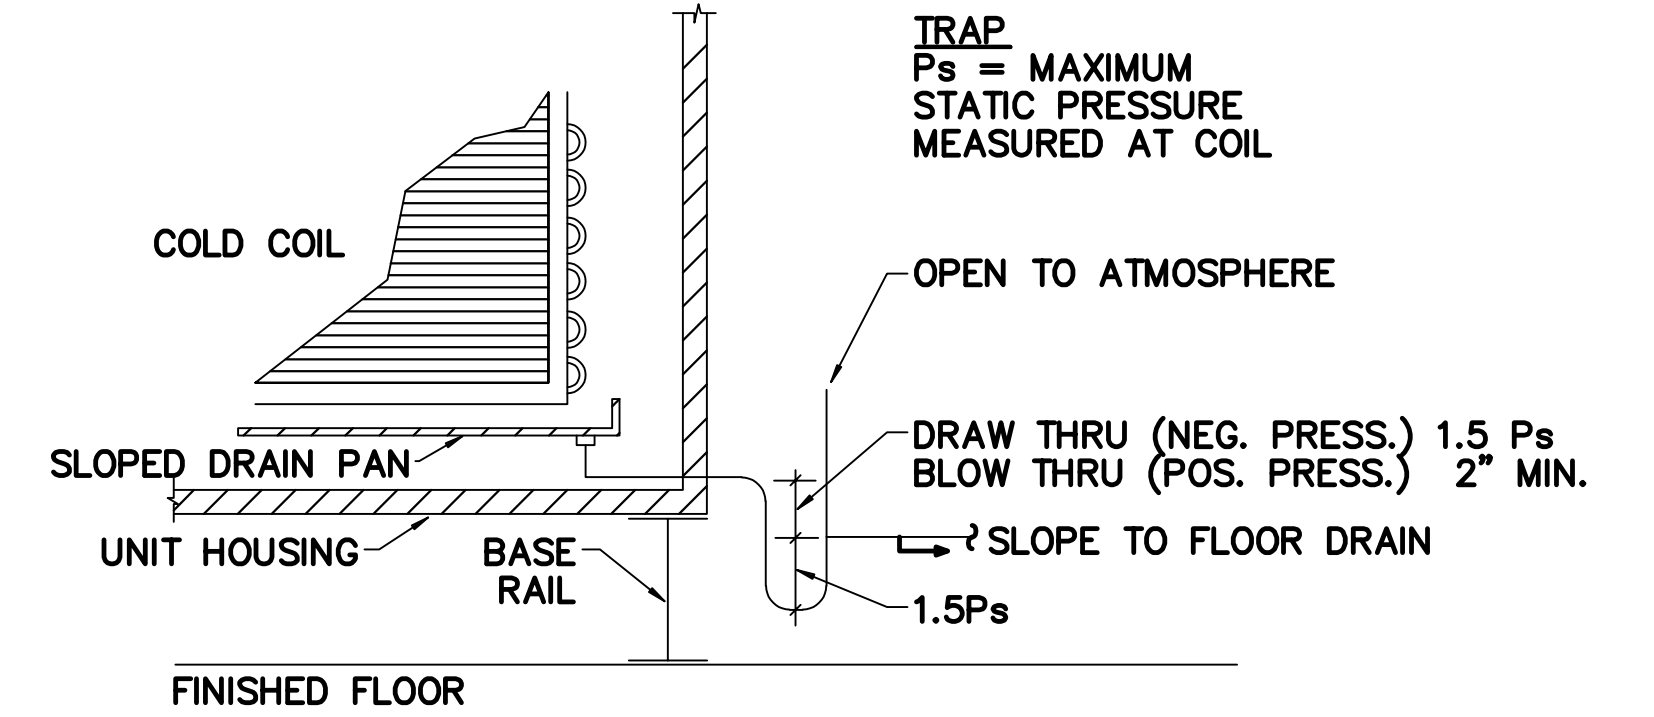


NOTES:  
1. TRAP AND DRAIN PIPING SIZE TO BE THE LARGER OF THE OUTLET SIZES OR THE FOLLOWING:

COOLING CAPACITY (MBH)	NOMINAL PIPE SIZE
UP TO 200	3/4"
201 TO 450	1"
451 TO 1000	1 1/4"
1001 TO 1500	1 1/2"
1501 TO 3000	2"

2. INSULATE TRAP AND DRAIN PIPING WITH 1/2" CLOSED CELL POLYETHYLENE FOAM INSULATION.

COIL CONDENSATE DRAIN PIPING DETAIL 2  
SCALE: NTS

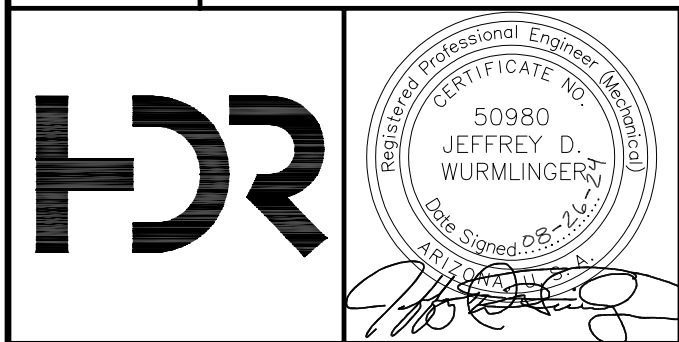

REVISIONS					REMARKS
NO.	BY	DATE	CHKD		
A	CM	01/2024	JW	90% SUBMITTAL	
B	CM	04/2024	JW	AGENCY REVIEW	
C	CM	08/2024	JW	ISSUED FOR CONSTRUCTION	

DES  
JW  
DWN  
CM  
CKD



CITY OF PHOENIX  
WATER SERVICES DEPARTMENT  
  
LIFT STATION 40  
REFURBISHMENT

HVAC  
  
HVAC/PLUMBING DETAILS

COPYRIGHT © 2007-JANUARY  
CITY PROJECT NO. WS90400085  
DATE: 01/2024  
H-02 SHEET 86 OF 134  
CAD FILE: CSHLS40D01.dwg

FACILITY DRAWINGS  
This drawing was supplied by a Consultant Engineer from a past construction project. The original construction drawing was modified based on information provided by the Contractor to provide the Record Drawing. The City does not warrant the accuracy and reliability of the information and accurate portrayal of facilities as they exist in the field.

REVISION	ENGINEERING COMPANY	PROJECT NO.	PROJECT NAME	REFERENCE	OID NUMBER	DATE	CAD FILE NAME	DWG NUMBER	REMARKS
#									


THIS DRAWING MUST BE FIELD VERIFIED BEFORE USE  
DRAWING NOT TO SCALE UNLESS SCALE BAR IS PRESENT

**FOR CONSTRUCTION**

"PER CITY OF PHOENIX CODE CHAPTER 2, SECTION 2-2B, THESE PLANS ARE FOR OFFICIAL USE ONLY AND MAY NOT BE SHARED WITH OTHERS EXCEPT AS REQUIRED TO FULFILL THE OBLIGATIONS OF THE CONTRACTOR'S CONTRACT WITH THE CITY OF PHOENIX."  
THIS DOCUMENT MUST BE KEPT SECURE AT ALL TIMES.


**KEY NOTES**

- 1 36X36 SUPPLY AIR DUCT UP.
- 2 36X36 RETURN AIR DUCT UP.
- 3 36X18 RETURN AIR DUCT WITH 1/4" SQUARE WELDED WIRE FABRIC IN A REMOVABLE FRAME.
- 4 INDOOR UNIT (SPLIT AIR CONDITIONING UNIT) MOUNTED HIGH ON WALL. INSTALLED PER MANUFACTURER'S INSTRUCTIONS. ROUTE CONDENSATE DRAIN THRU WALL AND DOWN. SPILL TO GRADE IN AN APPROPRIATE LANDSCAPING AREA. SEE 2  
H-03 H-02
- 5 CEILING MOUNTED TOILET EXHAUST FAN: GREENHECK, SP-B70-QD (35-89CFM), 115V/1PH/60HZ ROUTE 6" RIGID DUCT TO EXTERIOR WALL. TERMINATE AT WALL WITH VENT CAP INCLUDING BACKDRAFT DAMPER AND BIRDSCREEN. SET FAN TO HIGH SPEED.

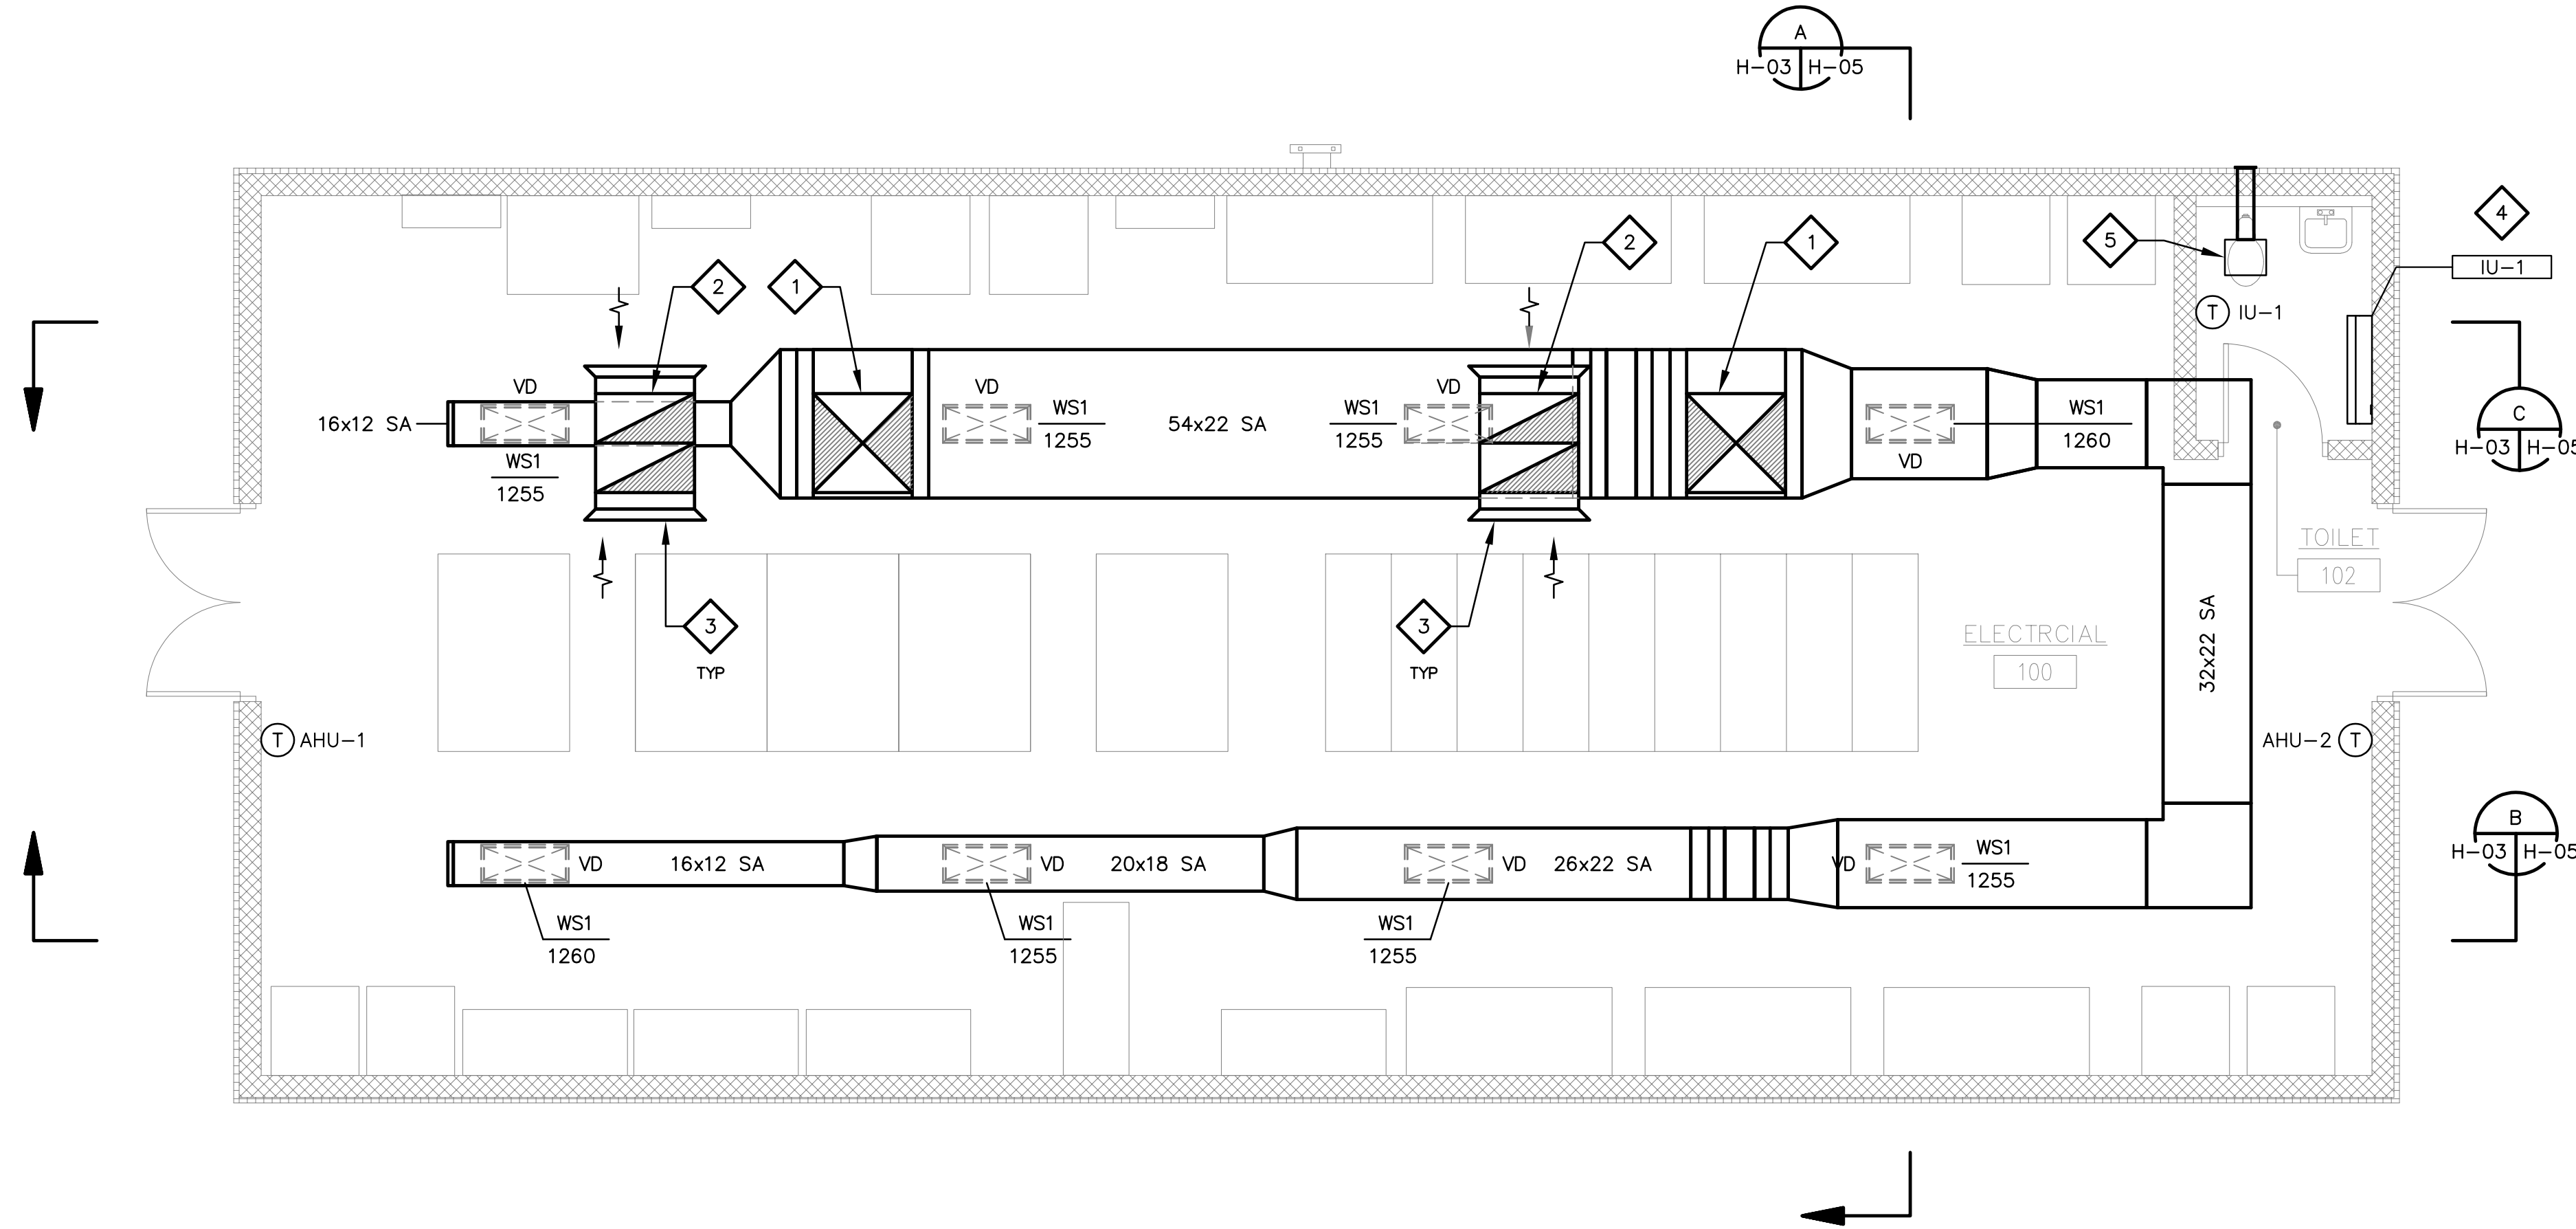

**ELECTRICAL BUILDING HVAC PLAN** 1

SCALE: 1/4" = 1'-0"

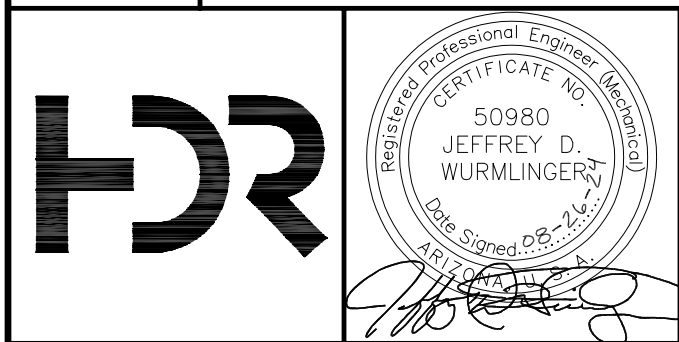

REVISIONS				
NO.	BY	DATE	CKD	REMARKS
A	CM	01/2024	JW	90% SUBMITTAL
B	CM	04/2024	JW	AGENCY REVIEW
C	CM	08/2024	JW	ISSUED FOR CONSTRUCTION

DES  
JW  
DWN  
CM  
CKD



CITY OF PHOENIX  
WATER SERVICES DEPARTMENT  
  
LIFT STATION 40  
REFURBISHMENT

HVAC

**ELECTRICAL BUILDING HVAC PLAN**

COPYRIGHT © 2007-JANUARY  
CITY PROJECT NO. WS90400085  
DATE: 01/2024  
H-03 SHEET 87 OF 134  
CAD FILE: CSHLS40P01.dwg

FACILITY DRAWINGS  
This drawing was supplied by a Consultant Engineer from a past construction project. The original construction drawing was modified based on information provided by the Contractor to provide the Record Drawing. The City does not warrant the accuracy and reliability of the information and accurate portrayal of facilities as they exist in the field.

REVISION #	FOR CITY OF PHOENIX USE ONLY	PROJECT NO.	PROJECT NAME	DATE	CAD FILE NAME	DWG NUMBER	REMARKS
1							


THIS DRAWING MUST BE FIELD VERIFIED BEFORE USE  
DRAWING NOT TO SCALE UNLESS SCALE BAR IS PRESENT

FOR CONSTRUCTION

"PER CITY OF PHOENIX CODE CHAPTER 2, SECTION 2-2B, THESE PLANS ARE FOR OFFICIAL USE ONLY AND MAY NOT BE SHARED WITH OTHERS EXCEPT AS REQUIRED TO FULFILL THE OBLIGATIONS OF THE CONTRACTOR'S CONTRACT WITH THE CITY OF PHOENIX."  
THIS DOCUMENT MUST BE KEPT SECURE AT ALL TIMES.


**KEY NOTES**

- 1 AIR HANDLING UNIT WITH ASSOCIATED ROOF CURB. INSTALL PER MANUFACTURER'S INSTRUCTIONS. ROUTE CONDENSATE DRAIN ACROSS ROOF, DOWN WALL AND SPILL TO GRADE IN AN APPROPRIATE LANDSCAPING AREA. SEE 1 AND 2  
H-04 H-02 H-04 H-02
- 2 EQUIPMENT CLEARANCE.
- 3 36X36 SUPPLY AIR DUCT DOWN.
- 4 36X36 RETURN AIR DUCT DOWN.
- 5 OUTDOOR UNIT (SPLIT AIR CONDITIONING UNIT) MOUNTED ON ROOF CURB OR SUPPORTED FROM ARCHITECTURAL SCREEN WALL. INSTALL PER MANUFACTURER'S INSTRUCTIONS.

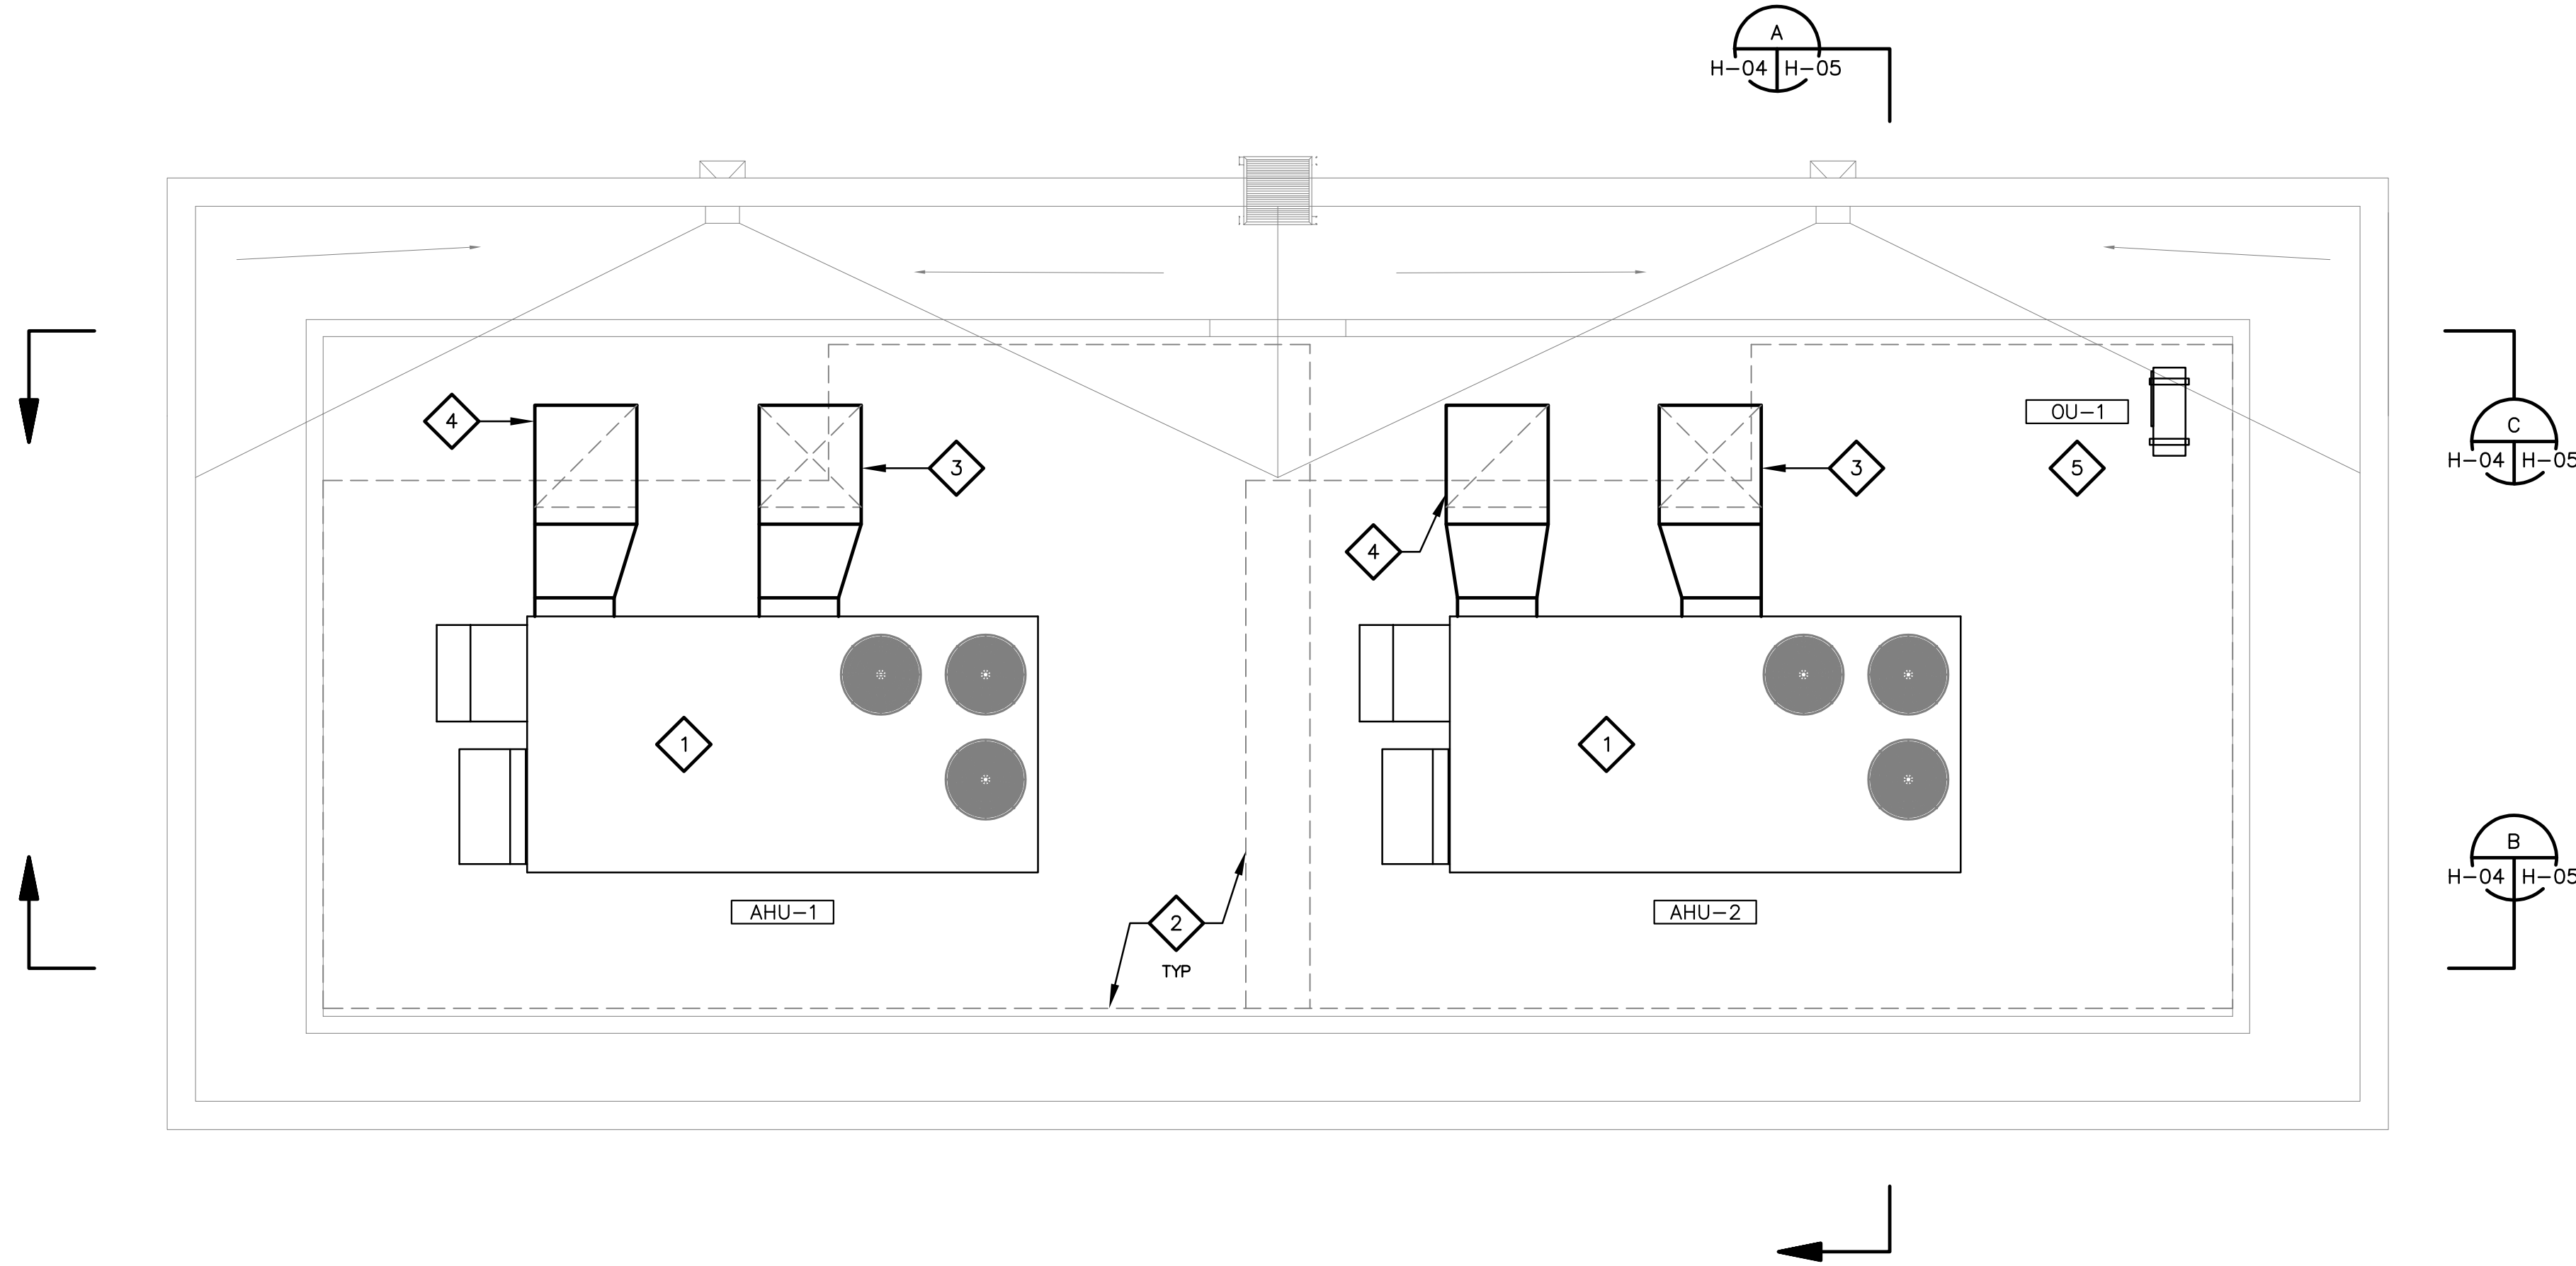

ELECTRICAL BUILDING HVAC ROOF PLAN 1

SCALE: 1/4" = 1'-0"

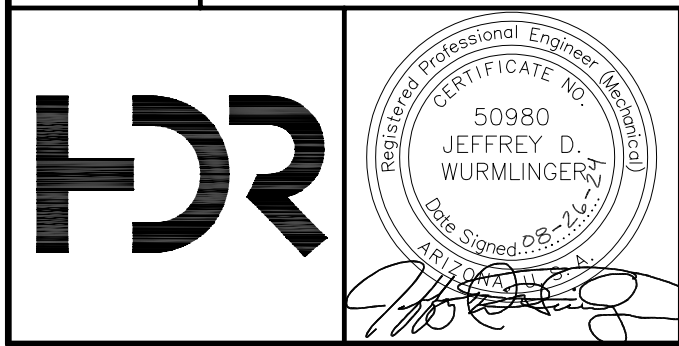

REVISIONS				
NO.	BY	DATE	CKD	REMARKS
A	CM	01/2024	JW	90% SUBMITTAL
B	CM	04/2024	JW	AGENCY REVIEW
C	CM	08/2024	JW	ISSUED FOR CONSTRUCTION

DES  
JW  
DWN  
CM  
CKD



CITY OF PHOENIX  
WATER SERVICES DEPARTMENT  
  
LIFT STATION 40  
REFURBISHMENT

HVAC  
  
ELECTRICAL BUILDING HVAC ROOF PLAN

COPYRIGHT © 2007-JANUARY  
CITY PROJECT NO. WS90400085  
DATE: 01/2024  
H-04 SHEET 88 OF 134  
CAD FILE: CSHLS40P02.dwg

FACILITY DRAWINGS  
This drawing was supplied by a Consultant Engineer from a past construction project. The original construction drawing was modified based on information provided by the Contractor to provide the Record Drawing. The City does not warrant the accuracy and reliability of the information and accurate portrayal of facilities as they exist in the field.


REVISION #	ENGINEERING COMPANY	PROJECT NO.	PROJECT NAME	DATE	CAD FILE NAME	DWG NUMBER	REMARKS
1							




THIS DRAWING MUST BE FIELD VERIFIED BEFORE USE  
DRAWING NOT TO SCALE UNLESS SCALE BAR IS PRESENT

FOR CONSTRUCTION


"PER CITY OF PHOENIX CODE CHAPTER 2, SECTION 2-28, THESE PLANS ARE FOR OFFICIAL USE ONLY AND MAY NOT BE SHARED WITH OTHERS EXCEPT AS REQUIRED TO FULFILL THE OBLIGATIONS OF THE CONTRACTOR'S CONTRACT WITH THE CITY OF PHOENIX."  
THIS DOCUMENT MUST BE KEPT SECURE AT ALL TIMES.

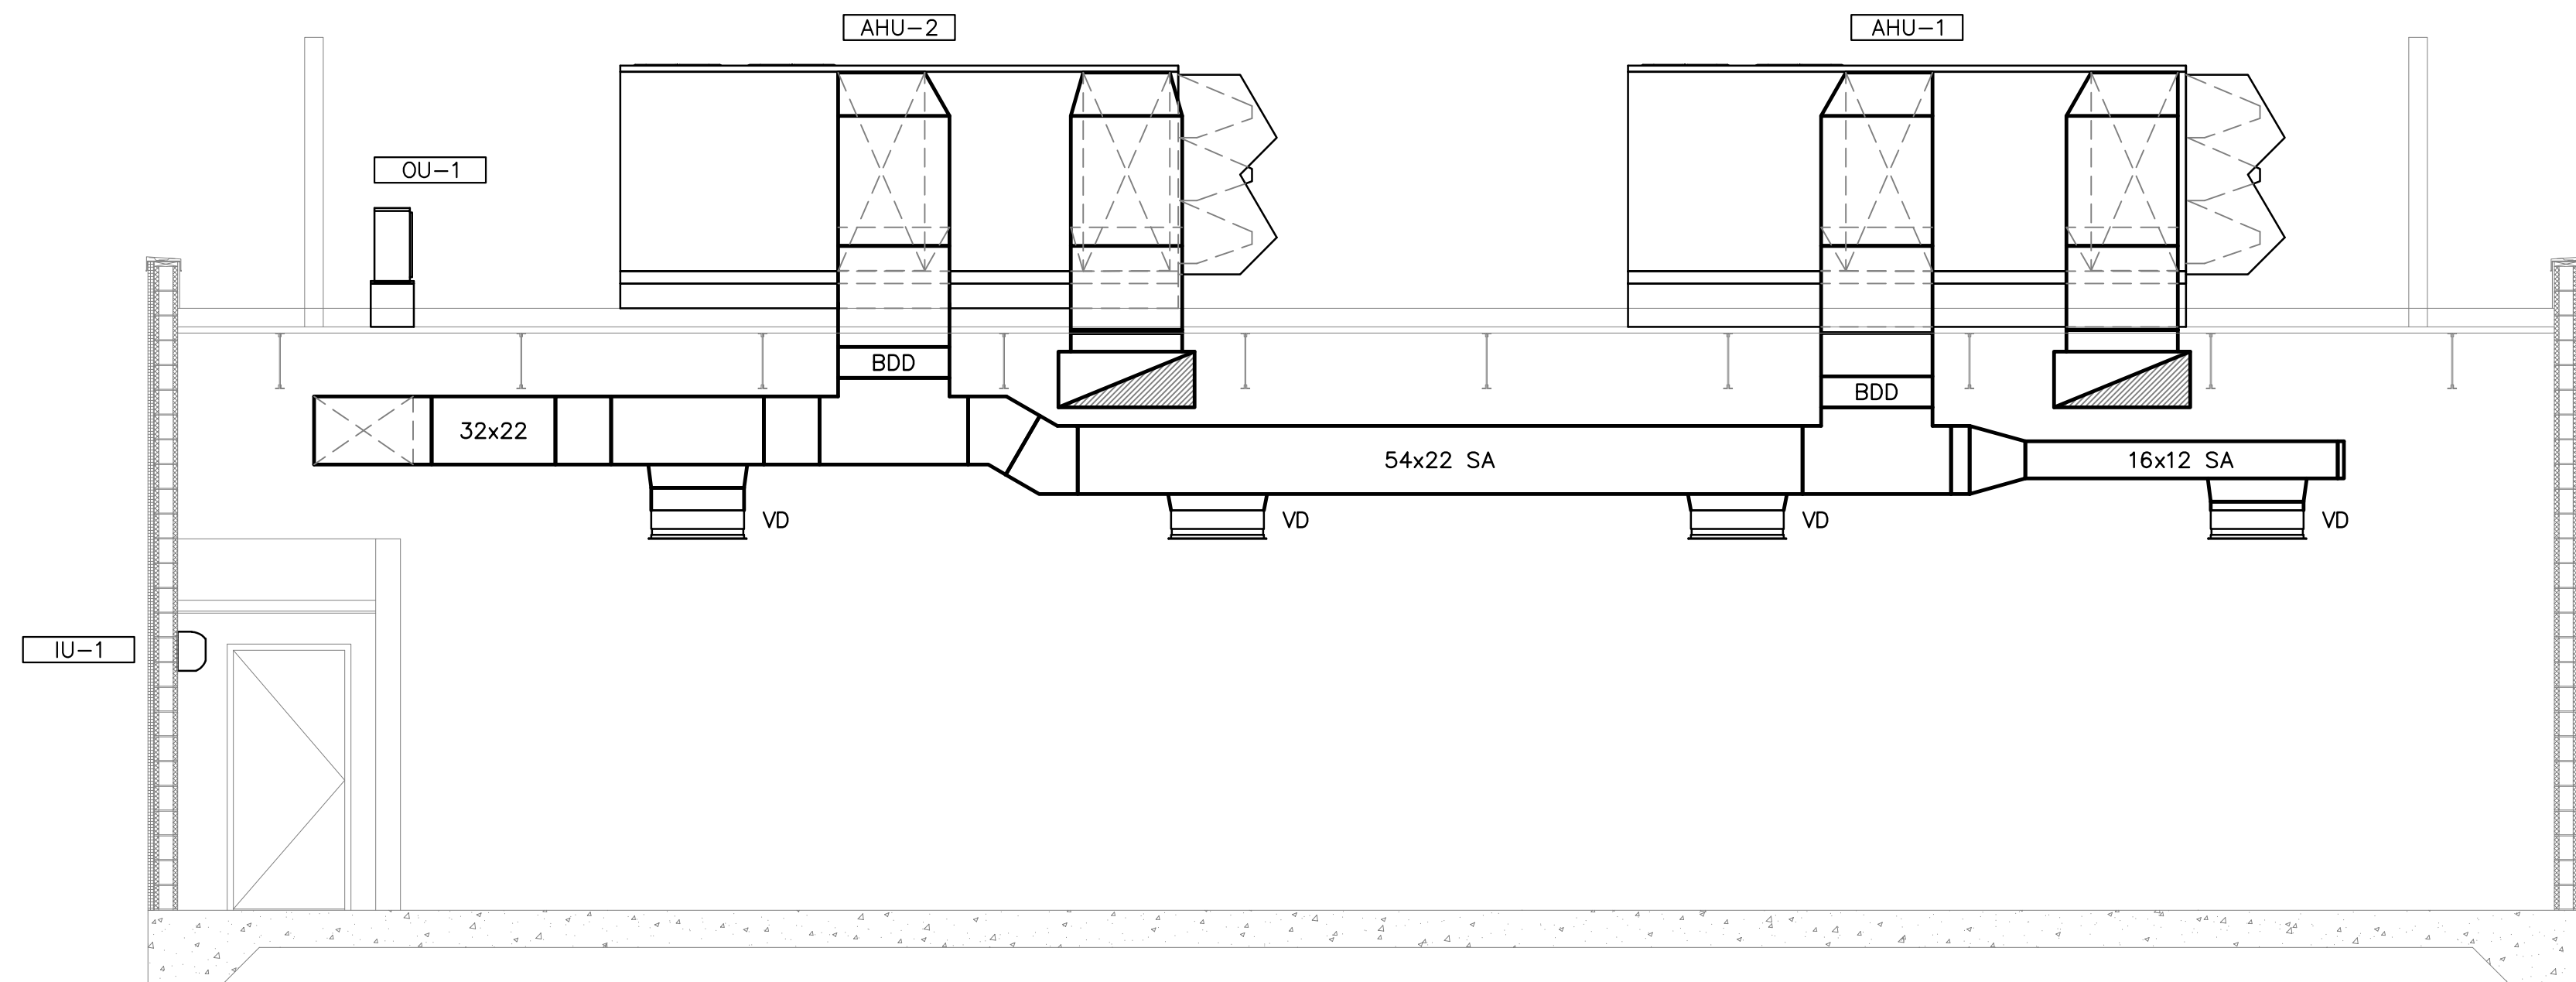


SECTION C  
SCALE: 1/4" = 1'-0"

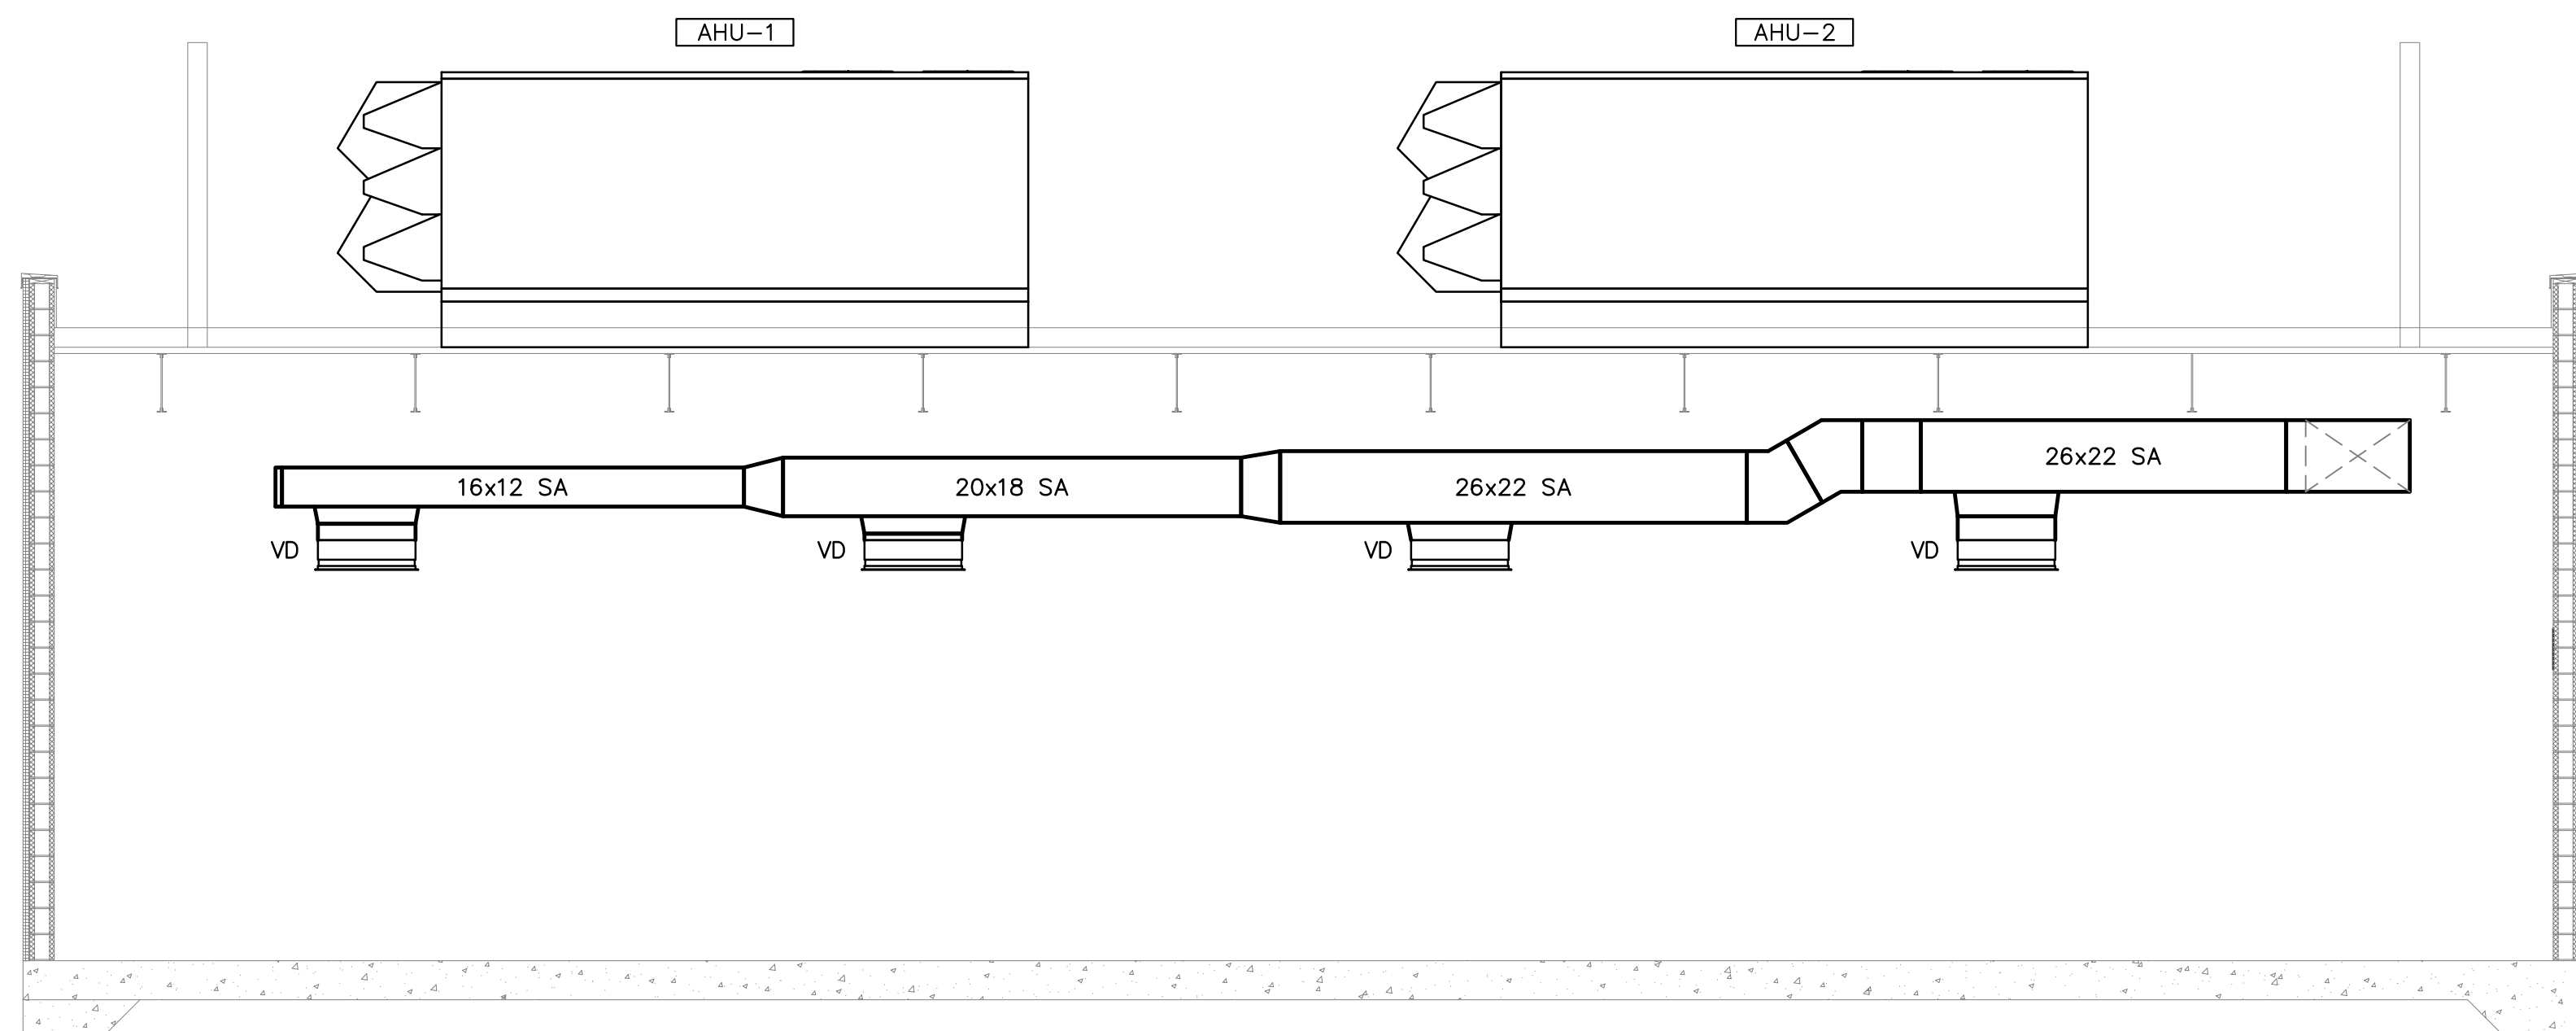

SECTION B  
SCALE: 1/4" = 1'-0"

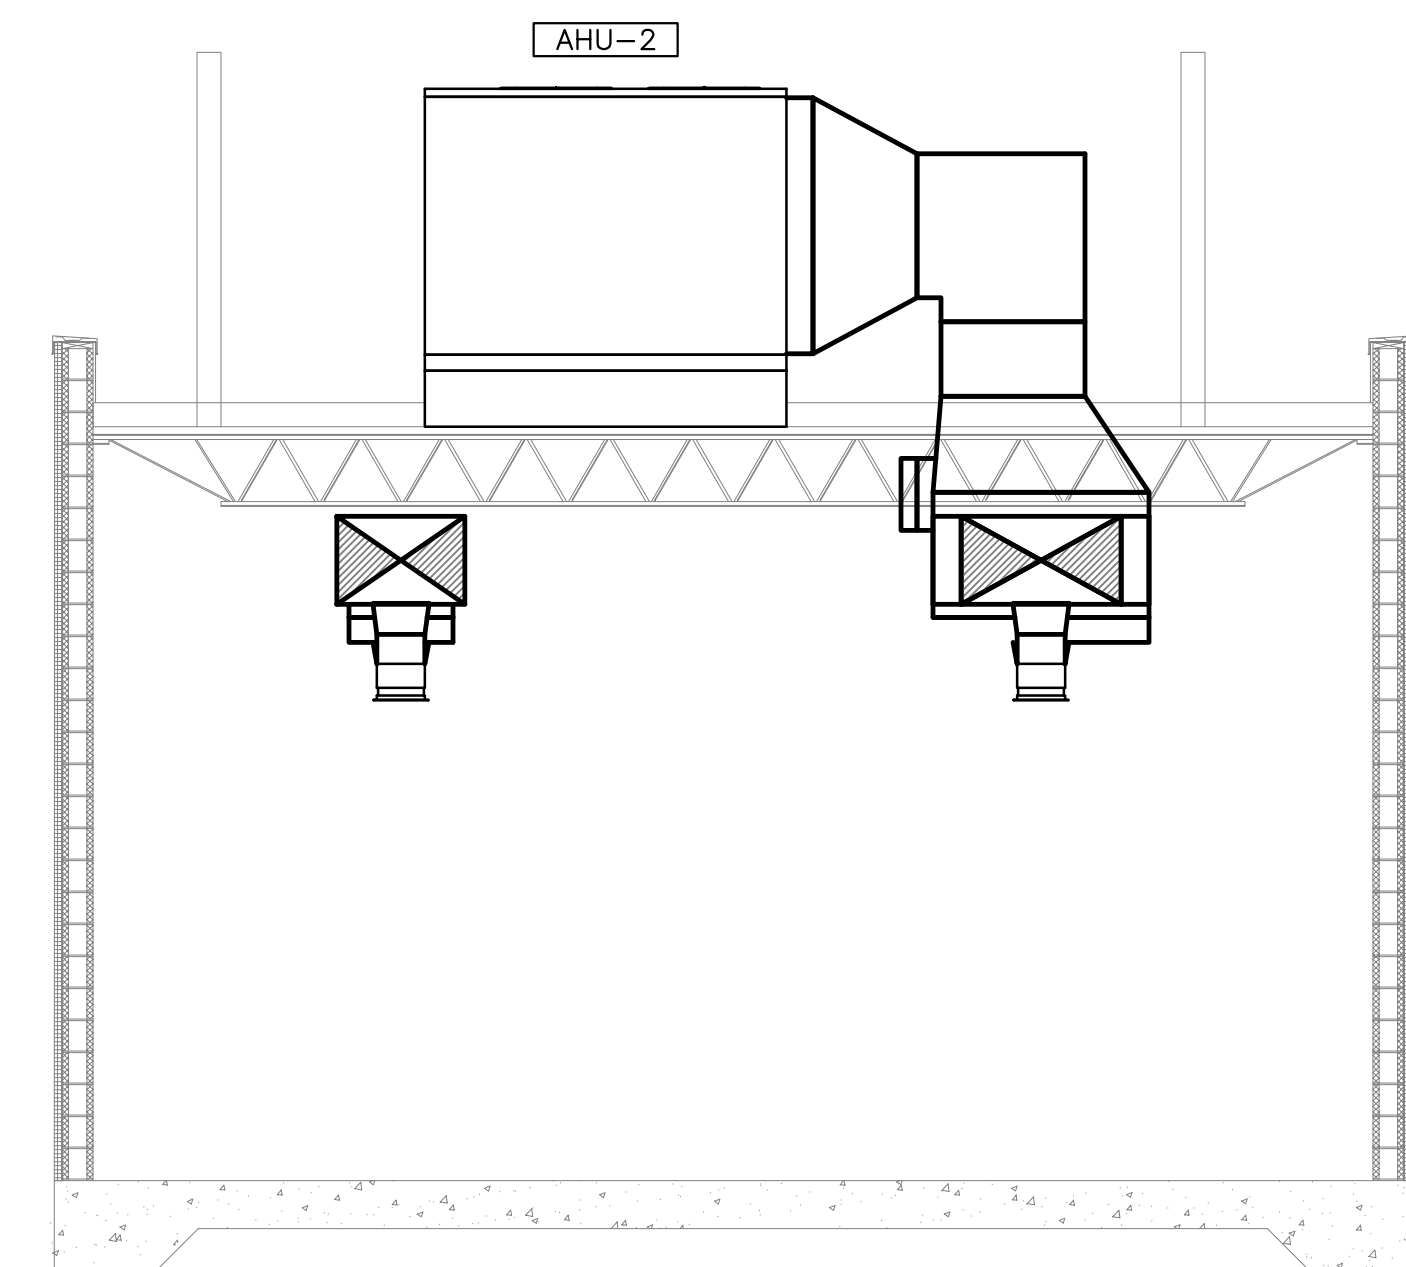

SECTION A  
SCALE: 1/4" = 1'-0"

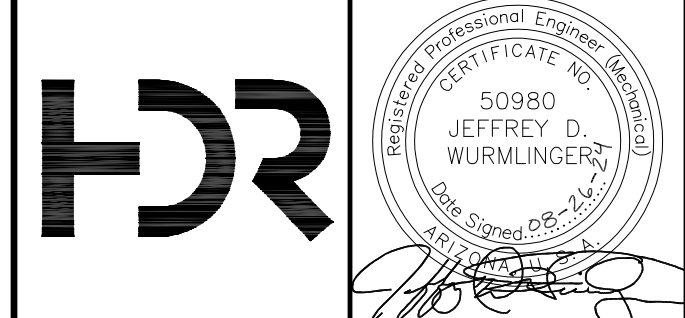

REVISIONS					
NO.	BY	DATE	CKD	REVISIONS	REMARKS
A	CM	01/2024	JW	90% SUBMITTAL	
B	CM	04/2024	JW	AGENCY REVIEW	
C	CM	08/2024	JW	ISSUED FOR CONSTRUCTION	

DES  
JW  
DWN  
CM  
CKD

CITY OF PHOENIX  
WATER SERVICES DEPARTMENT  
  
LIFT STATION 40  
REFURBISHMENT

HVAC  
  
HVAC SECTIONS

COPYRIGHT © 2007—JANUARY  
CITY PROJECT NO. WS90400085  
DATE: 01/2024  
H-05 SHEET 89 OF 134  
CAD FILE: CSHLS40Q01.dwg

FACILITY DRAWINGS  
This drawing was supplied by a Consultant Engineer from a past construction project. The original construction drawing was modified based on information provided by the Contractor to provide the Record Drawing. The City does not warrant the accuracy and reliability of the information and accurate portrayal of facilities as they exist in the field.

REVISION	ENGINEERING COMPANY	PROJECT NO.	PROJECT NAME	DATE	CAD FILE NAME	DWG NUMBER	REMARKS
#	-	-	-	-	-	-	-
#	-	-	-	-	-	-	-

USER:CMCDONAL FILE:C:\PWORKING\west01\3411626\_CSHLS40Q001.dwg DATE:8/26/24 TIME:04:22pm

THIS DRAWING MUST BE FIELD VERIFIED BEFORE USE  
DRAWING NOT TO SCALE UNLESS SCALE BAR IS PRESENT

FOR CONSTRUCTION

"PER CITY OF PHOENIX CODE CHAPTER 2, SECTION 2-28, THESE PLANS ARE FOR OFFICIAL USE ONLY AND MAY NOT BE SHARED WITH OTHERS EXCEPT AS REQUIRED TO FULFILL THE OBLIGATIONS OF THE CONTRACTOR'S CONTRACT WITH THE CITY OF PHOENIX."  
THIS DOCUMENT MUST BE KEPT SECURE AT ALL TIMES.

PLUMBING FIXTURE CONNECTION SCHEDULE								
MARK NUMBER	FIXTURE DESCRIPTION	SPECIFICATION SECTION	PIPE DIAMETER (IN)				WATER FLOW RATE	NOTES
			CW	HW	WASTE	VENT		
WC-1	WATER CLOSET	-	1"	-	3"	2"	1.28 GPF	FLOOR MOUNT
L-1	LAVATORY	-	1/2"	1/2"	1 1/2"	1 1/2"	0.5 GPM	WALL HUNG
FD-1	FLOOR SINK	-	-	-	3"	1 1/2"	-	-
TP-1	TRAP PRIMER	-	1/2"	-	-	-	-	-

NOTES:  
SEE PLANS AND RISER DIAGRAMS FOR DRAIN AND PIPE SIZE REQUIREMENTS.

AIR HANDLING UNIT SCHEDULE									
MARK NUMBER	LOCATION	SERVES	NOMINAL AIRFLOW CFM	VOLT/PH	ELECTRICAL FLA	MCA	WEIGHT LBS	BASIS OF DESIGN	NOTES
AHU-2	ROOF	ELECTRICAL ROOM	10000	460 / 3		75.80	4532.0	TRANE TCH330B4	1, 2

NOTES:  
1. PROVIDE PREFABRICATED ROOF CURB.  
2. AIR HANDLING UNIT (AHU-2) PROVIDES REDUNDANCY

DIFFUSER, REGISTER, AND GRILLE SCHEDULE											
MARK NUMBER	MAX AIRFLOW CFM	FACE SIZE IN (WXH)	CONNECTION SIZE, IN (WXH OR DIA)	MAX STATIC PRESS DROP IN WG	MAX NC	MOUNTING LOCATION	FRAME TYPE	MATERIAL	FINISH	BASIS OF DESIGN	NOTES


NOTES:  
1. ADJUSTABLE DOUBLE DEFLECTION GRILLE WITH 3/4 IN BLADE SPACING AND FRONT BLADES PARALLEL TO THE HEIGHT (H) DIMENSION.

WATER HEATER SCHEDULE									
MARK NUMBER	KW	AMP	VOLT	TURN ON GPM	0.3 GPM	0.5 GPM	1.0 GPM	1.5 GPM	NOTES

SPLIT AIR CONDITIONING UNIT SCHEDULE														
MARK NUMBER	LOCATION / SERVES	TYPE	INDOOR EVAPORATOR UNIT DATA							ELECTRICAL				WEIGHT LBS
			FAN				COOLING COIL			FLA	MCA	V / PH		
			AIRFLOW CFM	EXT SP IN WC	COUNT	SPEED	TOTAL CAP BTUH	SENS CAP BTUH	EAT DB/WB DEG F				LAT DB DEG F	
OU-1 / IU-1	ROOF / TOILET	WALL MOUNT	437	0	1	HIGH	5240.0	5240.0	80 / 67	68.7	POWERED BY OUTDOOR UNIT		40	


SPLIT AIR CONDITIONING UNIT SCHEDULE (CONTINUED)													
TYPE	AMB AIR		COMPRESSOR		REFRIGERANT		EFFICIENCY		ELECTRICAL		WEIGHT LBS	BASIS OF DESIGN INDOOR / OUTDOOR	NOTES
	TEMP DB	DEG F	COUNT	STEPS EACH	TYPE	EER BTUH/W	SEER BTUH/W	MCA	MOCP	V / PH			
	ROTARY	115		1	R410A	R410A	19.0	33.1	11	15			

NOTES:  
INDOOR UNIT SHALL BE POWERED FROM OUTDOOR UNIT - SINGLE CIRCUIT SERVES BOTH INDOOR AND OUTDOOR UNIT.  
PROVIDE HARDWIRED WALL-MOUNT THERMOSTAT WITH THE INDOOR UNIT. WIRELESS CONTROLS IS NOT ACCEPTABLE.  
PROVIDE INDOOR UNIT CONDENSATE PUMP.

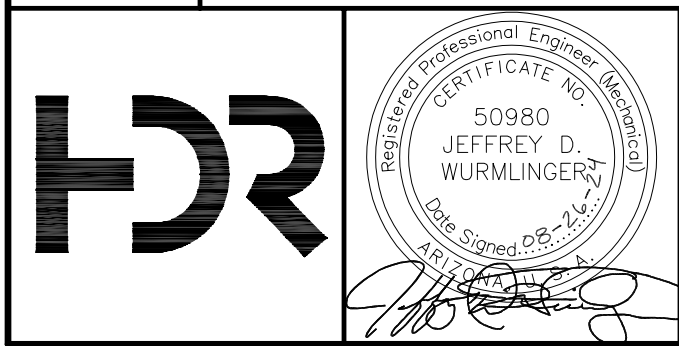

REVISIONS				
NO.	BY	DATE	CKD	REMARKS
A	CM	01/2024	JW	90% SUBMITTAL
B	CM	04/2024	JW	AGENCY REVIEW
C	CM	08/2024	JW	ISSUED FOR CONSTRUCTION

DES	JW
DWN	CM
CKD	CM

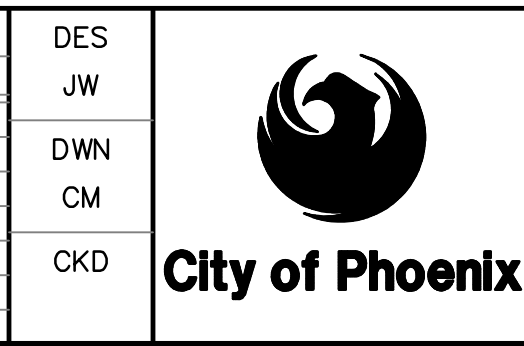

CITY OF PHOENIX  
WATER SERVICES DEPARTMENT  
  
LIFT STATION 40  
REFURBISHMENT

HVAC  
  
HVAC/PLUMBING SCHEDULES

COPYRIGHT © 2007-JANUARY  
CITY PROJECT NO. WS90400085  
DATE: 01/2024  
H-06 SHEET 90 OF 134  
CAD FILE: CSHLS40X01.dwg


FACILITY DRAWINGS  
This drawing was supplied by a Consultant Engineer from a past construction project. The original construction drawing was modified based on information provided by the Contractor to provide the Record Drawing. The City does not warrant the accuracy and reliability of the information and accurate portrayal of facilities as they exist in the field.

REVISION	ENGINEERING COMPANY	PROJECT NO.	PROJECT NAME	DATE	CAD FILE NAME	DWG NUMBER	REMARKS
#							
#							

THIS DRAWING MUST BE FIELD VERIFIED BEFORE USE  
DRAWING NOT TO SCALE UNLESS SCALE BAR IS PRESENT

FOR CONSTRUCTION

"PER CITY OF PHOENIX CODE CHAPTER 2, SECTION 2-28, THESE PLANS ARE FOR OFFICIAL USE ONLY AND MAY NOT BE SHARED WITH OTHERS EXCEPT AS REQUIRED TO FULFILL THE OBLIGATIONS OF THE CONTRACTOR'S CONTRACT WITH THE CITY OF PHOENIX."  
THIS DOCUMENT MUST BE KEPT SECURE AT ALL TIMES.

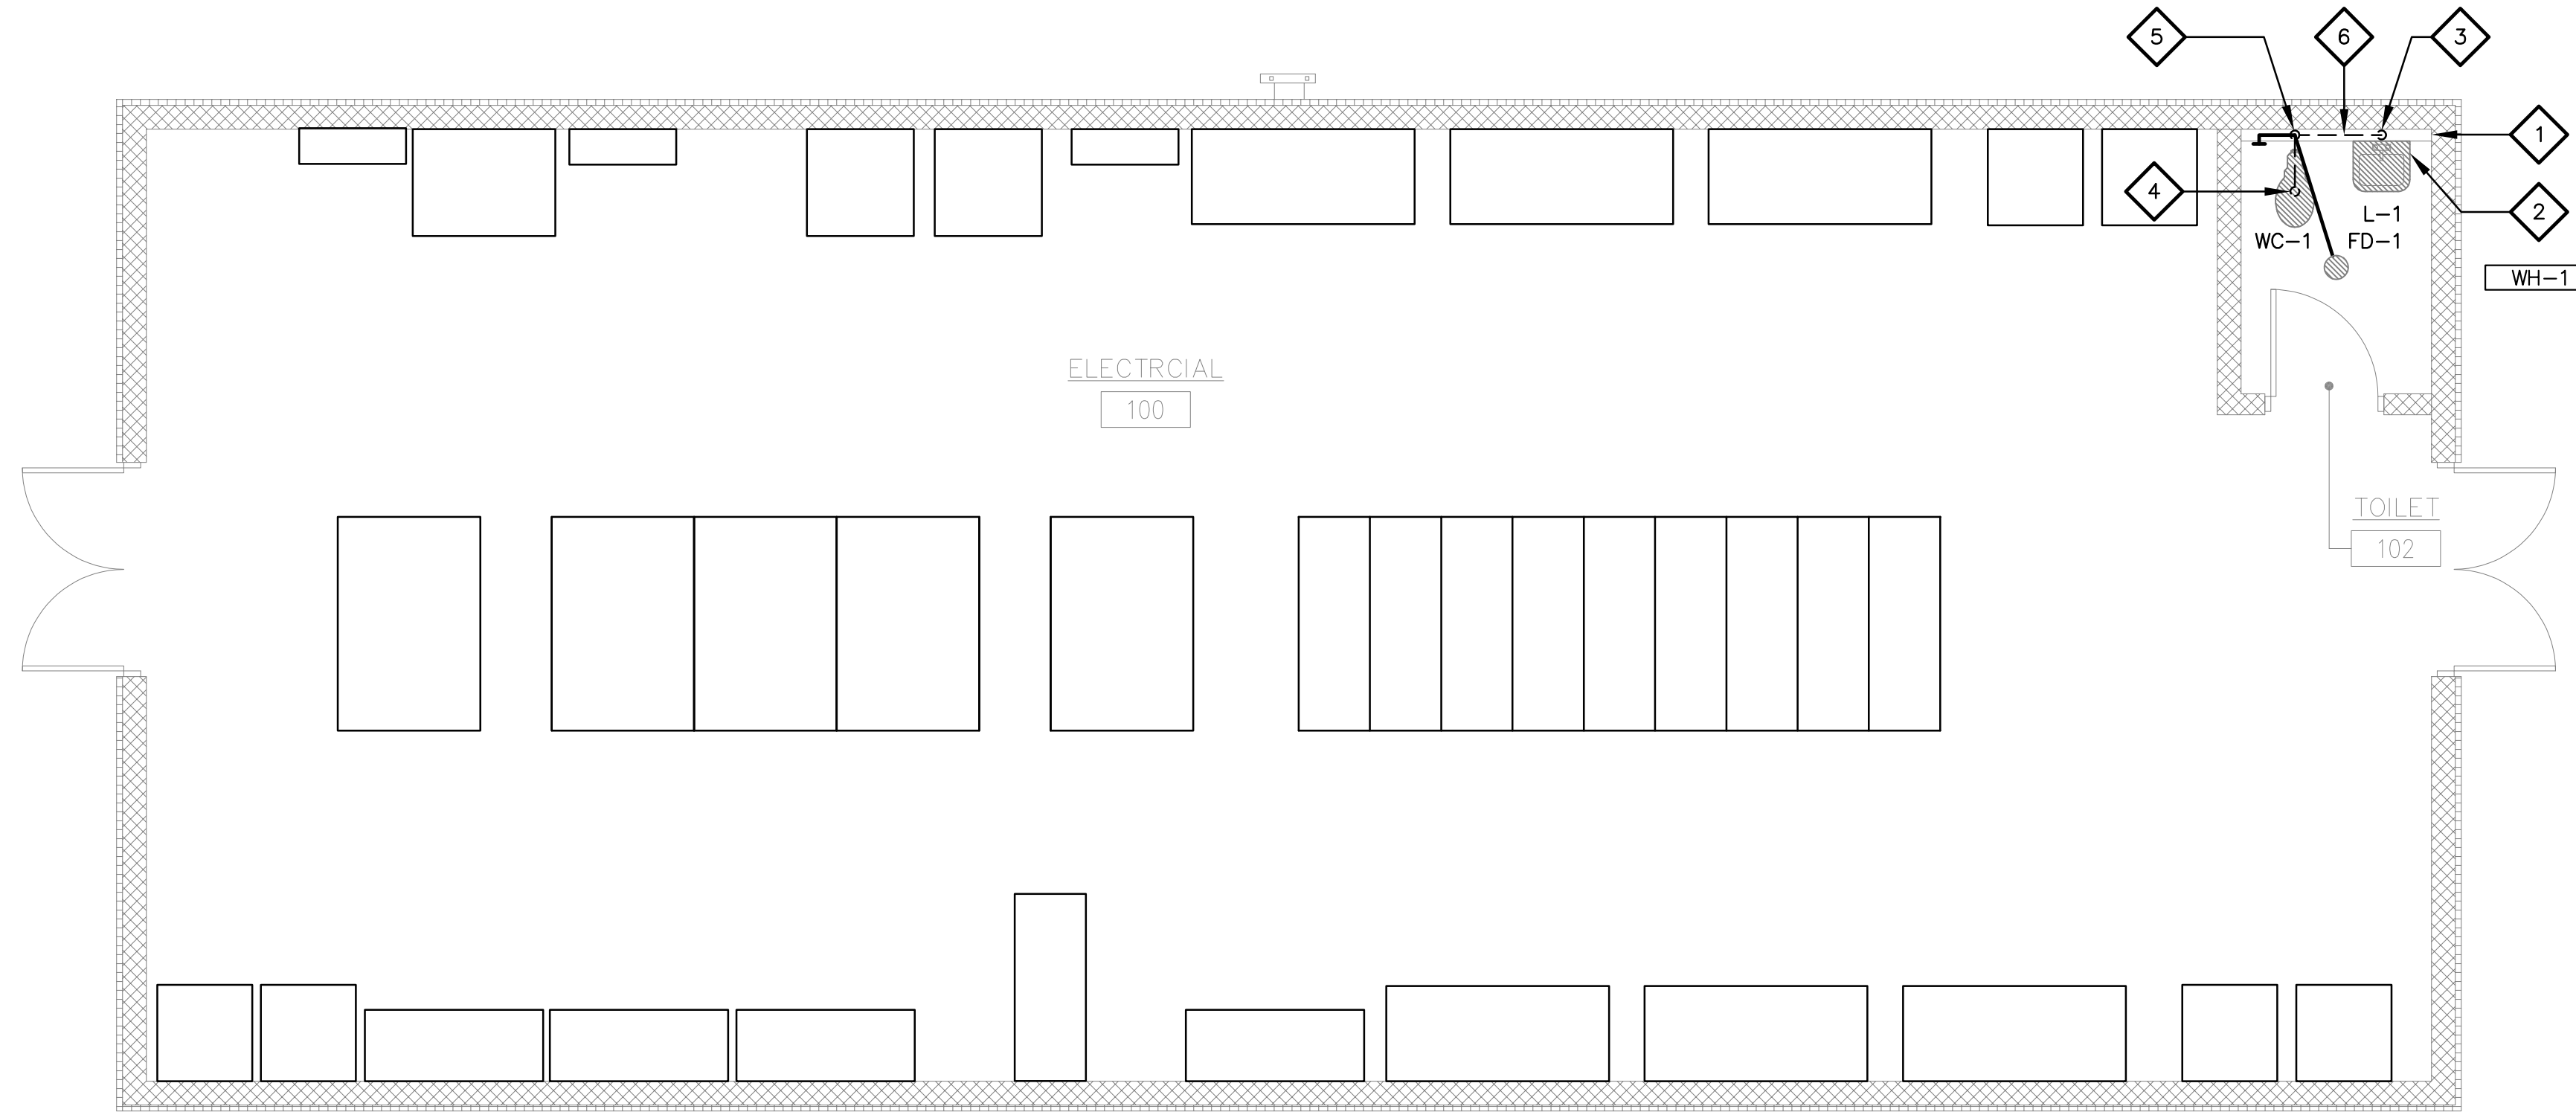


**KEY NOTES**

- 1 2" COLD WATER SERVICE. SEE CIVIL FOR CONTINUATION.  
1" COLD WATER TO WATER CLOSET.  
1/2" COLD WATER TO UNDERSINK INSTANT WATER HEATER. 1/2" COLD WATER TO FLOOR DRAIN TRAP PRIMER VALVE. INSTALLED PER MANUFACTURER'S INSTRUCTIONS
- 2 UNDERSINK INSTANT WATER HEATER WH-1. INSTALL PER MANUFACTURER'S INSTRUCTIONS. SEE 3  
P-01H-02
- 3 1 1/2" SANITARY SEWER IN WALL.
- 4 3" VENT THRU ROOF.
- 5 2" VENT UP. 4" SANITARY SEWER DOWN. SEE CIVIL FOR CONTINUATION.
- 6 SEE 4 FOR PLUMBING RISER DIAGRAM.  
P-01H-02

ELECTRICAL BUILDING PLUMBING PLAN 1

SCALE: 1/4" = 1'-0"

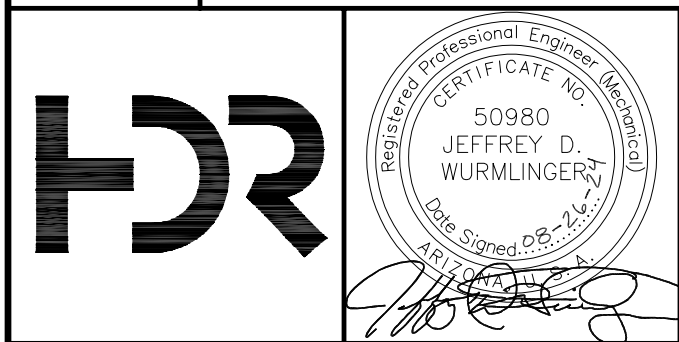

REVISIONS					
NO.	BY	DATE	CKD	REVISIONS	REMARKS
A	CM	01/2024	JW	90% SUBMITTAL	
B	CM	04/2024	JW	AGENCY REVIEW	
C	CM	08/2024	JW	ISSUED FOR CONSTRUCTION	

DES  
JW  
DWN  
CM  
CKD



CITY OF PHOENIX  
WATER SERVICES DEPARTMENT  
  
LIFT STATION 40  
REFURBISHMENT

HVAC  
  
ELECTRICAL BUILDING PLUMBING PLAN

COPYRIGHT © 2007-JANUARY  
CITY PROJECT NO. WS90400085  
DATE: 01/2024  
P-01 SHEET 91 OF 134  
CAD FILE: CSPLS40P01.dwg

FACILITY DRAWINGS  
This drawing was supplied by a Consultant Engineer from a past construction project. The original construction drawing was modified based on information provided by the Contractor to provide the Record Drawing. The City does not warrant the accuracy and/or completeness of the information and accurate portrayal of facilities as they exist in the field.

REVISION #	FOR CITY OF PHOENIX USE ONLY	ENGINEERING COMPANY	PROJECT NO.	PROJECT NAME	REFERENCE CID NUMBER: #	DATE	CAD FILE NAME	DWG NUMBER	REMARKS
1									

THIS DRAWING MUST BE FIELD VERIFIED BEFORE USE  
DRAWING NOT TO SCALE UNLESS SCALE BAR IS PRESENT

FOR CONSTRUCTION

"PER CITY OF PHOENIX CODE CHAPTER 2, SECTION 2-28, THESE PLANS ARE FOR OFFICIAL USE ONLY AND MAY NOT BE SHARED WITH OTHERS EXCEPT AS REQUIRED TO FULFILL THE OBLIGATIONS OF THE CONTRACTOR'S CONTRACT WITH THE CITY OF PHOENIX."  
THIS DOCUMENT MUST BE KEPT SECURE AT ALL TIMES.

<b>3W</b>	THREE WAY	<b>M</b>	MAX	MAXIMUM
<b>4W</b>	FOUR WAY	<b>MCC</b>	MOTOR CONTROL CENTER	
<b>A</b>		<b>MCP</b>	MOTOR CIRCUIT PROTECTOR	
<b>AMP</b>	AMPERE	<b>MFR</b>	MANUFACTURER	
<b>A/C</b>	AIR CONDITIONING	<b>MH</b>	MANHOLE	
<b>AB</b>	ANCHOR BOLT	<b>MIN</b>	MINIMUM	
<b>AC</b>	ALTERNATING CURRENT	<b>MOV</b>	MOTOR OPERATED VALVE	
<b>AFD</b>	ADJUSTABLE FREQUENCY DRIVE	<b>MPR</b>	MOTOR PROTECTION RELAY	
<b>AFF</b>	ABOVE FINISH FLOOR	<b>MS</b>	MOTOR STARTER	
<b>AFG</b>	ABOVE FINISH GRADE	<b>MTD</b>	MOUNTED	
<b>AHU</b>	AIR HANDLING UNIT	<b>N</b>	NEUTRAL	
<b>AI</b>	ANALOG INPUT	<b>NC</b>	NORMALLY CLOSED	
<b>AL</b>	ALUMINUM	<b>NEC</b>	NATIONAL ELECTRIC CODE	
<b>ALCP</b>	AREA LIGHTING CONTACTOR PANEL	<b>NO</b>	NORMALLY OPEN	
<b>AO</b>	ANALOG OUTPUT	<b>NTS</b>	NOT TO SCALE	
<b>ATC</b>	AUTOMATIC TEMPERATURE CONTROL AUTOMATIC TRANSFER SWITCH AUTOMATIC	<b>NUM</b>	NUMBER	
<b>AUTO</b>	AUXILIARY	<b>Q</b>		
<b>AUX</b>	AUXILIARY	<b>OC</b>	ON CENTER	
<b>AWG</b>	AMERICAN WIRE GAUGE CURRENT	<b>OL</b>	OVERLOAD	
<b>B</b>		<b>P</b>		
<b>BCP</b>	BLOWER CONTROL PANEL	<b>PB</b>	PULL BOX	
<b>BLDG</b>	BUILDING	<b>PF</b>	POWER FACTOR	
<b>BTU</b>	BRITISH THERMAL UNIT	<b>PFM</b>	POWER FACTOR METER	
<b>C</b>		<b>PH</b>	PHASE	
<b>CB</b>	CIRCUIT BREAKER	<b>PNL</b>	PANEL	
<b>CKT</b>	CIRCUIT	<b>PD</b>	PLATE DESIGNATION	
<b>CLF</b>	CURRENT LIMITING FUSE	<b>PP</b>	POWER PANEL	
<b>CND</b>	CONDUIT	<b>PT</b>	POTENTIAL TRANSFORMER	
<b>COMB</b>	COMBINATION	<b>R</b>		
<b>COND</b>	CONDUCTIVITY	<b>RCS</b>	REMOTE CONTROL STATION	
<b>CPT</b>	CONTROL POWER TRANSFORMER	<b>RECEPT</b>	RECEPTACLE	
<b>CR</b>	CONTROL RELAY	<b>RVA</b>	REDUCE VOLTAGE AUTOTRANSFER	
<b>CS</b>	CONTROL SWITCH	<b>RVNR</b>	REDUCE VOLTAGE NON-REVERSING	
<b>CT</b>	CURRENT TRANSFORMER	<b>S</b>		
<b>CU</b>	COPPER	<b>SC</b>	SURGE CAPACITOR	
<b>D</b>		<b>SCR</b>	SEMICONDUCTOR CONTROLLED RECTIFIER	
<b>DC</b>	DIRECT CURRENT	<b>SN</b>	SOLID NEUTRAL	
<b>DI</b>	DIGITAL INPUT	<b>SV</b>	SOLENOID VALVE	
<b>DIA</b>	DIAMETER	<b>SSRV</b>	SOFT START REDUCED VOLTAGE	
<b>DIM</b>	DIMENSION	<b>ST</b>	SPEED TACHOMETER	
<b>DIV</b>	DIVISION	<b>SW</b>	SWITCH	
<b>DN</b>	DOWN	<b>SWBD</b>	SWITCHBOARD	
<b>DO</b>	DIGITAL OUTPUT	<b>SWGR</b>	SWITCHGEAR	
<b>DS</b>	DISCONNECT SWITCH	<b>I</b>		
<b>E</b>		<b>I</b>		
<b>EC</b>	EMPTY CONDUIT	<b>I</b>		
<b>ECC</b>	EQUIPMENT GROUNDING CONDUCTOR	<b>I</b>		
<b>EHH</b>	ELECTRICAL HANDHOLE	<b>I</b>		
<b>EL</b>	ELEVATION	<b>I</b>		
<b>ELEC</b>	ELECTRICAL	<b>I</b>		
<b>ELP</b>	EMERGENCY LIGHTING PANEL	<b>I</b>		
<b>EMERG</b>	EMERGENCY	<b>I</b>		
<b>EMH</b>	ELECTRICAL MANHOLE	<b>I</b>		
<b>ENT</b>	ETHERNET SIGNAL	<b>I</b>		
<b>EP</b>	ELECTROPNEUMATIC	<b>I</b>		
<b>EPP</b>	EMERGENCY POWER PANEL	<b>I</b>		
<b>F</b>		<b>I</b>		
<b>FBO</b>	FURNISHED BY OTHERS	<b>I</b>		
<b>FT</b>	FEET/FOOT	<b>I</b>		
<b>FU</b>	FUSE	<b>I</b>		
<b>FUT</b>	FUTURE	<b>I</b>		
<b>FURN</b>	FURNISHED	<b>I</b>		
<b>FVR</b>	FULL VOLTAGE REVERSING	<b>I</b>		
<b>FVNR</b>	FULL VOLTAGE NON-REVERSING	<b>I</b>		
<b>G</b>		<b>I</b>		
<b>GEC</b>	GROUNDING ELECTRODE CONDUCTOR	<b>I</b>		
<b>GEN</b>	GENERATOR	<b>I</b>		
<b>GFI</b>	GROUND FAULT INTERRUPTER	<b>I</b>		
<b>GND</b>	GROUND	<b>I</b>		
<b>GRS</b>	GALVANIZED RIGID STEEL	<b>I</b>		
<b>H</b>		<b>I</b>		
<b>HGT</b>	HEIGHT	<b>I</b>		
<b>HH</b>	HANDHOLE	<b>I</b>		
<b>HP</b>	HORSEPOWER	<b>I</b>		
<b>HTR</b>	HEATER	<b>I</b>		
<b>HZ</b>	HERTZ	<b>I</b>		
<b>I</b>		<b>I</b>		
<b>I</b>	INSRUMENTATION	<b>I</b>		
<b>IHH</b>	INSTRUMENTATION HANDHOLE	<b>I</b>		
<b>IMH</b>	INSTRUMENTATION MANHOLE	<b>I</b>		
<b>IN</b>	INCH	<b>I</b>		
<b>INST</b>	INSTANTANEOUS	<b>I</b>		
<b>INSTR</b>	INTRUMENT	<b>I</b>		
<b>ISW</b>	INSTRUMENT ISOLATION SWITCH	<b>I</b>		
<b>ITP</b>	INTERMEDIATE TERMINATION PANEL	<b>I</b>		
<b>L</b>		<b>I</b>		
<b>L</b>	LINE	<b>I</b>		
<b>LA</b>	LIGHTNING ARRESTER	<b>I</b>		
<b>LCP</b>	LOCAL CONTROL PANEL	<b>I</b>		
<b>LD</b>	LEAK DETECTOR	<b>I</b>		
<b>LP</b>	LIGHTING PANEL	<b>I</b>		

FACILITY DRAWINGS  
This drawing was supplied by a Consultant Engineer from a past construction project. The original contractor drawing was modified based on information provided by the Contractor to provide the Record Drawing. The City does not warrant the accuracy and reliability of the drawings and accurate portrayal of facilities as they exist in the field.

REVISION	DWG NUMBER	CAD FILE NAME	DATE	PROJECT NAME	PROJECT NO.	REFERENCE CID NUMBER	NO.

			<table border="1"> <thead> <tr> <th colspan="4">REVISIONS</th> </tr> <tr> <th>NO.</th> <th>BY</th> <th>DATE</th> <th>CKD</th> <th>REMARKS</th> </tr> </thead> <tbody> <tr><td> </td><td> </td><td> </td><td> </td><td> </td></tr> <tr><td> </td><td> </td><td> </td><td> </td><td> </td></tr> <tr><td> </td><td> </td><td> </td><td> </td><td> </td></tr> <tr><td> </td><td> </td><td> </td><td> </td><td> </td></tr> </tbody> </table>				REVISIONS				NO.	BY	DATE	CKD	REMARKS																					DES RB DWN BB CKD VB	 City of Phoenix	CITY OF PHOENIX WATER SERVICES DEPARTMENT  LIFT STATION 40 REFURBISHMENT	ELECTRICAL  ABBREVIATIONS - 1	COPYRIGHT © 2007-JANUARY CITY PROJECT NO. WS90400085 DATE: 08/2024 E-01 SHEET 92 OF 134 CAD FILE: CEELS40ABBREV1.dwg
			REVISIONS																																					
NO.	BY	DATE	CKD	REMARKS																																				

THIS DRAWING MUST BE FIELD VERIFIED BEFORE USE  
DRAWING NOT TO SCALE UNLESS SCALE BAR IS PRESENT

FOR CONSTRUCTION

\*PER CITY OF PHOENIX CODE CHAPTER 2, SECTION 2-28, THESE PLANS ARE FOR OFFICIAL USE ONLY AND MAY NOT BE SHARED WITH OTHERS EXCEPT AS REQUIRED TO FULFILL THE OBLIGATIONS OF THE CONTRACTOR'S CONTRACT WITH THE CITY OF PHOENIX.  
THIS DOCUMENT MUST BE KEPT SECURE AT ALL TIMES.

STANDARD ABBREVIATIONS

SYMBOLS

Table of symbols and abbreviations including AT (PERCENT), A (ARCHITECTURAL), B (BRASS CAP), C (CIVIL), D (DRY BULB), E (ELECTRICAL), etc.

E

Table of abbreviations starting with E: FC (FLEXIBLE CONNECTOR), GA (GAUGE), H (HIGH), IAS (INFORMATION ACCESS SYSTEM), etc.

M

Table of abbreviations starting with M: MAG (MAGNETIC), P-# (PUMP NO.), R (RADIUS), etc.

S

Table of abbreviations starting with S: S (STRUCTURAL), T (TELEPHONE), UG (UNDER GROUND), etc.

PROCESS ABBREVIATIONS

Table of process abbreviations: ALM (ALUM), AMN (AMMONIA), B (BALL CHECK VALVE), CAS (CAUSTIC SODA), etc.

THIS DRAWING WAS SUPPLIED BY A CONSULTANT ENGINEER FROM A PAST CONSTRUCTION PROJECT. THE ORIGINAL CONSTRUCTOR DRAWING WAS MODIFIED BASED ON INFORMATION PROVIDED BY THE CONTRACTOR TO PROVIDE THE RECORD DRAWING. THE CITY DOES NOT WARRANT THE ACCURACY AND COMPLETENESS OF THE INFORMATION AND ACCURACY OF FACILITIES AS THEY EXIST IN THE FIELD.

Table with columns: REVISIONS, DWG NUMBER, CAD FILE NAME, DATE, PROJECT NAME, PROJECT NO., REVISION ENGINEERING COMPANY.


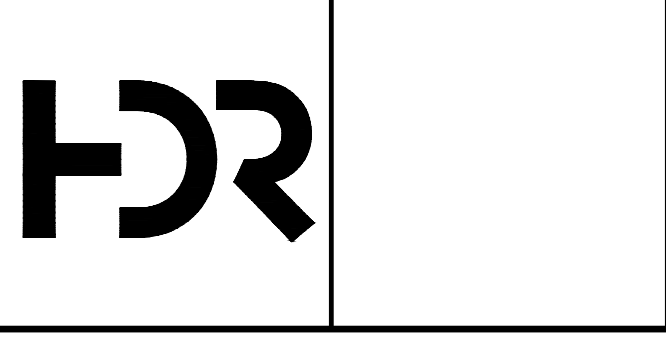


Table with columns: NO., BY, DATE, CKD, REVISIONS, REMARKS

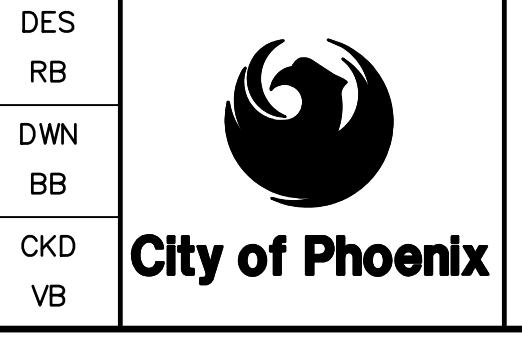

CITY OF PHOENIX  
WATER SERVICES DEPARTMENT  
LIFT STATION 40  
REFURBISHMENT

ELECTRICAL  
ABBREVIATIONS - 2

COPYRIGHT © 2007-JANUARY  
CITY PROJECT NO. WS90400085  
DATE: 08/2024  
E-02 SHEET 93 OF 134  
CAD FILE: CEELS40ABBREV2.dwg

THIS DRAWING MUST BE FIELD VERIFIED BEFORE USE  
DRAWING NOT TO SCALE UNLESS SCALE BAR IS PRESENT

FOR CONSTRUCTION

PER CITY OF PHOENIX CODE CHAPTER 2, SECTION 2-28, THESE PLANS ARE FOR OFFICIAL USE ONLY AND NOT BE SHARED WITH OTHERS EXCEPT AS REQUIRED TO FULFILL THE OBLIGATIONS OF THE CONTRACTOR'S CONTRACT WITH THE CITY OF PHOENIX.  
THIS DOCUMENT MUST BE KEPT SECURE AT ALL TIMES.

**AREA CLASSIFICATIONS**

DAMP

WET

CORROSIVE

CLASS 1, DIV. 1  
GROUP D

**DESCRIPTION**

INDICATES THAT ALL ELECTRICAL EQUIPMENT AND MATERIALS INSTALLED WITHIN THE ROOM OR AREA IN WHICH THIS NOTATION APPEARS SHALL BE OF NEMA 12 CONSTRUCTION (OR GASKETED AND SUITABLE FOR USE IN A WET LOCATION WHERE NEMA STANDARDS DO NOT APPLY) UNLESS OTHER-WISE NOTED.


INDICATES THAT ALL ELECTRICAL EQUIPMENT AND MATERIALS INSTALLED WITHIN THE ROOM OR AREA IN WHICH THIS NOTATION APPEARS SHALL BE OF NEMA 4X CONSTRUCTION (OR GASKETED AND SUITABLE FOR USE IN A WET LOCATION WHERE NEMA STANDARDS DO NOT APPLY) UNLESS OTHER-WISE NOTED.

INDICATES THAT ALL ELECTRICAL EQUIPMENT AND MATERIALS INSTALLED WITHIN THE ROOM OR AREA IN WHICH THIS NOTATION APPEARS SHALL BE OF NEMA 4X NON-METALLIC CONSTRUCTION (OR CORROSION RESISTANT CONSTRUCTION SUITABLE FOR USE IN A WET LOCATION WHERE NEMA STANDARDS DO NOT APPLY) UNLESS OTHERWISE NOTED.


INDICATES THAT ALL ELECTRICAL EQUIPMENT AND MATERIALS INSTALLED WITHIN THE ROOM OR AREA IN WHICH THIS NOTATION APPEARS SHALL CONFORM TO N.E.C. REQUIREMENTS FOR THE HAZARDOUS AREA CLASSIFICATION SHOWN.

**BREAKERS**


SINGLE LINE PLAN

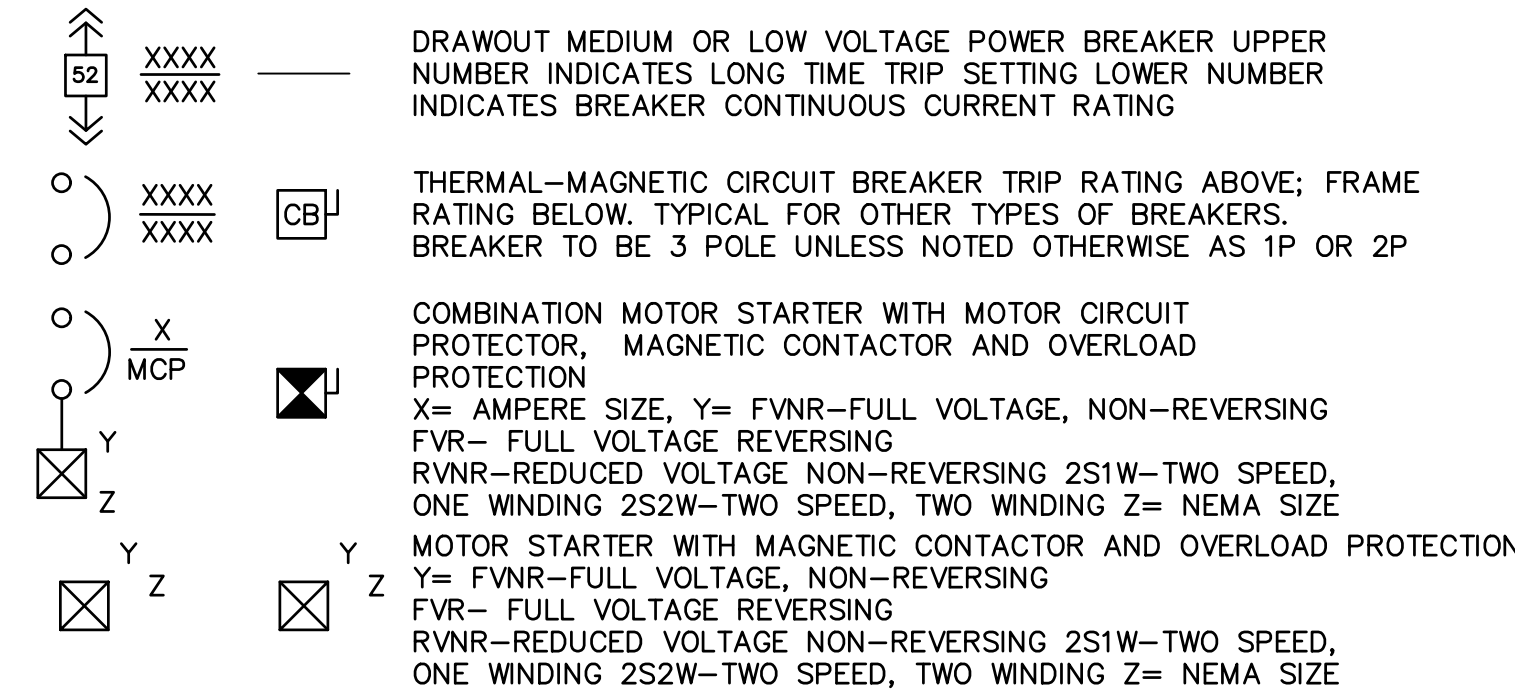


**COMMUNICATION SYSTEMS**

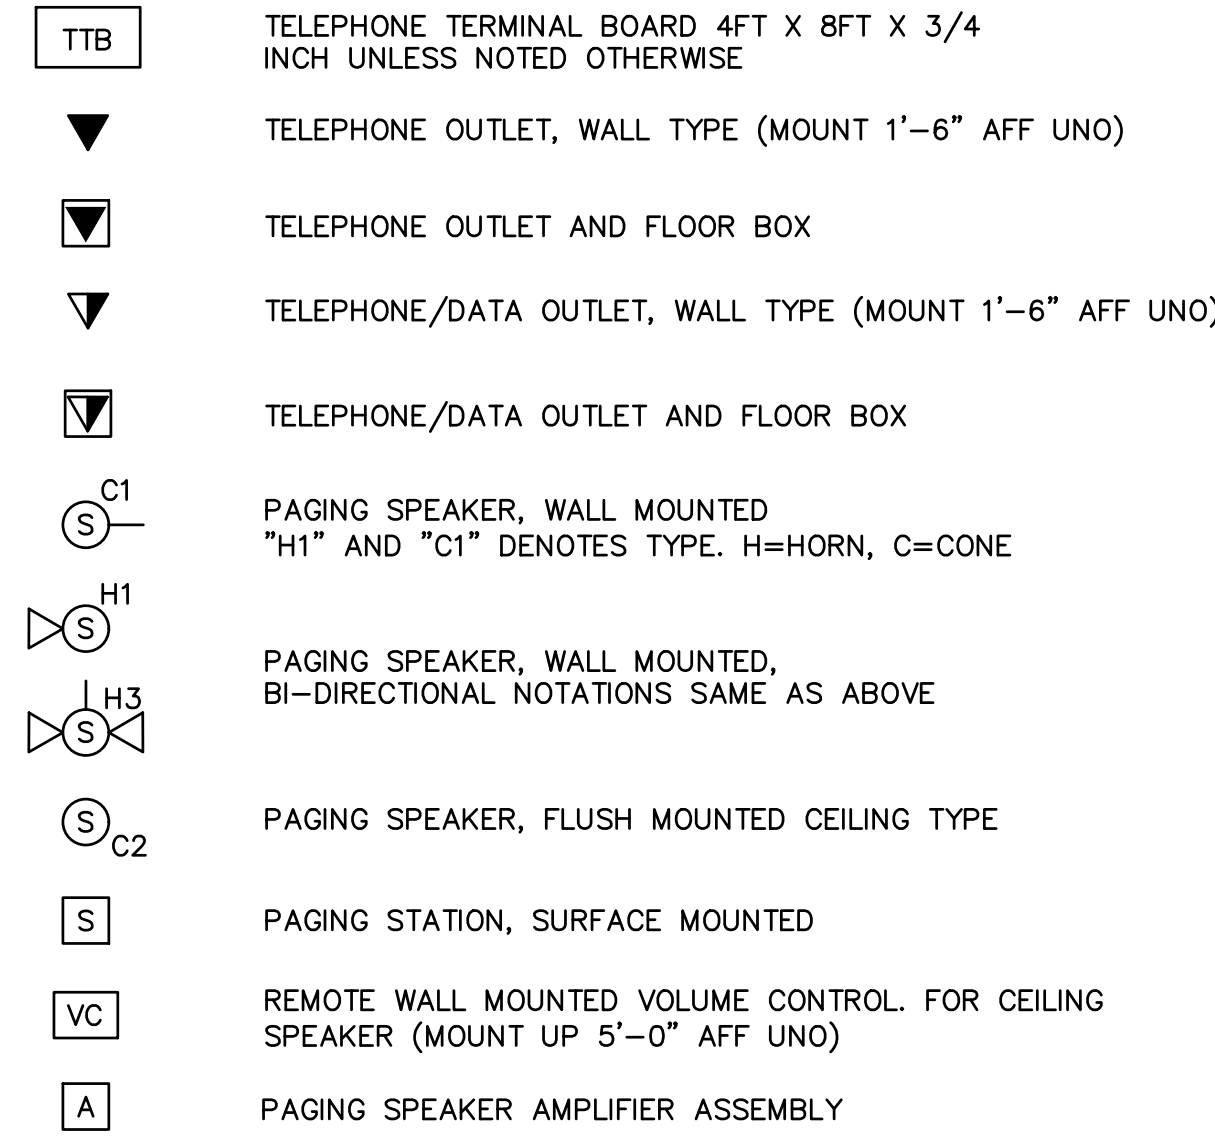


**CONDUIT**

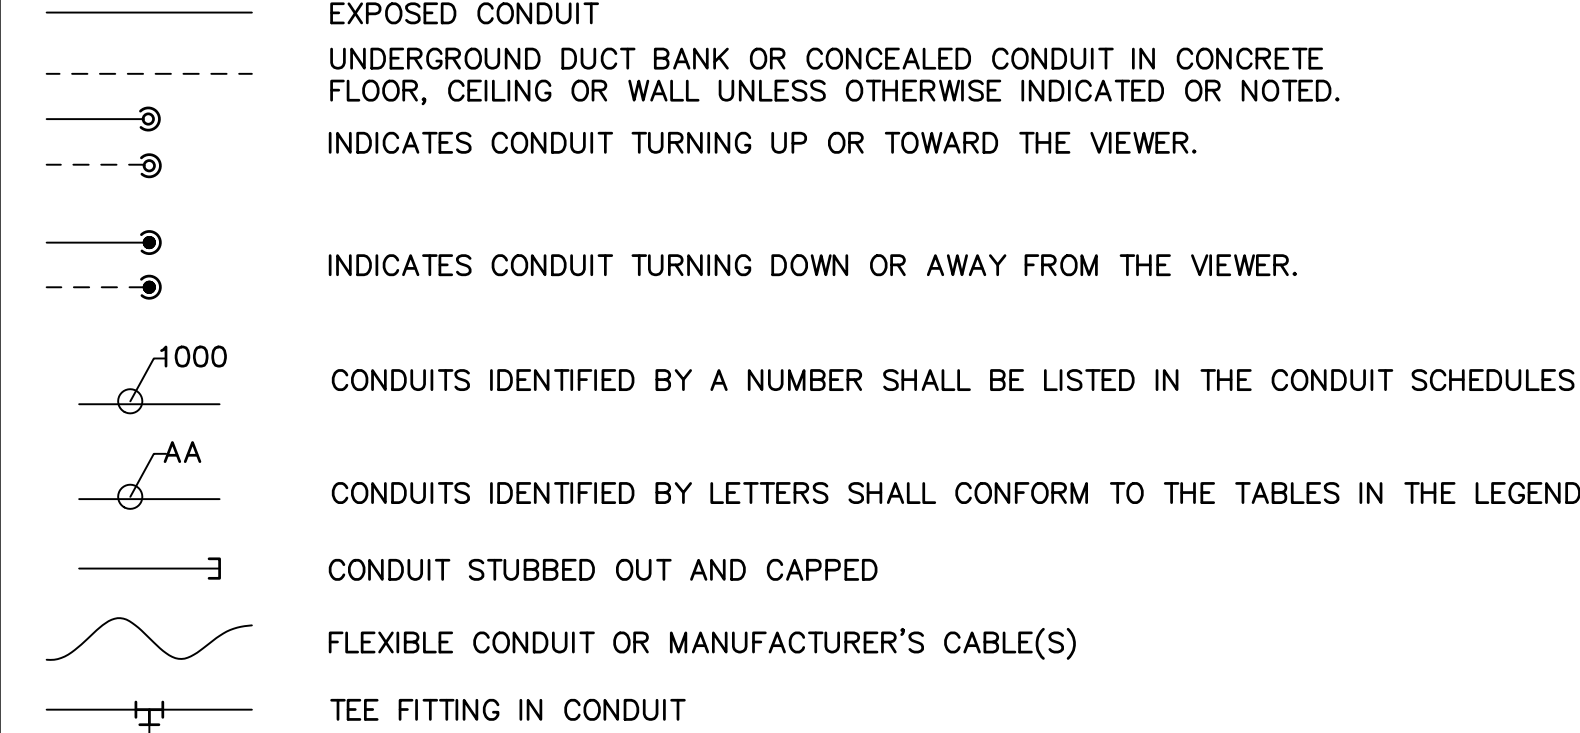


**CONDUIT CONTINUED**

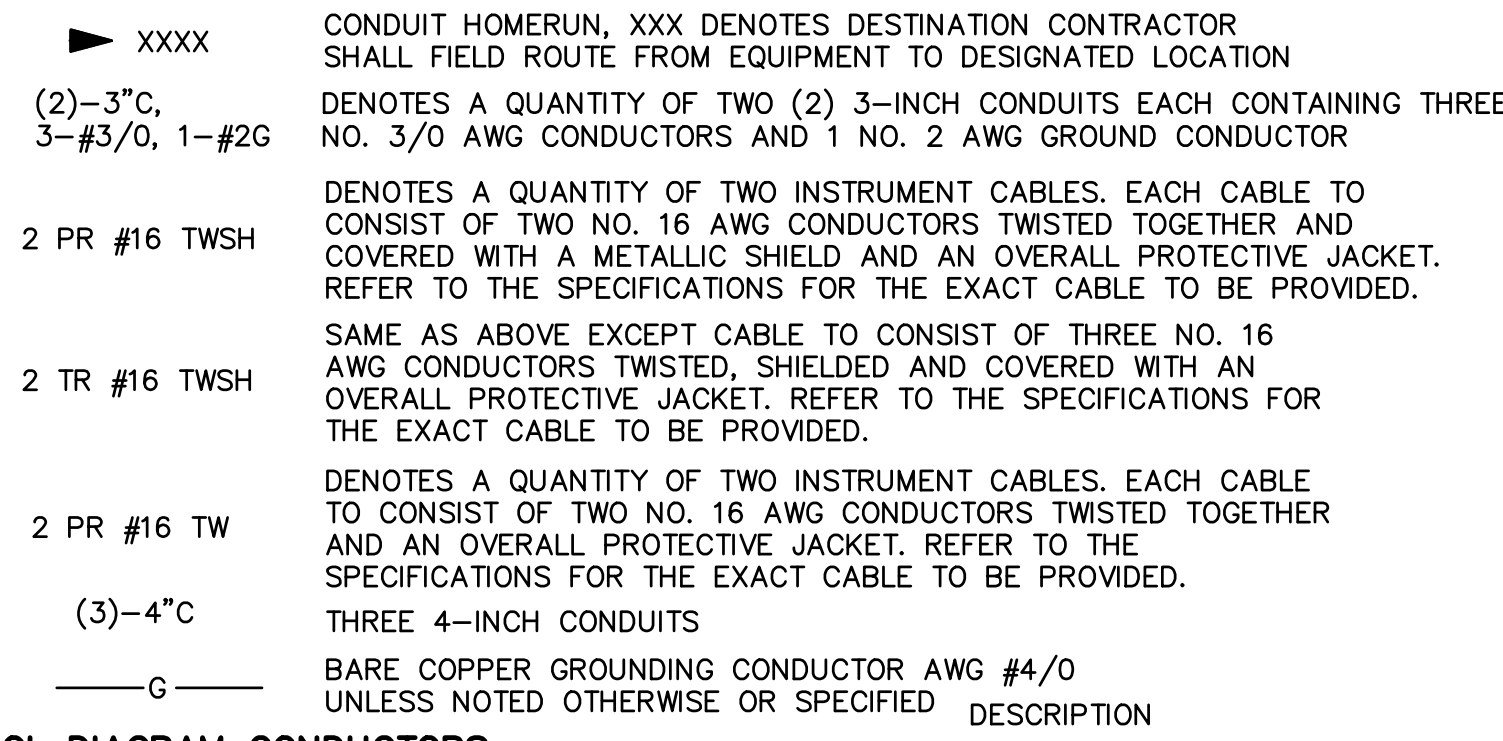


**CONTROL DIAGRAM CONDUCTORS**

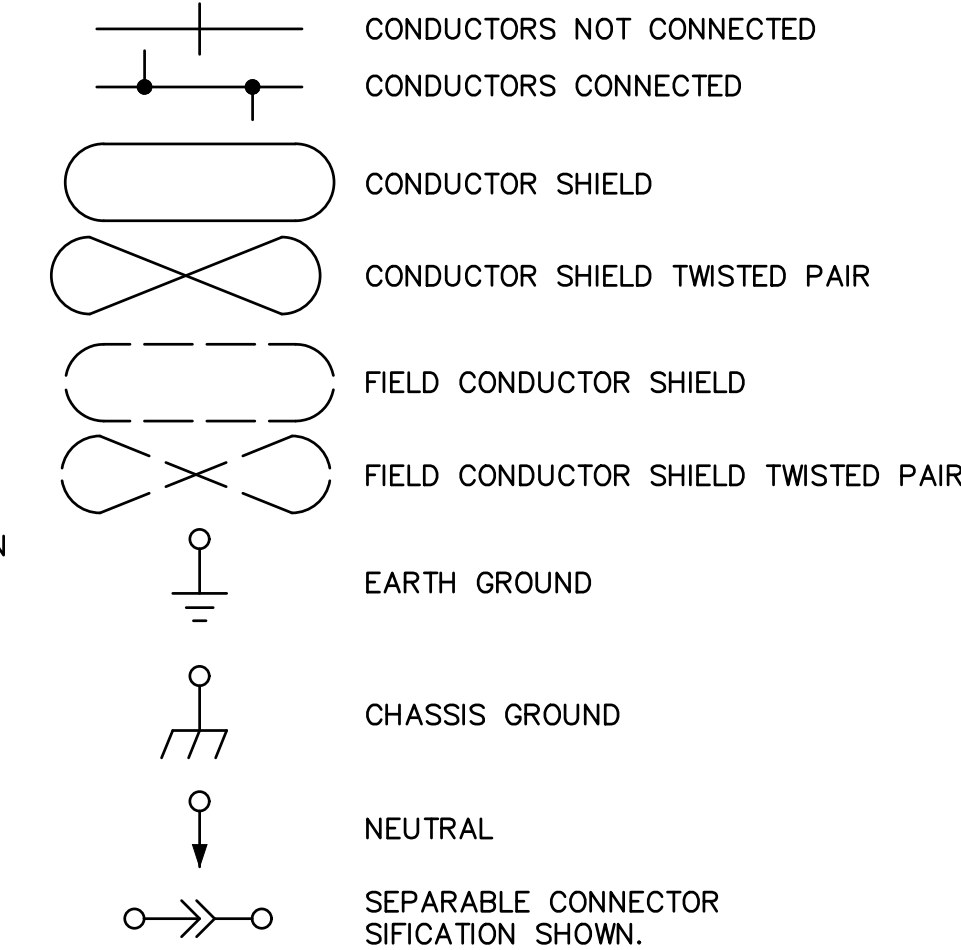


**CONTROL DIAGRAM COMPUTER CONTROL SYSTEM INPUT/OUTPUT**

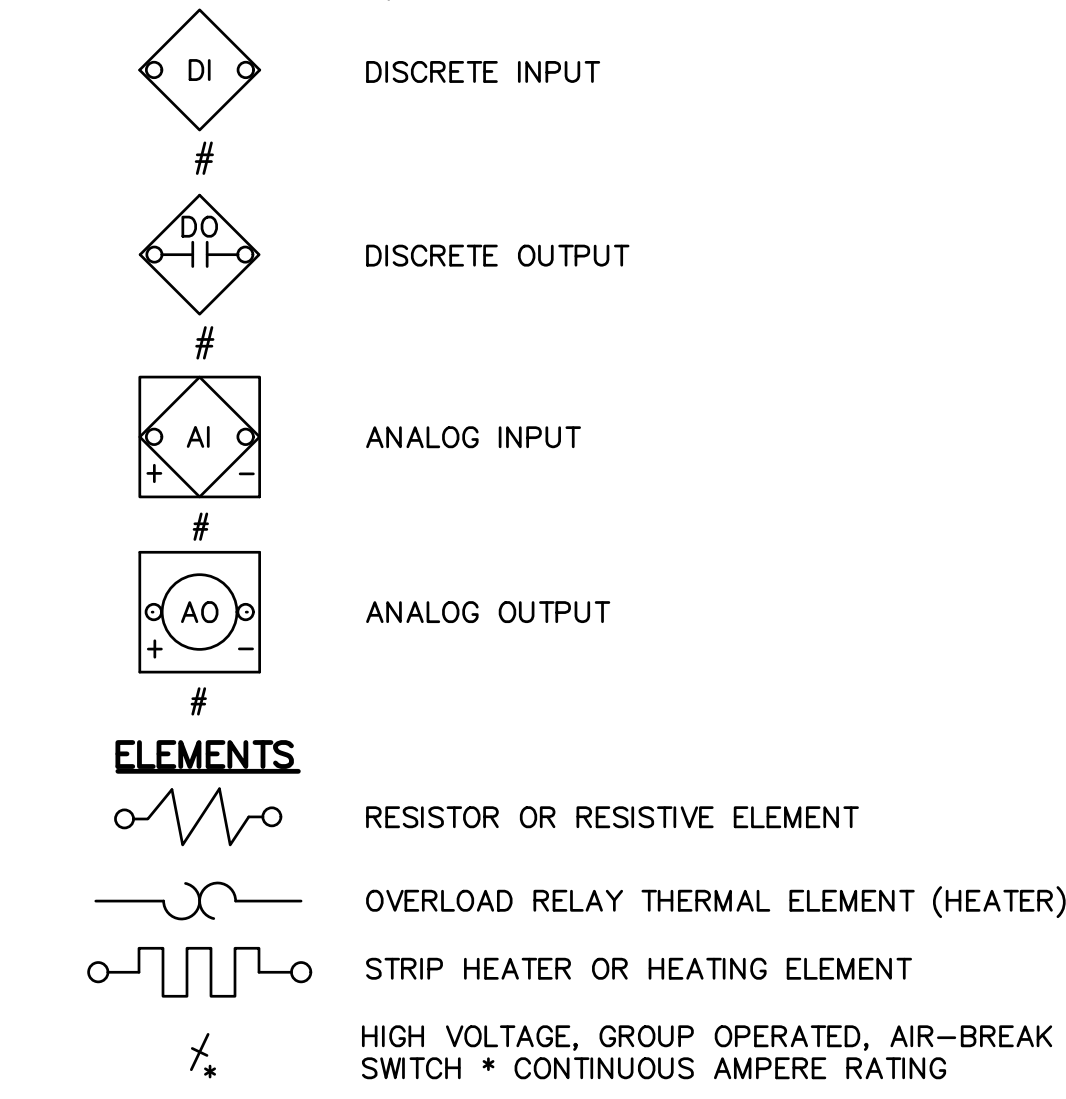


**ELEMENTS**

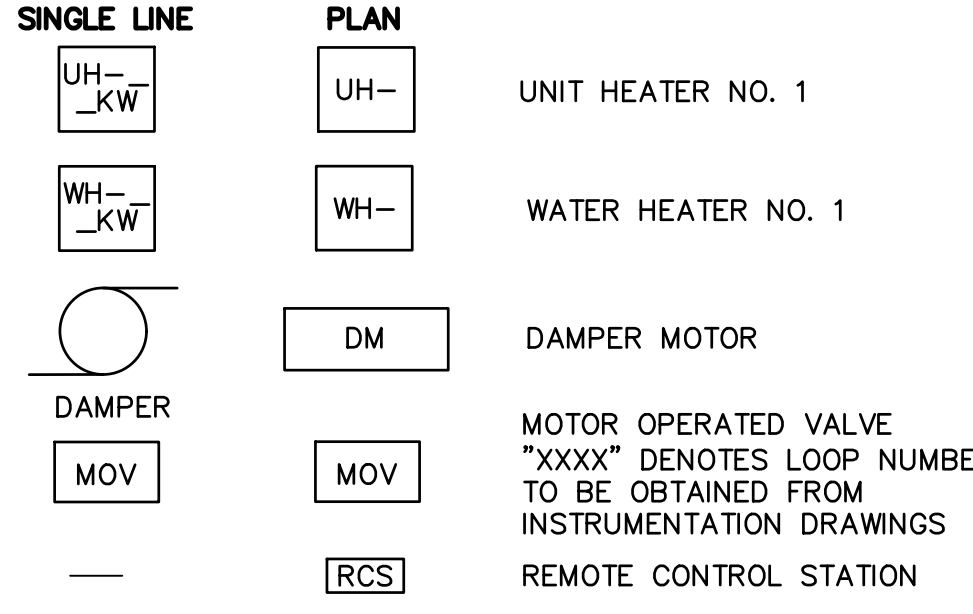


**FIRE ALARM SYSTEMS**

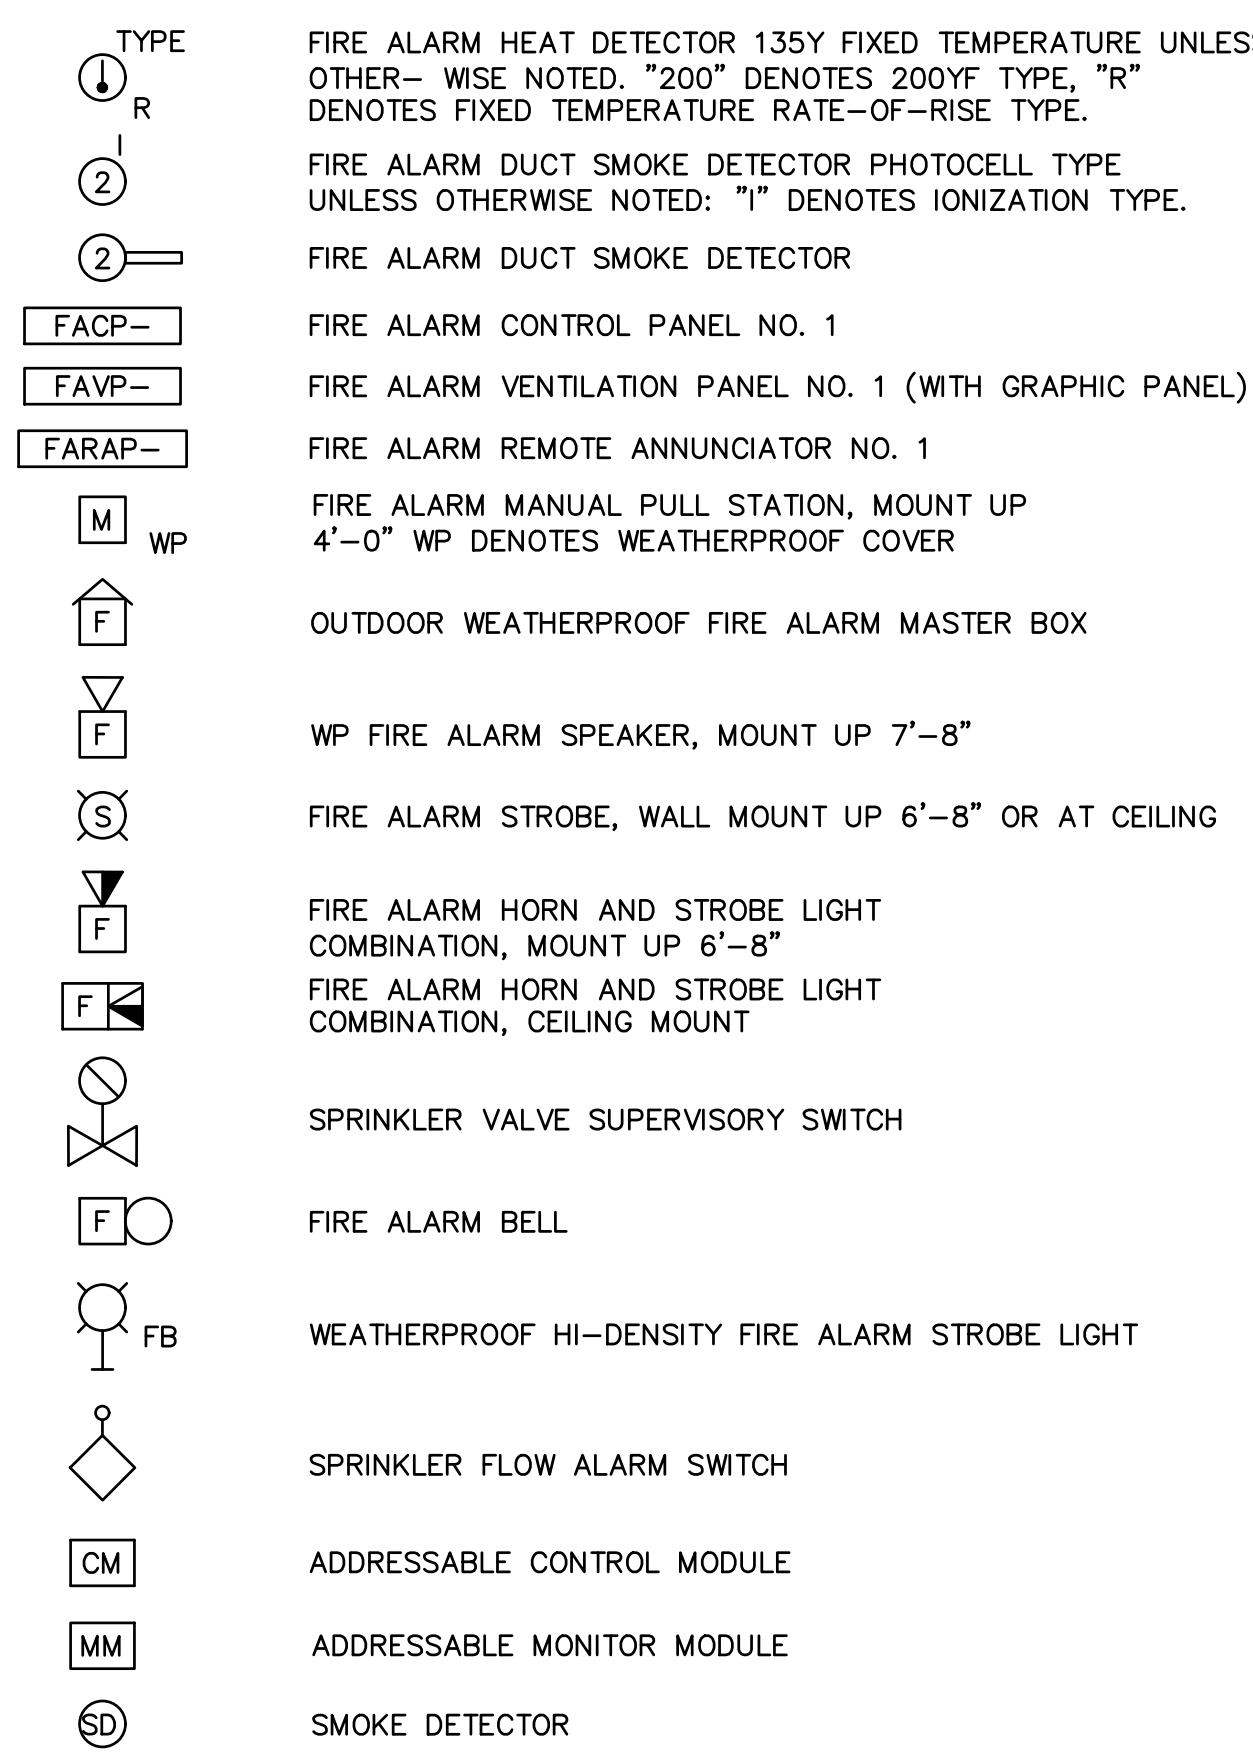

**GROUNDING**

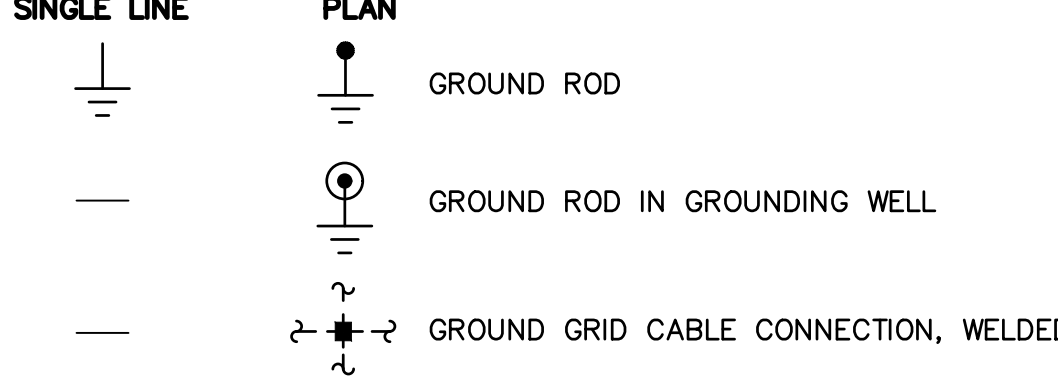

**LIGHTING**

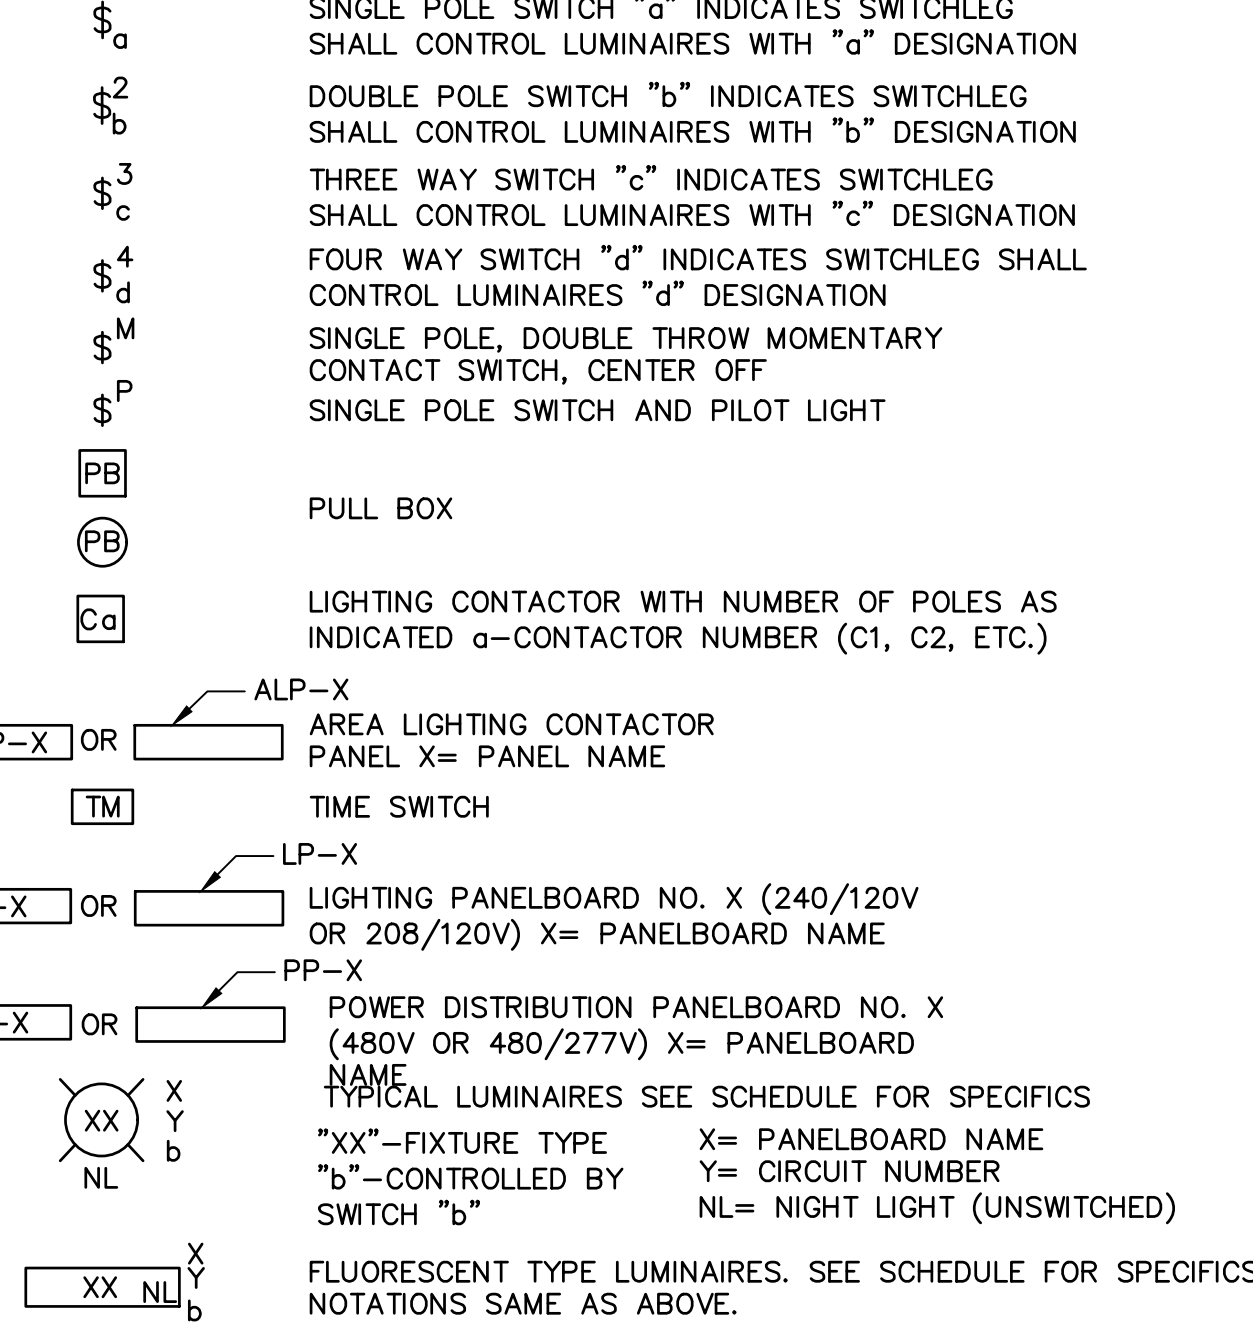

**LIGHTING CONTINUED**

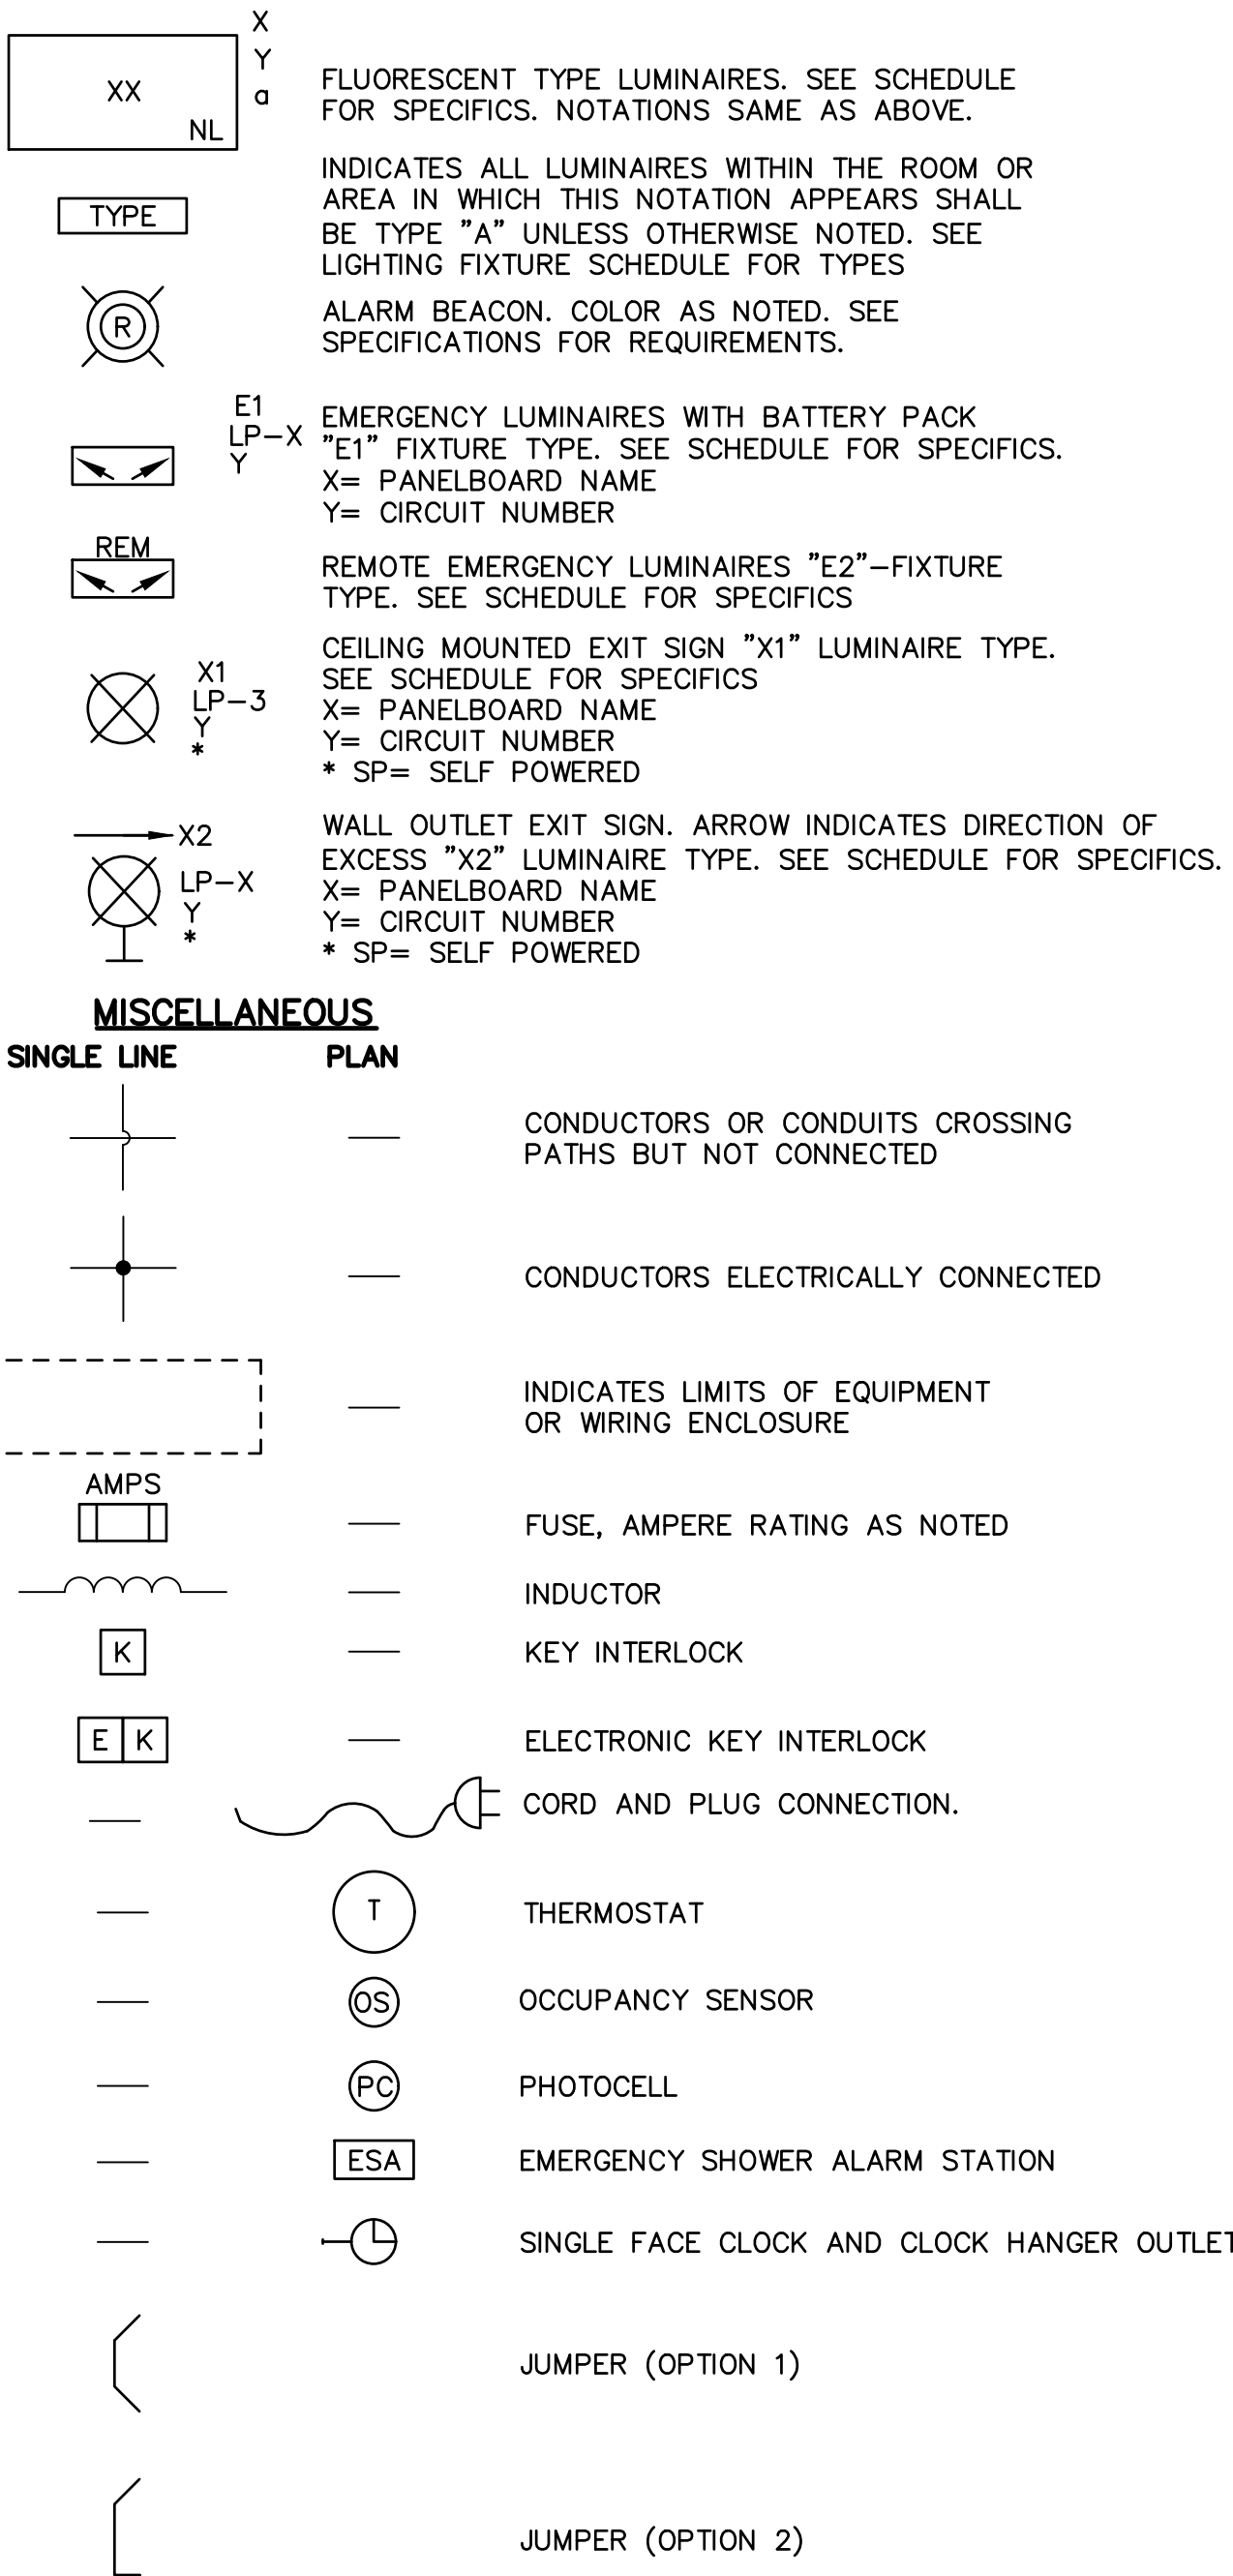


Table with columns: NO., BY, DATE, CKD, REVISIONS, REMARKS

DES RB, DWN BB, CKD VB, City of Phoenix logo

CITY OF PHOENIX WATER SERVICES DEPARTMENT  
LIFT STATION 40 REFURBISHMENT

ELECTRICAL  
SYMBOLS AND LEGENDS - 1

COPYRIGHT © 2007-JANUARY  
CITY PROJECT NO. WS90400085  
DATE: 08/2024  
E-03 SHEET 94 OF 134  
CAD FILE: CSELS40LEGEND1.dwg

REVISIONS, DWG NUMBER, CAD FILE NAME, DATE, PROJECT NAME, PROJECT NO. (Vertical sidebar information)

FACTORY DRAWINGS... This drawing was supplied by a Consultant Engineer from a past construction project... (Disclaimer text)

THIS DRAWING MUST BE FIELD VERIFIED BEFORE USE. DRAWING NOT TO SCALE UNLESS SCALE BAR IS PRESENT

FOR CONSTRUCTION

PER CITY OF PHOENIX CODE CHAPTER 2, SECTION 2-28, THESE PLANS ARE FOR OFFICIAL USE ONLY AND MAY NOT BE SHARED WITH OTHERS EXCEPT AS REQUIRED TO FULFILL THE OBLIGATIONS OF THE CONTRACTOR'S CONTRACT WITH THE CITY OF PHOENIX. THIS DOCUMENT MUST BE KEPT SECURE AT ALL TIMES.

**POWER SWITCHES**

SINGLE LINE	PLAN	DESCRIPTION
		NON-FUSIBLE DISCONNECT SWITCH, 600 VOLT, 3 POLE, * AMPERE RATING NOTED IF OTHER THAN 30A
		FUSIBLE DISCONNECT SWITCH, 600 VOLT, 3 POLE, AMPERE RATING AND FUSE SIZE AS NOTED *AMPERE RATING NOTED IF OTHER THAN 30A *FUSE RATING, EXAMPLE 15A
		MANUAL MOTOR STARTER WITH THERMAL OVERLOAD PROTECTION "P" INDICATES WITH PILOT LIGHT "2" INDICATES NUMBER OF POLES
		DRAWOUT TYPE EQUIPMENT OR DEVICE
		MEDIUM VOLTAGE CABLE TERMINATION
		MEDIUM VOLTAGE AIR INTERRUPTER SWITCH
		MEDIUM VOLTAGE FUSED AIR INTERRUPTER SWITCH
		MEDIUM VOLTAGE FUSED MOTOR CONTROLLER *AT=AUTOTRANSFORMER TYPE
		TRANSFORMER, RATINGS AND CONNECTIONS AS NOTED. UNLESS OTHERWISE NOTED ON THE ONE LINE DIAGRAMS ALL DRY TYPE TRANSFORMERS SERVICING ADMINISTRATIVE AND LABORATORY SPACES SHALL HAVE A K FACTOR OF 13. ALL OTHER DRY TYPE TRANSFORMERS SHALL HAVE A K-4 RATING. ISOLATION TRANSFORMERS SHALL HAVE A K-20 RATING. RATING * METER * WM-WATTMETER WHM-WATTHOUR METER WHDM-WATTHOUR DEMAND METER WHDR-WATTHOUR DEMAND RECORDER PF-POWER FACTOR METER TRANSDUCER * AX-CURRENT TRANSDUCER WX-WATT TRANSDUCER
		CURRENT TRANSFORMER *QUANTITY XXXX = PRIMARY AMPERE RATING
		POTENTIAL TRANSFORMER (PT) OR CONTROL POWER TRANSFORMER (CPT) *QUANTITY XXXX = PRIMARY VOLTAGE RATING
		GENERATOR WITH GENERATION NUMBER, RATINGS AND CONNECTIONS AS NOTED IN CALL-OUT ON DRAWING
		AUTOMATIC TRANSFER SWITCH (ATS) "N" INDICATES NORMAL SOURCE "S" INDICATES STANDBY SOURCE "RATE" INDICATES CONTINUOUS CURRENT RATING "#" INDICATES ATS NAME
		AC MOTOR SPEED CONTROLLER (VARIABLE FREQUENCY DRIVE)
		DC MOTOR SPEED CONTROLLER (SILICON CONTROLLED RECTIFIER)
		MOTOR, NUMERAL INDICATES HORSEPOWER
		VOLTMETER WITH SWITCH, 3 PHASE * = SCALE
		AMMETER WITH SWITCH, 3 PHASE * = SCALE
		LIGHTNING ARRESTOR
		SURGE SUPPRESSER
		TRANSIENT VOLTAGE SURGE SUPPRESSOR (POWER DISTRIBUTION TYPE) PILOT LIGHT, COLOR AS NOTED A-AMBER, B-BLUE, C-CLEAR G-GREEN, R-RED, W-WHITE
		SPECIAL CAPACITOR *SC-SURGE CAPACITOR PR-POWER FACTOR CORRECTION CAPACITOR
		CONTROL STATION (STANDMOUNT OR WALLMOUNT) SEE SCHEMATIC DIAGRAMS AND/OR INSTRUMENTATION DIAGRAMS FOR TYPE AND QUANTITY OF OPERATORS.
		SOLENOID OPERATED VALVE
		ELAPSED TIME METER

**PUSH BUTTONS**

SINGLE LINE	DESCRIPTION
	EMERGENCY STOP PUSHBUTTON WITH RED MUSHROOM HEAD OPERATOR (MAINTAINED CONTACT)
	PUSHBUTTON, MOMENTARY CONTACT, SPRING RETURN, NORMALLY CLOSED
	PUSHBUTTON, MOMENTARY CONTACT, SPRING RETURN, NORMALLY OPEN
	START-STOP PUSHBUTTON CONTROL STATION, MAINTAINED CONTACT WITH LOCKOUT DEVICE ON STOP
	2 POSITION SELECTOR SWITCH, NORMALLY CLOSED
	2 POSITION SELECTOR SWITCH, NORMALLY OPEN
	2 POSITION 2 POLE SELECTOR SWITCH
	2 POSITION 3 POLE SELECTOR SWITCH
	3 POSITION SELECTOR SWITCH, NORMALLY CLOSED
	3 POSITION SELECTOR SWITCH, NORMALLY OPEN
	3 POSITION 3 POLE SELECTOR SWITCH
	4 POSITION SELECTOR SWITCH, NORMALLY OPEN

**RELAY CONTACTS**

DESCRIPTION
MOTOR STARTER COIL, NUMBER AS INDICATED
TIMING RELAY RANGE AS NOTED STEPPING AS NOTED
CONTROL RELAY COIL, NUMBER AS INDICATED
NORMALLY OPEN MOTOR STARTER CONTACT
NORMALLY CLOSED MOTOR STARTER CONTACT
NORMALLY OPEN RELAY CONTACT
NORMALLY CLOSED RELAY CONTACT
NOTC-NORMALLY OPEN TIMED CLOSING, WHEN ENERGIZED
NCTO-NORMALLY CLOSED TIMED OPENING, WHEN ENERGIZED
NOTO-NORMALLY OPEN, TIMED OPENING WHEN DE-ENERGIZED
NCTC-NORMALLY CLOSED, TIMED CLOSING WHEN DE-ENERGIZED

**SWITCH CONTACTS**

SINGLE LINE	PLAN TAGNUMBER	DESCRIPTION
	X	AUXILLARY SWITCH CONTACT NORMALLY CLOSED
	X	AUXILLARY SWITCH CONTACT NORMALLY OPEN
	X	LIQUID LEVEL (FLOAT) SWITCH NORMALLY OPEN, CLOSSES ON RISING LEVEL
	X	LIQUID LEVEL (FLOAT) SWITCH NORMALLY CLOSED, OPENS ON RISING LEVEL
	X	PRESSURE SWITCH NORMALLY OPEN, CLOSSES ON RISING PRESSURE
	X	PRESSURE SWITCH NORMALLY CLOSED, OPENS ON DROPPING PRESSURE
	X	VACUUM SWITCH NORMALLY OPEN, CLOSSES ON RISING PRESSURE
	X	VACUUM SWITCH NORMALLY CLOSED, OPENS ON DROPPING PRESSURE
	X	DIFFERENTIAL PRESSURE SWITCH NORMALLY OPEN, CLOSSES ON RISING DIFFERENTIAL PRESSURE
	X	DIFFERENTIAL PRESSURE SWITCH NORMALLY CLOSED, OPENS ON RISING DIFFERENTIAL PRESSURE
	X	TEMPERATURE SWITCH NORMALLY OPEN, CLOSSES ON RISING TEMPERATURE
	X	TEMPERATURE SWITCH NORMALLY CLOSED, OPENS ON RISING TEMPERATURE
	X	FLOW SWITCH (AIR, WATER, ETC..) NORMALLY OPEN, CLOSSES ON INCREASED FLOW
	X	FLOW SWITCH (AIR, WATER, ETC..) NORMALLY CLOSED, OPENS ON INCREASED FLOW
	X	POSITION (LIMIT) SWITCH NORMALLY OPEN

**SWITCH CONTACTS CONT.**

SINGLE LINE	DESCRIPTION
	POSITION (LIMIT) SWITCH NORMALLY OPEN-HHELD CLOSED
	NORMALLY CLOSED
	NORMALLY CLOSED-HHELD OPEN
	TORQUE SWITCH NORMALLY OPEN, CLOSSES ON HIGH TORQUE
	TORQUE SWITCH NORMALLY CLOSED, OPENS ON HIGH TORQUE
	PUSH-TEST, 110V S6 LAMP UNLESS NOTED, LETTER IS LENS COLOR * R-RED G-GREEN B-BLUE

**RECEPTACLES**

RECEPTACLE SYMBOL	DESCRIPTION
	208V, 3P, 4W, RECEPTACLE *AMPERE RATING AS NOTED X= PANELBOARD NUMBER Y= CIRCUIT NUMBER
	20A, 120V, 2P, 3W DUPLEX AND 20A, 240V, 2P, 3W SINGLE RECEPTACLES UNDER COMMON PLATE X= PANELBOARD NUMBER Y= CIRCUIT NUMBER
	DOUBLE RECEPTACLE (QUAD), 20A, 120V, 2P, 3W MOUNTED IN 2 GANG BOX. X= PANELBOARD NUMBER Y= CIRCUIT NUMBER
	240V, 20, 3W, RECEPTACLE *AMPERE RATING AS NOTED MULTI-OUTLET ASSEMBLY TYPE FLOOR OUTLET BOX WITH TYPE OUTLET INDICATED
	480V, 3P, 4W RECEPTACLE AND DISCONNECT SWITCH *AMPERE RATING AS NOTED X= PANELBOARD NUMBER Y= CIRCUIT NUMBER
	DUPLEX RECEPTACLE, 20A, 120V, 2P, 3W UNLESS OTHERWISE NOTED * C-MOUNTED ABOVE COUNTER-TOP GF- GROUND FAULT INTERRUPTER TYPE WP-WEATHERPROOF T-TRANSIENT VOLTAGE SURGE SUPPRESSER X= PANELBOARD NUMBER Y= CIRCUIT NUMBER
	240V, 3P, 4W, RECEPTACLE *AMPERE RATING AS NOTED **WP= WEATHER PROOF XP= EXPLOSION PROOF X= PANELBOARD NUMBER Y= CIRCUIT NUMBER

**SECURITY SYSTEMS**

SECURITY SYMBOL	DESCRIPTION
	SECURITY SYSTEM DOOR OR SWITCH
	SECURITY SYSTEM WINDOW SWITCH
	SECURITY SYSTEM KEY PAD
	SECURITY SYSTEM CARD ACCESS READER
	GLASS BREAK DETECTOR
	SECURITY ALARM MOTION DETECTOR
	CLOSED CIRCUIT TV CAMERA
	PAN, TILT, ZOOM CAMERA LENS CONTROLS

FACILITY DRAWINGS  
This drawing was supplied by a Consultant Engineer from a past construction project. The original construction drawing was modified based on information provided by the Contractor to provide the Record Drawing. The City does not warrant the accuracy and occurrence of any conditions and/or portrayal of facilities as they exist in the field.

REVISION	DWG NUMBER	CAD FILE NAME	DATE	PROJECT NAME	REFERENCE CID NUMBER

REVISIONS			
NO.	BY	DATE	REMARKS

DES RB  
DWN BB  
CKD VB

CITY OF PHOENIX  
WATER SERVICES DEPARTMENT

LIFT STATION 40  
REFURBISHMENT

ELECTRICAL



SYMBOLS AND LEGENDS - 2

COPYRIGHT © 2007-JANUARY  
CITY PROJECT NO. WS90400085  
DATE: 08/2024  
E-04 SHEET 95 OF 134  
CAD FILE: CEELS40LEGEND2.dwg

THIS DRAWING MUST BE FIELD VERIFIED BEFORE USE  
DRAWING NOT TO SCALE UNLESS SCALE BAR IS PRESENT

FOR CONSTRUCTION

"PER CITY OF PHOENIX CODE CHAPTER 2, SECTION 2-28, THESE PLANS ARE FOR OFFICIAL USE ONLY AND MAY NOT BE SHARED WITH OTHERS EXCEPT AS REQUIRED TO FULFILL THE OBLIGATIONS OF THE CONTRACTOR'S CONTRACT WITH THE CITY OF PHOENIX."  
THIS DOCUMENT MUST BE KEPT SECURE AT ALL TIMES.

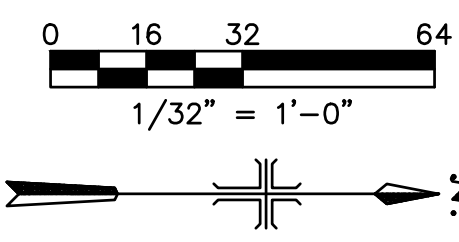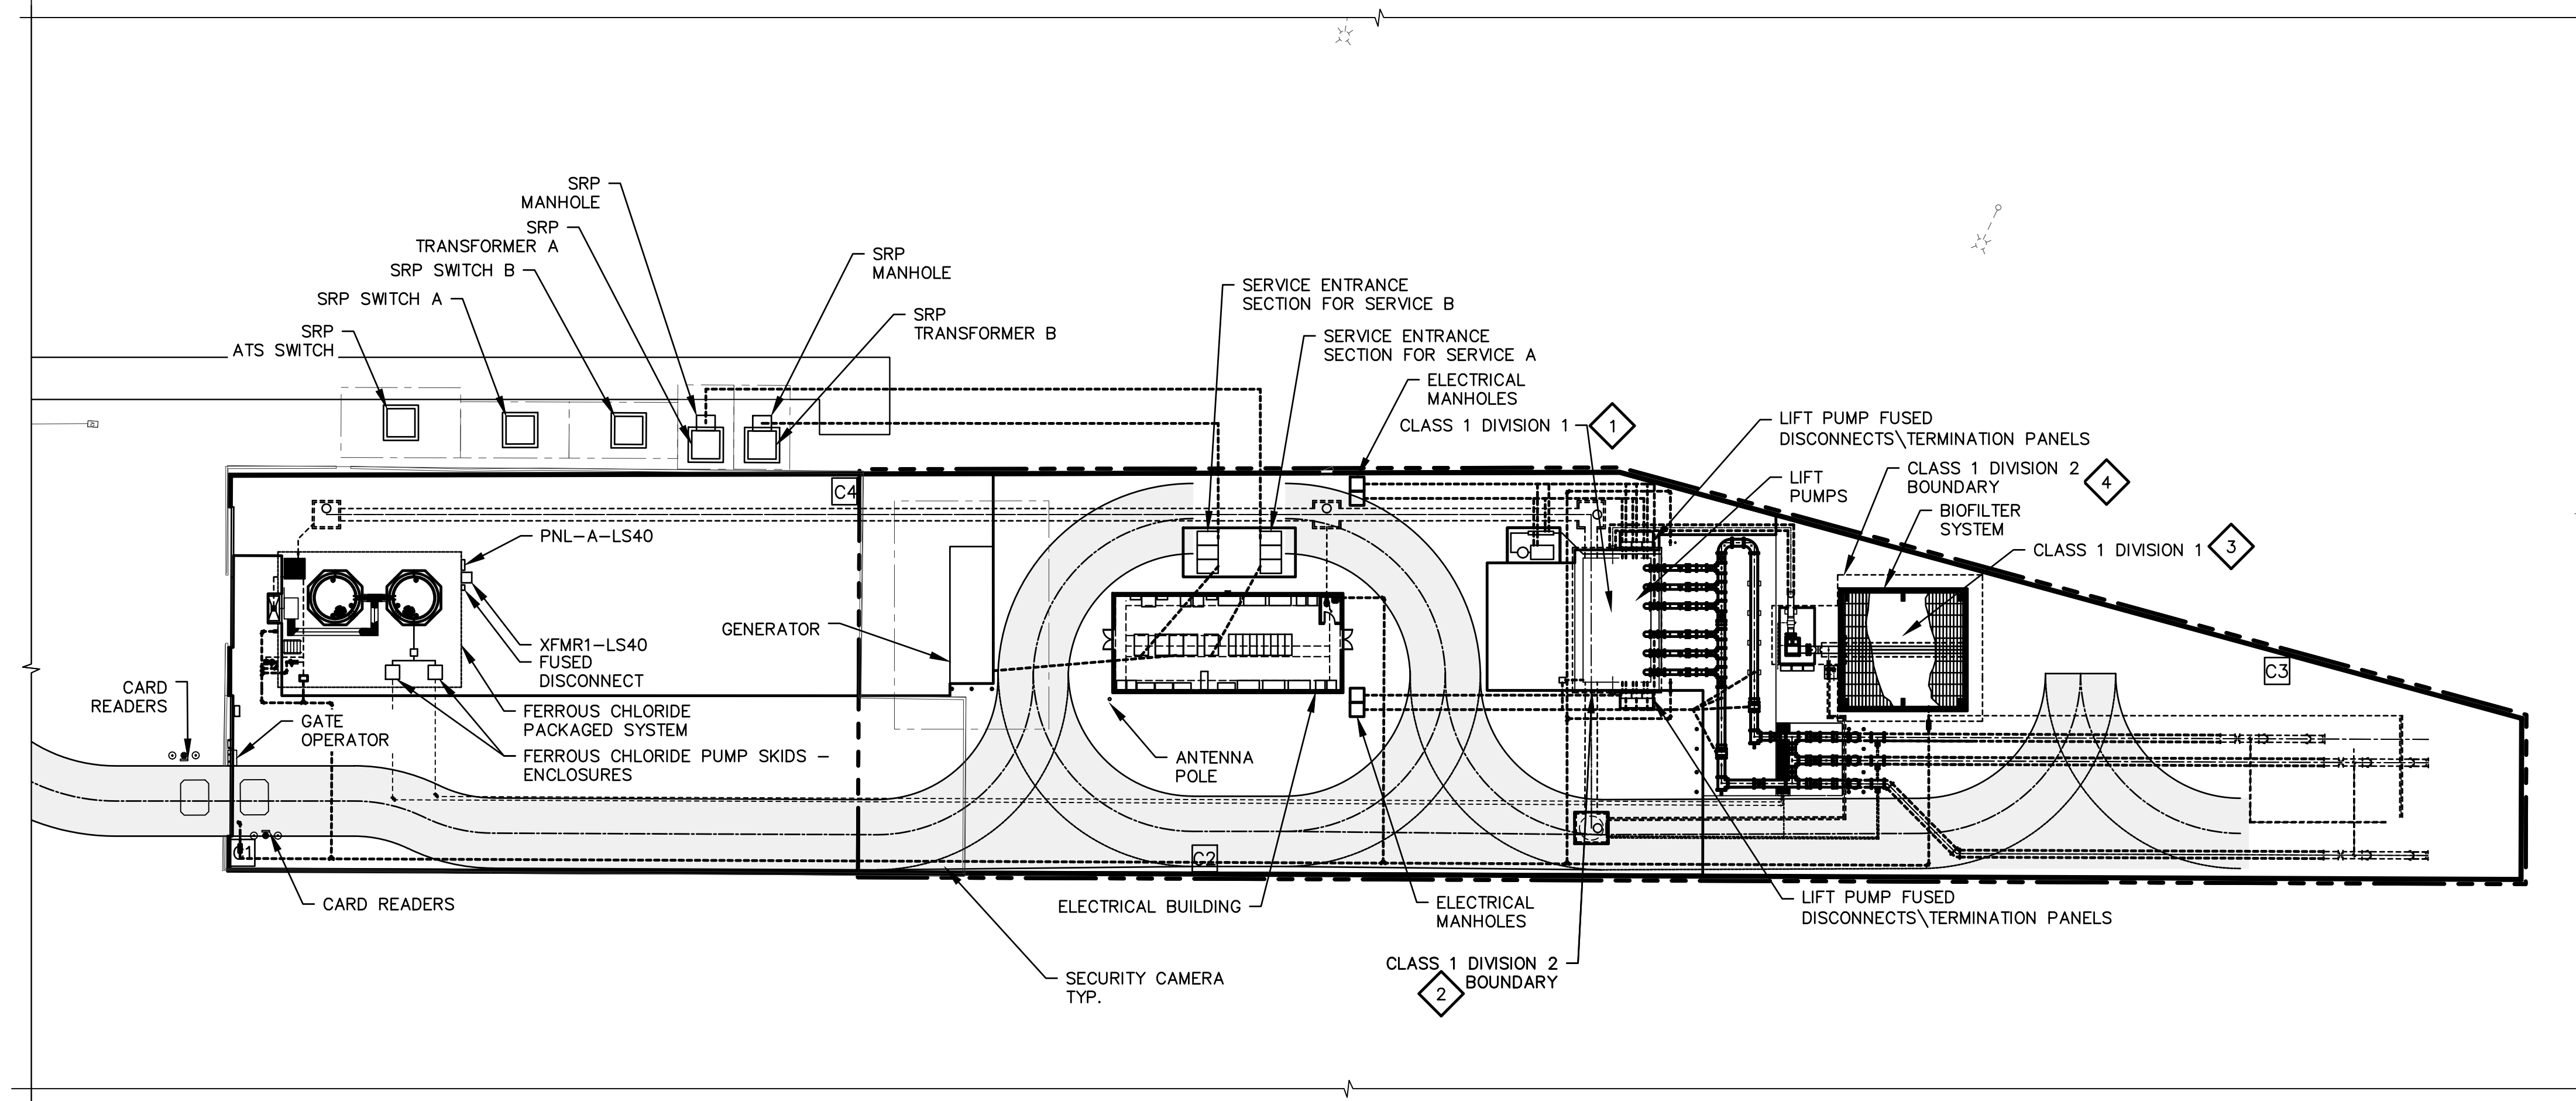

**KEY NOTES:**

- 1 ENTIRE WETWELL SPACE.
- 2 AREAS WITHIN THREE (3) FEET OF THE WETWELL PERIMETER.
- 3 ENTIRE BIOFILTER SPACE.
- 4 AREAS WITHIN 3 FEET OF LEAKAGE SOURCES SUCH AS BIOFILTER, BLOWER, DAMPER, PIPES, DUCTWORKS, AND VESSELS.

**GENERAL NOTES:**

1. PRIOR TO THE BID, THE CONTRACTOR SHALL VISIT THE PROJECT SITE AND INVESTIGATE THE DETAILS OF WORK ASSOCIATED WITH THIS PROJECT. NOT ALL DETAILS ARE INCLUDED IN THE BID DOCUMENTS. A SITE VISIT INVESTIGATION PRIOR TO THE BID IS REQUIRED.
2. THIS DRAWING DOES NOT INDICATE ALL THE PROJECT REQUIREMENTS. THE PROJECT REQUIREMENTS ARE INDICATED IN VARIOUS ELECTRICAL AND INSTRUMENTATION DRAWINGS AND SPECIFICATIONS. ALL DOCUMENTS MUST BE CAREFULLY INSPECTED AND GATHERED TOGETHER IN ORDER TO INCLUDE THE COLLECTIVE REQUIREMENTS FOR THIS PROJECT.
3. WHERE DISCREPANCIES EXIST AMONG VARIOUS DRAWINGS AND/OR SPECIFICATIONS, THE CONTRACTOR SHALL INCLUDE THE ITEM WITH THE MOST STRINGENT REQUIREMENT. FOR EXAMPLE, THE MOST LABORIOUS INSTALLATION, THE LARGER CONDUCTOR AND CONDUIT, THE HIGHER RATING DEVICE AND EQUIPMENT, THE FURTHER DISTANCE, ETC..
4. REFER TO NON-ELECTRICAL DRAWINGS FOR ADDITIONAL REQUIREMENTS THAT ARE NOT INDICATED ON THE ELECTRICAL DRAWINGS. THESE REQUIREMENTS MAY BE ELECTRICAL OR NON-ELECTRICAL WORK.
5. CIRCUITRY IS NOT SHOWN INTENTIONALLY. REFER TO OTHER DRAWINGS AND SPECIFICATIONS FOR COMPLETE CONDUIT AND CONDUCTOR REQUIREMENTS, INCLUDING BUT NOT LIMITED TO: SINGLE LINE DIAGRAMS, PANEL SCHEDULES, AND BLOCK DIAGRAMS
6. CONDUIT ROUTING IS NOT SHOWN INTENTIONALLY. CONDUIT ROUTING SHALL BE AS PERMITTED BY THE SPECIFICATIONS.
7. WHERE THE CONDUITS ARE INSTALLED UNDER EXISTING CONCRETE OR ASPHALT: SAW CUT AND REMOVE CONCRETE/ASPHALT; TRENCH, INSTALL CONDUITS, AND BACKFILL; AND INSTALL CONCRETE/ASPHALT AS REQUIRED TO MATCH EXISTING CONDITIONS.
8. EXISTING ITEMS ARE INDICATED AS EXISTING. ALL ITEMS ARE NEW UNLESS INDICATED EXISTING.
9. FURNISH AND INSTALL A 20-AMP, 120V, WEATHERPROOF, GFCI RECEPTACLE WITHIN 25 FEET OF EACH HVAC EQUIPMENT EVEN IF THEY ARE NOT INDICATED ON THE DRAWINGS.
10. FURNISH AND INSTALL A FUSED DISCONNECT SWITCH AT EACH HVAC EQUIPMENT EVEN IF THEY ARE NOT INDICATED ON THE DRAWINGS. UNLESS INDICATED OTHERWISE, FURNISH AND INSTALL A 60A, 480V, NEMA 4X SWITCH WITH FUSES PER MANUFACTURER'S RECOMMENDATION.
11. FOR EACH SPLIT SYSTEM AIR CONDITIONING UNIT, FURNISH AND INSTALL 3/4-INCH CONDUIT FROM THE CONDENSER TO THE AIR HANDLING UNIT WITH 4-#12, #12GND FOR CONTROL.
12. FOR EACH THERMOSTAT, FURNISH AND INSTALL 3/4-INCH CONDUIT FROM THE THERMOSTAT TO THE HVAC EQUIPMENT CONTROLLER WITH MULTI-CONDUCTOR CABLE CONTROL.
13. CONTRACTOR TO FIELD VERIFY THE LOCATION OF THE STORM DRAIN AND MOVE SRP EQUIPMENT ACCORDINGLY WITHOUT REDUCING THE CLEARANCE REQUIRED AS SHOWN BY THE DASHED LINES.

FACILITY DRAWINGS  
 This drawing was supplied by a Consultant Engineer from a past construction project. The original construction drawing was modified based on information provided by the Contractor to provide the Record Drawing. The City does not warrant the accuracy or completeness of the drawings and accurate portrayal of facilities as they exist in the field.

REVISION	DWG NUMBER	CAD FILE NAME	DATE	PROJECT NO.	PROJECT NAME	REFERENCE CID NUMBER	#


			<b>REVISIONS</b>	<b>DES</b> RB DWN BB CKD VB		CITY OF PHOENIX WATER SERVICES DEPARTMENT	ELECTRICAL  OVERALL SITE PLAN	COPYRIGHT © 2007-JANUARY																			
			<table border="1" style="width: 100%; border-collapse: collapse;"> <thead> <tr> <th>NO.</th> <th>BY</th> <th>DATE</th> <th>CKD</th> <th>REMARKS</th> </tr> </thead> <tbody> <tr><td> </td><td> </td><td> </td><td> </td><td> </td></tr> <tr><td> </td><td> </td><td> </td><td> </td><td> </td></tr> <tr><td> </td><td> </td><td> </td><td> </td><td> </td></tr> <tr><td> </td><td> </td><td> </td><td> </td><td> </td></tr> </tbody> </table>	NO.		BY		DATE	CKD	REMARKS																	
NO.	BY	DATE	CKD	REMARKS																							



THIS DRAWING MUST BE FIELD VERIFIED BEFORE USE. DRAWING NOT TO SCALE UNLESS SCALE BAR IS PRESENT.

FOR CONSTRUCTION

\*PER CITY OF PHOENIX CODE CHAPTER 2, SECTION 2-28, THESE PLANS ARE FOR OFFICIAL USE ONLY AND MAY NOT BE SHARED WITH OTHERS EXCEPT AS REQUIRED TO FULFILL THE OBLIGATIONS OF THE CONTRACTOR'S CONTRACT WITH THE CITY OF PHOENIX. THIS DOCUMENT MUST BE KEPT SECURE AT ALL TIMES.

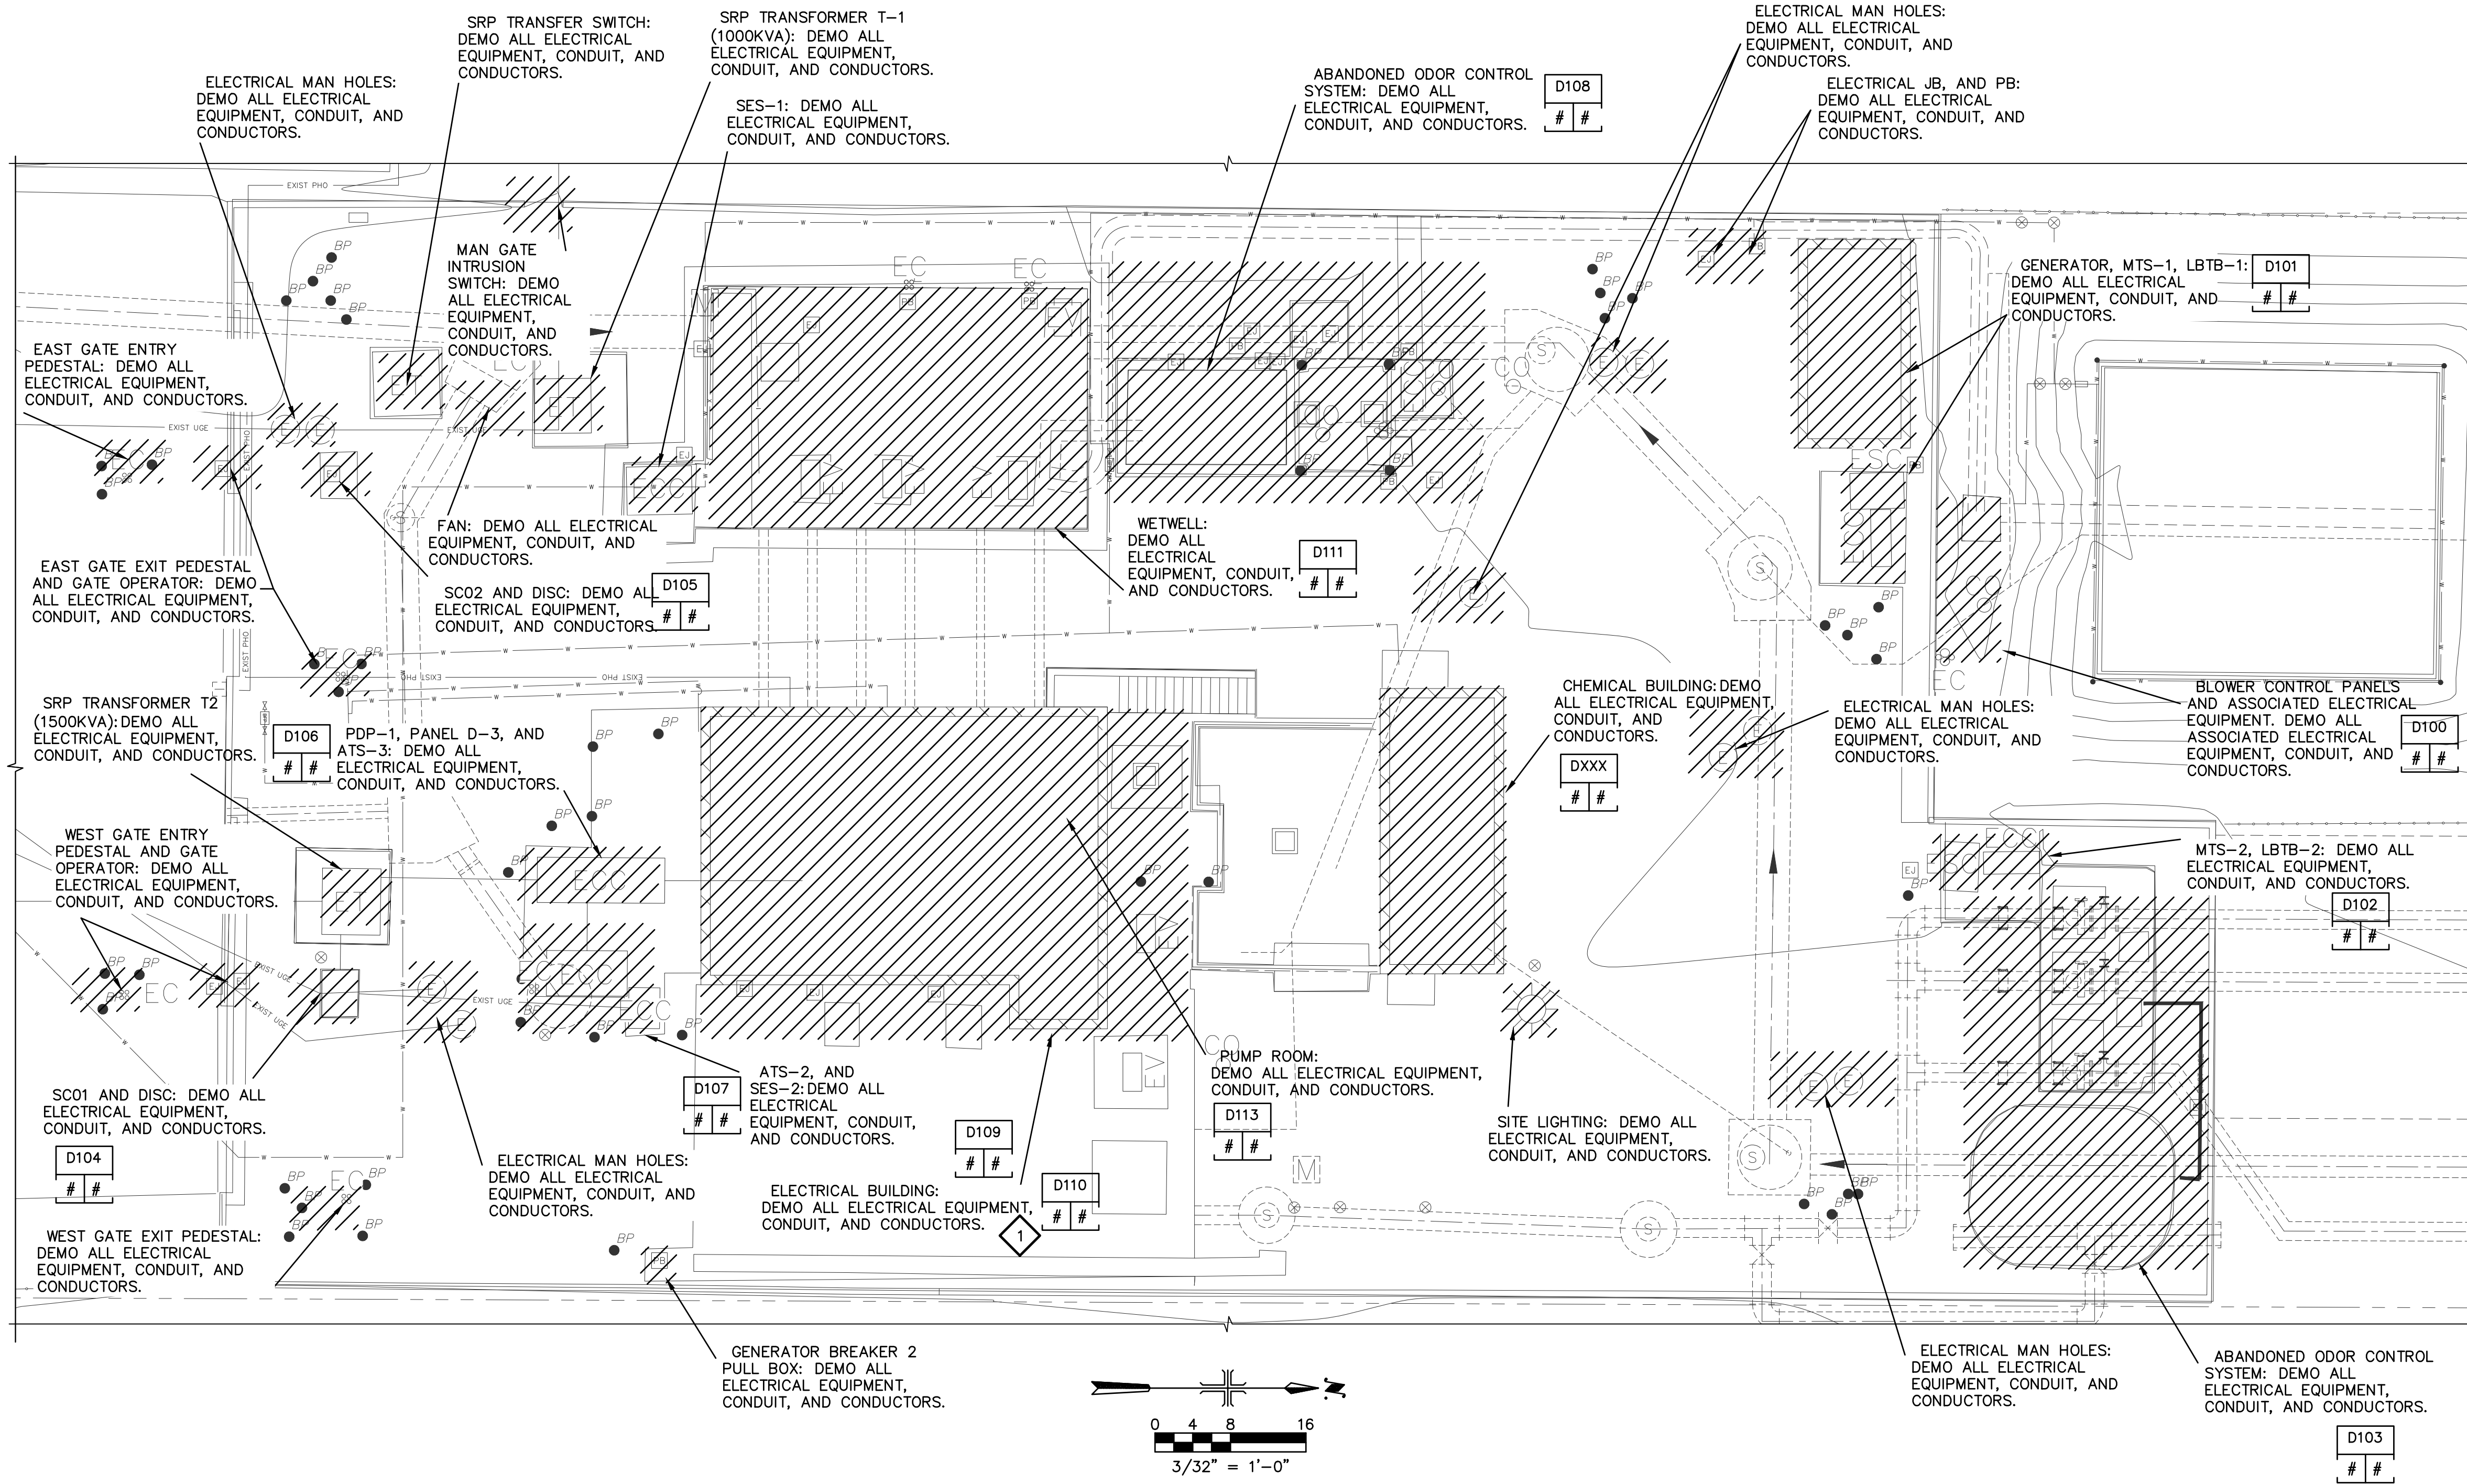

**GENERAL NOTES:**


1. PRIOR TO THE BID, THE CONTRACTOR SHALL VISIT THE PROJECT SITE AND INVESTIGATE THE DETAILS OF WORK ASSOCIATED WITH THIS PROJECT. NOT ALL DETAILS ARE INCLUDED IN THE BID DOCUMENTS. A SITE VISIT INVESTIGATION PRIOR TO THE BID IS REQUIRED.
2. THIS DRAWING DOES NOT INDICATE ALL DEMOLITION REQUIREMENTS FOR THIS PROJECT. THE EXISTING PROJECT CONDITIONS (STRUCTURES, POLES, EQUIPMENT, UNDERGROUND AND ABOVEGROUND PIPES AND CONDUITS, AND ETC...) ARE INDICATED ON NON-ELECTRICAL DRAWINGS INCLUDING BUT NOT LIMITED TO CIVIL AND MECHANICAL DRAWINGS. REFER TO NON-ELECTRICAL DRAWINGS FOR ADDITIONAL INFORMATION NOT INDICATED ON THIS DRAWING. ALL CONTRACT DOCUMENTS MUST BE CAREFULLY INSPECTED AND GATHERED TOGETHER IN ORDER TO INCLUDE THE COLLECTIVE REQUIREMENTS FOR THIS PROJECT.
3. FOR CIRCUITS BEING DEMOLISHED, REMOVE ASSOCIATED CONDUCTORS, REMOVE ASSOCIATED ABOVEGROUND CONDUITS (INCLUDING FITTINGS AND SUPPORTS), AND ABANDON BELOW GRADE CONDUITS IN PLACE. CUT CONDUIT SUB-UPS FLUSH WITH CONCRETE PAD OR 12" BELOW GRADE AND ABANDON REMAINING UNDERGROUND CONDUIT IN PLACE. DEMOLISHED CONDUCTORS SHALL ALWAYS BE DISCONNECTED AND REMOVED BACK TO SOURCE UNLESS OTHERWISE INDICATED.
4. DISCONNECT AND REMOVE EQUIPMENT AND ASSOCIATED HARDWARE AND LABELING IN ITS ENTIRETY AS INDICATED ON THE PLANS. PATCH AND, OR PAINT ANY EXISTING HOLES OR OUTLINES LEFT FROM DEMOLISHED EQUIPMENT AS NECESSARY TO MINIMIZE INDICATIONS OF PREVIOUS EQUIPMENT LOCATIONS.
5. ALL DEMOLISHED EQUIPMENT AND MATERIAL NOT BEING SALVAGED BY THE OWNER SHALL BECOME PROPERTY OF THE CONTRACTOR FOR PROPER REMOVAL AND DISPOSAL.
6. CONTRACTOR SHALL COORDINATE WITH THE OWNER TO DETERMINE IF ANY EQUIPMENT OR MATERIALS ARE TO BE SALVAGED TO THE OWNER. CONTRACTOR SHALL PROVIDE PROPER PROTECTION, STORAGE AND TRANSPORTATION OF SALVAGED EQUIPMENT TO AN OWNER DESIGNATED DROP OFF LOCATION.
7. USE IF APPROPRIATE: ELECTRICAL DEMOLITION INCLUDES THE REMOVAL OF ANY ELECTRICAL EQUIPMENT CONCRETE PADS AND/OR EQUIPMENT FOUNDATIONS UNLESS OTHERWISE INDICATED.
8. REFER TO DEMOLITION SPECIFICATIONS FOR ADDITIONAL REQUIREMENTS NOT INDICATED ON THIS DRAWING.
9. COORDINATE WORK WITH THE UTILITY COMPANY. REFER TO DEMOLITION SPECIFICATIONS FOR ADDITIONAL REQUIREMENTS.
10. REMOVE ELECTRICAL INSTRUMENTATION, AND CONTROL DEVICES, EQUIPMENT, EXPOSED CONDUITS, CONDUCTORS, AND THEIR ASSOCIATED APURTENANCES. VERIFY WITH OWNER PRIOR TO DISCONNECTION AND REMOVAL OF THE ITEMS. RETAIN AND DELIVER THE ITEMS THAT THE OWNER WISHED TO KEEP. DISPOSE OF THE REMAINDER. REFER TO DEMOLITION SPECIFICATIONS FOR ADDITIONAL REQUIREMENTS.

**KEY NOTES:**

- 1. KEEP AND REUSE EXISTING TRIPOD ANTENNA POLE ON TOP OF EXITING ELECTRICAL BUILDING.

FACILITY DRAWINGS  
This drawing was supplied by a Consultant Engineer from a past construction project. The original construction drawing was modified based on information provided by the Contractor to provide the Record Drawing. The City does not warrant the accuracy and reliability of the information and accurate portrayal of facilities as they exist in the field.

REVISIONS	REMARKS	DWG NUMBER	CAD FILE NAME	DATE

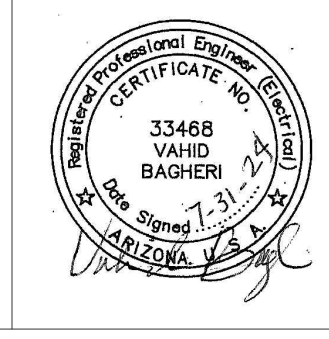

REVISIONS				
NO.	BY	DATE	CKD	REMARKS



CITY OF PHOENIX  
WATER SERVICES DEPARTMENT  
  
LIFT STATION 40  
REFURBISHMENT


ELECTRICAL  
  
DEMOSITE PLAN

COPYRIGHT © 2007-JANUARY  
CITY PROJECT NO. WS90400085  
DATE: 08/2024  
E-06 SHEET 97 OF 134  
CAD FILE: CEELS40EM01.dwg


THIS DRAWING MUST BE FIELD VERIFIED BEFORE USE. DRAWING NOT TO SCALE UNLESS SCALE BAR IS PRESENT.

FOR CONSTRUCTION

\*PER CITY OF PHOENIX CODE CHAPTER 2, SECTION 2-28, THESE PLANS ARE FOR OFFICIAL USE ONLY AND MAY NOT BE SHARED WITH OTHERS EXCEPT AS REQUIRED TO FULFILL THE OBLIGATIONS OF THE CONTRACTOR'S CONTRACT WITH THE CITY OF PHOENIX. THIS DOCUMENT MUST BE KEPT SECURE AT ALL TIMES.

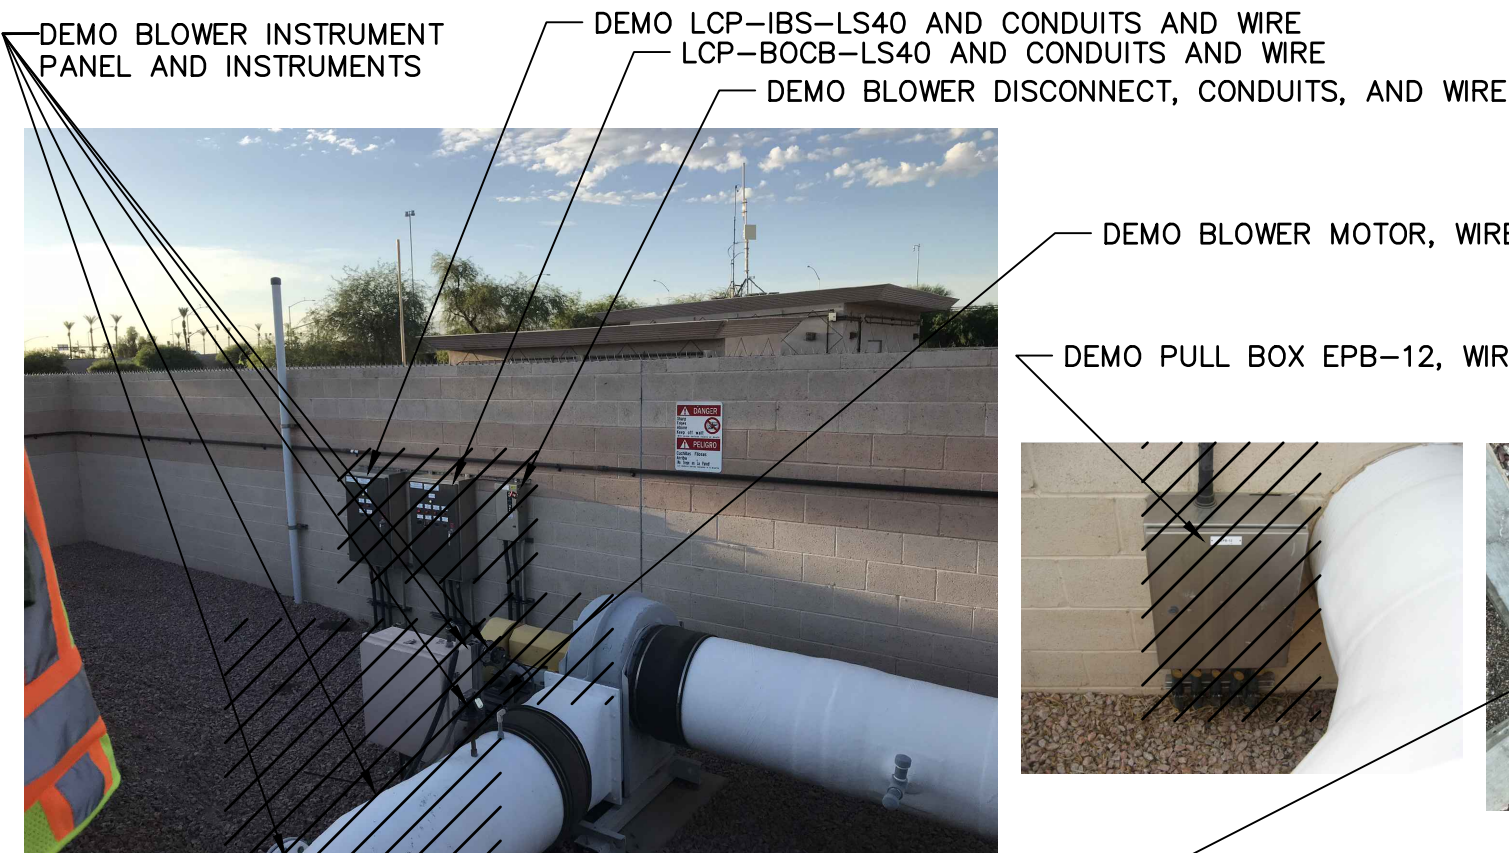


DETAIL D100 **BIOFILTER EQUIPMENT DEMO DETAILS**  
SCALE = NONE

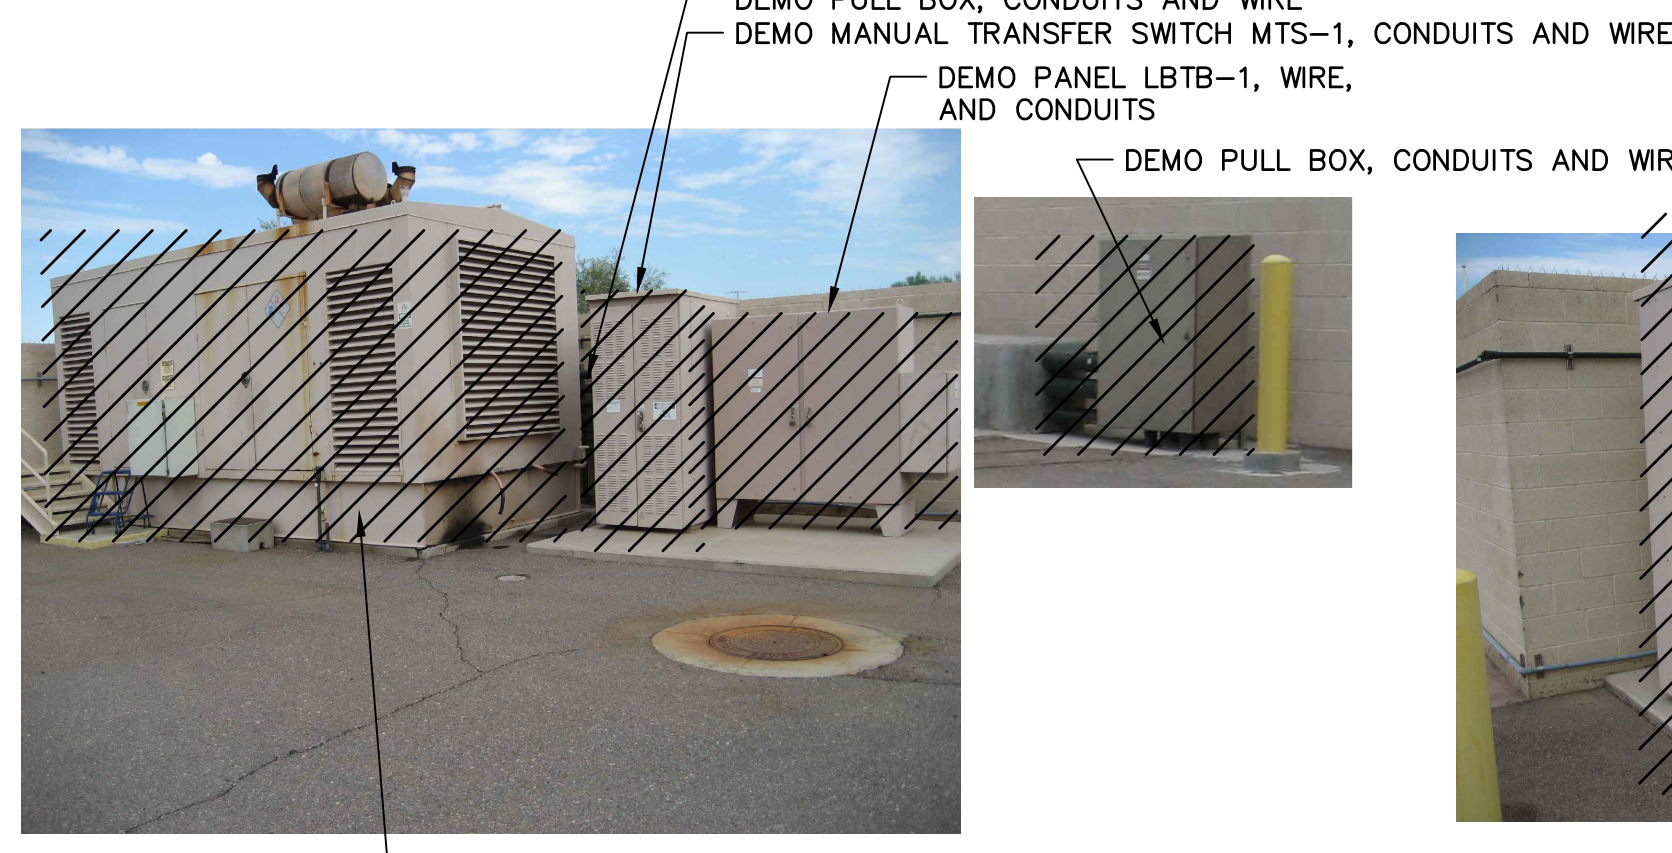

DETAIL D101 **GENERATOR, LBTB-1, AND MTS-1 DEMO DETAILS**  
SCALE = NONE

DETAIL D102 **MTS-2 AND LBTB-2 DEMO DETAILS**  
SCALE = NONE


DETAIL D103 **ODOR CONTROL EQUIPMENT DEMO DETAILS**  
SCALE = NONE

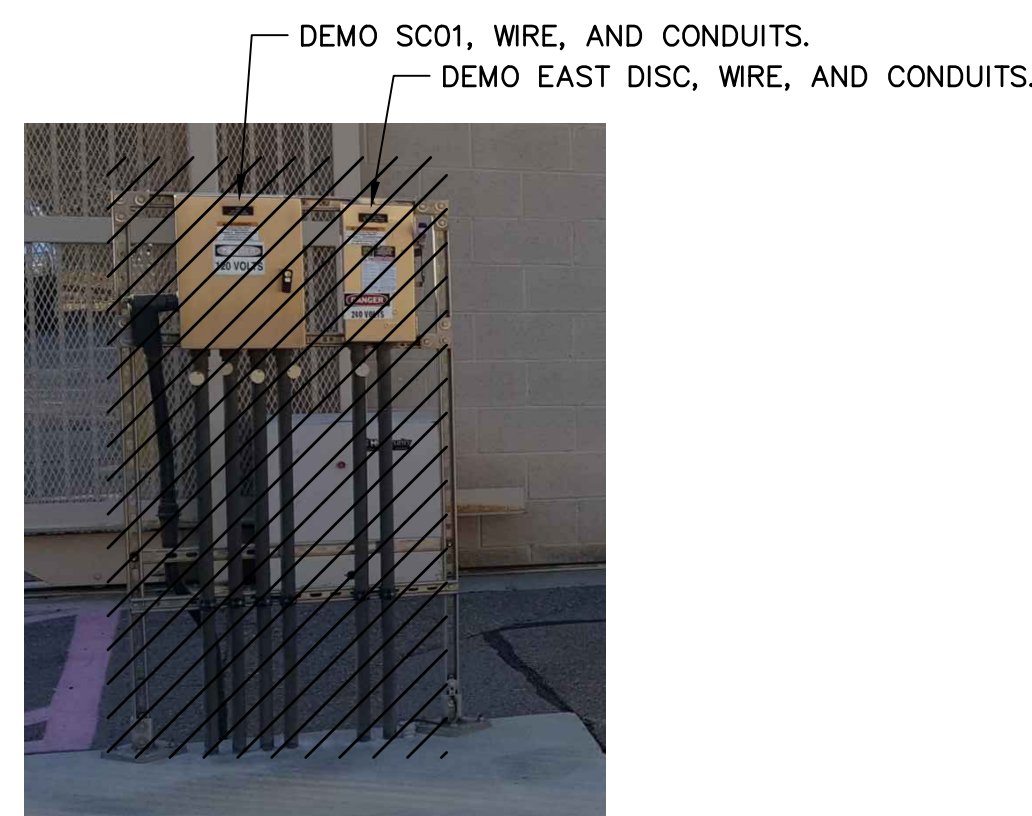

DETAIL D104 **SC01, AND DISCONNECT DEMO DETAILS**  
SCALE = NONE




DETAIL D105 **SC02, AND DISCONNECT DEMO DETAILS**  
SCALE = NONE

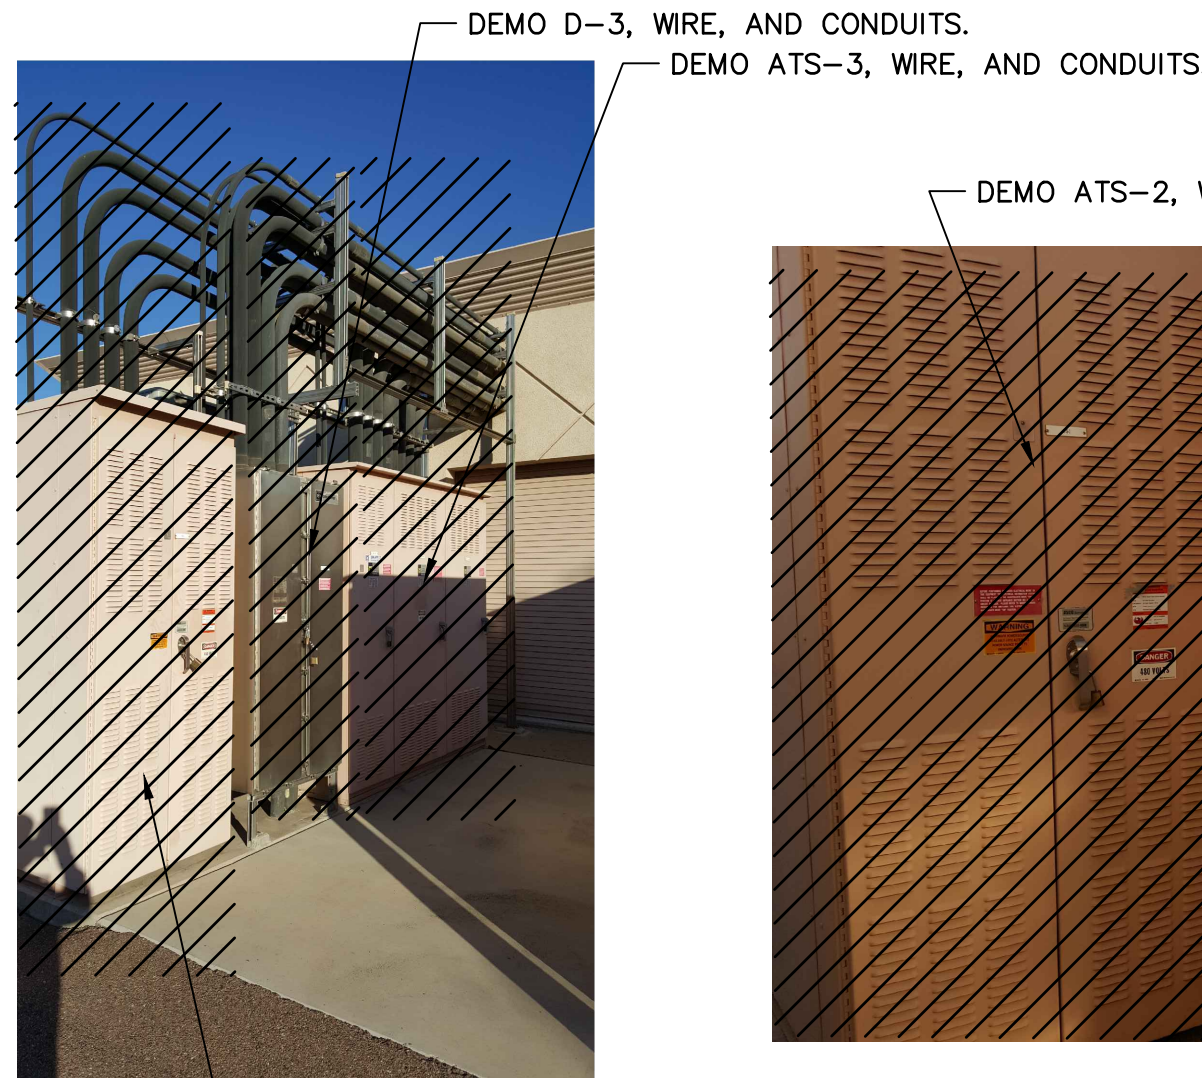

DETAIL D106 **PDB-1, D-3, AND ATS-3 DEMO DETAILS**  
SCALE = NONE



DETAIL D107 **ATS-2, and SES-2 DEMO DETAILS**  
SCALE = NONE

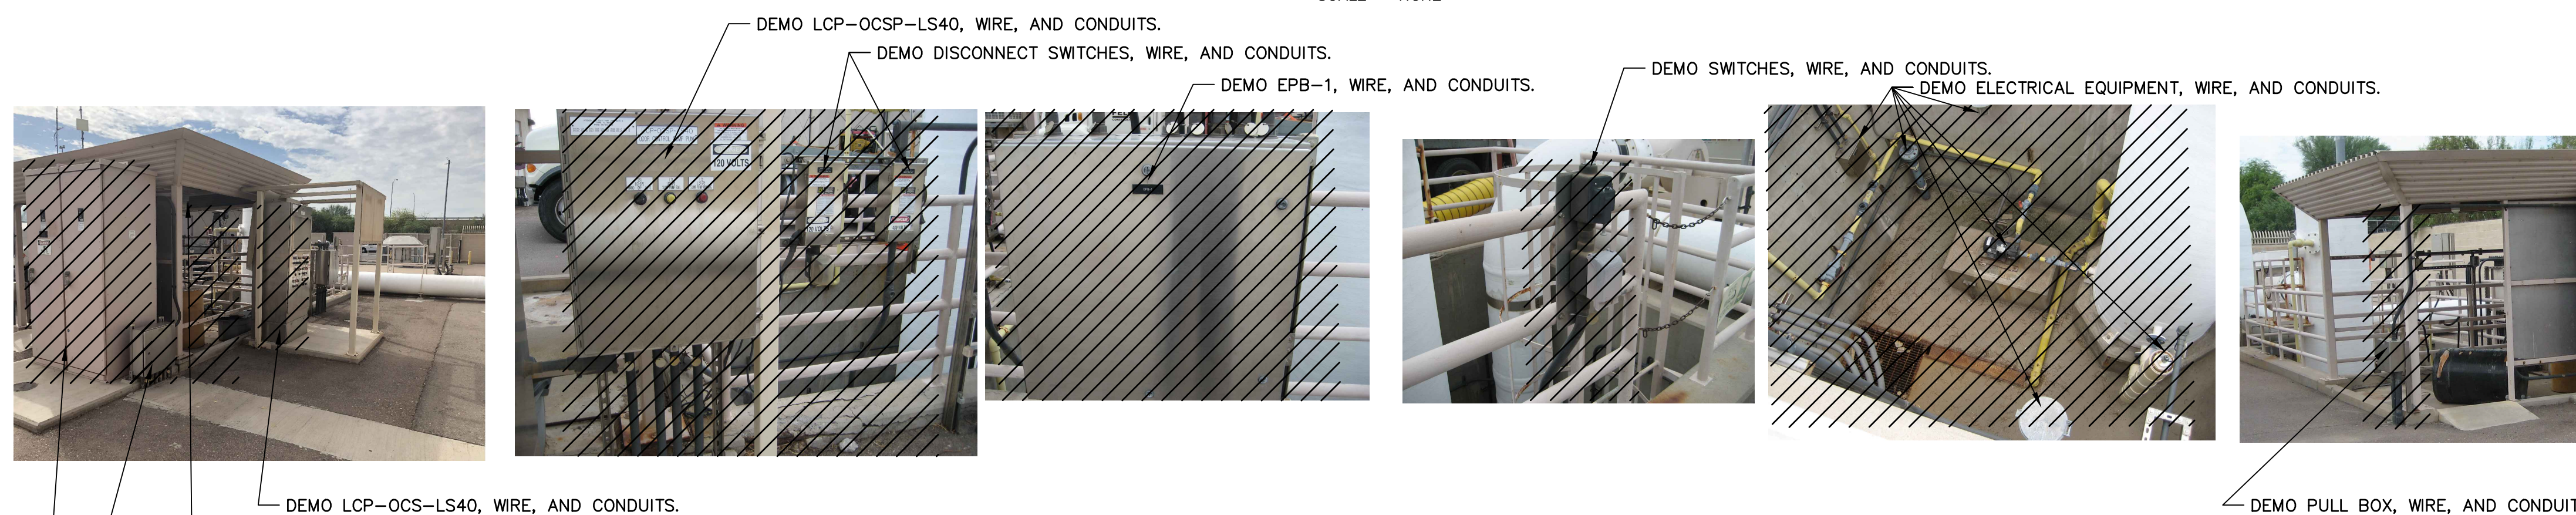

DETAIL D108 **ABANDONED ODOR CONTROL SYSTEM DEMO DETAILS**  
SCALE = NONE

**GENERAL NOTES:**

- PRIOR TO THE BID, THE CONTRACTOR SHALL VISIT THE PROJECT SITE AND INVESTIGATE THE DETAILS OF WORK ASSOCIATED WITH THIS PROJECT. NOT ALL DETAILS ARE INCLUDED IN THE BID DOCUMENTS. A SITE VISIT INVESTIGATION PRIOR TO THE BID IS REQUIRED.
- THIS DRAWING DOES NOT INDICATE ALL DEMOLITION REQUIREMENTS FOR THIS PROJECT. THE EXISTING PROJECT CONDITIONS (STRUCTURES, POLES, EQUIPMENT, UNDERGROUND AND ABOVEGROUND PIPES AND CONDUITS, AND ETC...) ARE INDICATED ON NON-ELECTRICAL DRAWINGS INCLUDING BUT NOT LIMITED TO CIVIL AND MECHANICAL DRAWINGS. REFER TO NON-ELECTRICAL DRAWINGS FOR ADDITIONAL INFORMATION NOT INDICATED ON THIS DRAWING. ALL CONTRACT DOCUMENTS MUST BE CAREFULLY INSPECTED AND GATHERED TOGETHER IN ORDER TO INCLUDE THE COLLECTIVE REQUIREMENTS FOR THIS PROJECT.
- FOR CIRCUITS BEING DEMOLISHED, REMOVE ASSOCIATED CONDUCTORS, REMOVE ASSOCIATED ABOVEGROUND CONDUITS (INCLUDING FITTINGS AND SUPPORTS), AND ABANDON BELOW GRADE CONDUITS IN PLACE. CUT CONDUIT STUB-UPS FLUSH WITH CONCRETE PAD OR 12" BELOW GRADE AND ABANDON REMAINING UNDERGROUND CONDUIT IN PLACE. DEMOLISHED CONDUCTORS SHALL ALWAYS BE DISCONNECTED AND REMOVED BACK TO SOURCE UNLESS OTHERWISE INDICATED.
- DISCONNECT AND REMOVE EQUIPMENT AND ASSOCIATED HARDWARE AND LABELING IN ITS ENTIRETY AS INDICATED ON THE PLANS. PATCH AND, OR PAINT ANY EXISTING HOLES OR OUTLINES LEFT FROM DEMOLISHED EQUIPMENT AS NECESSARY TO MINIMIZE INDICATIONS OF PREVIOUS EQUIPMENT LOCATIONS.
- ALL DEMOLISHED EQUIPMENT AND MATERIAL NOT BEING SALVAGED BY THE OWNER SHALL BECOME PROPERTY OF THE CONTRACTOR FOR PROPER REMOVAL AND DISPOSAL.
- CONTRACTOR SHALL COORDINATE WITH THE OWNER TO DETERMINE IF ANY EQUIPMENT OR MATERIALS ARE TO BE SALVAGED TO THE OWNER. CONTRACTOR SHALL PROVIDE PROPER PROTECTION, STORAGE AND TRANSPORTATION OF SALVAGED EQUIPMENT TO AN OWNER DESIGNATED DROP OFF LOCATION.
- USE IF APPROPRIATE: ELECTRICAL DEMOLITION INCLUDES THE REMOVAL OF ANY ELECTRICAL EQUIPMENT CONCRETE PADS AND/OR EQUIPMENT FOUNDATIONS UNLESS OTHERWISE INDICATED.
- REFER TO DEMOLITION SPECIFICATIONS FOR ADDITIONAL REQUIREMENTS NOT INDICATED ON THIS DRAWING.
- COORDINATE WORK WITH THE UTILITY COMPANY. REFER TO DEMOLITION SPECIFICATIONS FOR ADDITIONAL REQUIREMENTS.
- REMOVE ELECTRICAL, INSTRUMENTATION, AND CONTROL DEVICES, EQUIPMENT, EXPOSED CONDUITS, CONDUCTORS, AND THEIR ASSOCIATED APPURTENANCES. VERIFY WITH OWNER PRIOR TO DISCONNECTION AND REMOVAL OF THE ITEMS. RETAIN AND DELIVER THE ITEMS THAT THE OWNER WISHED TO KEEP. DISPOSE OF THE REMAINDER. REFER TO DEMOLITION SPECIFICATIONS FOR ADDITIONAL REQUIREMENTS.

FACILITY DRAWINGS  
This drawing was supplied by a Consultant Engineer from a past construction project. The original construction drawing was modified based on information provided by the Contractor to provide the Record Drawing. The City does not warrant the accuracy and reliability of the information and accurate portrayal of facilities as they exist in the field.


REVISION	DWG NUMBER	CAD FILE NAME	DATE	PROJECT NAME	PROJECT NO.	REFERENCE CID NUMBER	NO.

			<table border="1"> <thead> <tr> <th colspan="4">REVISIONS</th> </tr> <tr> <th>NO.</th> <th>BY</th> <th>DATE</th> <th>REMARKS</th> </tr> </thead> <tbody> <tr> <td> </td> <td> </td> <td> </td> <td> </td> </tr> </tbody> </table>				REVISIONS				NO.	BY	DATE	REMARKS					DES RB DWN BB CKD VB		CITY OF PHOENIX WATER SERVICES DEPARTMENT	ELECTRICAL	COPYRIGHT © 2007-JANUARY
			REVISIONS																				
NO.	BY	DATE	REMARKS																				
CITY PROJECT NO. WS90400085	LIFT STATION 40 REFURBISHMENT	DEMO SITE PLAN DETAILS 1	DATE: 08/2024 E-07 SHEET 98 OF 134 CAD FILE: CEELS40EM02.dwg																				





THIS DRAWING MUST BE FIELD VERIFIED BEFORE USE  
DRAWING NOT TO SCALE UNLESS SCALE BAR IS PRESENT

FOR CONSTRUCTION





PER CITY OF PHOENIX CODE CHAPTER 2, SECTION 2-28, THESE PLANS ARE FOR OFFICIAL USE ONLY AND MAY NOT BE SHARED WITH OTHERS EXCEPT AS REQUIRED TO FULFILL THE OBLIGATIONS OF THE CONTRACTOR'S CONTRACT WITH THE CITY OF PHOENIX.  
THIS DOCUMENT MUST BE KEPT SECURE AT ALL TIMES.

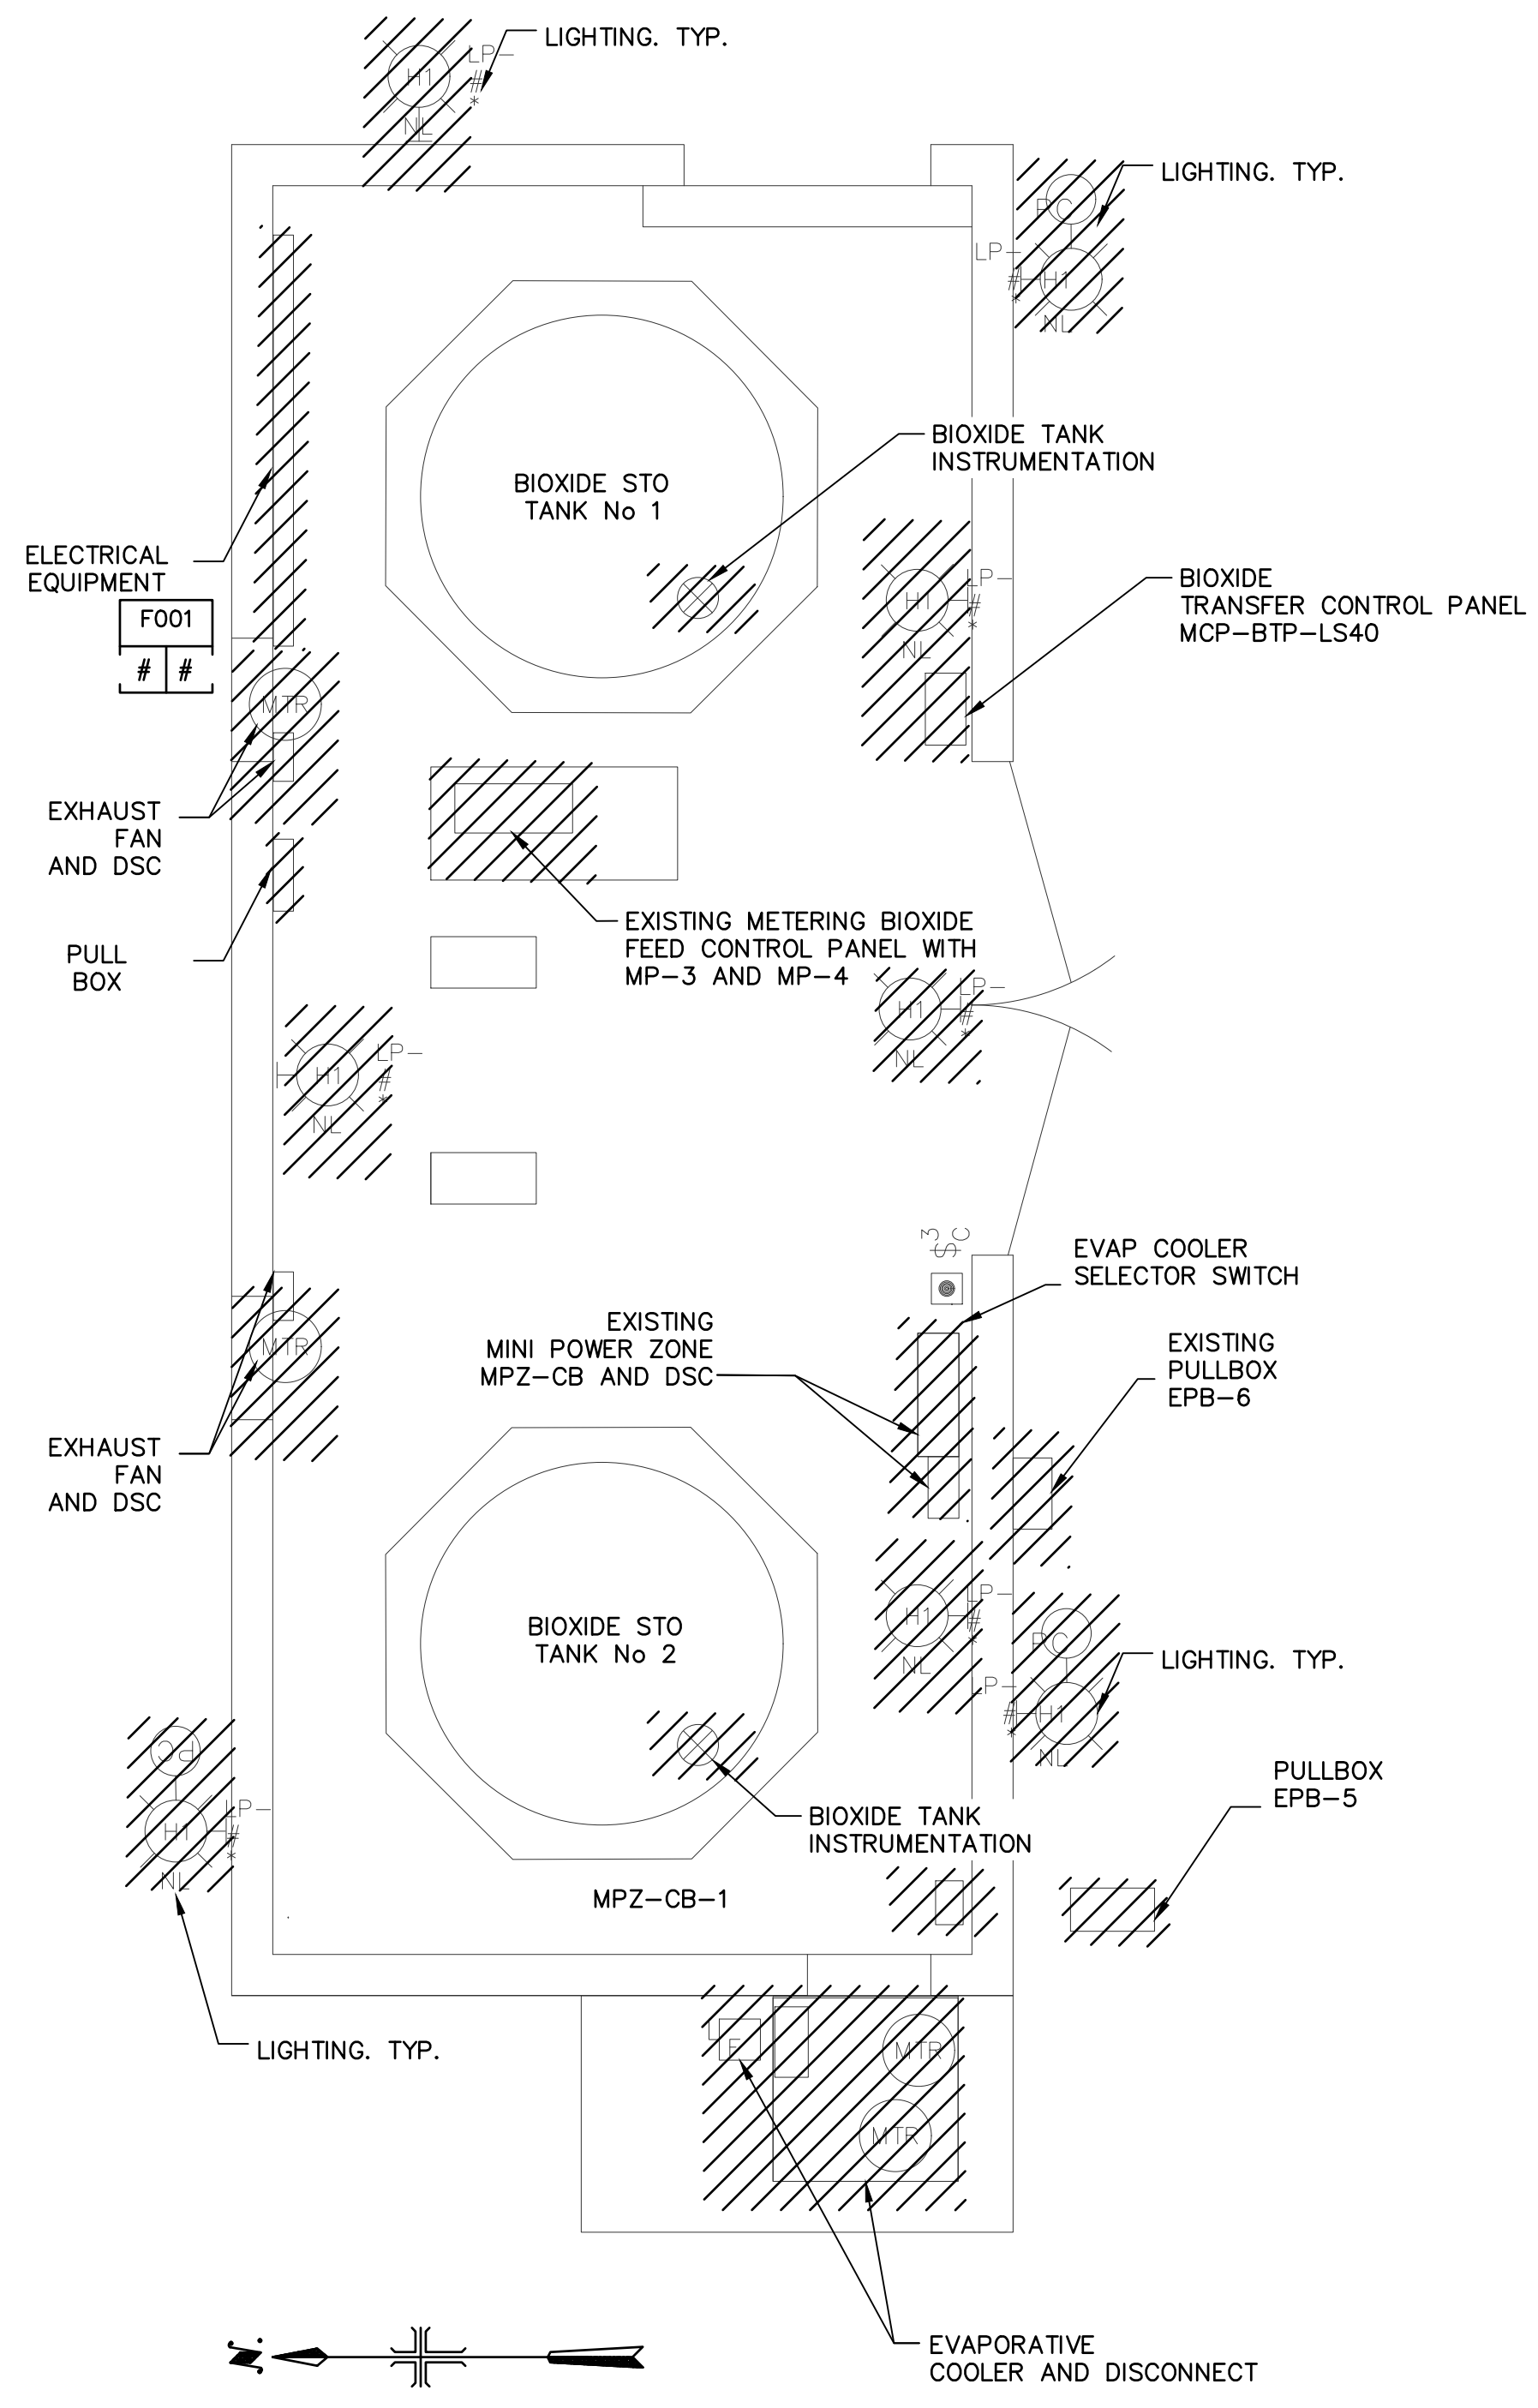


DETAIL D112 CHEMICAL BUILDING DEMO DETAILS  
SCALE = NONE

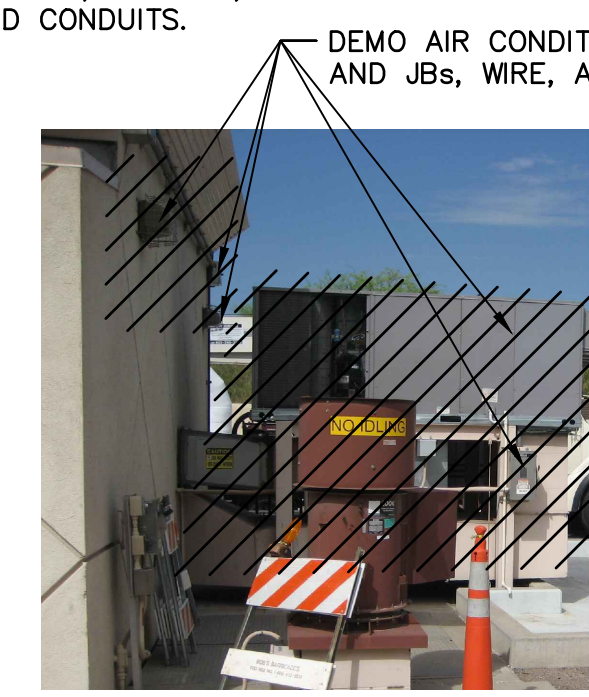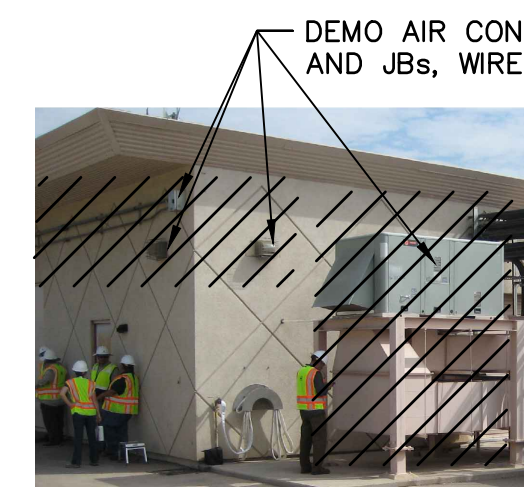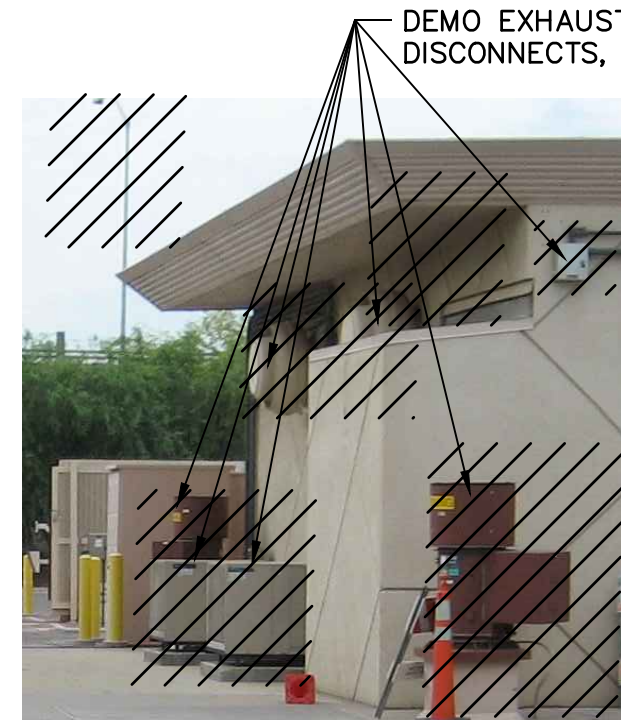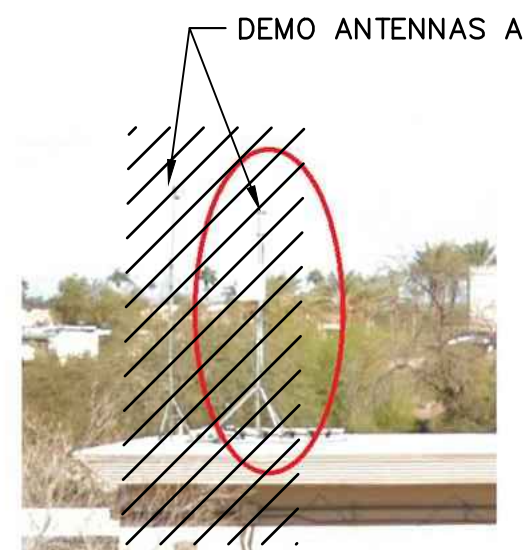

DETAIL D109 ELECTRICAL BUILDING EXTERIOR DEMO DETAILS  
SCALE = NONE

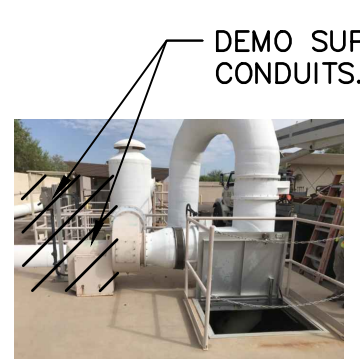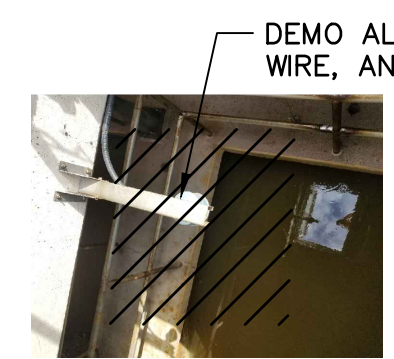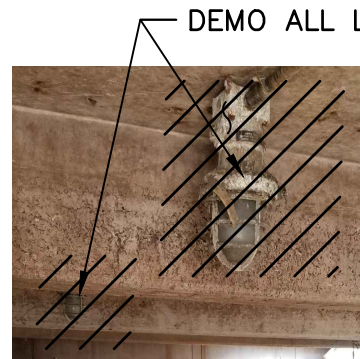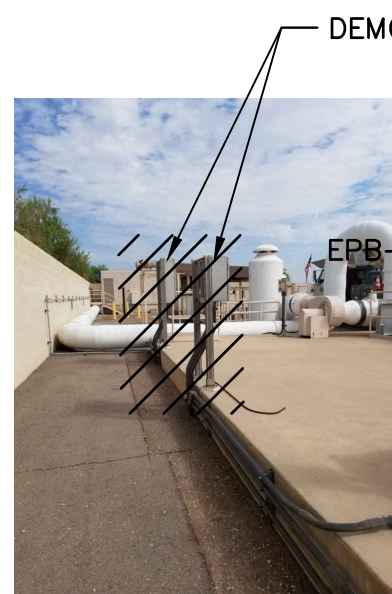

DETAIL D111 WETWELL DEMO DETAILS  
SCALE = NONE

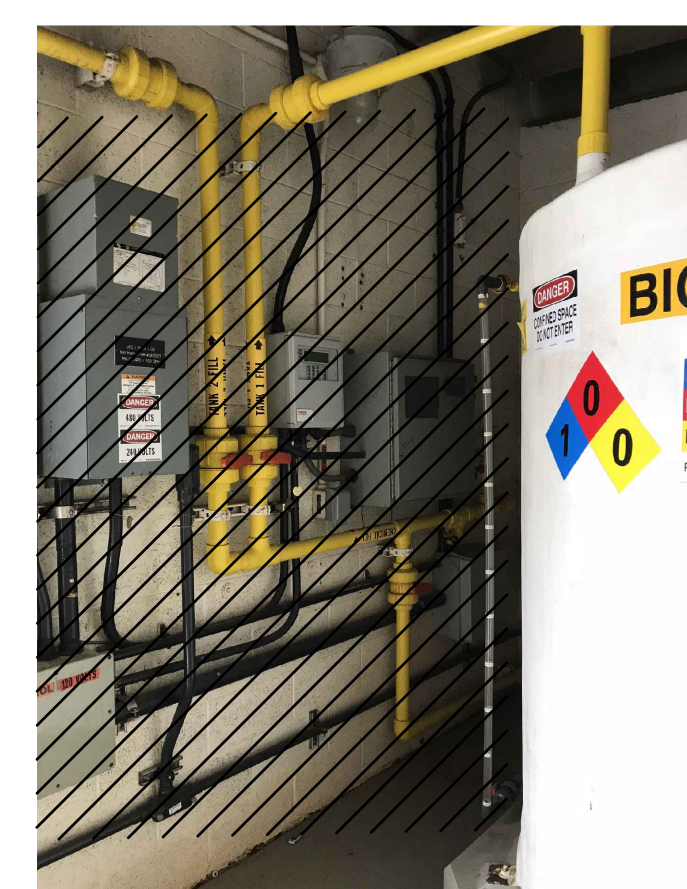



DETAIL F001 ELECTRICAL EQUIPMENT  
SCALE = NONE

**GENERAL NOTES:**


- PRIOR TO THE BID, THE CONTRACTOR SHALL VISIT THE PROJECT SITE AND INVESTIGATE THE DETAILS OF WORK ASSOCIATED WITH THIS PROJECT. NOT ALL DETAILS ARE INDICATED ON NON-ELECTRICAL DRAWINGS INCLUDING BUT NOT LIMITED TO CIVIL AND MECHANICAL DRAWINGS. REFER TO NON-ELECTRICAL DRAWINGS FOR ADDITIONAL INFORMATION NOT INDICATED ON THIS DRAWING. ALL CONTRACT DOCUMENTS MUST BE CAREFULLY INSPECTED AND GATHERED TOGETHER IN ORDER TO INCLUDE THE COLLECTIVE REQUIREMENTS FOR THIS PROJECT.
- THIS DRAWING DOES NOT INDICATE ALL DEMOLITION REQUIREMENTS FOR THIS PROJECT. THE EXISTING PROJECT CONDITIONS (STRUCTURES, POLES, EQUIPMENT, UNDERGROUND AND ABOVEGROUND PIPES AND CONDUITS, AND ETC...) ARE INDICATED ON NON-ELECTRICAL DRAWINGS INCLUDING BUT NOT LIMITED TO CIVIL AND MECHANICAL DRAWINGS. REFER TO NON-ELECTRICAL DRAWINGS FOR ADDITIONAL INFORMATION NOT INDICATED ON THIS DRAWING. ALL CONTRACT DOCUMENTS MUST BE CAREFULLY INSPECTED AND GATHERED TOGETHER IN ORDER TO INCLUDE THE COLLECTIVE REQUIREMENTS FOR THIS PROJECT.
- FOR CIRCUITS BEING DEMOLISHED, REMOVE ASSOCIATED CONDUCTORS, REMOVE ASSOCIATED ABOVEGROUND CONDUITS (INCLUDING FITTINGS AND SUPPORTS), AND ABANDON BELOW GRADE CONDUITS IN PLACE. CUT CONDUIT STUB-UPS FLUSH WITH CONCRETE PAD OR 12" BELOW GRADE AND ABANDON REMAINING UNDERGROUND CONDUIT IN PLACE. DEMOLISHED CONDUCTORS SHALL ALWAYS BE DISCONNECTED AND REMOVED BACK TO SOURCE UNLESS OTHERWISE INDICATED.
- DISCONNECT AND REMOVE EQUIPMENT AND ASSOCIATED HARDWARE AND LABELING IN ITS ENTIRETY AS INDICATED ON THE PLANS. PATCH AND, OR PAINT ANY EXISTING HOLES OR OUTLINES LEFT FROM DEMOLISHED EQUIPMENT AS NECESSARY TO MINIMIZE INDICATIONS OF PREVIOUS EQUIPMENT LOCATIONS.
- ALL DEMOLISHED EQUIPMENT AND MATERIAL NOT BEING SALVAGED BY THE OWNER SHALL BECOME PROPERTY OF THE CONTRACTOR FOR PROPER REMOVAL AND DISPOSAL.
- CONTRACTOR SHALL COORDINATE WITH THE OWNER TO DETERMINE IF ANY EQUIPMENT OR MATERIALS ARE TO BE SALVAGED TO THE OWNER. CONTRACTOR SHALL PROVIDE PROPER PROTECTION, STORAGE AND TRANSPORTATION OF SALVAGED EQUIPMENT TO AN OWNER DESIGNATED DROP OFF LOCATION.
- USE IF APPROPRIATE: ELECTRICAL DEMOLITION INCLUDES THE REMOVAL OF ANY ELECTRICAL EQUIPMENT CONCRETE PADS AND/OR EQUIPMENT FOUNDATIONS UNLESS OTHERWISE INDICATED.
- REFER TO DEMOLITION SPECIFICATIONS FOR ADDITIONAL REQUIREMENTS NOT INDICATED ON THIS DRAWING.
- COORDINATE WORK WITH THE UTILITY COMPANY. REFER TO DEMOLITION SPECIFICATIONS FOR ADDITIONAL REQUIREMENTS.
- REMOVE ELECTRICAL, INSTRUMENTATION, AND CONTROL DEVICES, EQUIPMENT, EXPOSED CONDUITS, CONDUCTORS, AND THEIR ASSOCIATED APPURTENANCES. VERIFY WITH OWNER PRIOR TO DISCONNECTION AND REMOVAL OF THE ITEMS. RETAIN AND DELIVER THE ITEMS THAT THE OWNER WISHED TO KEEP. DISPOSE OF THE REMAINDER. REFER TO DEMOLITION SPECIFICATIONS FOR ADDITIONAL REQUIREMENTS.

FACILITY DRAWINGS  
This drawing was supplied by a Consultant Engineer from a past construction project. The original contractor to provide the Record Drawing, the City does not warrant the accuracy and complete and accurate portrayal of facilities as they exist in the field.

REVISION	DWG NUMBER	CAD FILE NAME	DATE	PROJECT NO.	PROJECT NAME	REFERENCE	CID NUMBER

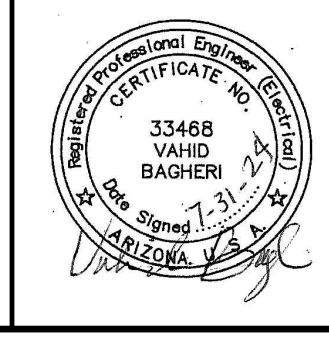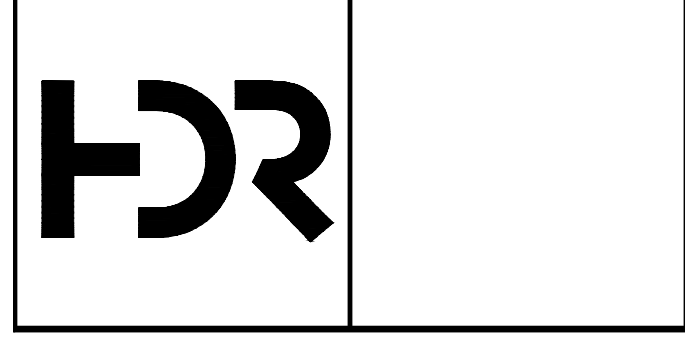

REVISIONS				
NO.	BY	DATE	CKD	REMARKS

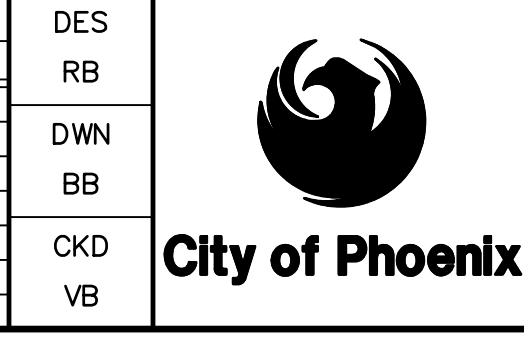

CITY OF PHOENIX  
WATER SERVICES DEPARTMENT  
  
LIFT STATION 40  
REFURBISHMENT


ELECTRICAL  
  
DEMO SITE PLAN DETAILS 2

COPYRIGHT © 2007-JANUARY  
CITY PROJECT NO. WS90400085  
DATE: 08/2024  
E-08 SHEET 99 OF 134  
CAD FILE: CEELS40EM03.dwg


THIS DRAWING MUST BE FIELD VERIFIED BEFORE USE  
DRAWING NOT TO SCALE UNLESS SCALE BAR IS PRESENT

FOR CONSTRUCTION

"PER CITY OF PHOENIX CODE CHAPTER 2, SECTION 2-28, THESE PLANS ARE FOR OFFICIAL USE ONLY AND MAY NOT BE SHARED WITH OTHERS EXCEPT AS REQUIRED TO FULFILL THE OBLIGATIONS OF THE CONTRACTOR'S CONTRACT WITH THE CITY OF PHOENIX."  
THIS DOCUMENT MUST BE KEPT SECURE AT ALL TIMES.

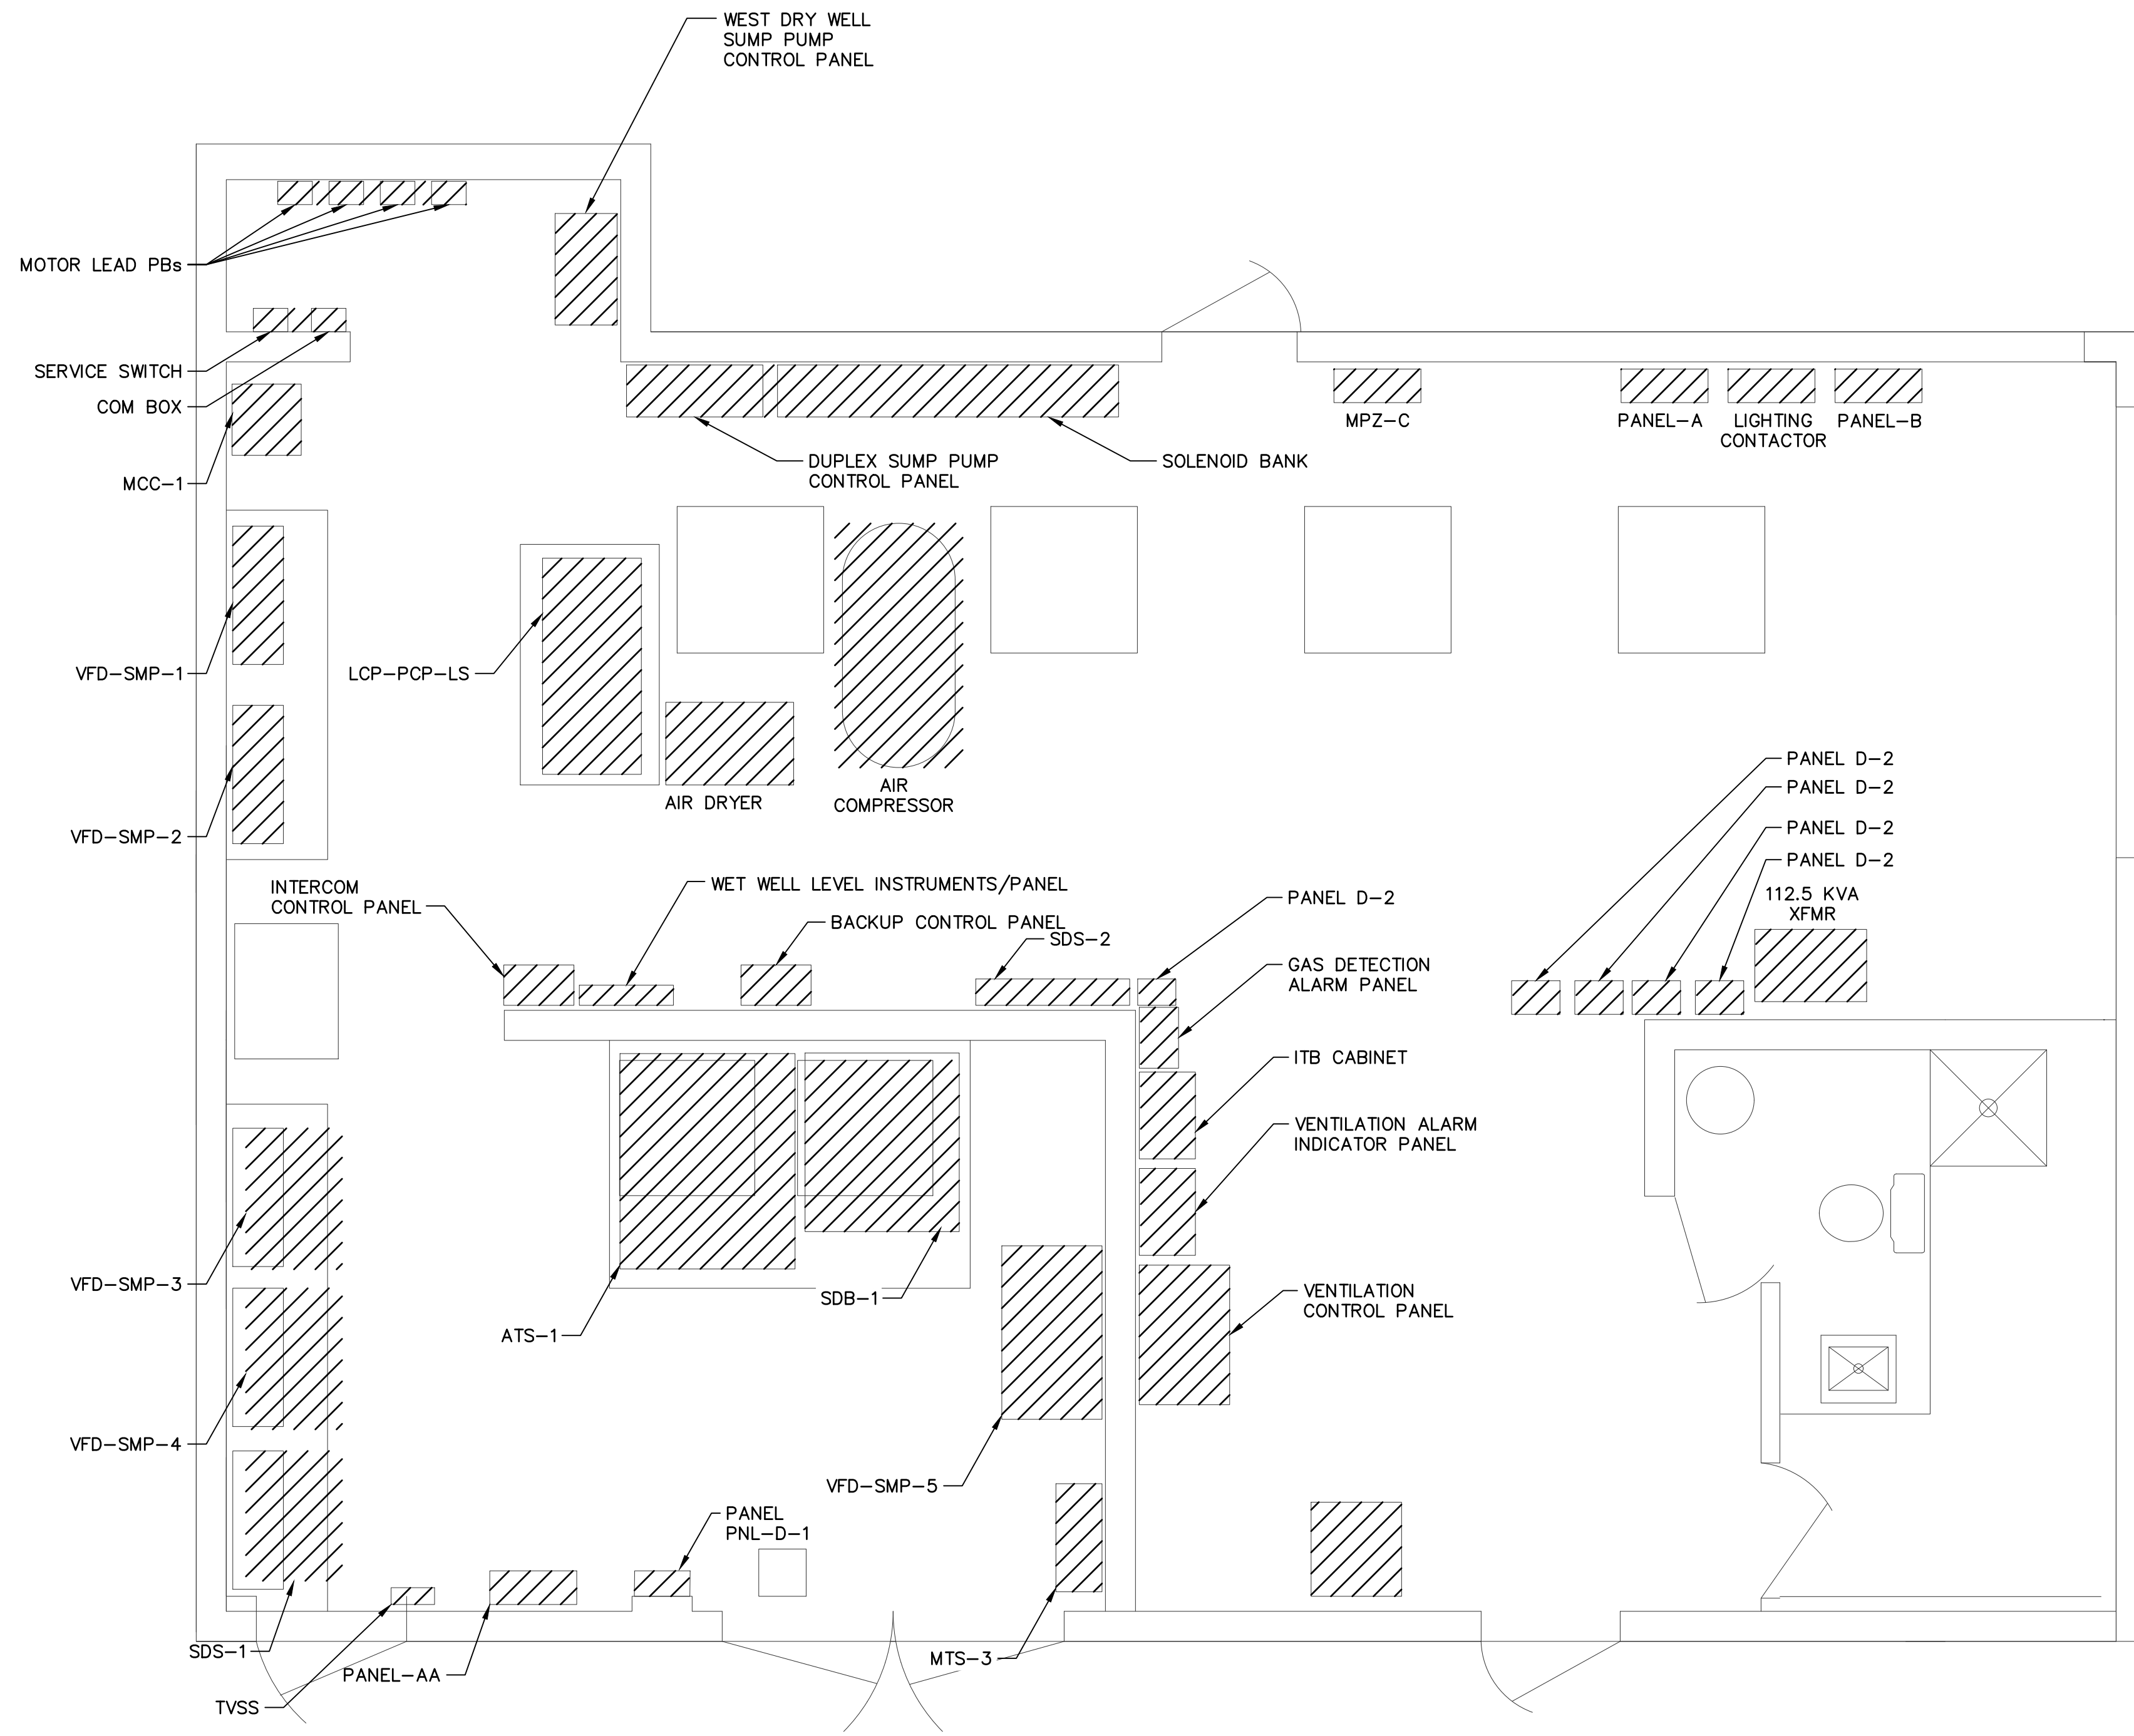

DETAIL D110 ELECTRICAL BUILDING INTERIOR DEMO DETAILS  
SCALE = NONE


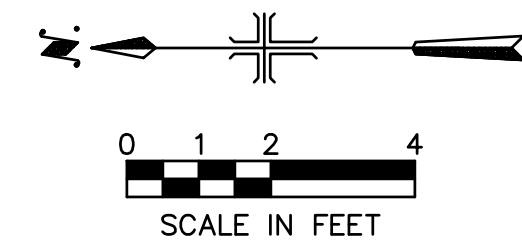


**GENERAL NOTES:**


1. PRIOR TO THE BID, THE CONTRACTOR SHALL VISIT THE PROJECT SITE AND INVESTIGATE THE DETAILS OF WORK ASSOCIATED WITH THIS PROJECT. NOT ALL DETAILS ARE INCLUDED IN THE BID DOCUMENTS. A SITE VISIT INVESTIGATION PRIOR TO THE BID IS REQUIRED.
2. THIS DRAWING DOES NOT INDICATE ALL DEMOLITION REQUIREMENTS FOR THIS PROJECT. THE EXISTING PROJECT CONDITIONS (STRUCTURES, POLES, EQUIPMENT, UNDERGROUND AND ABOVEGROUND PIPES AND CONDUITS, AND ETC.) ARE INDICATED ON NON-ELECTRICAL DRAWINGS INCLUDING BUT NOT LIMITED TO CIVIL AND MECHANICAL DRAWINGS. REFER TO NON-ELECTRICAL DRAWINGS FOR ADDITIONAL INFORMATION NOT INDICATED ON THIS DRAWING. ALL CONTRACT DOCUMENTS MUST BE CAREFULLY INSPECTED AND GATHERED TOGETHER IN ORDER TO INCLUDE THE COLLECTIVE REQUIREMENTS FOR THIS PROJECT.
3. FOR CIRCUITS BEING DEMOLISHED, REMOVE ASSOCIATED CONDUCTORS, REMOVE ASSOCIATED ABOVEGROUND CONDUITS (INCLUDING FITTINGS AND SUPPORTS), AND ABANDON BELOW GRADE CONDUITS IN PLACE. CUT CONDUIT STUB-UPS FLUSH WITH CONCRETE PAD OR 12" BELOW GRADE AND ABANDON REMAINING UNDERGROUND CONDUIT IN PLACE. DEMOLISHED CONDUCTORS SHALL ALWAYS BE DISCONNECTED AND REMOVED BACK TO SOURCE UNLESS OTHERWISE INDICATED.
4. DISCONNECT AND REMOVE EQUIPMENT AND ASSOCIATED HARDWARE AND LABELING IN ITS ENTIRETY AS INDICATED ON THE PLANS. PATCH AND, OR PAINT ANY EXISTING HOLES OR OUTLINES LEFT FROM DEMOLISHED EQUIPMENT AS NECESSARY TO MINIMIZE INDICATIONS OF PREVIOUS EQUIPMENT LOCATIONS.
5. ALL DEMOLISHED EQUIPMENT AND MATERIAL NOT BEING SALVAGED BY THE OWNER SHALL BECOME PROPERTY OF THE CONTRACTOR FOR PROPER REMOVAL AND DISPOSAL.
6. CONTRACTOR SHALL COORDINATE WITH THE OWNER TO DETERMINE IF ANY EQUIPMENT OR MATERIALS ARE TO BE SALVAGED TO THE OWNER. CONTRACTOR SHALL PROVIDE PROPER PROTECTION, STORAGE AND TRANSPORTATION OF SALVAGED EQUIPMENT TO AN OWNER DESIGNATED DROP OFF LOCATION.
7. USE IF APPROPRIATE: ELECTRICAL DEMOLITION INCLUDES THE REMOVAL OF ANY ELECTRICAL EQUIPMENT CONCRETE PADS AND/OR EQUIPMENT FOUNDATIONS UNLESS OTHERWISE INDICATED.
8. REFER TO DEMOLITION SPECIFICATIONS FOR ADDITIONAL REQUIREMENTS NOT INDICATED ON THIS DRAWING.
9. COORDINATE WORK WITH THE UTILITY COMPANY. REFER TO DEMOLITION SPECIFICATIONS FOR ADDITIONAL REQUIREMENTS.
10. REMOVE LIGHTING, ELECTRICAL, INSTRUMENTATION, AND CONTROL DEVICES, EQUIPMENT, EXPOSED CONDUITS, CONDUCTORS, AND THEIR ASSOCIATED APPURTENANCES. VERIFY WITH OWNER PRIOR TO DISCONNECTION AND REMOVAL OF THE ITEMS. RETAIN AND DELIVER THE ITEMS THAT THE OWNER WISHED TO KEEP. DISPOSE OF THE REMAINDER. REFER TO DEMOLITION SPECIFICATIONS FOR ADDITIONAL REQUIREMENTS.

FACILITY DRAWINGS  
This drawing was supplied by a Consultant Engineer from a past construction project. The original construction drawing was modified based on information provided by the Contractor to provide the Record Drawing. The City does not warrant the accuracy and reliability of the information and accuracy of the facilities as they exist in the field.

REVISION	DATE	CAD FILE NAME	DWG NUMBER	REMARKS

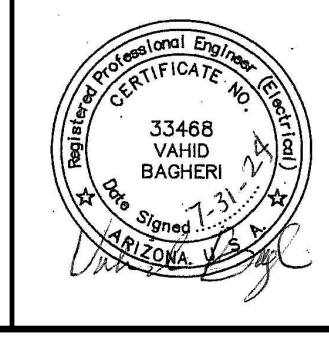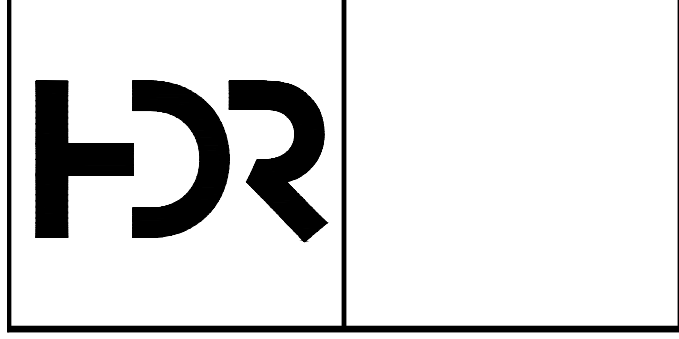

REVISIONS				
NO.	BY	DATE	CKD	REMARKS

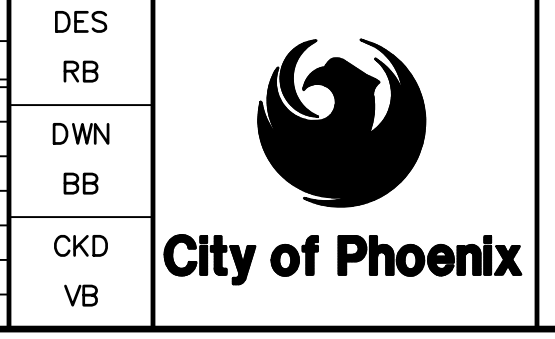

CITY OF PHOENIX  
WATER SERVICES DEPARTMENT  
  
LIFT STATION 40  
REFURBISHMENT

ELECTRICAL  
  
DEMO SITE PLAN DETAILS 3

COPYRIGHT © 2007-JANUARY  
CITY PROJECT NO. WS90400085  
DATE: 08/2024  
E-09 SHEET 100 OF 134  
CAD FILE: CSELS40EM03.dwg

THIS DRAWING MUST BE FIELD VERIFIED BEFORE USE  
DRAWING NOT TO SCALE UNLESS SCALE BAR IS PRESENT


FOR CONSTRUCTION

\*PER CITY OF PHOENIX CODE CHAPTER 2, SECTION 2-28, THESE PLANS ARE FOR OFFICIAL USE ONLY AND MAY NOT BE SHARED WITH OTHERS EXCEPT AS REQUIRED TO FULFILL THE OBLIGATIONS OF THE CONTRACTOR'S CONTRACT WITH THE CITY OF PHOENIX.  
THIS DOCUMENT MUST BE KEPT SECURE AT ALL TIMES.


DEMO ALL OUTLETS, WIRE, AND CONDUITS.



DEMO OVERHEAD CRANE, SENSORS, AND ALL INSTRUMENTATION, WIRE, AND CONDUITS.

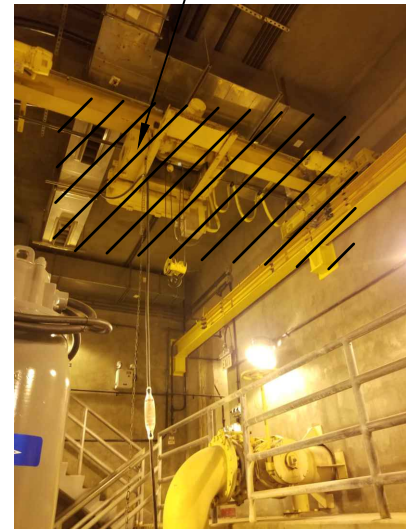

DEMO ALL LIGHTING, GAS SENSORS, JB's, AND PB's, WIRE, AND CONDUITS.

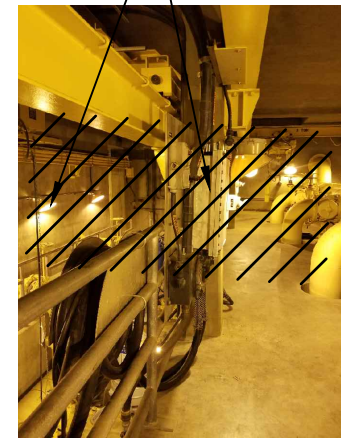

DEMO PUMP MOTOR/SENSORS, SWITCHES, AND COMMON DISCHARGE HEADER INSTRUMENTATION, JB's, AND PB's, WIRE, AND CONDUITS. (TYPICAL ALL PUMPS)



DETAIL D113 **PUMP STATION LOWER LEVEL DEMO DETAILS**

# #

SCALE = NONE

**GENERAL NOTES:**

1. PRIOR TO THE BID, THE CONTRACTOR SHALL VISIT THE PROJECT SITE AND INVESTIGATE THE DETAILS OF WORK ASSOCIATED WITH THIS PROJECT. NOT ALL DETAILS ARE INCLUDED IN THE BID DOCUMENTS. A SITE VISIT INVESTIGATION PRIOR TO THE BID IS REQUIRED.
2. THIS DRAWING DOES NOT INDICATE ALL DEMOLITION REQUIREMENTS FOR THIS PROJECT. THE EXISTING PROJECT CONDITIONS (STRUCTURES, POLES, EQUIPMENT, UNDERGROUND AND ABOVEGROUND PIPES AND CONDUITS, AND ETC...) ARE INDICATED ON NON-ELECTRICAL DRAWINGS INCLUDING BUT NOT LIMITED TO CIVIL AND MECHANICAL DRAWINGS. REFER TO NON-ELECTRICAL DRAWINGS FOR ADDITIONAL INFORMATION NOT INDICATED ON THIS DRAWING. ALL CONTRACT DOCUMENTS MUST BE CAREFULLY INSPECTED AND GATHERED TOGETHER IN ORDER TO INCLUDE THE COLLECTIVE REQUIREMENTS FOR THIS PROJECT.
3. FOR CIRCUITS BEING DEMOLISHED, REMOVE ASSOCIATED CONDUCTORS, REMOVE ASSOCIATED ABOVEGROUND CONDUITS (INCLUDING FITTINGS AND SUPPORTS), AND ABANDON BELOW GRADE CONDUITS IN PLACE. CUT CONDUIT STUB-UPS FLUSH WITH CONCRETE PAD OR 12" BELOW GRADE AND ABANDON REMAINING UNDERGROUND CONDUIT IN PLACE. DEMOLISHED CONDUCTORS SHALL ALWAYS BE DISCONNECTED AND REMOVED BACK TO SOURCE UNLESS OTHERWISE INDICATED.
4. DISCONNECT AND REMOVE EQUIPMENT AND ASSOCIATED HARDWARE AND LABELING IN ITS ENTIRETY AS INDICATED ON THE PLANS. PATCH AND, OR PAINT ANY EXISTING HOLES OR OUTLINES LEFT FROM DEMOLISHED EQUIPMENT AS NECESSARY TO MINIMIZE INDICATIONS OF PREVIOUS EQUIPMENT LOCATIONS.
5. ALL DEMOLISHED EQUIPMENT AND MATERIAL NOT BEING SALVAGED BY THE OWNER SHALL BECOME PROPERTY OF THE CONTRACTOR FOR PROPER REMOVAL AND DISPOSAL.
6. CONTRACTOR SHALL COORDINATE WITH THE OWNER TO DETERMINE IF ANY EQUIPMENT OR MATERIALS ARE TO BE SALVAGED TO THE OWNER. CONTRACTOR SHALL PROVIDE PROPER PROTECTION, STORAGE AND TRANSPORTATION OF SALVAGED EQUIPMENT TO AN OWNER DESIGNATED DROP OFF LOCATION.
7. USE IF APPROPRIATE: ELECTRICAL DEMOLITION INCLUDES THE REMOVAL OF ANY ELECTRICAL EQUIPMENT CONCRETE PADS AND/OR EQUIPMENT FOUNDATIONS UNLESS OTHERWISE INDICATED.
8. REFER TO DEMOLITION SPECIFICATIONS FOR ADDITIONAL REQUIREMENTS NOT INDICATED ON THIS DRAWING.
9. COORDINATE WORK WITH THE UTILITY COMPANY. REFER TO DEMOLITION SPECIFICATIONS FOR ADDITIONAL REQUIREMENTS.
10. REMOVE LIGHTING, ELECTRICAL, INSTRUMENTATION, AND CONTROL DEVICES, EQUIPMENT, EXPOSED CONDUITS, CONDUCTORS, AND THEIR ASSOCIATED APPURTENANCES. VERIFY WITH OWNER PRIOR TO DISCONNECTION AND REMOVAL OF THE ITEMS. RETAIN AND DELIVER THE ITEMS THAT THE OWNER WISHED TO KEEP. DISPOSE OF THE REMAINDER. REFER TO DEMOLITION SPECIFICATIONS FOR ADDITIONAL REQUIREMENTS.

**KEY NOTES:**



FACILITY DRAWINGS  
This drawing was supplied by a Consultant Engineer from a past construction project. The original construction drawing was modified based on information provided by the Contractor to provide the Record Drawing. The City does not warrant the accuracy and reliability of the information and accuracy of the drawings as they exist in the field.


REVISION	DWG NUMBER	CAD FILE NAME	DATE	PROJECT NO.	PROJECT NAME	REFERENCE	CID NUMBER	#

			REVISIONS					DES RB DWN BB CKD VB		CITY OF PHOENIX WATER SERVICES DEPARTMENT	ELECTRICAL	COPYRIGHT © 2007-JANUARY
			NO.	BY	DATE	CKD	REMARKS					
									LIFT STATION 40 REFURBISHMENT	DEMO SITE PLAN DETAILS 4	DATE: 08/2024	
											E-10 SHEET 101 OF 134	
											CAD FILE: CSELS40EM04.dwg	

THIS DRAWING MUST BE FIELD VERIFIED BEFORE USE  
DRAWING NOT TO SCALE UNLESS SCALE BAR IS PRESENT


FOR CONSTRUCTION

"PER CITY OF PHOENIX CODE CHAPTER 2, SECTION 2-28, THESE PLANS ARE FOR OFFICIAL USE ONLY AND MAY NOT BE SHARED WITH OTHERS EXCEPT AS REQUIRED TO FULFILL THE OBLIGATIONS OF THE CONTRACTOR'S CONTRACT WITH THE CITY OF PHOENIX."  
THIS DOCUMENT MUST BE KEPT SECURE AT ALL TIMES.

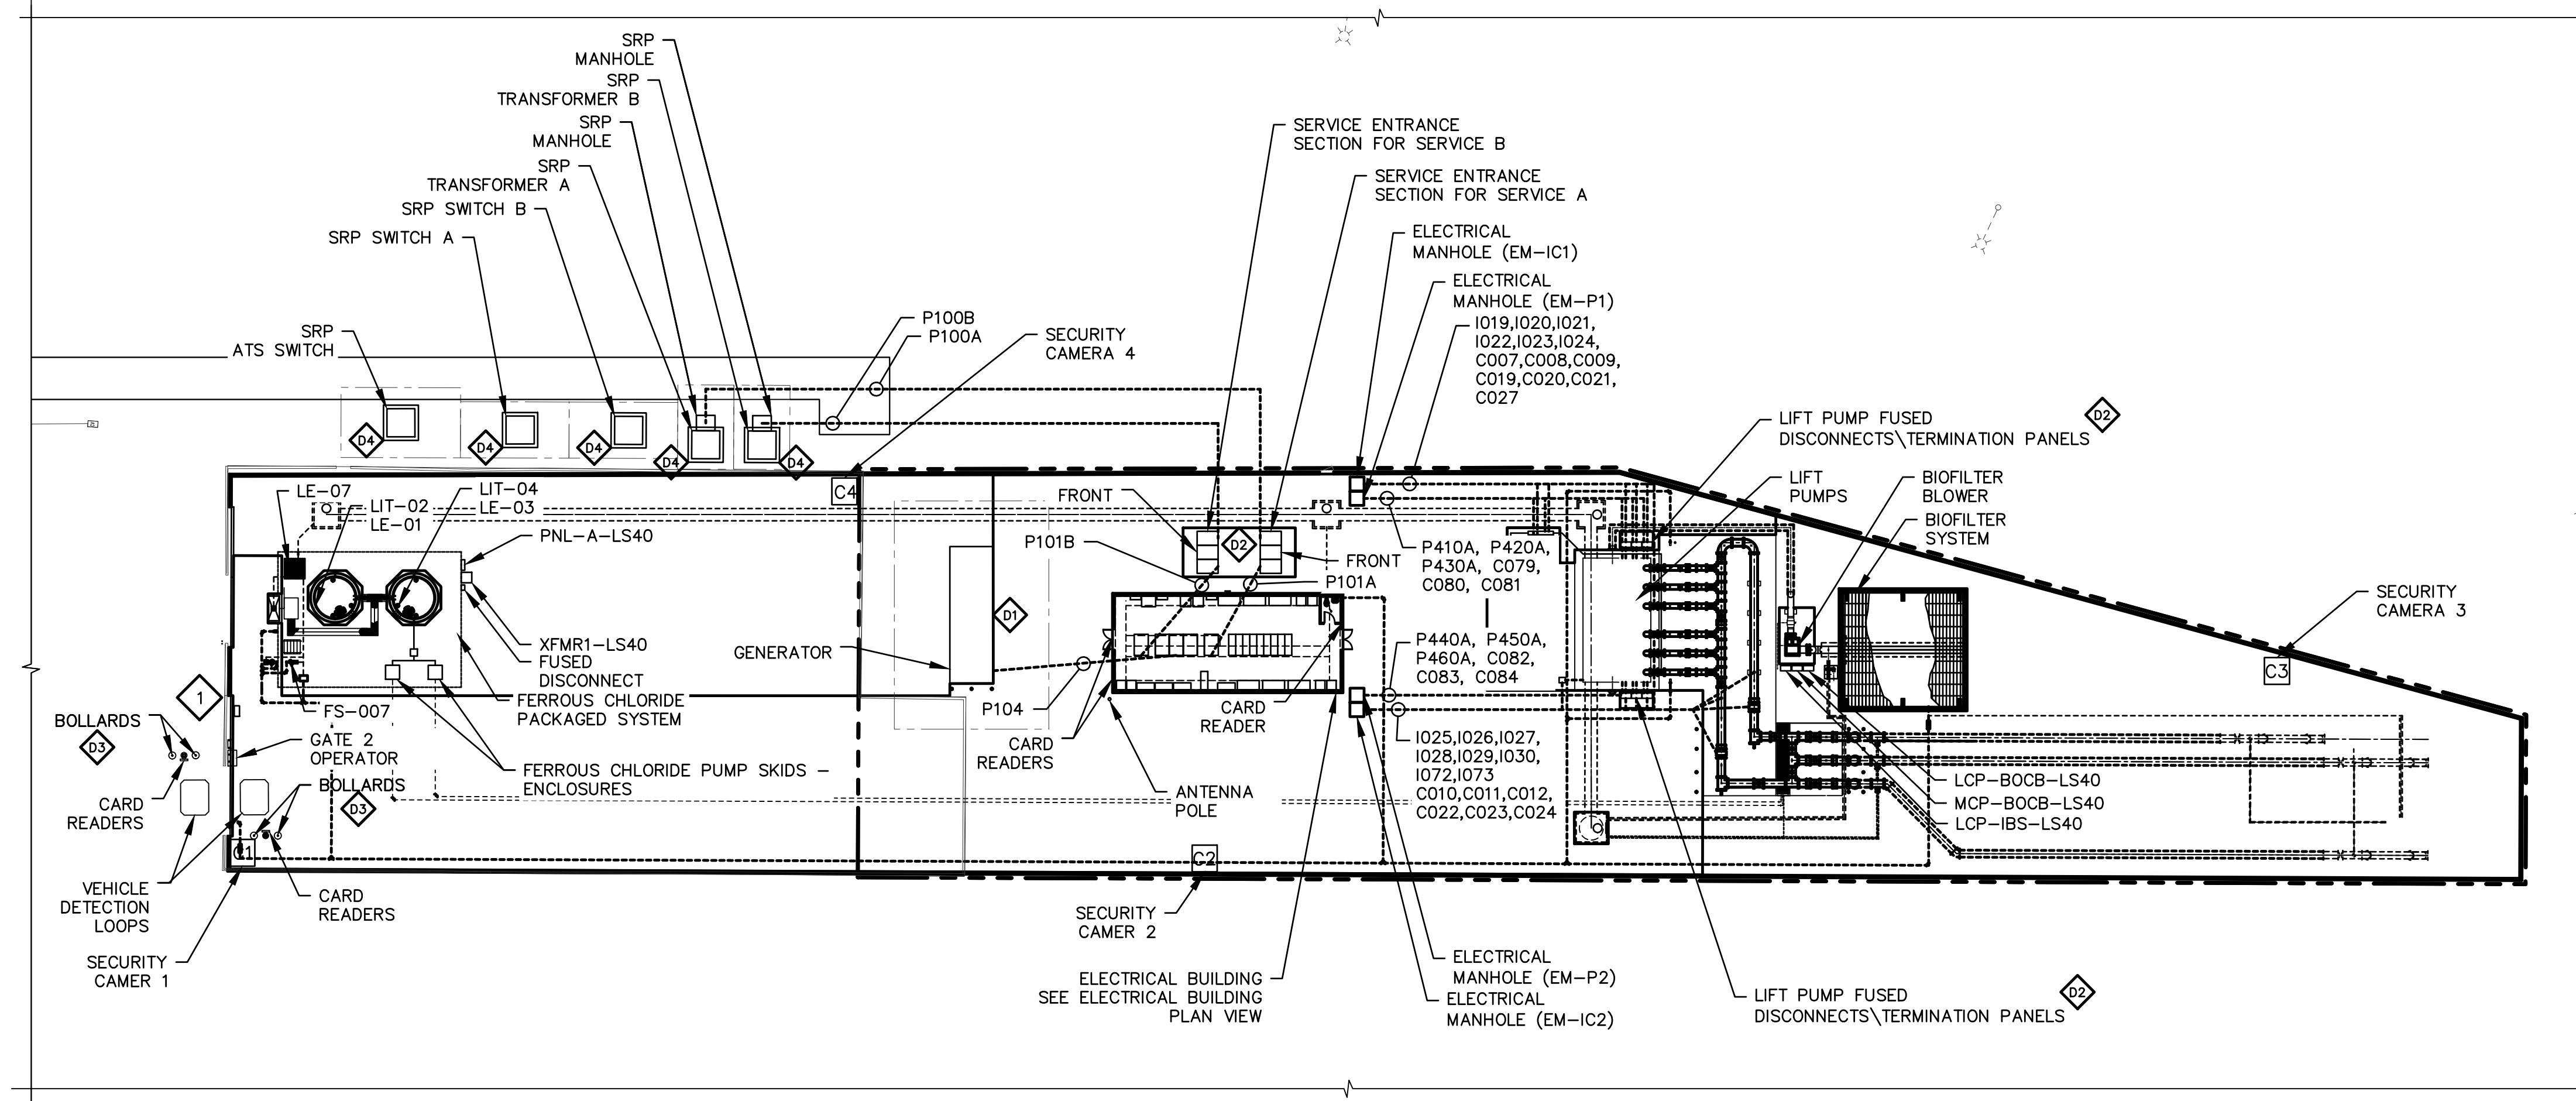

**GENERAL NOTES:**

1. PRIOR TO THE BID, THE CONTRACTOR SHALL VISIT THE PROJECT SITE AND INVESTIGATE THE DETAILS OF WORK ASSOCIATED WITH THIS PROJECT. NOT ALL DETAILS ARE INCLUDED IN THE BID DOCUMENTS. A SITE VISIT INVESTIGATION PRIOR TO THE BID IS REQUIRED.
2. THIS DRAWING DOES NOT INDICATE ALL THE PROJECT REQUIREMENTS. THE PROJECT REQUIREMENTS ARE INDICATED IN VARIOUS ELECTRICAL AND INSTRUMENTATION DRAWINGS AND SPECIFICATIONS. ALL DOCUMENTS MUST BE CAREFULLY INSPECTED AND GATHERED TOGETHER IN ORDER TO INCLUDE THE COLLECTIVE REQUIREMENTS FOR THIS PROJECT.
3. WHERE DISCREPANCIES EXIST AMONG VARIOUS DRAWINGS AND/OR SPECIFICATIONS, THE CONTRACTOR SHALL INCLUDE THE ITEM WITH THE MOST STRINGENT REQUIREMENT. FOR EXAMPLE, THE MOST LABORIOUS INSTALLATION, THE LARGER CONDUCTOR AND CONDUIT, THE HIGHER RATING DEVICE AND EQUIPMENT, THE FURTHER DISTANCE, ETC...
4. REFER TO NON-ELECTRICAL DRAWINGS FOR ADDITIONAL REQUIREMENTS THAT ARE NOT INDICATED ON THE ELECTRICAL DRAWINGS. THESE REQUIREMENTS MAY BE ELECTRICAL OR NON-ELECTRICAL WORK.
5. CIRCUITRY IS NOT SHOWN INTENTIONALLY. REFER TO OTHER DRAWINGS AND SPECIFICATIONS FOR COMPLETE CONDUIT AND CONDUCTOR REQUIREMENTS, INCLUDING BUT NOT LIMITED TO: SINGLE LINE DIAGRAMS, PANEL SCHEDULES, AND BLOCK DIAGRAMS
6. CONDUIT ROUTING IS NOT SHOWN INTENTIONALLY. CONDUIT ROUTING SHALL BE AS PERMITTED BY THE SPECIFICATIONS.
7. WHERE THE CONDUITS ARE INSTALLED UNDER EXISTING CONCRETE OR ASPHALT: SAW CUT AND REMOVE CONCRETE/ASPHALT; TRENCH, INSTALL CONDUITS, AND BACKFILL; AND INSTALL CONCRETE/ASPHALT AS REQUIRED TO MATCH EXISTING CONDITIONS.
8. EXISTING ITEMS ARE INDICATED AS EXISTING. ALL ITEMS ARE NEW UNLESS INDICATED EXISTING.

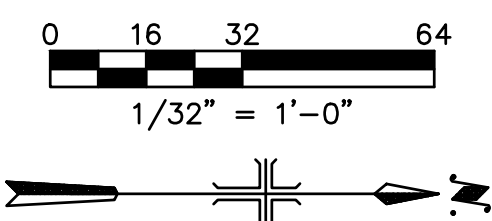

**CONCRETE PAD KEYED NOTES:**



- Ⓛ1 SEE DETAIL 1 ON SHEET S-12 FOR CONCRETE PAD DETAILS.
- Ⓛ2 SEE DETAIL 6 ON SHEET S-04 FOR CONCRETE PAD DETAILS.
- Ⓛ3 SEE MAG DETAILS.
- Ⓛ4 CONCRETE PAD PER SRP REQUIREMENTS.

**KEY NOTES:**


- Ⓛ1 FURNISH AND INSTALL AREA LIGHTING CONTACTOR PANEL WITH ON/OFF SELECTOR SWITCH, NEMA 4 RATED ENCLOSURE AND CONTROLS.

FACILITY DRAWINGS  
This drawing was supplied by a Consultant Engineer from a past construction project. The original construction drawing was modified based on information provided by the Contractor to provide the Record Drawing. The City does not warrant the accuracy and reliability of the information and portrayal of facilities as they exist in the field.

REVISION	DWG NUMBER	CAD FILE NAME	DATE	REMARKS

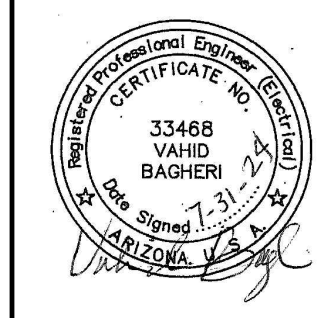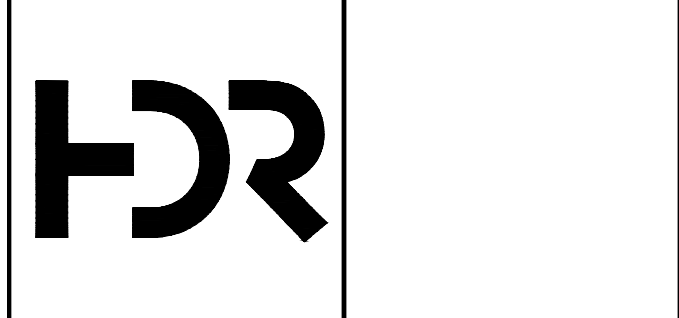

REVISIONS				
NO.	BY	DATE	CKD	REMARKS

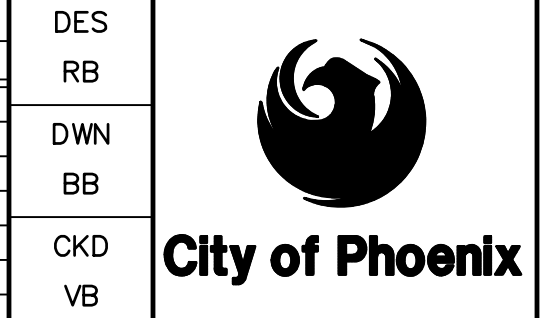

CITY OF PHOENIX  
WATER SERVICES DEPARTMENT  
  
LIFT STATION 40  
REFURBISHMENT




ELECTRICAL  
  
SITE PLAN POWER AND CONTROL

COPYRIGHT © 2007-JANUARY  
CITY PROJECT NO. WS90400085  
DATE: 08/2024  
E-11 SHEET 102 OF 134  
CAD FILE: CEELS40EP07.dwg

THIS DRAWING MUST BE FIELD VERIFIED BEFORE USE  
DRAWING NOT TO SCALE UNLESS SCALE BAR IS PRESENT

FOR CONSTRUCTION

PER CITY OF PHOENIX CODE CHAPTER 2, SECTION 2-28, THESE PLANS ARE FOR OFFICIAL USE ONLY AND MAY NOT BE SHARED WITH OTHERS EXCEPT AS REQUIRED TO FULFILL THE OBLIGATIONS OF THE CONTRACTOR'S CONTRACT WITH THE CITY OF PHOENIX. THIS DOCUMENT MUST BE KEPT SECURE AT ALL TIMES.

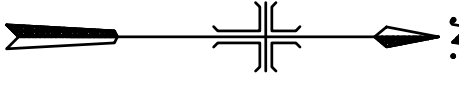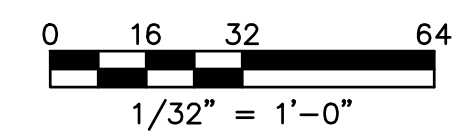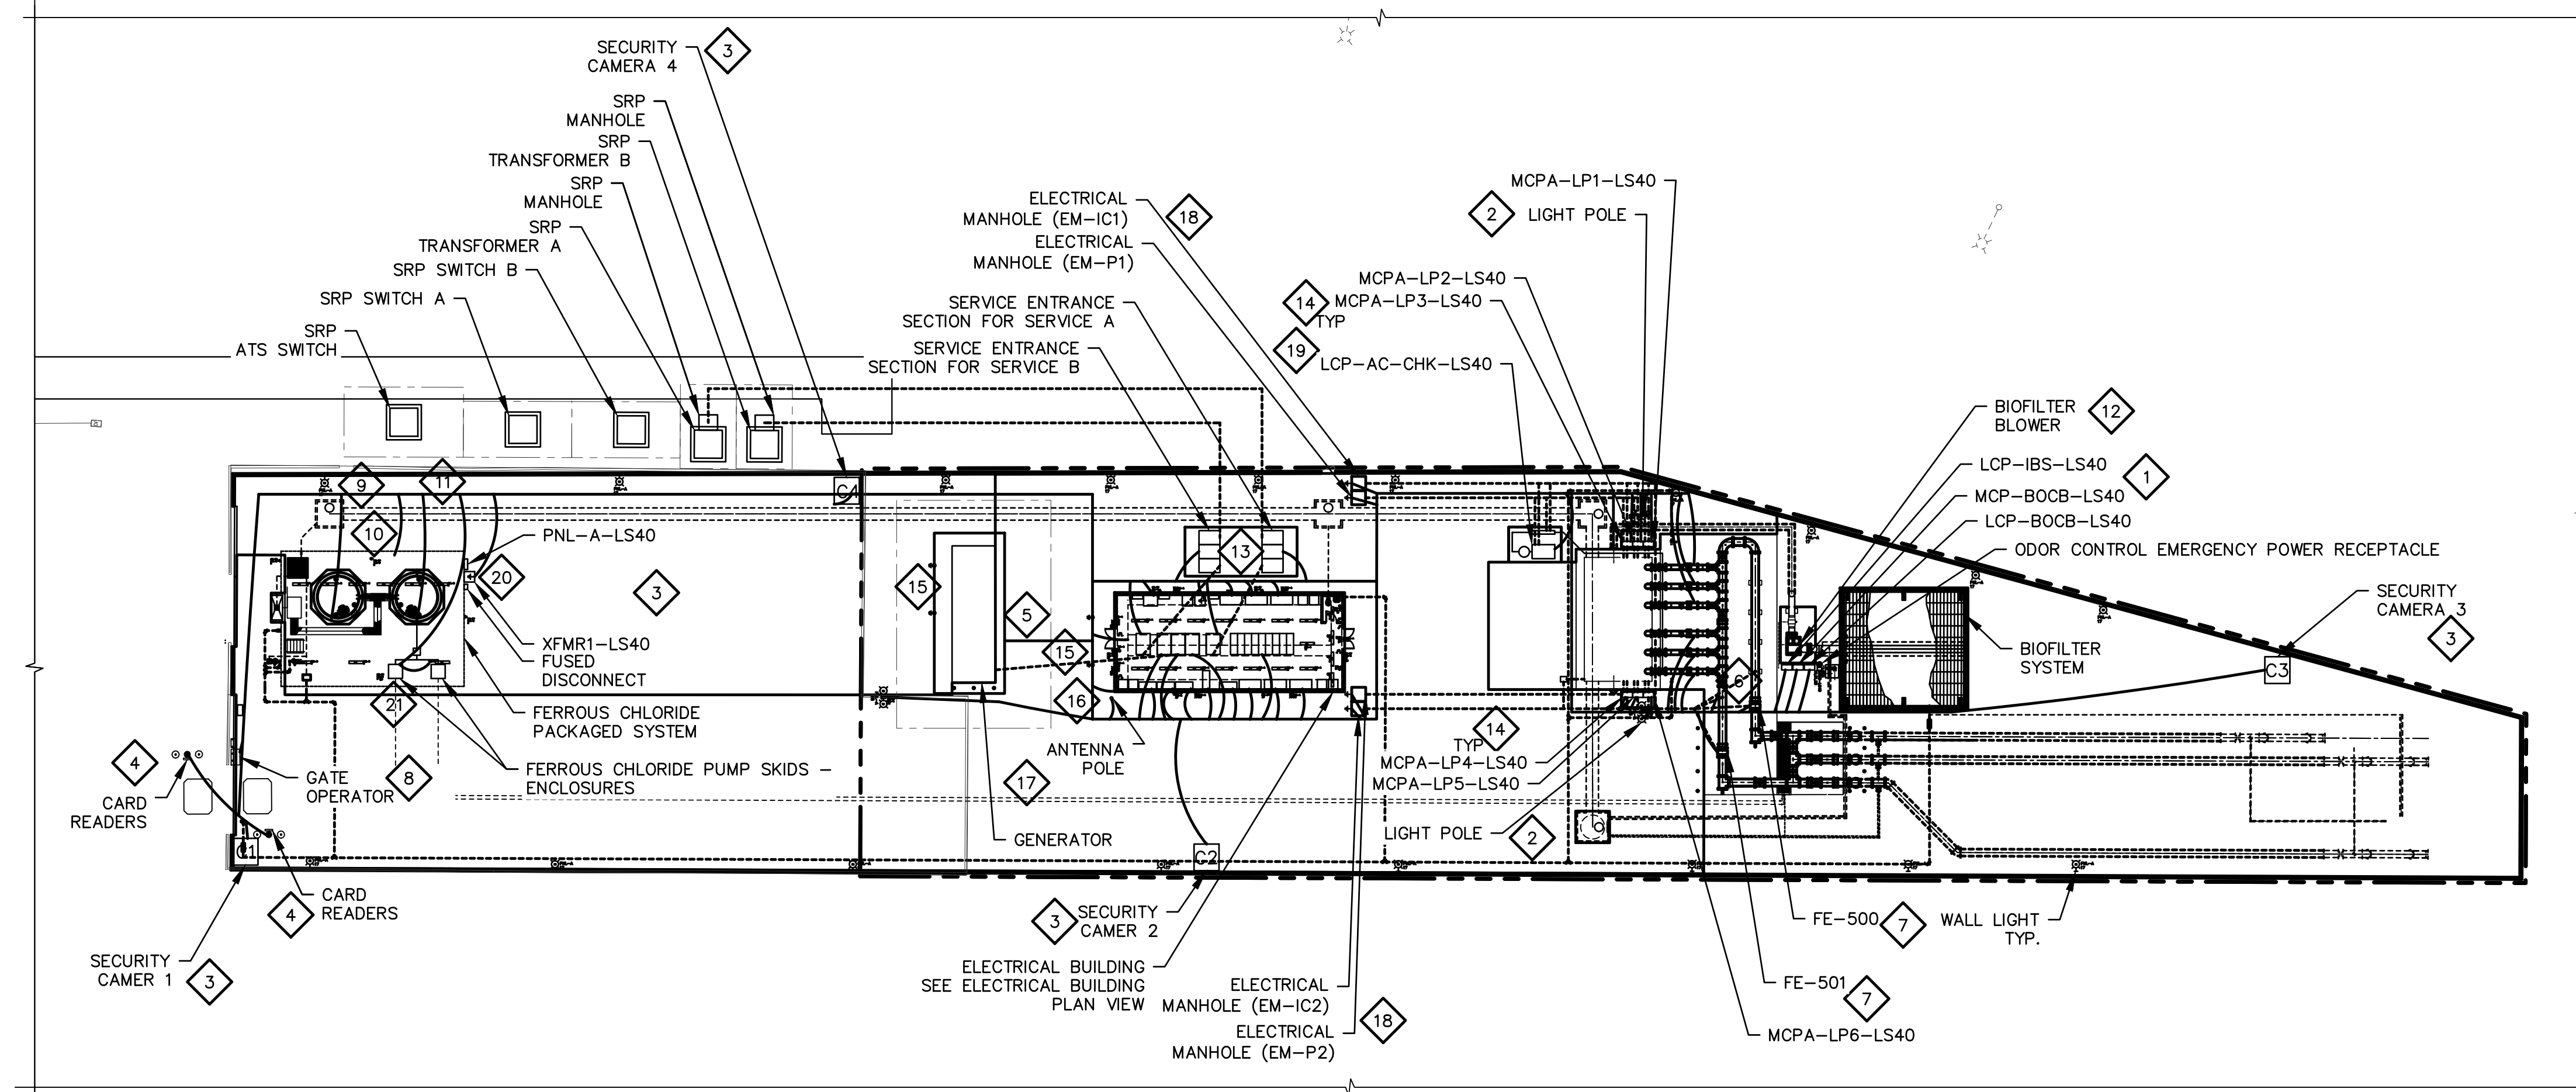




**GENERAL NOTES:**

1. THIS DRAWING DOES NOT INDICATE ALL THE PROJECT REQUIREMENTS. THE PROJECT REQUIREMENTS ARE INDICATED IN VARIOUS ELECTRICAL AND INSTRUMENTATION DRAWINGS AND SPECIFICATIONS. ALL DOCUMENTS MUST BE CAREFULLY INSPECTED AND GATHERED TOGETHER IN ORDER TO INCLUDE THE COLLECTIVE REQUIREMENTS FOR THIS PROJECT.
2. WHERE DISCREPANCIES EXIST AMONG VARIOUS DRAWINGS AND/OR SPECIFICATIONS, THE CONTRACTOR SHALL INCLUDE THE ITEM WITH THE MOST STRINGENT REQUIREMENT. FOR EXAMPLE, THE MOST LABORIOUS INSTALLATION, THE LARGER CONDUCTOR AND CONDUIT, THE HIGHER RATING DEVICE AND EQUIPMENT, THE FURTHER DISTANCE, ETC...
3. INSTALL RECEPTACLES AND DATA OUTLETS AT 18 INCHES ABOVE FINISHED FLOOR.
4. FURNISH AND INSTALL A 20-AMP, 120V, WEATHERPROOF, GFCI RECEPTACLE WITHIN 25 FEET OF ALL HVAC EQUIPMENT EVEN IF THEY ARE NOT INDICATED ON THE DRAWINGS.
5. INSTALL RECEPTACLES AT 18 INCHES ABOVE FINISHED FLOOR.
6. INSTALL LIGHT SWITCHES AT 42 INCHES ABOVE FINISHED FLOOR.
7. INSTALL WALL MOUNTED LIGHT FIXTURES AT 8 FEET ABOVE FINISHED FLOOR.
8. ALL OUTDOOR LIGHT FIXTURES SHALL BE EQUIPPED WITH FULL CUT-OFF SHIELDS EVEN IF IT IS NOT INDICATED ON THE LIGHT FIXTURE SCHEDULE OR ELSEWHERE ON THE DRAWINGS AND/OR SPECIFICATIONS.
9. INSTALL CEILING MOUNTED LIGHT FIXTURES AT 12 FEET ABOVE FINISHED FLOOR.
10. FURNISH AND INSTALL LIGHTING CONTROL PANEL FOR ALL OUTDOOR LIGHTS. THE CONTROL PANEL SHALL MEET OR EXCEED THE FOLLOWING REQUIREMENTS
  - a. BE EQUIPPED WITH A MAIN CIRCUIT BREAKER RATED 65AIC
  - b. BE EQUIPPED WITH A CONTACTOR RATED FOR 30 AMPS
  - c. HAVE A VOLTAGE RATING AS INDICATED BY ITS FEEDER
  - d. TURN LIGHTS ON AND OFF BY A PHOTOCELL REMOTELY LOCATED OUTSIDE THE BUILDING.
  - e. BE EQUIPPED WITH A TIMER THAT LIMITS THE HOURS OF OPERATION DURING PHOTOCELL OPERATION
  - f. HAVE OVERRIDE CAPABILITY TO TURN LIGHTS ON AND OFF REGARDLESS OF PHOTOCELL
  - g. BE EQUIPPED WITH A NEMA 12 ENCLOSURE
  - h. LOCATION OF THE LIGHTING CONTROL PANEL WILL BE DETERMINED DURING CONSTRUCTION. ALLOW FOR 30 FEET OF DISTANCE BETWEEN THE POWER SOURCE AND THE LIGHTING CONTROL PANEL
  - i. LOCATION OF THE PHOTOCELL WILL BE DETERMINED DURING CONSTRUCTION. ALLOW FOR 100 FEET OF DISTANCE BETWEEN THE LIGHTING CONTROL PANEL AND THE PHOTOCELL


**KEY NOTES:**

- 1 BOND THE GROUNDING ELECTRODE CONDUCTOR TO LCP-BOCB-LS40, TO MCP-BOCB-LS40, AND LCP-IBS-LS40.
- 2 BOND THE GROUNDING ELECTRODE CONDUCTOR TO THE LIGHT POLE.
- 3 BOND THE GROUNDING ELECTRODE CONDUCTOR TO THE SECURITY CAMERA POLE .
- 4 BOND THE GROUNDING ELECTRODE CONDUCTOR TO THE KEYPAD PEDESTALS.
- 5 BOND THE GENERATOR GROUNDING ELECTRODE TO THE BUILDING GROUNDING ELECTRODE.
- 6 BOND THE GROUNDING ELECTRODE CONDUCTOR TO ABOVE GROUND WATER PIPE.
- 7 BOND THE GROUNDING ELECTRODE CONDUCTOR TO THE MAGNETIC FLOW METERS.
- 8 BOND THE GROUNDING ELECTRODE CONDUCTOR TO THE GATE OPERATOR POWER SUPPLY.

- 9 BOND THE GROUNDING ELECTRODE CONDUCTOR TO THE SHADE STRUCTURE.
- 10 BOND THE GROUNDING ELECTRODE CONDUCTOR TO THE FERROUS CHLORIDE TANKS.
- 11 BOND THE GROUNDING ELECTRODE CONDUCTOR TO THE FERROUS CHLORIDE SYSTEM STRUCTURE.
- 12 BOND THE GROUNDING ELECTRODE CONDUCTOR TO THE BIOFILTER BLOWER.
- 13 BOND THE GROUNDING ELECTRODE CONDUCTOR TO THE SERVICE ENTRANCE SECTIONS.
- 14 BOND THE GROUNDING ELECTRODE CONDUCTOR TO THE LIFT PUMP MCP PANELS.
- 15 GROUND ROD AND GROUND TEST WELL PER TYPICAL DETAIL.
- 16 CONCRETE ENCASED GROUND (UFER) IN BLOCK WALL.
- 17 BOND THE GROUNDING ELECTRODE CONDUCTOR TO THE ANTENNA POLE.
- 18 BOND THE MANHOLE GROUNDING ELECTRODES TO THE BUILDING GROUNDING ELECTRODE.
- 19 BOND THE GROUNDING ELECTRODE TO THE COMPRESSOR.
- 20 BOND THE GROUNDING ELECTRODE CONDUCTOR TO THE SECONDARY SIDE OF THE TRANSFORMER AND GROUND ROD.
- 21 BOND THE GROUNDING ELECTRODE CONDUCTOR TO THE FERROUS CHLORIDE PUMP SKIDS.

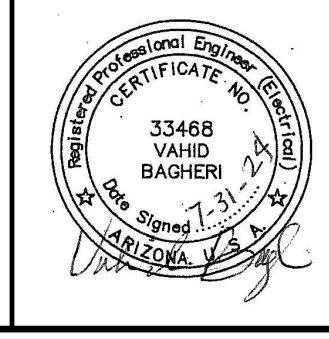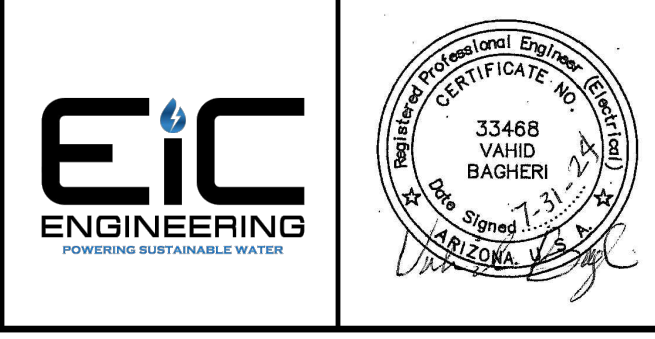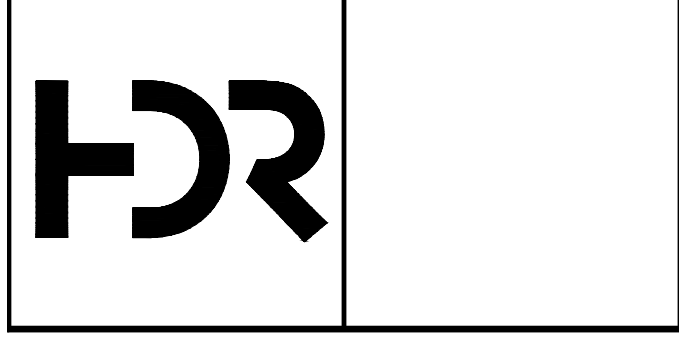

REVISIONS				
NO.	BY	DATE	CKD	REMARKS

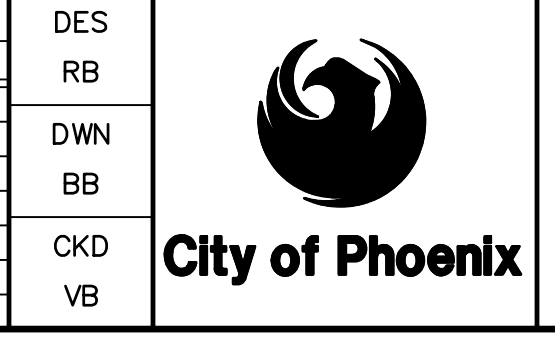

CITY OF PHOENIX  
WATER SERVICES DEPARTMENT  
  
LIFT STATION 40  
REFURBISHMENT

ELECTRICAL  
  
SITE PLAN LIGHTING AND GROUNDING

COPYRIGHT © 2007-JANUARY  
CITY PROJECT NO. WS90400085  
DATE: 08/2024  
E-12 SHEET 103 OF 134  
CAD FILE: CSELS40EP01.dwg


FACILITY DRAWINGS  
This drawing was supplied by a Consultant Engineer from a past construction project. The original contractor drawing was modified based on information provided by the Contractor to provide the Record Drawing. The City does not warrant the accuracy of the information and accurate portrayal of facilities as they exist in the field.

REVISION	ENGINEERING COMPANY	PROJECT NO.	PROJECT NAME	DATE	DWG NUMBER	REMARKS

THIS DRAWING MUST BE FIELD VERIFIED BEFORE USE  
DRAWING NOT TO SCALE UNLESS SCALE BAR IS PRESENT


FOR CONSTRUCTION

PER CITY OF PHOENIX CODE CHAPTER 2, SECTION 2-28, THESE PLANS ARE FOR OFFICIAL USE ONLY AND MAY NOT BE SHARED WITH OTHERS EXCEPT AS REQUIRED TO FULFILL THE OBLIGATIONS OF THE CONTRACTOR'S CONTRACT WITH THE CITY OF PHOENIX. THIS DOCUMENT MUST BE KEPT SECURE AT ALL TIMES.

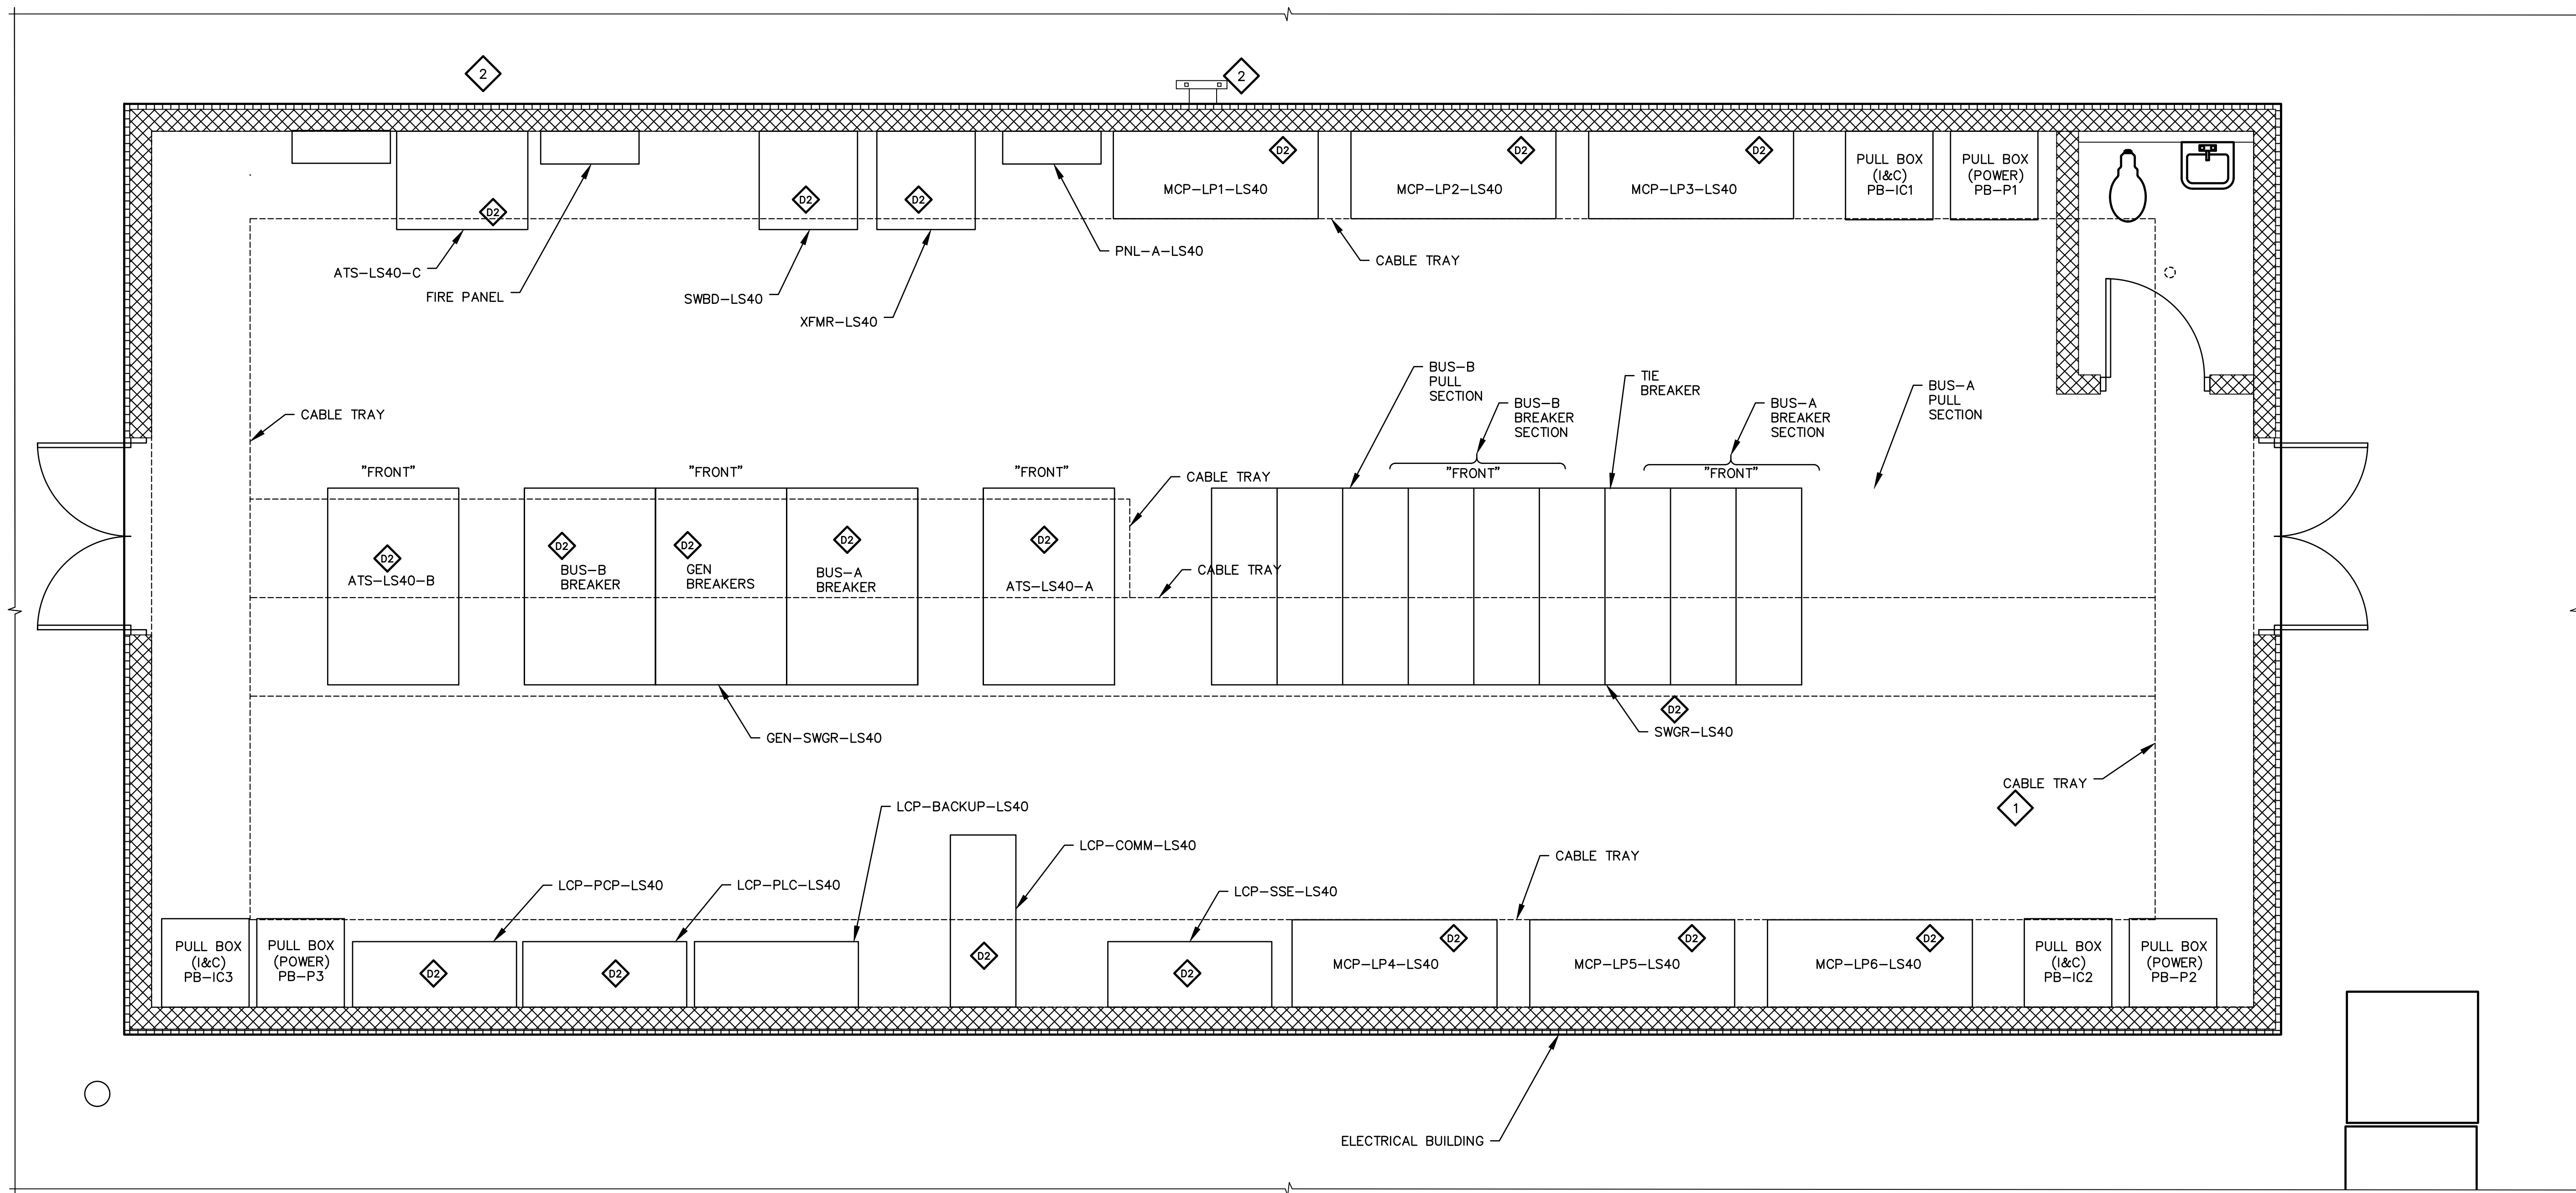

**GENERAL NOTES:**

- PRIOR TO THE BID, THE CONTRACTOR SHALL VISIT THE PROJECT SITE AND INVESTIGATE THE DETAILS OF WORK ASSOCIATED WITH THIS PROJECT. NOT ALL DETAILS ARE INCLUDED IN THE BID DOCUMENTS. A SITE VISIT INVESTIGATION PRIOR TO THE BID IS REQUIRED.
- THIS DRAWING DOES NOT INDICATE ALL THE PROJECT REQUIREMENTS. THE PROJECT REQUIREMENTS ARE INDICATED IN VARIOUS ELECTRICAL AND INSTRUMENTATION DRAWINGS AND SPECIFICATIONS. ALL DOCUMENTS MUST BE CAREFULLY INSPECTED AND GATHERED TOGETHER IN ORDER TO INCLUDE THE COLLECTIVE REQUIREMENTS FOR THIS PROJECT.
- WHERE DISCREPANCIES EXIST AMONG VARIOUS DRAWINGS AND/OR SPECIFICATIONS, THE CONTRACTOR SHALL INCLUDE THE ITEM WITH THE MOST STRINGENT REQUIREMENT. FOR EXAMPLE, THE MOST LABORIOUS INSTALLATION, THE LARGER CONDUCTOR AND CONDUIT, THE HIGHER RATING DEVICE AND EQUIPMENT, THE FURTHER DISTANCE, ETC...
- REFER TO NON-ELECTRICAL DRAWINGS FOR ADDITIONAL REQUIREMENTS THAT ARE NOT INDICATED ON THE ELECTRICAL DRAWINGS. THESE REQUIREMENTS MAY BE ELECTRICAL OR NON-ELECTRICAL WORK.
- CIRCUITRY IS NOT SHOWN INTENTIONALLY. REFER TO OTHER DRAWINGS AND SPECIFICATIONS FOR COMPLETE CONDUIT AND CONDUCTOR REQUIREMENTS, INCLUDING BUT NOT LIMITED TO: SINGLE LINE DIAGRAMS, PANEL SCHEDULES, AND BLOCK DIAGRAMS
- CONDUIT ROUTING IS NOT SHOWN INTENTIONALLY. CONDUIT ROUTING SHALL BE AS PERMITTED BY THE SPECIFICATIONS.
- WHERE THE CONDUITS ARE INSTALLED UNDER EXISTING CONCRETE OR ASPHALT: SAW CUT AND REMOVE CONCRETE/ASPHALT; TRENCH, INSTALL CONDUITS, AND BACKFILL; AND INSTALL CONCRETE/ASPHALT AS REQUIRED TO MATCH EXISTING CONDITIONS.
- EXISTING ITEMS ARE INDICATED AS EXISTING. ALL ITEMS ARE NEW UNLESS INDICATED EXISTING.

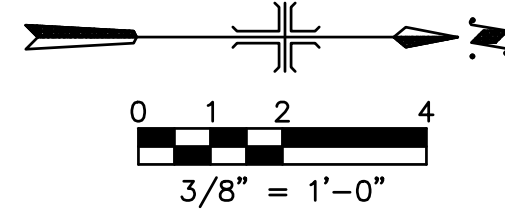

**KEY NOTES:**



- 1 CABLE TRAY SHOWN FOR REFERENCE ONLY. SEE SPECIFICATIONS FOR REQUIREMENTS.
- 2 FURNISH AND INSTALL GFI-WP DUPLEX OUTLET NEXT TO EACH A/C UNIT ON ROOF. (PNL-A CKT 19).

**CONCRETE PAD KEYED NOTES:**


- D1 SEE DETAIL 1 ON SHEET S-12 FOR CONCRETE PAD DETAILS.
- D2 SEE DETAIL 6 ON SHEET S-04 FOR CONCRETE PAD DETAILS.
- D3 SEE MAG DETAILS.

FACILITY DRAWINGS  
This drawing was supplied by a Consultant Engineer from a past construction project. The original constructor provided the Record Drawing on information provided by the Contractor to provide the Record Drawing. The City does not warrant the accuracy of the information and accurate portrayal of facilities as they exist in the field.

REVISION	ENGINEERING COMPANY	PROJECT NO.	PROJECT NAME	DATE	CAD FILE NAME	DWG NUMBER	REMARKS

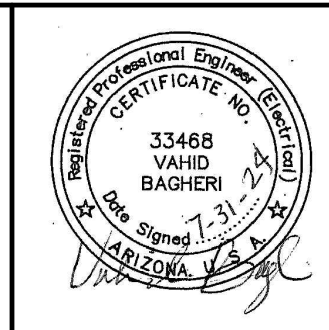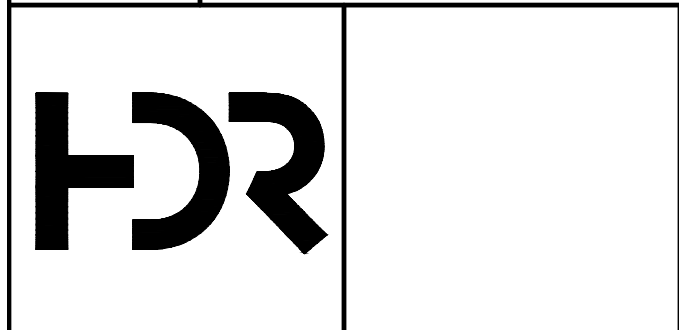

REVISIONS				
NO.	BY	DATE	CKD	REMARKS

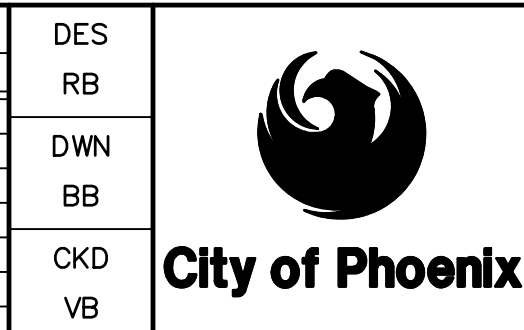

CITY OF PHOENIX  
WATER SERVICES DEPARTMENT  
  
LIFT STATION 40  
REFURBISHMENT

ELECTRICAL  
  
ELECTRICAL BUILDING POWER AND CONTROL

COPYRIGHT © 2007-JANUARY  
CITY PROJECT NO. WS90400085  
DATE: 08/2024  
E-13 SHEET 104 OF 134  
CAD FILE: CEELS40EP04.dwg






THIS DRAWING MUST BE FIELD VERIFIED BEFORE USE  
DRAWING NOT TO SCALE UNLESS SCALE BAR IS PRESENT

FOR CONSTRUCTION



"PER CITY OF PHOENIX CODE CHAPTER 2, SECTION 2-28, THESE PLANS ARE FOR OFFICIAL USE ONLY AND MAY NOT BE SHARED WITH OTHERS EXCEPT AS REQUIRED TO FULFILL THE OBLIGATIONS OF THE CONTRACTOR'S CONTRACT WITH THE CITY OF PHOENIX."  
THIS DOCUMENT MUST BE KEPT SECURE AT ALL TIMES.

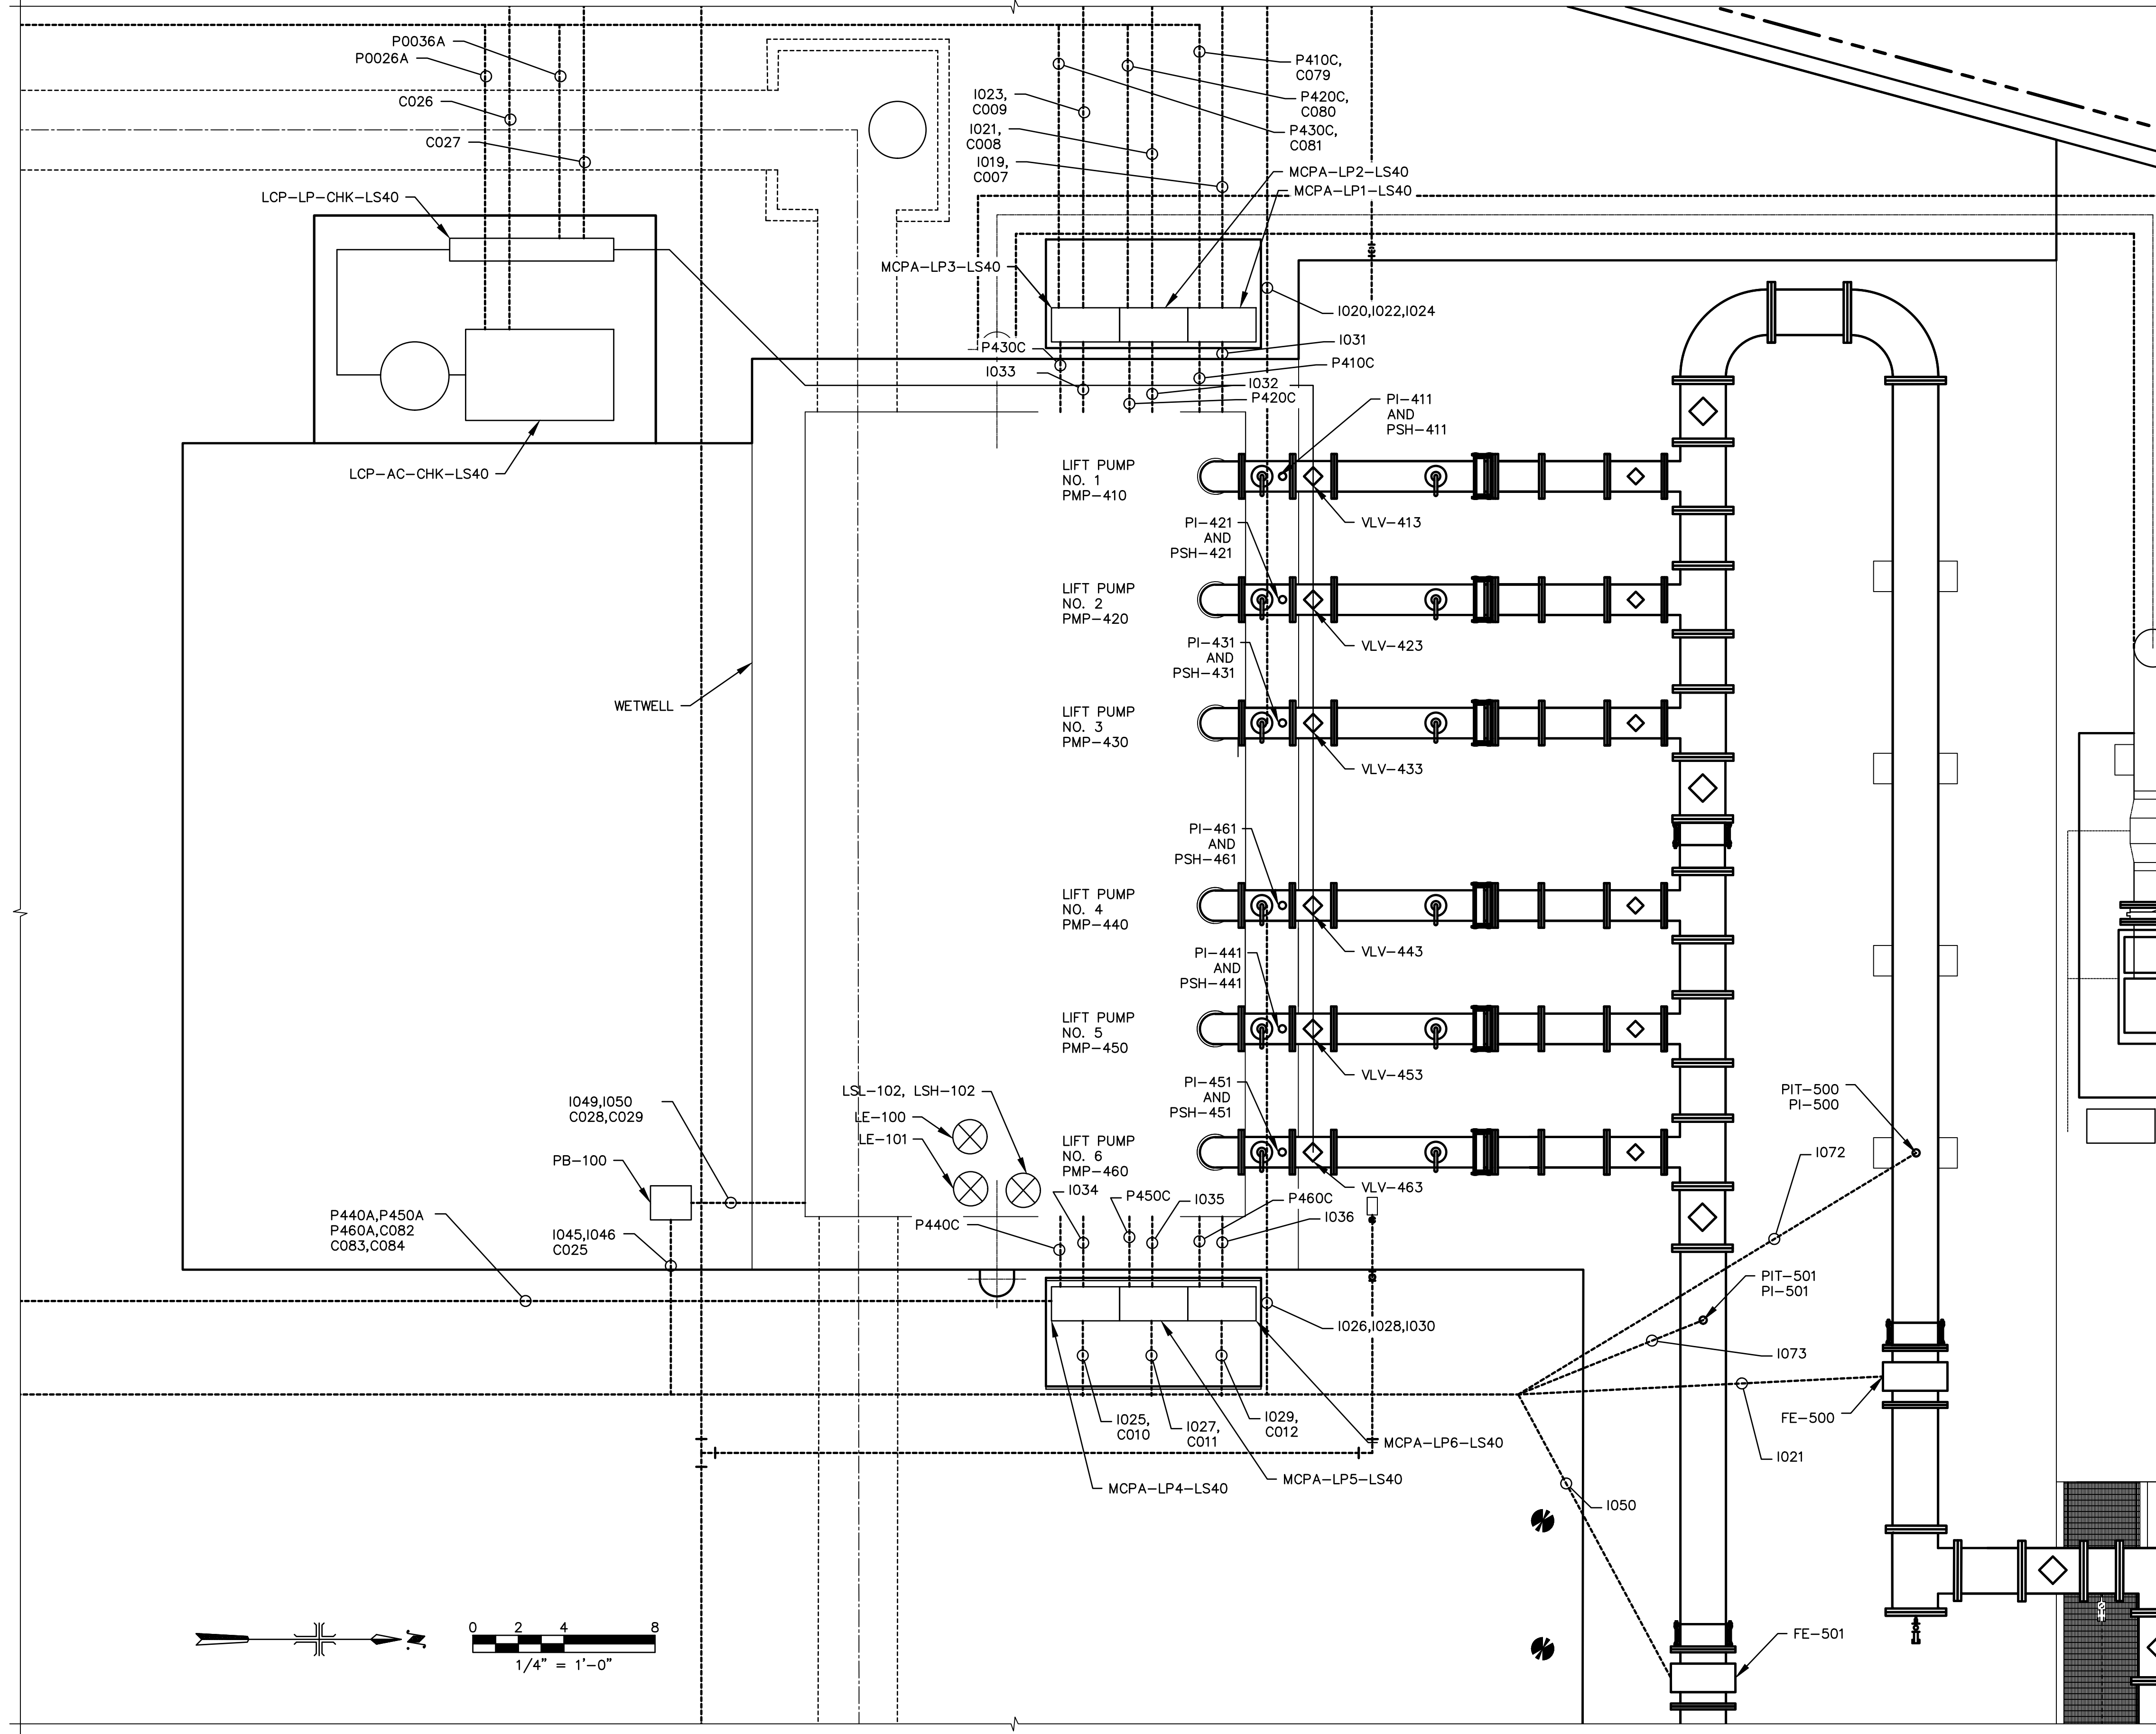


- GENERAL NOTES:**
1. PRIOR TO THE BID, THE CONTRACTOR SHALL VISIT THE PROJECT SITE AND INVESTIGATE THE DETAILS OF WORK ASSOCIATED WITH THIS PROJECT. NOT ALL DETAILS ARE INCLUDED IN THE BID DOCUMENTS. A SITE VISIT INVESTIGATION PRIOR TO THE BID IS REQUIRED.
  2. THIS DRAWING DOES NOT INDICATE ALL THE PROJECT REQUIREMENTS. THE PROJECT REQUIREMENTS ARE INDICATED IN VARIOUS ELECTRICAL AND INSTRUMENTATION DRAWINGS AND SPECIFICATIONS. ALL DOCUMENTS MUST BE CAREFULLY INSPECTED AND GATHERED TOGETHER IN ORDER TO INCLUDE THE COLLECTIVE REQUIREMENTS FOR THIS PROJECT.
  3. WHERE DISCREPANCIES EXIST AMONG VARIOUS DRAWINGS AND/OR SPECIFICATIONS, THE CONTRACTOR SHALL INCLUDE THE ITEM WITH THE MOST STRINGENT REQUIREMENT. FOR EXAMPLE, THE MOST LABORIOUS INSTALLATION, THE LARGER CONDUCTOR AND CONDUIT, THE HIGHER RATING DEVICE AND EQUIPMENT, THE FURTHER DISTANCE, ETC...
  4. REFER TO NON-ELECTRICAL DRAWINGS FOR ADDITIONAL REQUIREMENTS THAT ARE NOT INDICATED ON THE ELECTRICAL DRAWINGS. THESE REQUIREMENTS MAY BE ELECTRICAL OR NON-ELECTRICAL WORK.
  5. CIRCUITRY IS NOT SHOWN INTENTIONALLY. REFER TO OTHER DRAWINGS AND SPECIFICATIONS FOR COMPLETE CONDUIT AND CONDUCTOR REQUIREMENTS, INCLUDING BUT NOT LIMITED TO: SINGLE LINE DIAGRAMS, PANEL SCHEDULES, AND BLOCK DIAGRAMS
  6. CONDUIT ROUTING IS NOT SHOWN INTENTIONALLY. CONDUIT ROUTING SHALL BE AS PERMITTED BY THE SPECIFICATIONS.
  7. WHERE THE CONDUITS ARE INSTALLED UNDER EXISTING CONCRETE OR ASPHALT: SAW CUT AND REMOVE CONCRETE/ASPHALT; TRENCH, INSTALL CONDUITS, AND BACKFILL; AND INSTALL CONCRETE/ASPHALT AS REQUIRED TO MATCH EXISTING CONDITIONS.
  8. EXISTING ITEMS ARE INDICATED AS EXISTING. ALL ITEMS ARE NEW UNLESS INDICATED EXISTING.

FACILITY DRAWINGS  
This drawing was supplied by a Consultant Engineer from a past construction project. The original contractor drawing was modified based on information provided by the Contractor to provide the Record Drawing. The City does not warrant the accuracy and reliability of the drawings and accurate portrayal of facilities as they exist in the field.

REVISION	DWG NUMBER	CAD FILE NAME	DATE	PROJECT NAME	PROJECT NO.	REFERENCE CID NUMBER	REMARKS

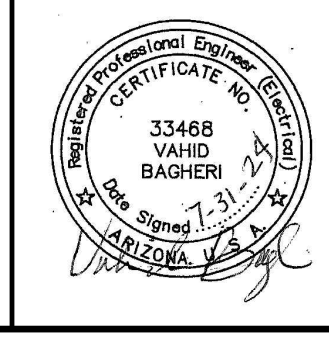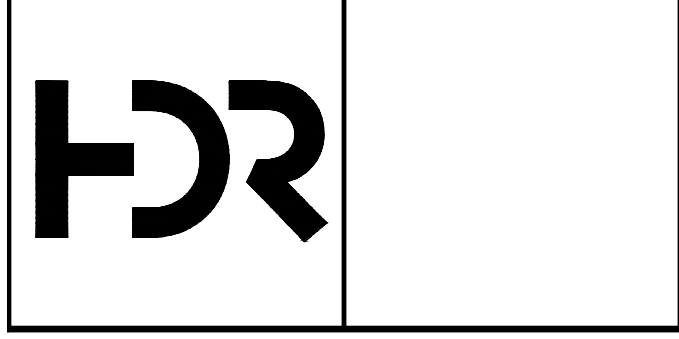

REVISIONS				
NO.	BY	DATE	CKD	REMARKS

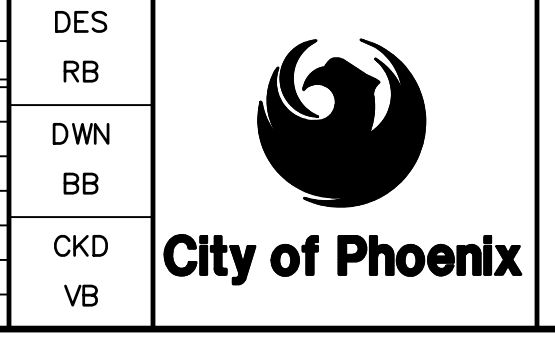

CITY OF PHOENIX  
WATER SERVICES DEPARTMENT  
**LIFT STATION 40  
REFURBISHMENT**


ELECTRICAL  
**WETWELL PLAN**

COPYRIGHT © 2007-JANUARY  
CITY PROJECT NO. WS90400085  
DATE: 08/2024  
E-15 SHEET 106 OF 134  
CAD FILE: CEELS40EP10.dwg

THIS DRAWING MUST BE FIELD VERIFIED BEFORE USE  
DRAWING NOT TO SCALE UNLESS SCALE BAR IS PRESENT

FOR CONSTRUCTION

PER CITY OF PHOENIX CODE CHAPTER 2, SECTION 2-28, THESE PLANS ARE FOR OFFICIAL USE ONLY AND MAY NOT BE SHARED WITH OTHERS EXCEPT AS REQUIRED TO FULFILL THE OBLIGATIONS OF THE CONTRACTOR'S CONTRACT WITH THE CITY OF PHOENIX.  
THIS DOCUMENT MUST BE KEPT SECURE AT ALL TIMES.

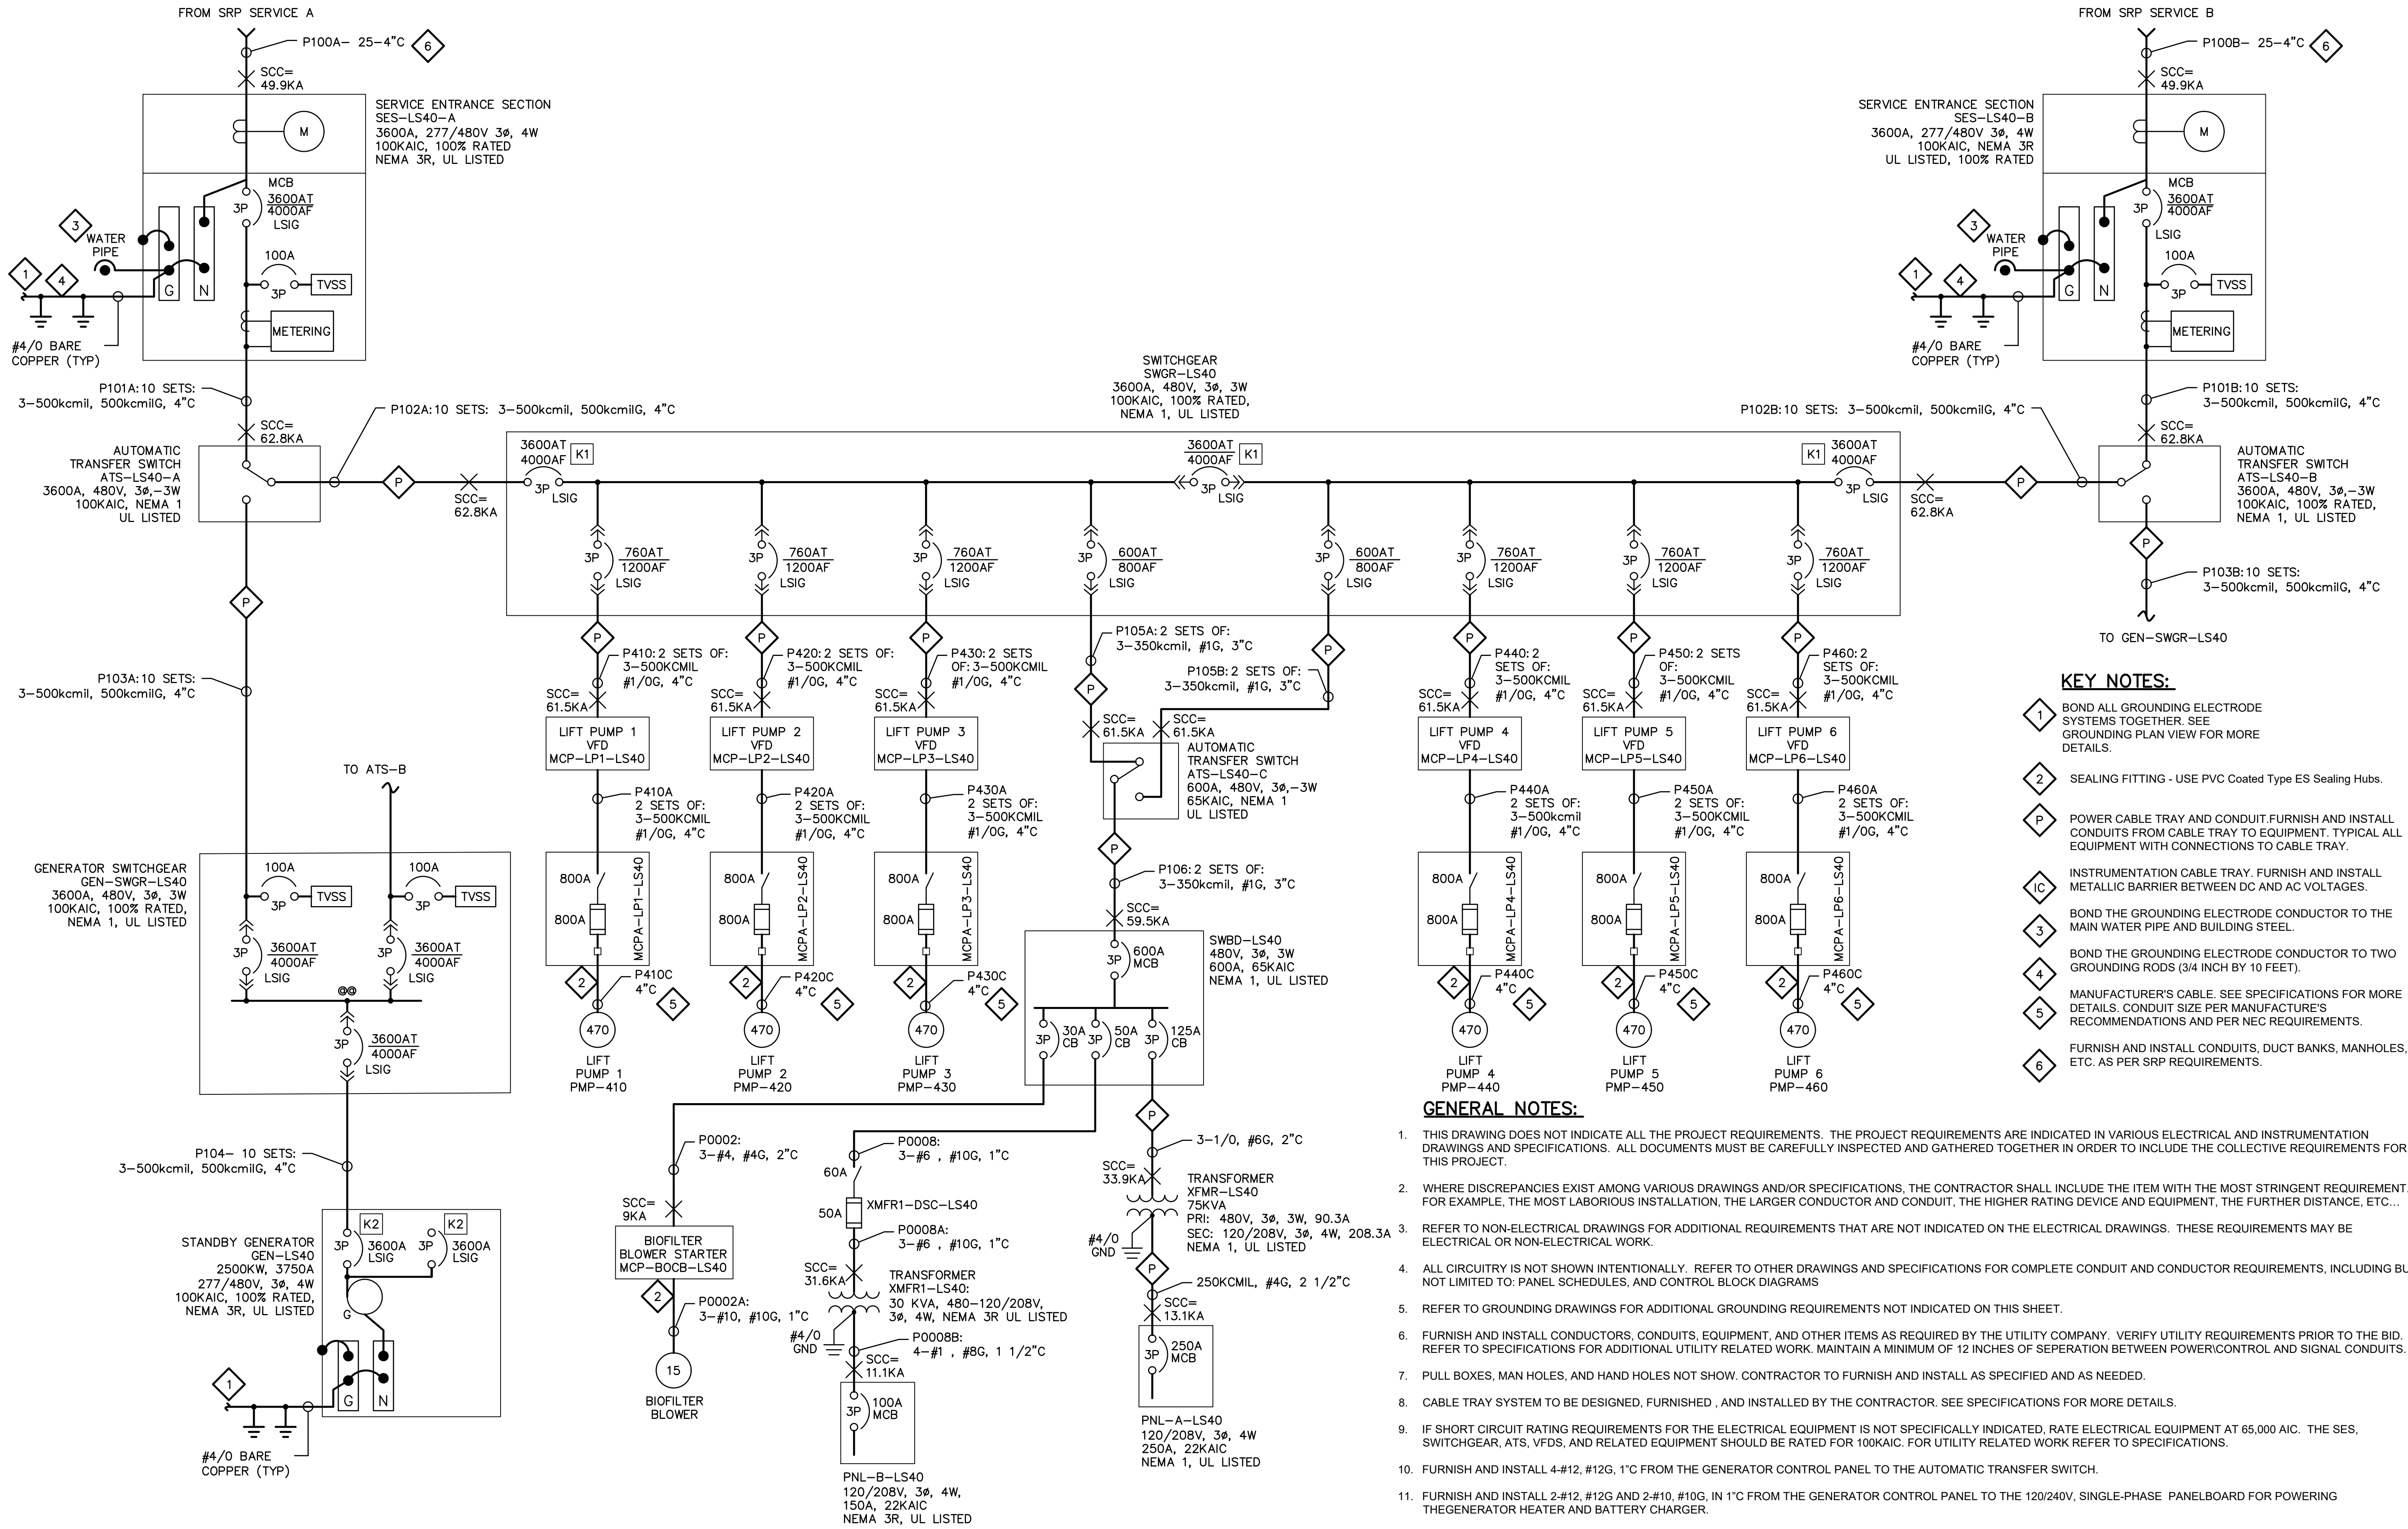

**KEY NOTES:**




- 1 BOND ALL GROUNDING ELECTRODE SYSTEMS TOGETHER. SEE GROUNDING PLAN VIEW FOR MORE DETAILS.
- 2 SEALING FITTING - USE PVC Coated Type ES Sealing Hubs.
- P POWER CABLE TRAY AND CONDUIT. FURNISH AND INSTALL CONDUITS FROM CABLE TRAY TO EQUIPMENT. TYPICAL ALL EQUIPMENT WITH CONNECTIONS TO CABLE TRAY.
- IC INSTRUMENTATION CABLE TRAY. FURNISH AND INSTALL METALLIC BARRIER BETWEEN DC AND AC VOLTAGES.
- 3 BOND THE GROUNDING ELECTRODE CONDUCTOR TO THE MAIN WATER PIPE AND BUILDING STEEL.
- 4 BOND THE GROUNDING ELECTRODE CONDUCTOR TO TWO GROUNDING RODS (3/4 INCH BY 10 FEET).
- 5 MANUFACTURER'S CABLE. SEE SPECIFICATIONS FOR MORE DETAILS. CONDUIT SIZE PER MANUFACTURER'S RECOMMENDATIONS AND PER NEC REQUIREMENTS.
- 6 FURNISH AND INSTALL CONDUITS, DUCT BANKS, MANHOLES, ETC. AS PER SRP REQUIREMENTS.

**GENERAL NOTES:**


1. THIS DRAWING DOES NOT INDICATE ALL THE PROJECT REQUIREMENTS. THE PROJECT REQUIREMENTS ARE INDICATED IN VARIOUS ELECTRICAL AND INSTRUMENTATION DRAWINGS AND SPECIFICATIONS. ALL DOCUMENTS MUST BE CAREFULLY INSPECTED AND GATHERED TOGETHER IN ORDER TO INCLUDE THE COLLECTIVE REQUIREMENTS FOR THIS PROJECT.
2. WHERE DISCREPANCIES EXIST AMONG VARIOUS DRAWINGS AND/OR SPECIFICATIONS, THE CONTRACTOR SHALL INCLUDE THE ITEM WITH THE MOST STRINGENT REQUIREMENT. FOR EXAMPLE, THE MOST LABORIOUS INSTALLATION, THE LARGER CONDUCTOR AND CONDUIT, THE HIGHER RATING DEVICE AND EQUIPMENT, THE FURTHER DISTANCE, ETC...
3. REFER TO NON-ELECTRICAL DRAWINGS FOR ADDITIONAL REQUIREMENTS THAT ARE NOT INDICATED ON THE ELECTRICAL DRAWINGS. THESE REQUIREMENTS MAY BE ELECTRICAL OR NON-ELECTRICAL WORK.
4. ALL CIRCUITRY IS NOT SHOWN INTENTIONALLY. REFER TO OTHER DRAWINGS AND SPECIFICATIONS FOR COMPLETE CONDUIT AND CONDUCTOR REQUIREMENTS, INCLUDING BUT NOT LIMITED TO: PANEL SCHEDULES, AND CONTROL BLOCK DIAGRAMS
5. REFER TO GROUNDING DRAWINGS FOR ADDITIONAL GROUNDING REQUIREMENTS NOT INDICATED ON THIS SHEET.
6. FURNISH AND INSTALL CONDUCTORS, CONDUITS, EQUIPMENT, AND OTHER ITEMS AS REQUIRED BY THE UTILITY COMPANY. VERIFY UTILITY REQUIREMENTS PRIOR TO THE BID. REFER TO SPECIFICATIONS FOR ADDITIONAL UTILITY RELATED WORK. MAINTAIN A MINIMUM OF 12 INCHES OF SEPERATION BETWEEN POWER/CONTROL AND SIGNAL CONDUITS.
7. PULL BOXES, MAN HOLES, AND HAND HOLES NOT SHOW. CONTRACTOR TO FURNISH AND INSTALL AS SPECIFIED AND AS NEEDED.
8. CABLE TRAY SYSTEM TO BE DESIGNED, FURNISHED, AND INSTALLED BY THE CONTRACTOR. SEE SPECIFICATIONS FOR MORE DETAILS.
9. IF SHORT CIRCUIT RATING REQUIREMENTS FOR THE ELECTRICAL EQUIPMENT IS NOT SPECIFICALLY INDICATED, RATE ELECTRICAL EQUIPMENT AT 65,000 AIC. THE SES, SWITCHGEAR, ATS, VFDS, AND RELATED EQUIPMENT SHOULD BE RATED FOR 100KAIC. FOR UTILITY RELATED WORK REFER TO SPECIFICATIONS.
10. FURNISH AND INSTALL 4-#12, #12G, 1°C FROM THE GENERATOR CONTROL PANEL TO THE AUTOMATIC TRANSFER SWITCH.
11. FURNISH AND INSTALL 2-#12, #12G AND 2-#10, #10G, IN 1°C FROM THE GENERATOR CONTROL PANEL TO THE 120/240V, SINGLE-PHASE PANELBOARD FOR POWERING THE GENERATOR HEATER AND BATTERY CHARGER.

FACILITY DRAWINGS  
This drawing was supplied by a Consultant Engineer from a past construction project. The original contractor drawing was modified based on information provided by the Contractor to provide the Record Drawing. The City does not warrant the accuracy and completeness of the drawings and portrayal of facilities as they exist in the field.

REVISION	DWG NUMBER	CAD FILE NAME	DATE	PROJECT NO.	PROJECT NAME	REFERENCE CID NUMBER

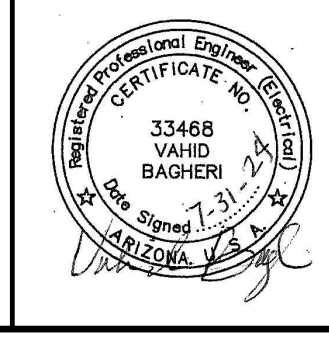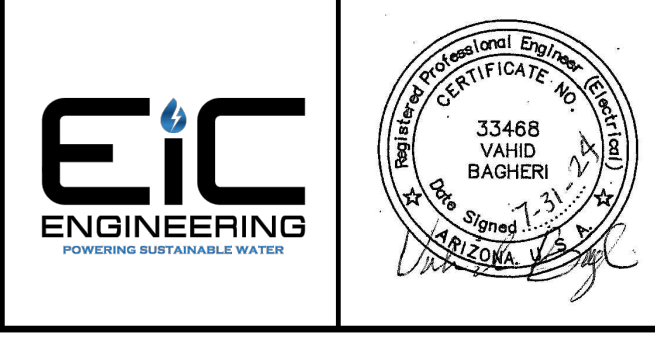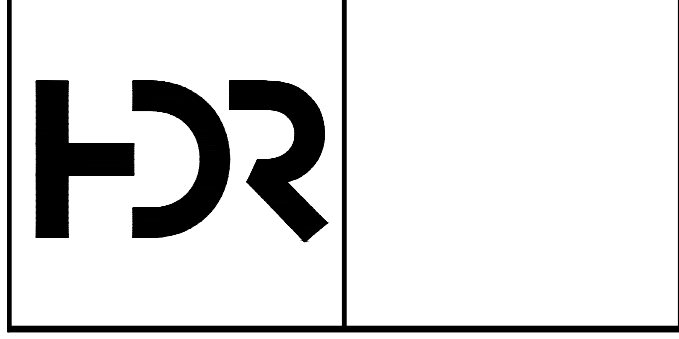

REVISIONS				
NO.	BY	DATE	CKD	REMARKS

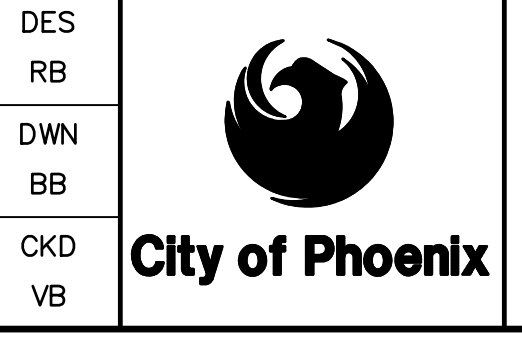

CITY OF PHOENIX  
WATER SERVICES DEPARTMENT  
**LIFT STATION 40  
REFURBISHMENT**

ELECTRICAL  
**SINGLE LINE DIAGRAM**

COPYRIGHT © 2007-JANUARY  
CITY PROJECT NO. WS90400085  
DATE: 08/2024  
E-16 SHEET 107 OF 134  
CAD FILE: CEELS40EN01.dwg

THIS DRAWING MUST BE FIELD VERIFIED BEFORE USE  
DRAWING NOT TO SCALE UNLESS SCALE BAR IS PRESENT

FOR CONSTRUCTION

LOAD SUMMARY									
FAC/AREA (ZONE/SITE): LS-40			MANUFACTURER: TBD						
EQUIPMENT LOCATION: LS-40			VOLTS/PHASE/WIRE 480 VAC, 3P, 3W						
TAG NAME: SES-LS40-A			MAIN BUS RATING: 3600						
FED FROM: SRP SERVICE A			MAIN BREAKER (AMPS): 3600						
			AIC RATING (AMPS): 100k						
			MAIN LUG ONLY: NO						
SECTION NO.	TAG/CMMS NUMBER	BREAKER / FUSE SIZE	STARTER SIZE	FEEDER CABLE SIZE	EQUIPMENT NAME	KVA	HP	FLA	BREAKER TRIP RATING
TBD	TBD	800	VFD	500 kcmil	PUMP NO.1		470	535	720
TBD	TBD	800	VFD	500 kcmil	PUMP NO.2		470	535	720
TBD	TBD	800	VFD	500 kcmil	PUMP NO.3		470	535	720
TBD	TBD	800	VFD	500 kcmil	PUMP NO.4		470	535	720
TBD	TBD	800	TBD	500 kcmil	PUMP NO.5		470	535	720
TBD	TBD	800	TBD	500 kcmil	PUMP NO.6 (Standby)		470		720
TBD	TBD	600	TBD	350 kcmil	SWITCHBOARD			300	600
SUBTOTAL OF FLA FOR NON-MOTOR LOADS (KVA):								100	
SUBTOTAL OF FLA FOR MOTOR LOADS:								2975	
PLUS 25% OF LARGEST MOTOR (THE SWITCHGEAR IS 100% RATED):								0	
TOTAL AMPS								3075	
% LOADED (NO LARGER THAN 80% OF SELECTED LOAD SERVICE SIZE):								85%	



A SES-LS40-A LOAD CALCULATION  
N.T.S.

LOAD SUMMARY									
FAC/AREA (ZONE/SITE): LS-40			MANUFACTURER: TBD						
EQUIPMENT LOCATION: LS-40			VOLTS/PHASE/WIRE 480 VAC, 3P, 3W						
TAG NAME: SES-LS40-B			MAIN BUS RATING: 3600						
FED FROM: SRP SERVICE B			MAIN BREAKER (AMPS): 3600						
			AIC RATING (AMPS): 100k						
			MAIN LUG ONLY: NO						
SECTION NO.	TAG/CMMS NUMBER	BREAKER / FUSE SIZE	STARTER SIZE	FEEDER CABLE SIZE	EQUIPMENT NAME	KVA	HP	FLA	BREAKER TRIP RATING
TBD	TBD	800	VFD	500 kcmil	PUMP NO. 1		470	535	720
TBD	TBD	800	VFD	500 kcmil	PUMP NO. 2		470	535	720
TBD	TBD	800	VFD	500 kcmil	PUMP NO. 3		470	535	720
TBD	TBD	800	VFD	500 kcmil	PUMP NO. 4		470	535	720
TBD	TBD	800	TBD	500 kcmil	PUMP NO. 5		470	535	720
TBD	TBD	800	TBD	500 kcmil	PUMP NO.6 (Standby)		470		720
TBD	TBD	600	TBD	350 kcmil	SWITCHBOARD			300	600
SUBTOTAL OF FLA FOR NON-MOTOR LOADS (KVA):								100	
SUBTOTAL OF FLA FOR MOTOR LOADS:								2975	
PLUS 25% OF LARGEST MOTOR (THE SWITCHGEAR IS 100% RATED):								0	
TOTAL AMPS								3075	
% LOADED (NO LARGER THAN 80% OF SELECTED LOAD SERVICE SIZE):								85%	

B SES-LS40-B LOAD CALCULATION  
N.T.S.

FACILITY DRAWINGS  
This drawing was supplied by a Consultant Engineer from a past construction project. The original contractor drawing was modified based on information provided by the Contractor to provide the Record Drawing. The City does not warrant the accuracy of the information and accurate portrayal of facilities as they exist in the field.

REVISION #	DATE	CAD FILE NAME	DWG NUMBER	REMARKS

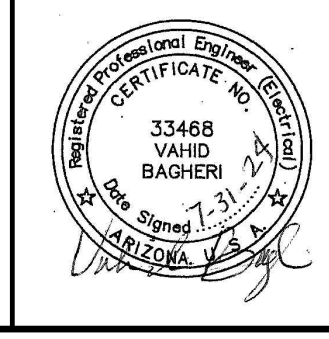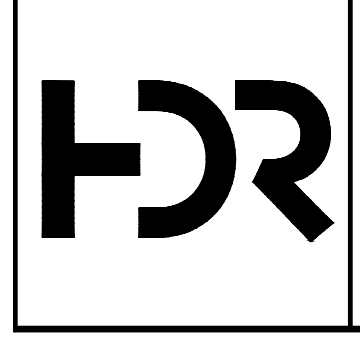

REVISIONS				
NO.	BY	DATE	CKD	REMARKS

DES RB  
DWN BB  
CKD VB



CITY OF PHOENIX  
WATER SERVICES DEPARTMENT  
  
LIFT STATION 40  
REFURBISHMENT

ELECTRICAL  
  
LOAD SUMMARY

COPYRIGHT © 2007-JANUARY  
CITY PROJECT NO. WS90400085  
DATE: 08/2024  
E-17 SHEET 108 OF 134  
CAD FILE: CEELS40EN02.dwg

FOR CITY OF PHOENIX USE ONLY -- REFERENCE CID NUMBER: #  
PROJECT NO. #  
PROJECT NAME #  
DATE #  
CAD FILE NAME #  
DWG NUMBER #  
REMARKS #

THIS DRAWING MUST BE FIELD VERIFIED BEFORE USE  
DRAWING NOT TO SCALE UNLESS SCALE BAR IS PRESENT

FOR CONSTRUCTION

"PER CITY OF PHOENIX CODE CHAPTER 2, SECTION 2-28, THESE PLANS ARE FOR OFFICIAL USE ONLY AND MAY NOT BE SHARED WITH OTHERS EXCEPT AS REQUIRED TO FULFILL THE OBLIGATIONS OF THE CONTRACTOR'S CONTRACT WITH THE CITY OF PHOENIX."  
THIS DOCUMENT MUST BE KEPT SECURE AT ALL TIMES.

**KEY NOTES:**

- 1 FURNISH AND INSTALL A NEMA 4X, SS 316, 600V, 30A, FUSED DISCONNECT SWITCHES. FUSED PER HVAC EQUIPMENT MANUFACTURER'S RECOMMENDATIONS. PLEASE NOTE THAT THESE DISCONNECT SWITCHES ARE NOT INDICATED ON THE PLAN VIEWS BUT ARE REQUIRED.
- 2 FURNISH AND INSTALL A NEMA 4X, SS 316, 600V, 30A, FUSED DISCONNECT SWITCHES. FUSED PER VENDOR EQUIPMENT MANUFACTURER'S RECOMMENDATIONS. PLEASE NOTE THAT THESE DISCONNECT SWITCHES ARE NOT INDICATED ON THE PLAN VIEWS BUT ARE REQUIRED.

**GENERAL NOTES:**

- 1. THIS DRAWING DOES NOT INDICATE ALL THE PROJECT REQUIREMENTS. THE PROJECT REQUIREMENTS ARE INDICATED IN VARIOUS ELECTRICAL AND INSTRUMENTATION DRAWINGS AND SPECIFICATIONS. ALL DOCUMENTS MUST BE CAREFULLY INSPECTED AND GATHERED TOGETHER IN ORDER TO INCLUDE THE COLLECTIVE REQUIREMENTS FOR THIS PROJECT.
- 2. WHERE DISCREPANCIES EXIST AMONG VARIOUS DRAWINGS AND/OR SPECIFICATIONS, THE CONTRACTOR SHALL INCLUDE THE ITEM WITH THE MOST STRINGENT REQUIREMENT. FOR EXAMPLE, THE MOST LABORIOUS INSTALLATION, THE LARGER CONDUCTOR AND CONDUIT, THE HIGHER RATING DEVICE AND EQUIPMENT, THE FURTHER DISTANCE, ETC...
- 3. THE CONTRACTOR SHALL VERIFY THAT ALL LOADS INDICATED ON THE PANEL SCHEDULE HAVE DESIGNATED CONDUITS AND CONDUCTORS. IF CIRCUITS DO NOT HAVE DESIGNATED CONDUITS AND CONDUCTORS, THEN THE CONTRACTOR SHALL INCLUDE CONDUITS AND CONDUCTORS PER NEC FOR THESE LOADS. IF THE DISTANCE BETWEEN THE LOADS AND PANELS ARE NOT EVIDENT, THEN THE CONTRACTOR SHALL INCLUDE 100 FEET OF CIRCUITRY FOR EACH LOAD.
- 4. FURNISH AND INSTALL 100 FEET OF CIRCUITRY (2-#12, #12G, 1°C) FOR EACH CIRCUIT INDICATED AS SPARE. THIS WORK SHALL BE IDENTIFIED AND DIRECTED PER ENGINEER ONLY.

**PANEL: SWBD-LS40**  
VOLTAGE, PHASE & WIRE: 480V VAC 3Ø 3W  
BUS SIZE: 600 AMPS  
MAIN SIZE: 600 AMPS  
MAIN TYPE: MCB  
MANUFACTURER: TBD  
LOCATION: ELECTRICAL ROOM  
ENCLOSURE: NEMA 1  
MOUNTING: SURFACE  
BUS BRACING: 65 KAIC  
FED FROM: SWGR-LS40

WIRE/CONDUIT SIZE	CKT NO.	LOAD DESCRIPTION	CKT. BKR. AMP	AMPS			CKT. BKR. AMP	LOAD DESCRIPTION	CKT NO.	WIRE/CONDUIT SIZE
				A	B	C				
SEE SINGLE LINE.	1	TRANSFORMER XFMR-LS-40	125A	90.3		21.0	30A	MCP-BOCB-LS40	2	SEE SINGLE LINE.
	3								4	
	5								6	
	7								8	
P007: 3-#8, #10G, 1°C	9	BUILDING A/C UNIT 1	40A	32.0	32.0	37.0	50A	TRANSFORMER XFMR1-LS-40	10	P008: 3-#6, #10G, 1°C
	11								12	
	13								14	
P0013: 3-#8, #10G, 1°C	15	BUILDING A/C UNIT 2	40A	32.0			20A	SPARE	16	
	17								18	
	19								20	
P0019: 3-#4, #10G, 1°C	21	EMERG ODOR CONTROL PWR REC	60A	48.0			20A	SPARE	22	
	23								24	
	25								26	
	27	SPARE	40A			18.0	30A MCP	LCP-AC-VLV-LS40	28	P0026: 3-#10, #10G, 1°C
	29								30	
	31								32	
	33	SPARE	40A					SPACE	34	
	35								36	
	37								38	
	39	SPARE	20A					SPACE	40	
	41								42	
	43								44	
	45	SPACE						SPACE	46	
	47								48	
	49								50	
	51	SPACE						SPACE	52	
	53								54	
	55								56	
	57	SPACE						SPACE	58	
	59								60	
	61								62	
	63	SPACE						SPACE	64	
	65								66	
				202.3	202.3	202.3	76.0	76.0	76.0	

**NOTES:**  
KVA A PHASE = 96.4 AMPS A PHASE = 347.9  
KVA B PHASE = 96.4 AMPS B PHASE = 347.9  
KVA C PHASE = 96.4 AMPS C PHASE = 347.9  
BY FIRM: DATE:  
Changes to this Schedule Require Approval From the City Electrical Foreman  
**TOTAL KVA = 289.1 (Load totals are calculated as continuous duty at 125% )**

**PANEL: PNL-A**  
VOLTAGE, PHASE & WIRE: 120/208 VAC 3Ø 4W  
BUS SIZE: 250 AMPS  
MAIN SIZE: 250 AMPS  
MAIN TYPE: MCB  
MANUFACTURER: TBD  
LOCATION: ELECTRICAL ROOM  
ENCLOSURE: NEMA 1  
MOUNTING: SURFACE  
BUS BRACING: 22 KAIC  
FED FROM: XFMR-LS40

WIRE/CONDUIT SIZE	CKT NO.	LOAD DESCRIPTION	CKT. BKR. AMP	AMPS			CKT. BKR. AMP	LOAD DESCRIPTION	CKT NO.	WIRE/CONDUIT SIZE
				A	B	C				
P001: 2#12, #12G, 1°C	1	LCP-PLC-LS40	20A	7.0			20A	LCP-SSE-LS40	2	P002: 2#12, #12G, 1°C
	3	LCP-PLC-LS40 (LIGHTING/REC)	20A		3.0		20A	LCP-SSE-LS40 (LIGHTING/REC)	4	P004: 2#12, #12G, 1°C
	5	LCP-PCP-LS40	20A		8.0		20A	LCP-BOCB-LS40	6	P006: 2#8, #8G, 1°C
P007: 2#12, #12G, 1°C	7	LCP-PCP-LS40 (LIGHTING/REC)	20A	3.0			20A	LCP-BOCB-LS40 (LIGHTING/REC)	8	P008: 2#8, #8G, 1°C
	9	SPARE	20A				20A	LCP-BACKUP-LS40	10	P010: 2#12, #12G, 1°C
	11	ROOF RECEPTACLES	20A		3.0		20A	LCP-COM-LS40	12	P012: 2#12, #12G, 1°C
P011: 2#12, #12G, 1°C	13	GENERATOR PANELBOARD	100A	80.0			20A	LCP-COM-LS40 (LIGHTING/REC)	14	P014: 2#12, #12G, 1°C
	15			80.0			20A	LCP-BS-LS40	16	P016: 2#12, #12G, 1°C
P017: 2#8, #12G, 1°C	17	AREA LIGHT CONT PNL (ALCP-LS40)	20A		4.5		20A	LCP-BS-LS40 (LIGHTING/REC)	18	P018: 2#12, #12G, 1°C
	19	ELECTRICAL ROOM LIGHTS	20A	5.0			20A	SPARE	20	
P019: 2#12, #12G, 1°C	21	ELECTRICAL BUILDING RECEPTACLES	20A		12.0		20A	SPARE	22	
	23	ELECTRICAL BUILDING OUTSIDE LIGHTS	20A		7.5		20A	BIOFILTER BLOWER ENCLOSURE FAN	24	P024: 2#8, #8G, 1°C
P023: 2#12, #12G, 1°C	25	ELECTRICAL BUILDING EXIT LIGHTS	20A	4.5			20A	SPARE	26	
P025: 2#12, #12G, 1°C	27	SPARE	20A				20A	SPARE	28	
	29	ELECTRICAL BUILDING OUTSIDE REC	20A		7.5		20A	SPARE	30	
P029: 2#12, #12G, 1°C	31	SPARE	20A				20A	OUTSIDE RECEPTACLES	32	P032: 2#8, #8G, 1°C
	33	SPARE	20A				20A	SPARE	34	
P035: 2#12, #12G, 1°C	35	OUTSIDE POLE LIGHTING	20A		5.5		20A	LCP-LP-VLV-LS40	36	P036: 2#12, #12G, 1°C
	37	SPARE	20A					SPACE	38	
	39	SPARE	20A					SPACE	40	
	41	SPARE	20A					SPACE	42	
				99.5	95.0	36.0	23.5	10.0	41.6	

**NOTES:**  
KVA A PHASE = 18.5 AMPS A PHASE = 153.8  
KVA B PHASE = 15.8 AMPS B PHASE = 131.3  
KVA C PHASE = 11.6 AMPS C PHASE = 97.0  
BY FIRM: DATE:  
Changes to this Schedule Require Approval From the City Electrical Foreman  
**TOTAL KVA = 45.8 (Load totals are calculated as continuous duty at 125% )**

**B PNL-A-LS40 SCHEDULE**  
N.T.S.

**A SWBD-LS40 SCHEDULE**  
N.T.S.

**PANEL: PNL-B**  
VOLTAGE, PHASE & WIRE: 120/208 VAC 3Ø 4W  
BUS SIZE: 125 AMPS  
MAIN SIZE: 100 AMPS  
MAIN TYPE: MCB  
MANUFACTURER: TBD  
LOCATION: ELECTRICAL ROOM  
ENCLOSURE: NEMA 3R  
MOUNTING: SURFACE  
BUS BRACING: 22 KAIC  
FED FROM: XFMR1-LS40

WIRE/CONDUIT SIZE	CKT NO.	LOAD DESCRIPTION	CKT. BKR. AMP	AMPS			CKT. BKR. AMP	LOAD DESCRIPTION	CKT NO.	WIRE/CONDUIT SIZE
				A	B	C				
P1001: 2#10, #10G, 1°C	1	FERROUS CHLORIDE SYSTEM	20A	14.0			20A	SPARE	2	
	3	FERROUS CHLORIDE LIGHTING	20A		7.0		25A	FERROUS CHLORIDE SYSTEM	4	P1004: 2#10, #10G, 1°C
P1005: 2#12, #12G, 1°C	5	FERROUS CHLORIDE RECEPTACLES	20A		8.0		20.0	FERROUS CHLORIDE CONTROL SYSTEMS	6	P1006: 2#10, #10G, 1°C
	7	GATE OPERATOR POWER SUPPLY	20A	17.5			20A	SPARE	8	
P1007: 2#12, #12G, 1°C	9	SPARE	20A		17.5		20A	SPARE	10	
	11	SPARE	20A				20A	SPARE	12	
	13	SPARE	20A				-	SPACE	14	
P1015: 2#10, #10G, 1°C	15	FERROUS CHLORIDE SYSTEM	25A		20.0		-	SPACE	16	
P1017: 2#10, #10G, 1°C	17	FERROUS CHLORIDE SYSTEM	25A		20.0		-	SPACE	18	
	19	SPACE	-				-	SPACE	20	
				31.5	44.5	28.0	0.0	20.0	20.0	

**NOTES:**  
KVA A PHASE = 4.7 AMPS A PHASE = 39.4  
KVA B PHASE = 9.7 AMPS B PHASE = 80.6  
KVA C PHASE = 7.2 AMPS C PHASE = 60.0  
BY FIRM: DATE:  
Changes to this Schedule Require Approval From the City Electrical Foreman  
**TOTAL KVA = 21.6 (Load totals are calculated as continuous duty at 125% )**

**C PNL-B-LS40 SCHEDULE**  
N.T.S.

			<b>REVISIONS</b>				DES RB DWN BB CKD VB		CITY OF PHOENIX WATER SERVICES DEPARTMENT	ELECTRICAL  <b>POWER PANEL SCHEDULES</b>	COPYRIGHT © 2007—JANUARY CITY PROJECT NO. WS90400085 DATE: 08/2024 E-18 SHEET 109 OF 134 CAD FILE: CEALS40EL01.dwg
			NO.	BY	DATE	CKD					




FACILITY DRAWINGS  
 This drawing was supplied by a Consultant Engineer from a past construction project. The original contractor drawing was modified based on information provided by the Contractor to provide the Record Drawing. The City does not assume responsibility for the accuracy and completeness of the information provided or the availability of facilities as they exist in the field.

REVISION	DWG NUMBER	CAD FILE NAME	DATE	PROJECT NO.	PROJECT NAME	REFERENCE CID NUMBER: #

THIS DRAWING MUST BE FIELD VERIFIED BEFORE USE  
DRAWING NOT TO SCALE UNLESS SCALE BAR IS PRESENT

FOR CONSTRUCTION

PER CITY OF PHOENIX CODE CHAPTER 2, SECTION 2-28, THESE PLANS ARE FOR OFFICIAL USE ONLY AND MAY NOT BE SHARED WITH OTHERS EXCEPT AS REQUIRED TO FULFILL THE OBLIGATIONS OF THE CONTRACTOR'S CONTRACT WITH THE CITY OF PHOENIX. THIS DOCUMENT MUST BE KEPT SECURE AT ALL TIMES.

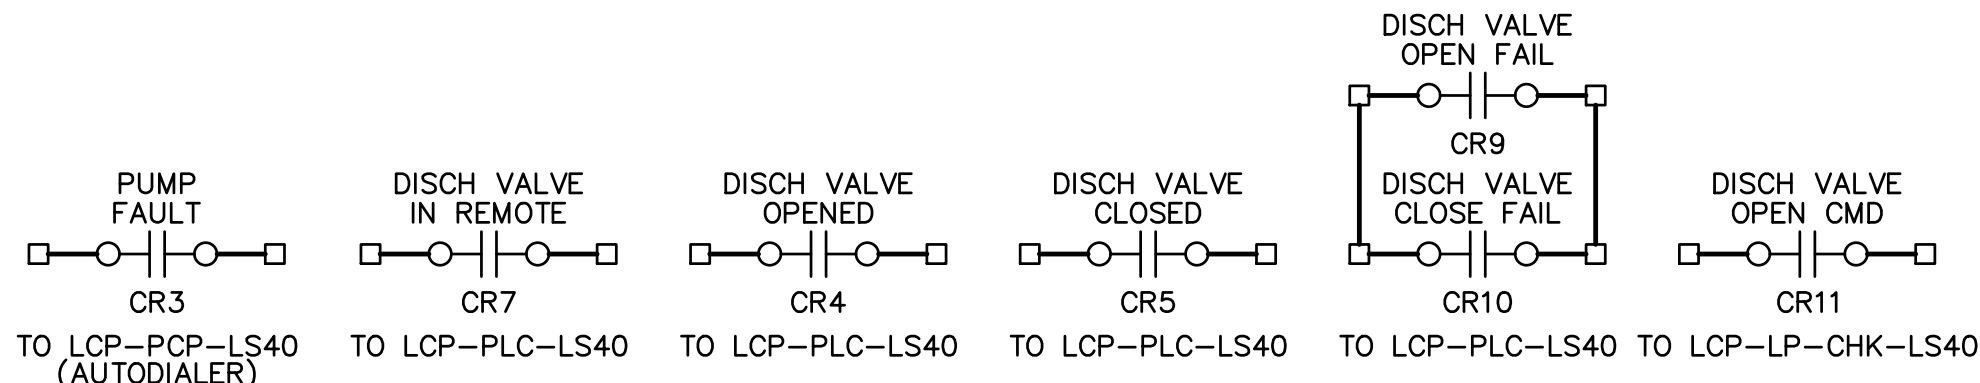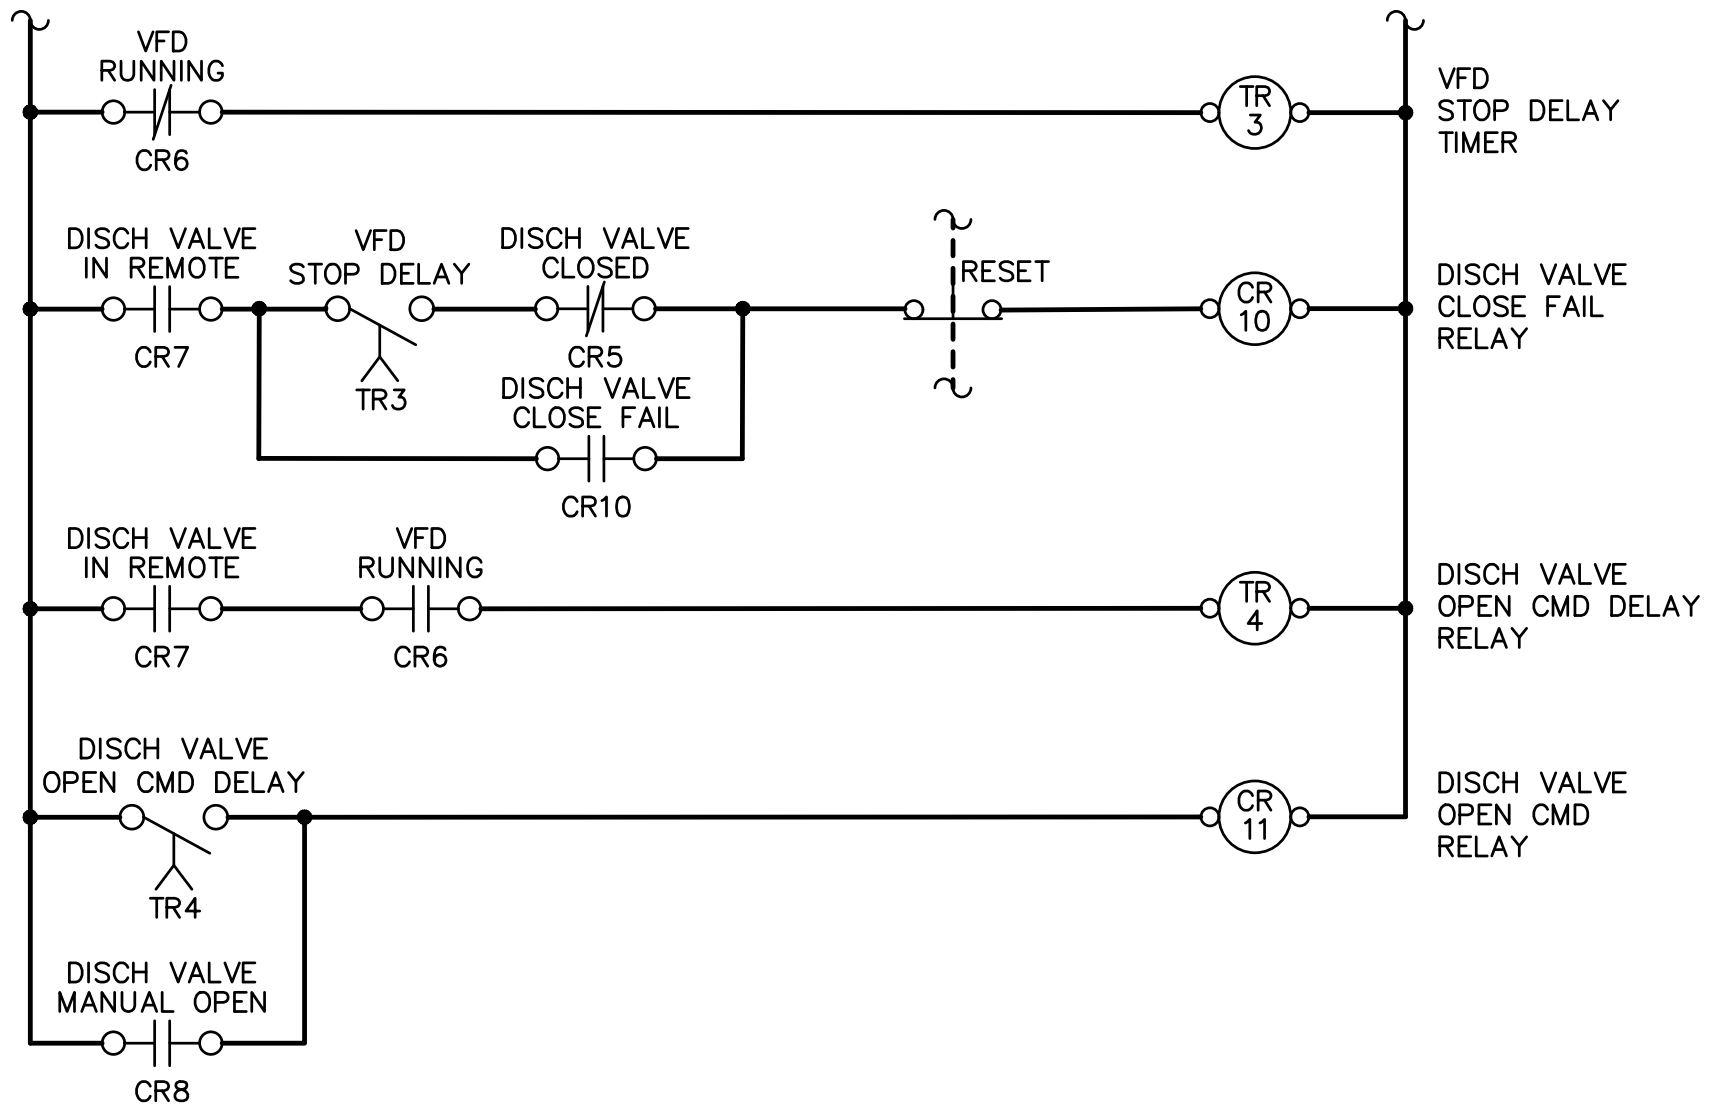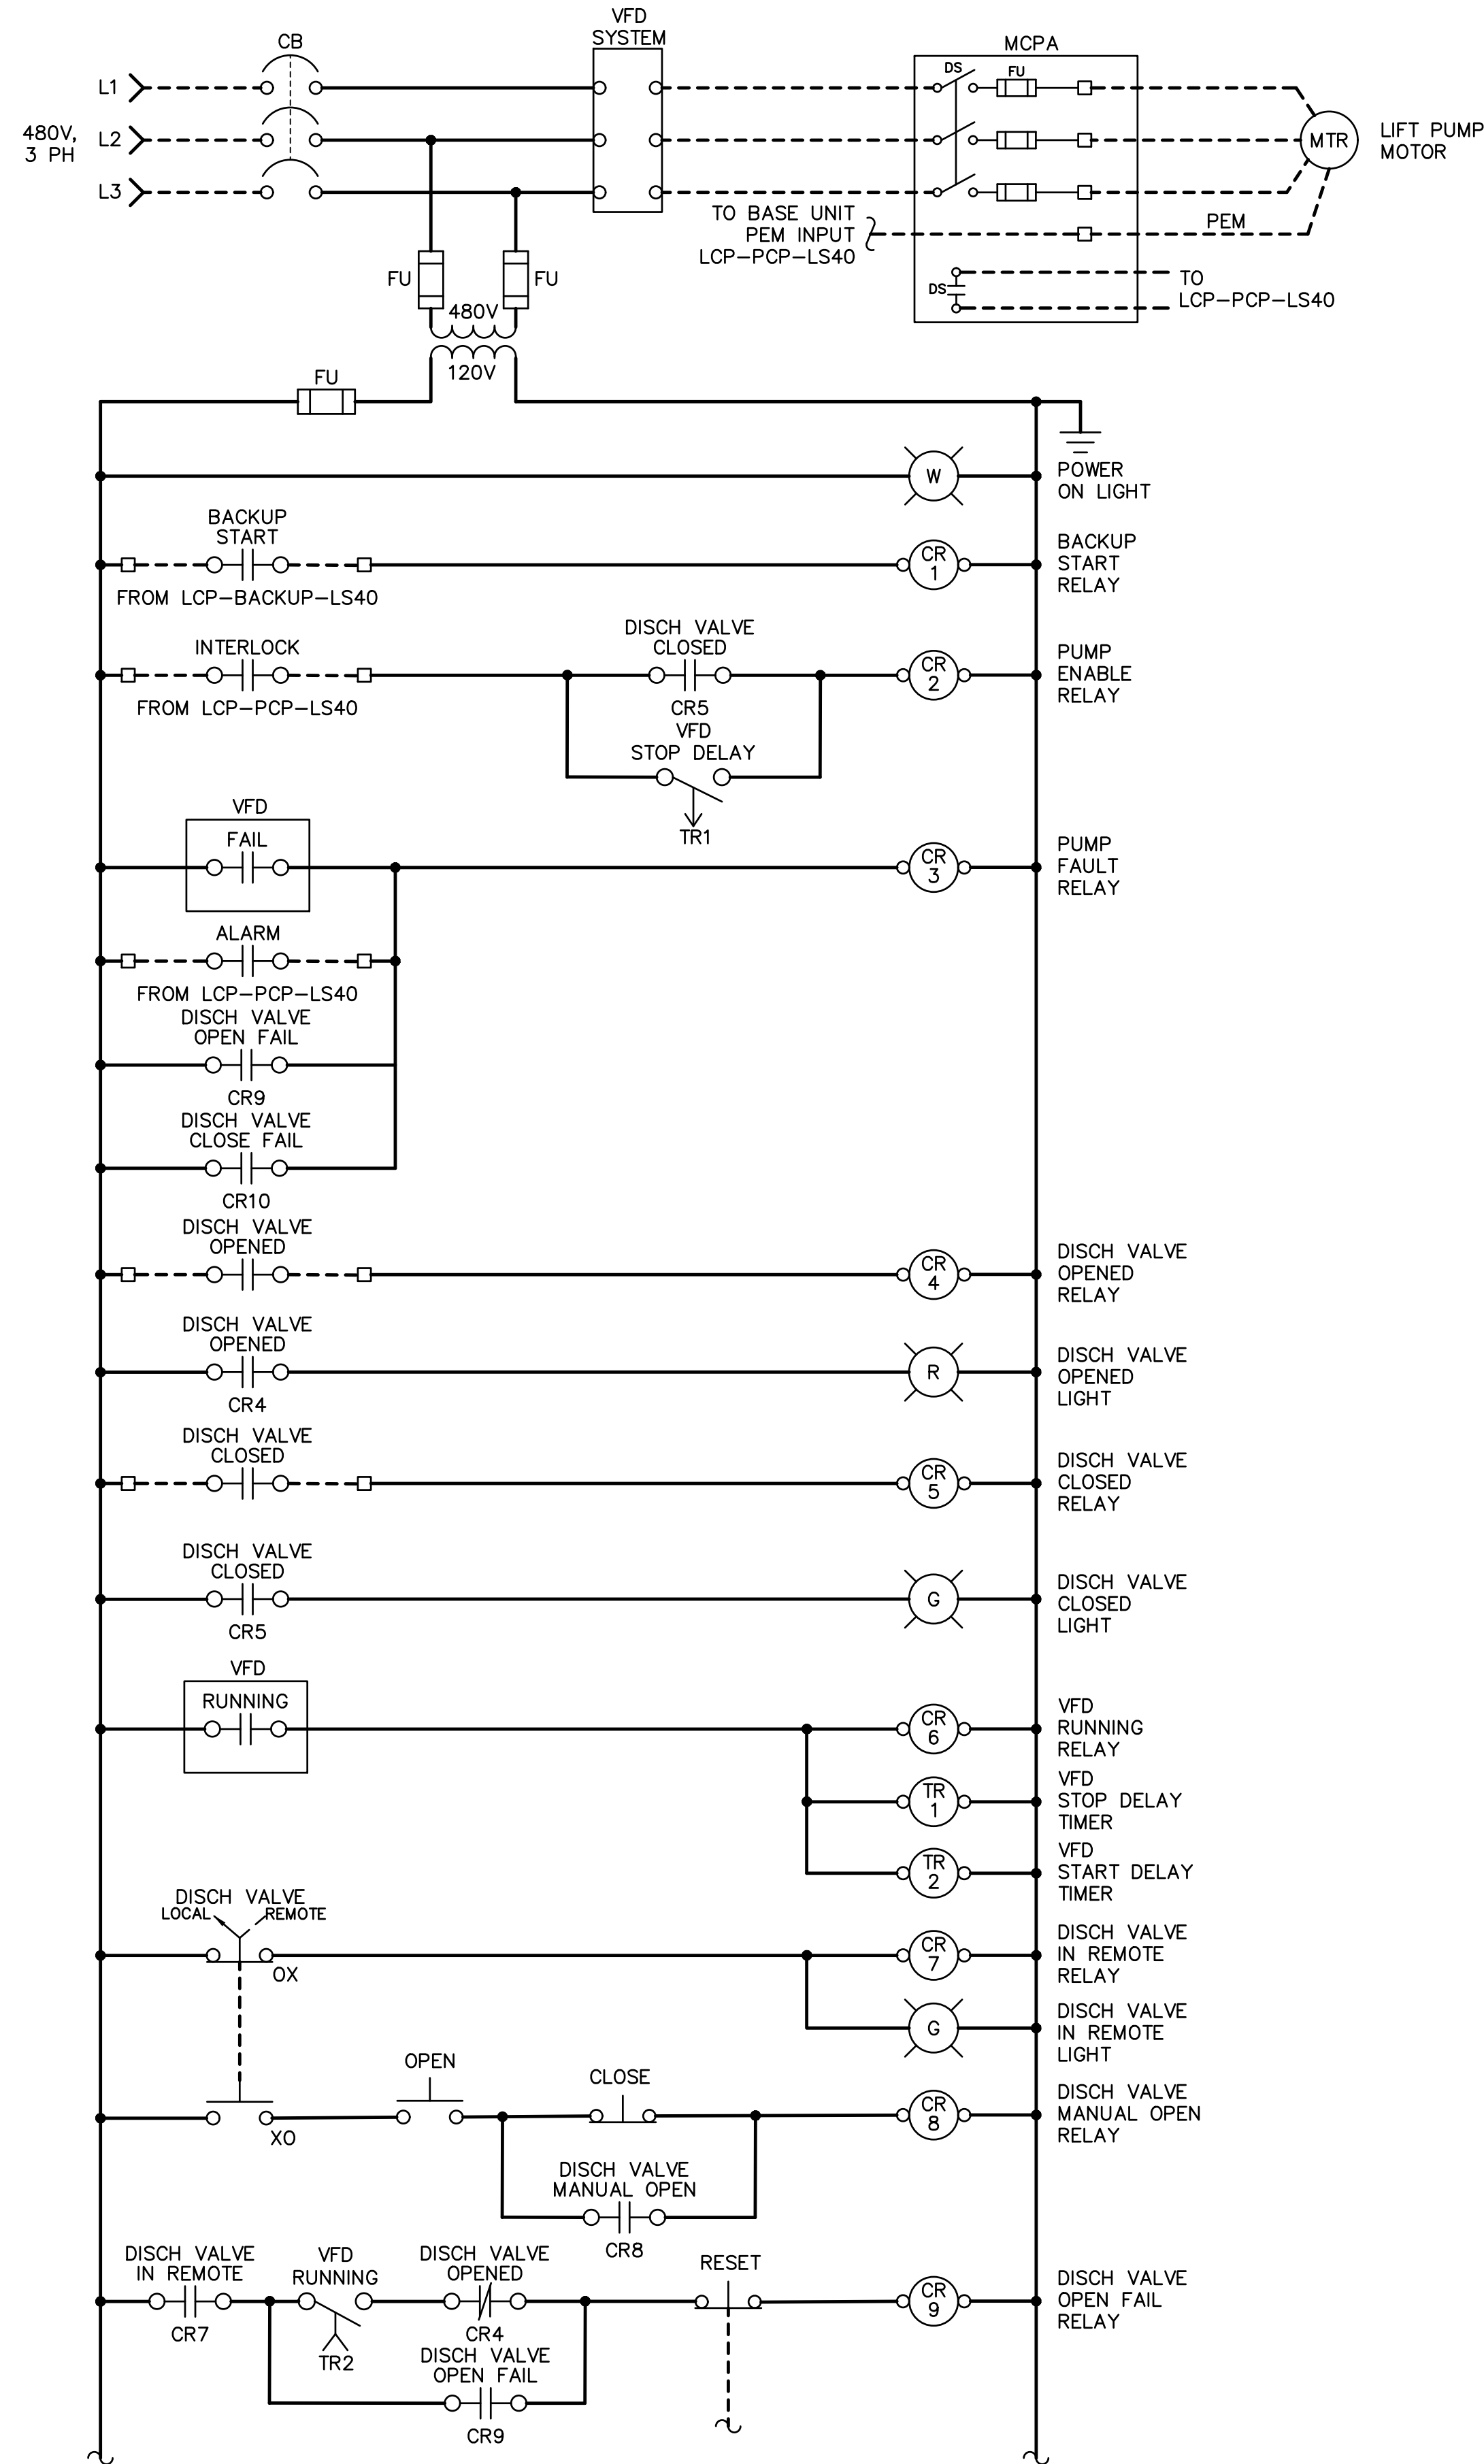


DETAIL A LIFT PUMP 1 VFD CONTROL SCHEMATIC (MCP-LP1-LS40)  
#/# TYPICAL PUMPS LP2, LP3, LP4, LP5 AND LP6.

**GENERAL NOTES:**

- FOR REFERENCE ONLY. CONTRACTOR TO LAYOUT AND DESCRIBE PER 17260 SPECIFICATIONS.
- THIS DRAWING DOES NOT INDICATE ALL THE PROJECT REQUIREMENTS. THE PROJECT REQUIREMENTS ARE INDICATED IN VARIOUS ELECTRICAL AND INSTRUMENTATION DRAWINGS AND SPECIFICATIONS. ALL DOCUMENTS MUST BE CAREFULLY INSPECTED AND GATHERED TOGETHER IN ORDER TO INCLUDE THE COLLECTIVE REQUIREMENTS FOR THIS PROJECT.
- WHERE DISCREPANCIES EXIST AMONG VARIOUS DRAWINGS AND/OR SPECIFICATIONS, THE CONTRACTOR SHALL INCLUDE THE ITEM WITH THE MOST STRINGENT REQUIREMENT. FOR EXAMPLE, THE MOST LABORIOUS INSTALLATION, THE LARGER CONDUCTOR AND CONDUIT, THE HIGHER RATING DEVICE AND EQUIPMENT, THE FURTHER DISTANCE, ETC...
- THE CONTROL SCHEMATICS ARE SHOWN TO FURTHER CONVEY THE DESIGN INTENT AND CONTROL STRATEGY FOR THE SHOWN EQUIPMENT AND DEVICES. THE CONTRACTOR SHALL DESIGN WIRING DIAGRAMS BY INCORPORATING THE CONTROL SCHEMATICS HEREIN, THE P&IDs, CONTROL STRATEGIES, AND INCORPORATING THE ACTUAL SUBMITTED EQUIPMENT AND DEVICES.
- WHEN THE CONTROL SCHEMATICS ARE EXISTING AND WE ARE MODIFYING THEM: THE CONTRACTOR SHALL ALLOW 16 HOURS BY A PROFICIENT CONTROL ELECTRICIAN TO AS-BUILD THE CONTROLS ASSOCIATED WITH THIS CONTROL SCHEMATIC. THE AS-BUILT CONTROL SCHEMATIC SHOULD BE SKETCHED AND SUBMITTED TO THE ENGINEER FOR FURTHER MODIFICATION IF NECESSARY.
- THE TEMPORARY CONTROLS WILL HAVE TO BE AS-BUILT BY THE CONTRACTOR AND SHALL BE OF THE EXISTING EQUIPMENT BEING DUPLICATED.

**IMPORTANT NOTE:**  
THE CONTROL SCHEMATICS SHOWN HERE INDICATE THE CONTROL STRATEGY FOR THE SHOWN EQUIPMENT AND DEVICES. THE CONTRACTOR SHALL SUBMIT 17260 WIRING DIAGRAMS INDICATIVE OF THE ACTUAL EQUIPMENT AND DEVICES BEING INSTALLED.

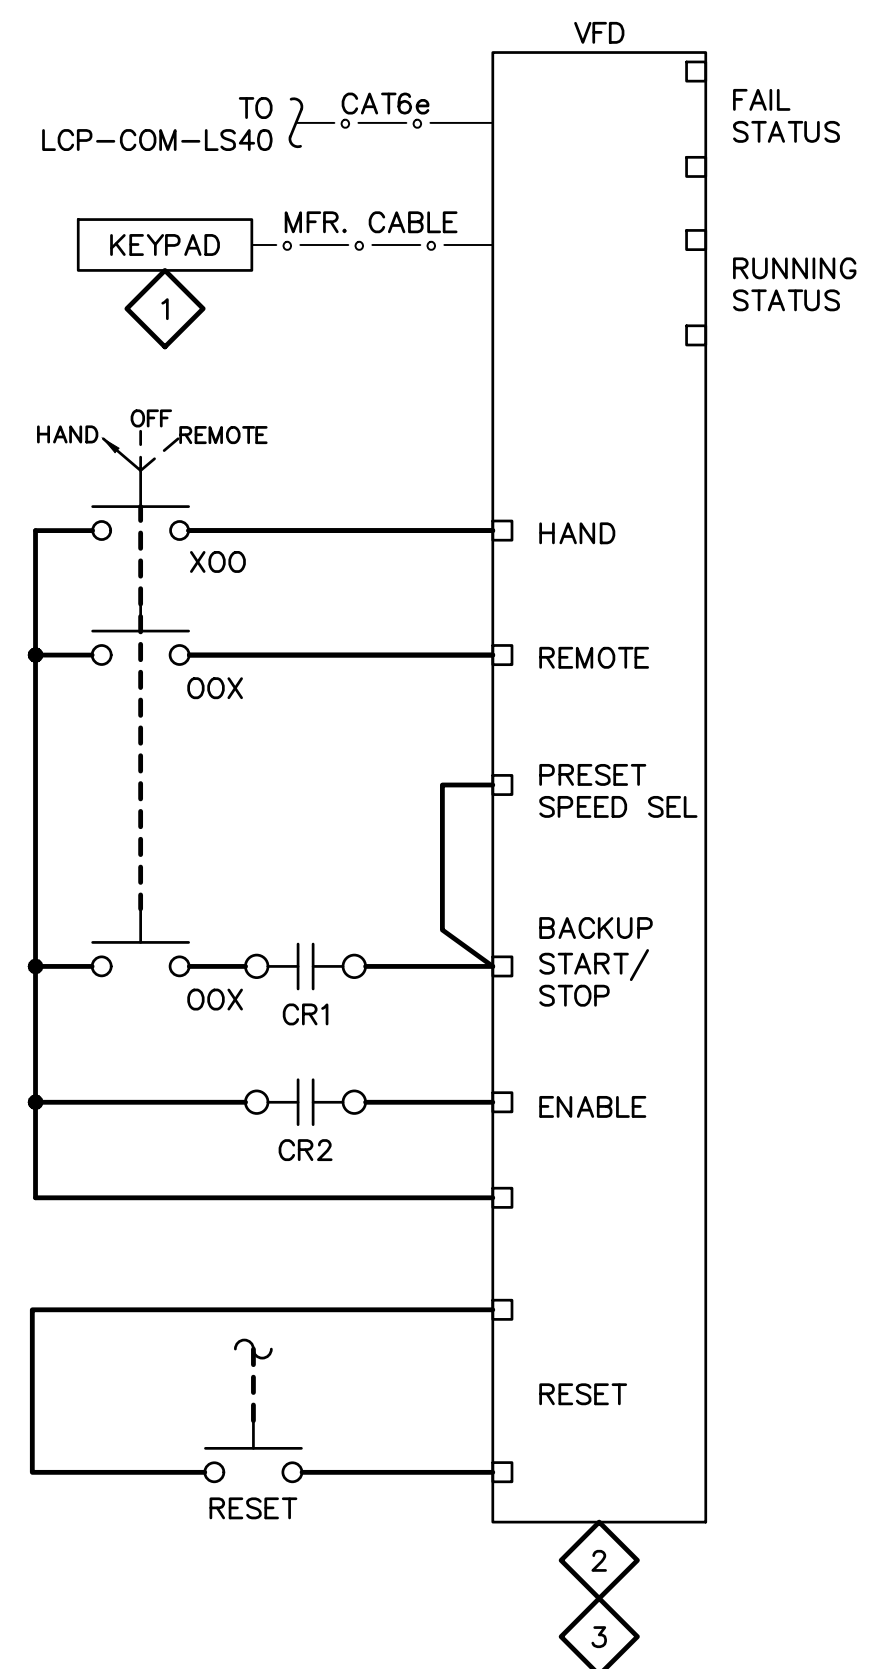

- KEY NOTES:**
- MOUNT IN VFD DOOR SUCH THAT KEYPAD IS VISIBLE WHEN VFD DOOR IS CLOS
  - FURNISH AND INSTALL CONTROLS AS NEEDED TO FACILITATE ETHERNET CONTROL AND BACKUP CONTROL. NOT ALL RELAY CONTACTS MAY BE SHOWN.
  - IN BACKUP CONTROL MODE OF OPERATION, PUMP SPEED IS FIXED. FIXED SPEED SETPOINTS TO BE DETERMINED AT STARTUP.

FACILITY DRAWINGS  
This drawing was supplied by a Consultant Engineer from a past construction project. The original contractor to provide the Record Drawing information provided by the Contractor to provide the Record Drawing. The City does not warrant the accuracy and reliability of the information and accurate portrayal of facilities as they exist in the field.

REVISION	DWG NUMBER	CAD FILE NAME	DATE	PROJECT NAME	REFERENCE CID NUMBER

REVISIONS				
NO.	BY	DATE	CKD	REMARKS

CITY OF PHOENIX  
WATER SERVICES DEPARTMENT  
  
LIFT STATION 40  
REFURBISHMENT


ELECTRICAL  
  
CONTROL SCHEMATICS 1

COPYRIGHT © 2007-JANUARY  
CITY PROJECT NO. WS90400085  
DATE: 08/2024  
E-19 SHEET 110 OF 134  
CAD FILE: CSELS40ES01.dwg

THIS DRAWING MUST BE FIELD VERIFIED BEFORE USE  
DRAWING NOT TO SCALE UNLESS SCALE BAR IS PRESENT

FOR CONSTRUCTION

PER CITY OF PHOENIX CODE CHAPTER 2, SECTION 2-28, THESE PLANS ARE FOR OFFICIAL USE ONLY AND MAY NOT BE SHARED WITH OTHERS EXCEPT AS REQUIRED TO FULFILL THE OBLIGATIONS OF THE CONTRACTOR'S CONTRACT WITH THE CITY OF PHOENIX. THIS DOCUMENT MUST BE KEPT SECURE AT ALL TIMES.

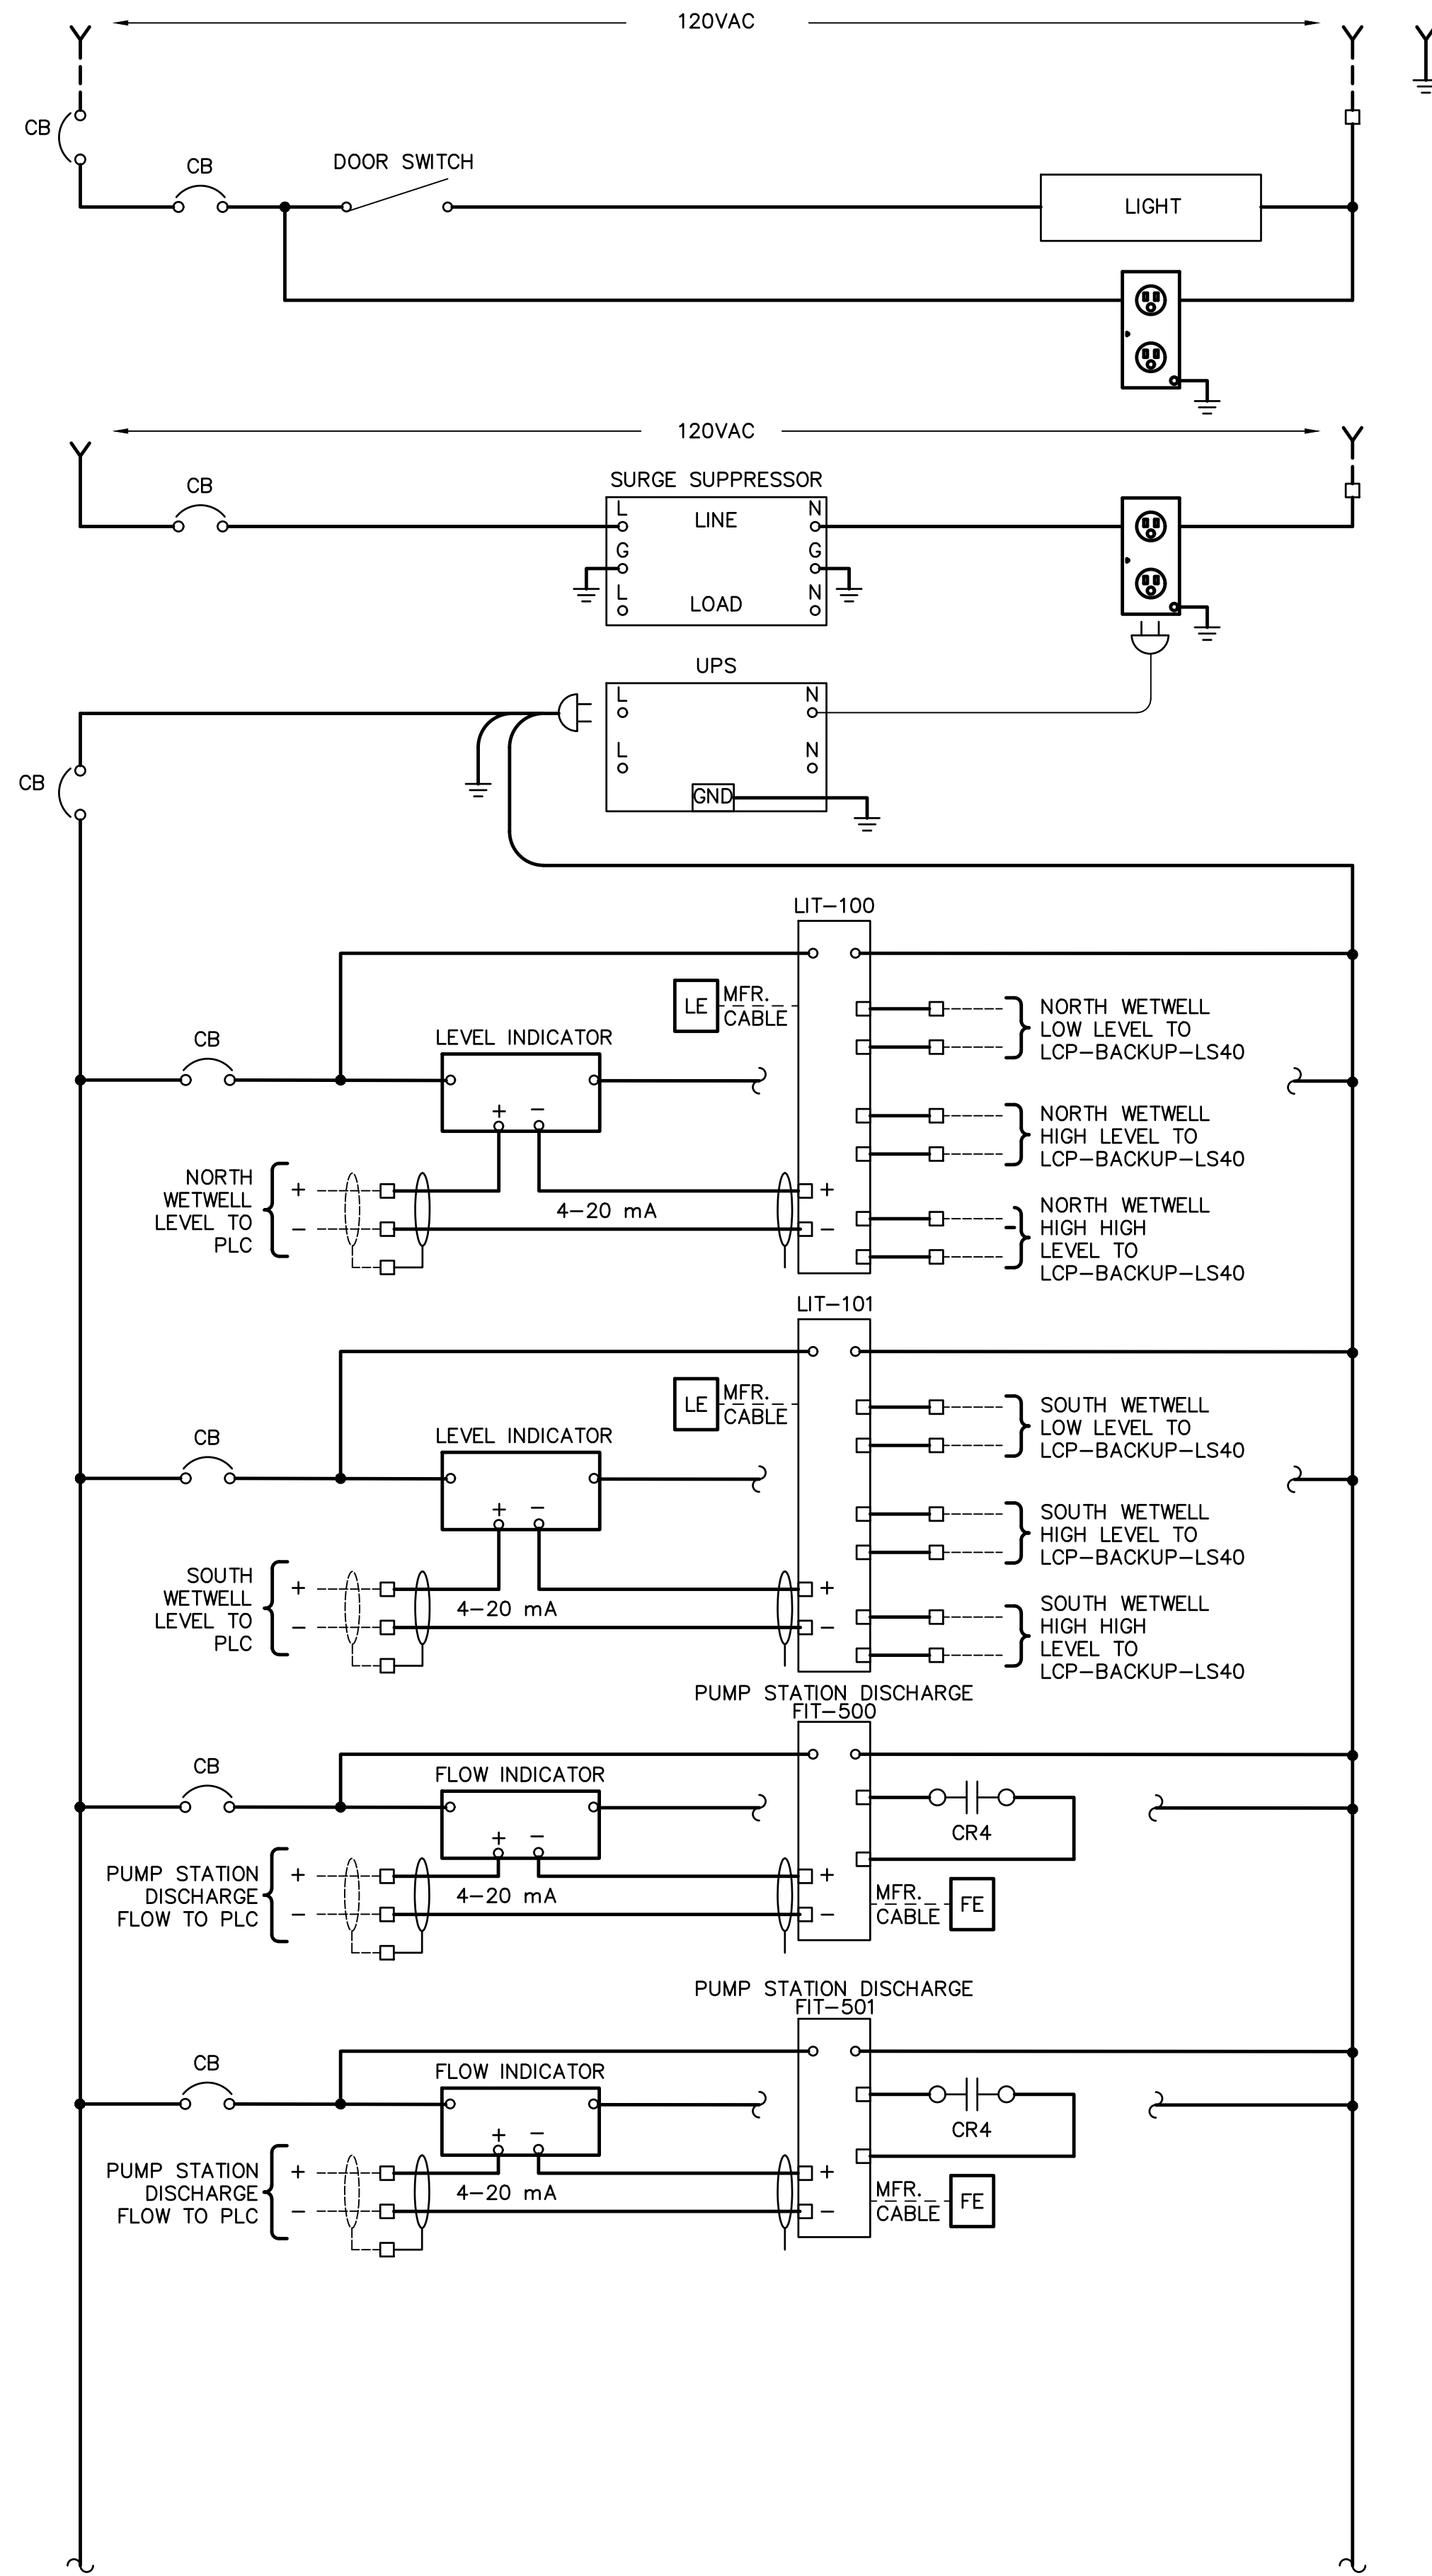


- KEYED NOTES:**
- 1. CRA, CRB FOR LP1  
CRC, CRD FOR LP2  
CRE, CRF FOR LP3  
CRG, CRH FOR LP4  
CRI, CRJ FOR LP5  
CRK, CRL FOR LP6
  - 2. ONLY ONE FLYGT MASCUB01 AND ONE FLYGT FOP 402 DISPLAY ARE REQUIRED. THE FLYGT BASE UNITS MASBU811 SHOULD ALL BE CONNECTED USING DEVICENET. SEE P&IDS FOR ADDITIONAL DETAILS.

**GENERAL NOTES:**

- FOR REFERENCE ONLY. CONTRACTOR TO LAYOUT AND DESCRIBE PER 17260 SPECIFICATIONS.
- THIS DRAWING DOES NOT INDICATE ALL THE PROJECT REQUIREMENTS. THE PROJECT REQUIREMENTS ARE INDICATED IN VARIOUS ELECTRICAL AND INSTRUMENTATION DRAWINGS AND SPECIFICATIONS. ALL DOCUMENTS MUST BE CAREFULLY INSPECTED AND GATHERED TOGETHER IN ORDER TO INCLUDE THE COLLECTIVE REQUIREMENTS FOR THIS PROJECT.
- WHERE DISCREPANCIES EXIST AMONG VARIOUS DRAWINGS AND/OR SPECIFICATIONS, THE CONTRACTOR SHALL INCLUDE THE ITEM WITH THE MOST STRINGENT REQUIREMENT. FOR EXAMPLE, THE MOST LABORIOUS INSTALLATION, THE LARGER CONDUIT AND CONDUIT, THE HIGHER RATING DEVICE AND EQUIPMENT, THE FURTHER DISTANCE, ETC...
- THE CONTROL SCHEMATICS ARE SHOWN TO FURTHER CONVEY THE DESIGN INTENT AND CONTROL STRATEGY FOR THE SHOWN EQUIPMENT AND DEVICES. THE CONTRACTOR SHALL DESIGN WIRING DIAGRAMS BY INCORPORATING THE CONTROL SCHEMATICS HEREIN, THE P&IDS, CONTROL STRATEGIES, AND INCORPORATING THE ACTUAL SUBMITTED EQUIPMENT AND DEVICES.
- WHEN THE CONTROL SCHEMATICS ARE EXISTING AND WE ARE MODIFYING THEM: THE CONTRACTOR SHALL ALLOW 16 HOURS BY A PROFICIENT CONTROL ELECTRICIAN TO AS-BUILD THE CONTROLS ASSOCIATED WITH THIS CONTROL SCHEMATIC. THE AS-BUILT CONTROL SCHEMATIC SHOULD BE SKETCHED AND SUBMITTED TO THE ENGINEER FOR FURTHER MODIFICATION IF NECESSARY.
- THE TEMPORARY CONTROLS WILL HAVE TO BE AS-BUILT BY THE CONTRACTOR AND SHALL BE OF THE EXISTING EQUIPMENT BEING DUPLICATED.

TYPICAL OF PUMPS P2, P3, P4, P5 AND P6

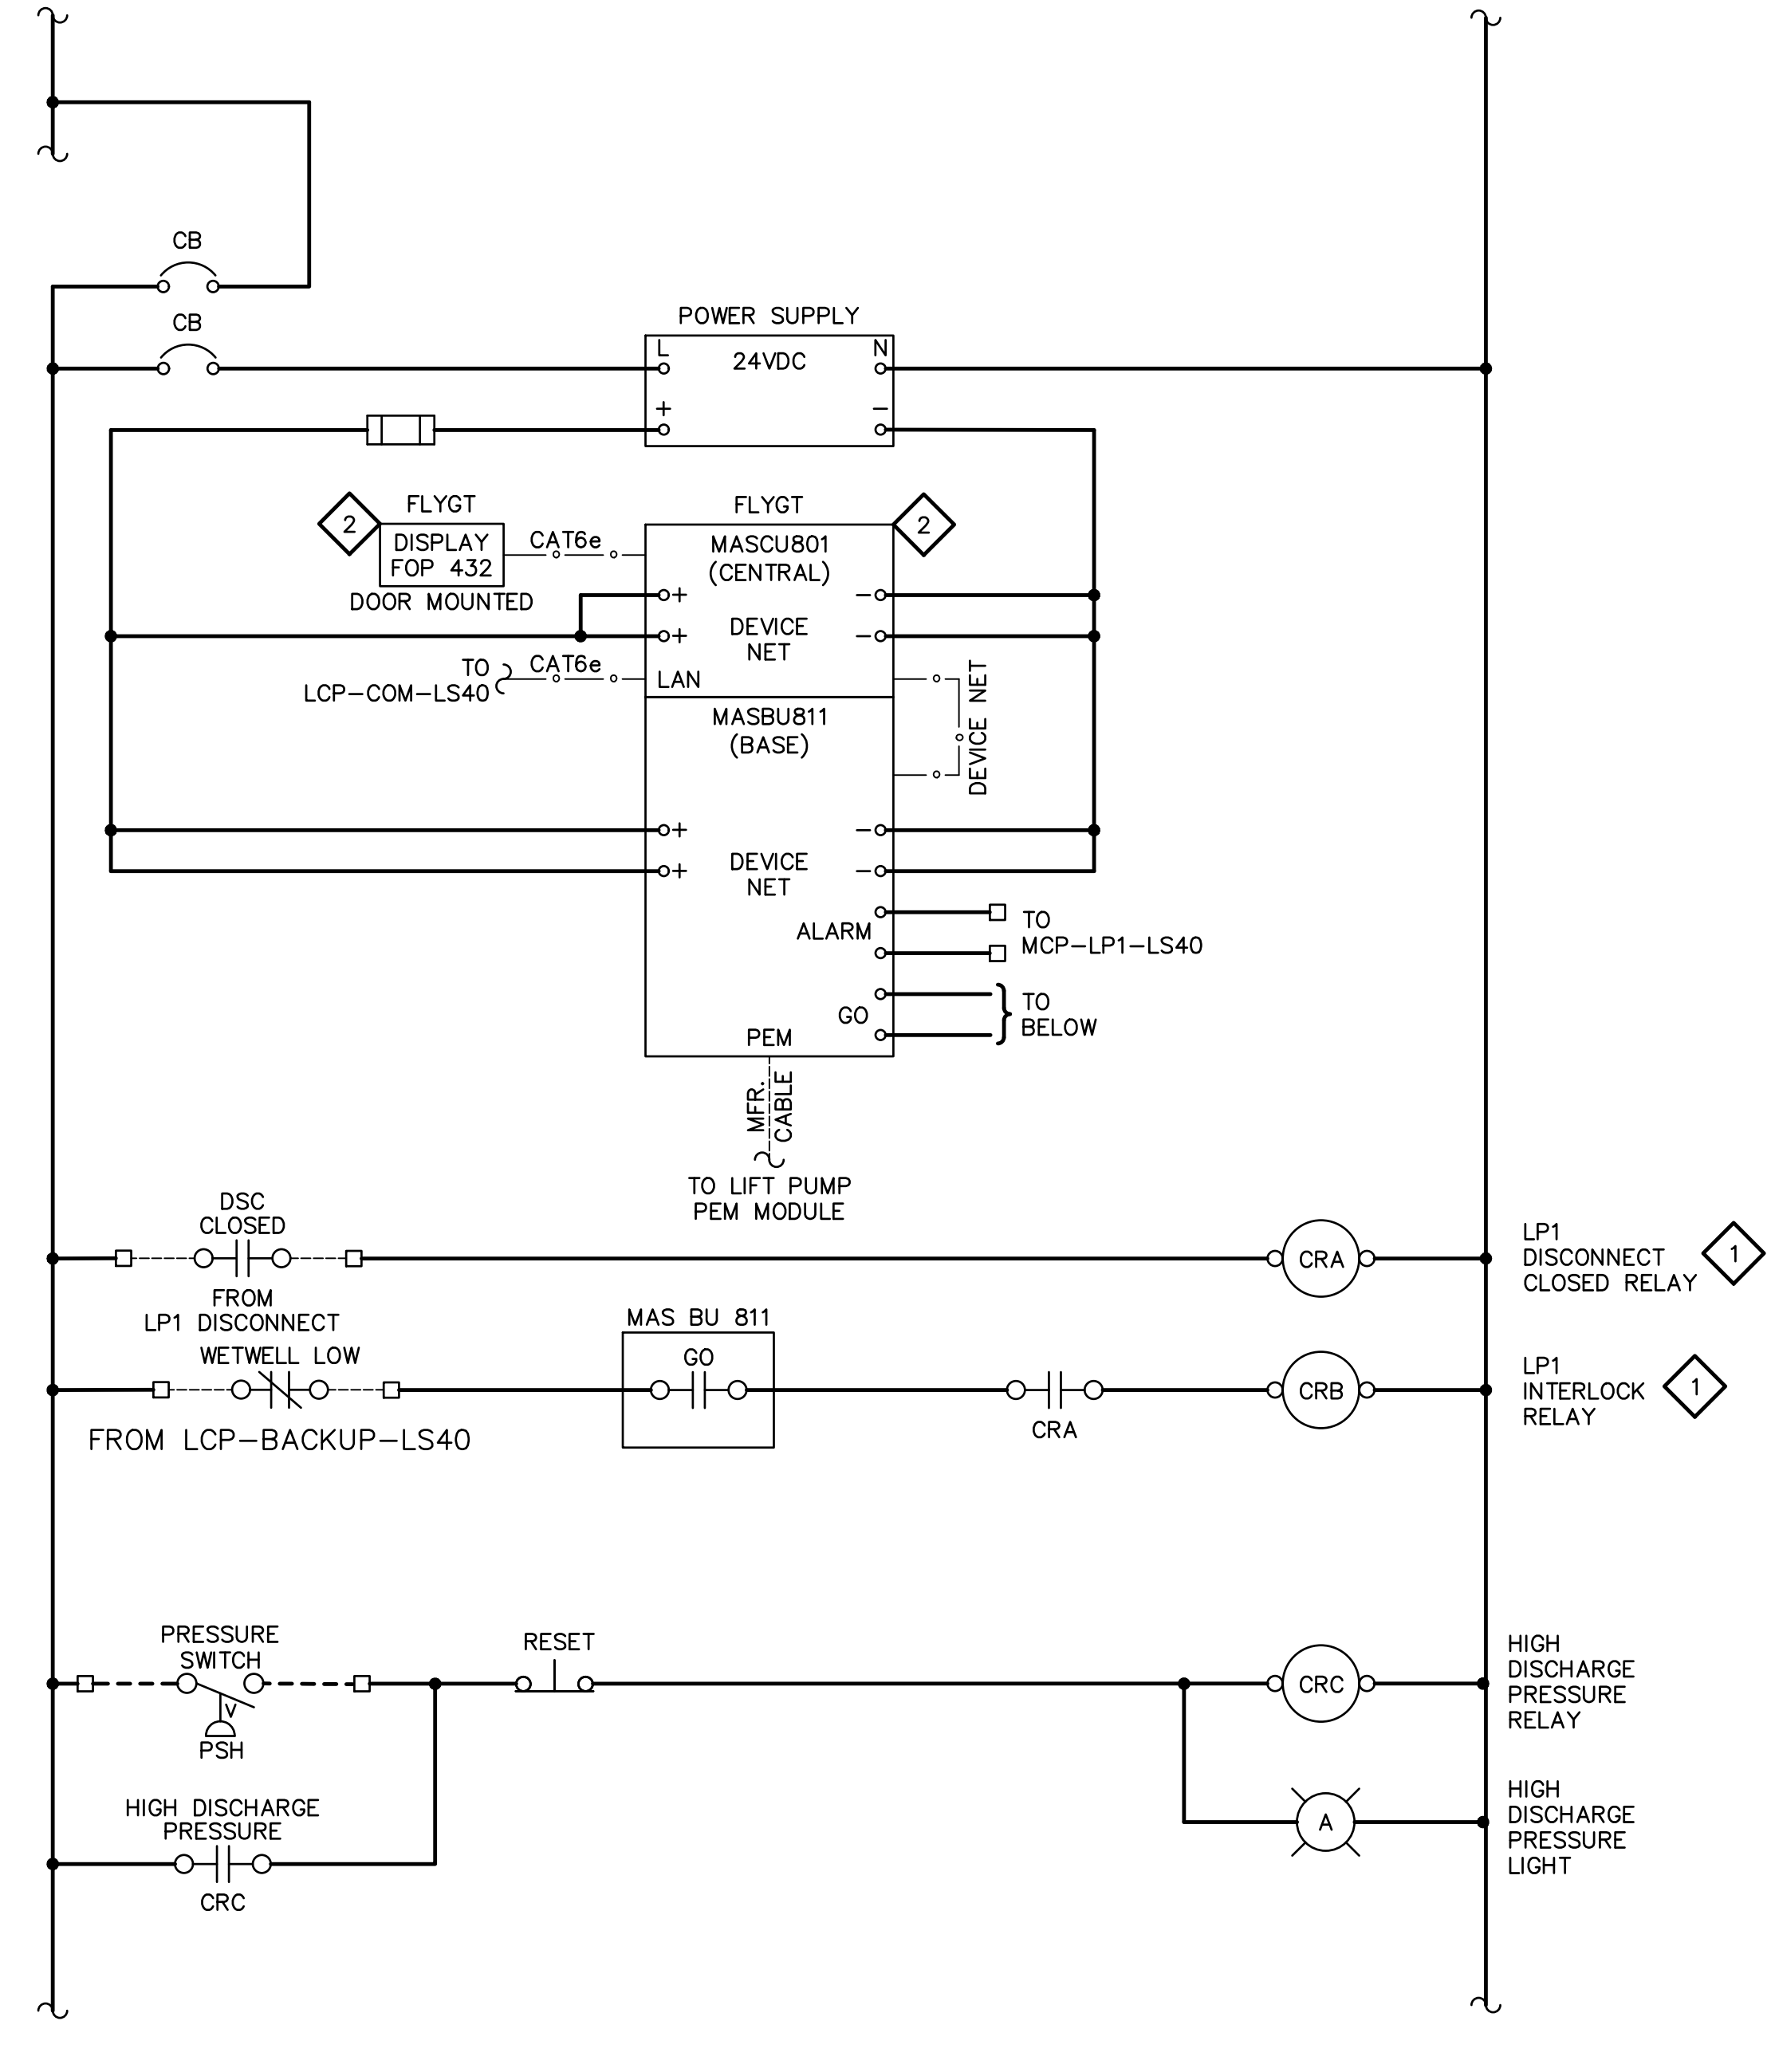

DETAIL A CONTROL SCHEMATIC LCP-PCP-LS40

**IMPORTANT NOTE:**  
1. THE CONTROL SCHEMATICS SHOWN HERE INDICATE THE CONTROL STRATEGY FOR THE SHOWN EQUIPMENT AND DEVICES. THE CONTRACTOR SHALL SUBMIT 17260 WIRING DIAGRAMS INDICATIVE OF THE ACTUAL EQUIPMENT AND DEVICES BEING INSTALLED.



FACILITY DRAWINGS  
This drawing was supplied by a Consultant Engineer from a past construction project. The original constructor drawing was modified based on information provided by the Contractor to provide the Record Drawing. The City does not warrant the accuracy of the drawings and accurate portrayal of facilities as they exist in the field.

REVISION	DATE	CAD FILE NAME	REMARKS

THIS DRAWING MUST BE FIELD VERIFIED BEFORE USE  
DRAWING NOT TO SCALE UNLESS SCALE BAR IS PRESENT

FOR CONSTRUCTION

"PER CITY OF PHOENIX CODE CHAPTER 2, SECTION 2-28, THESE PLANS ARE FOR OFFICIAL USE ONLY AND MAY NOT BE SHARED WITH OTHERS EXCEPT AS REQUIRED TO FULFILL THE OBLIGATIONS OF THE CONTRACTOR'S CONTRACT WITH THE CITY OF PHOENIX."  
THIS DOCUMENT MUST BE KEPT SECURE AT ALL TIMES.

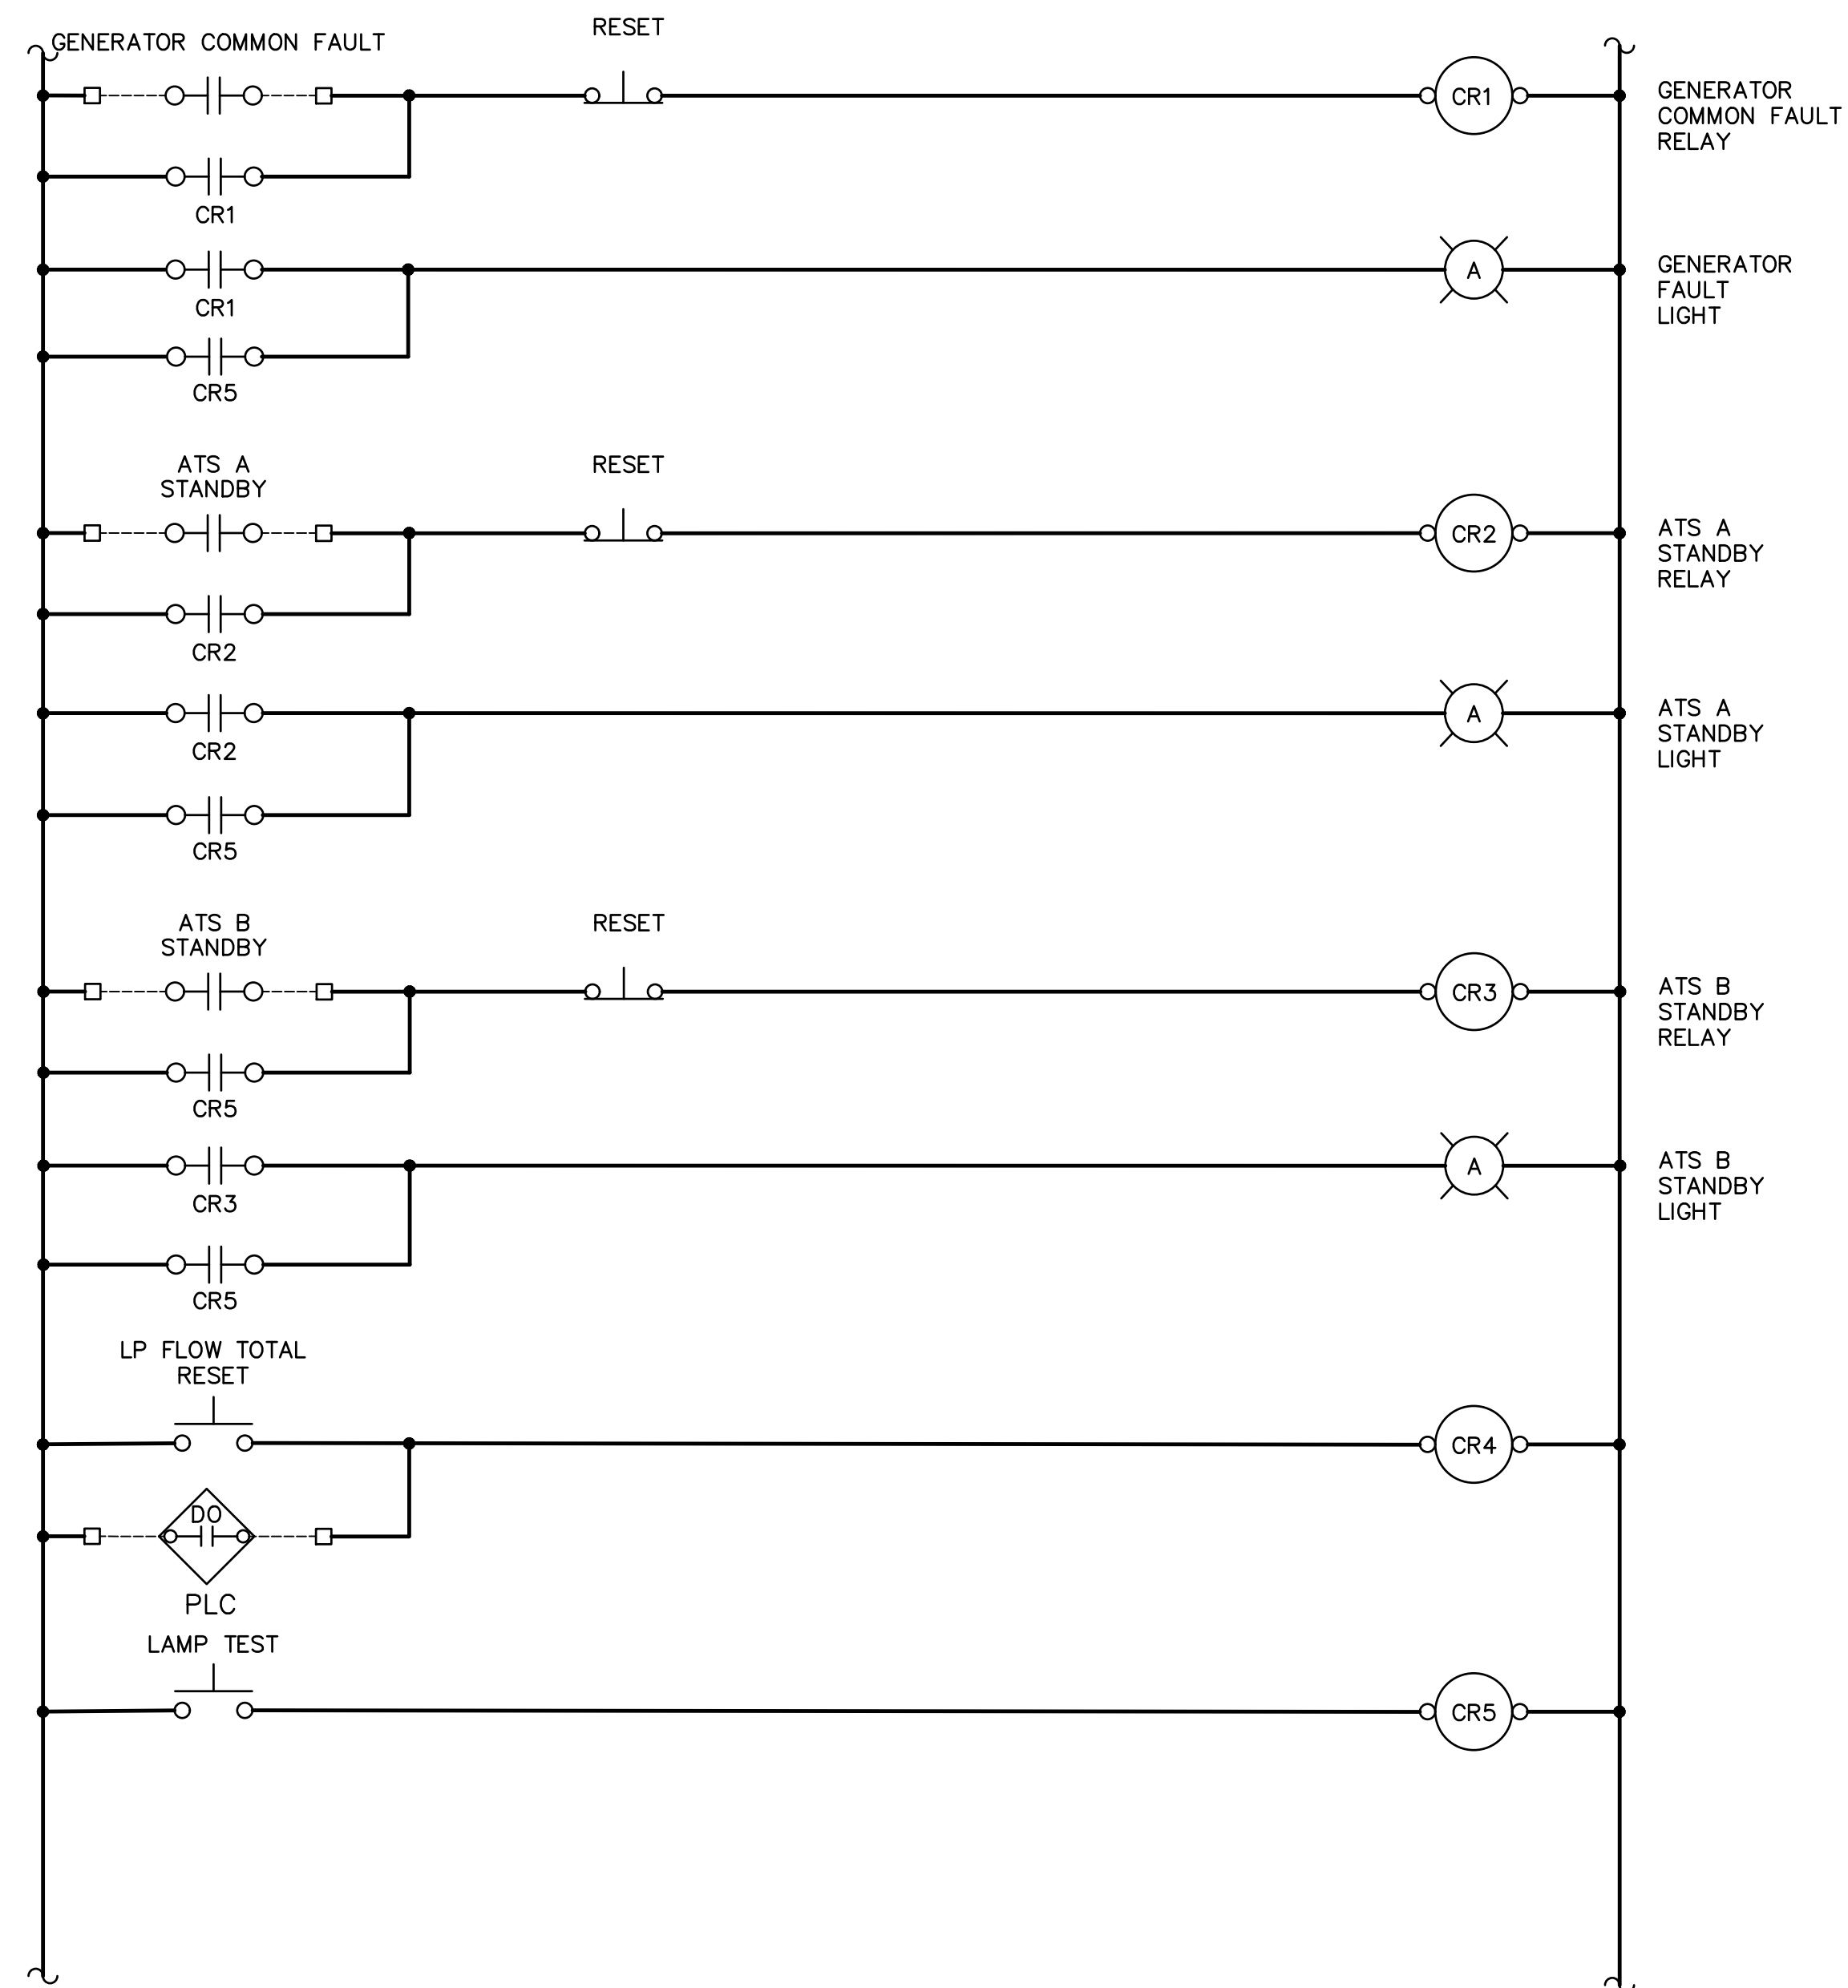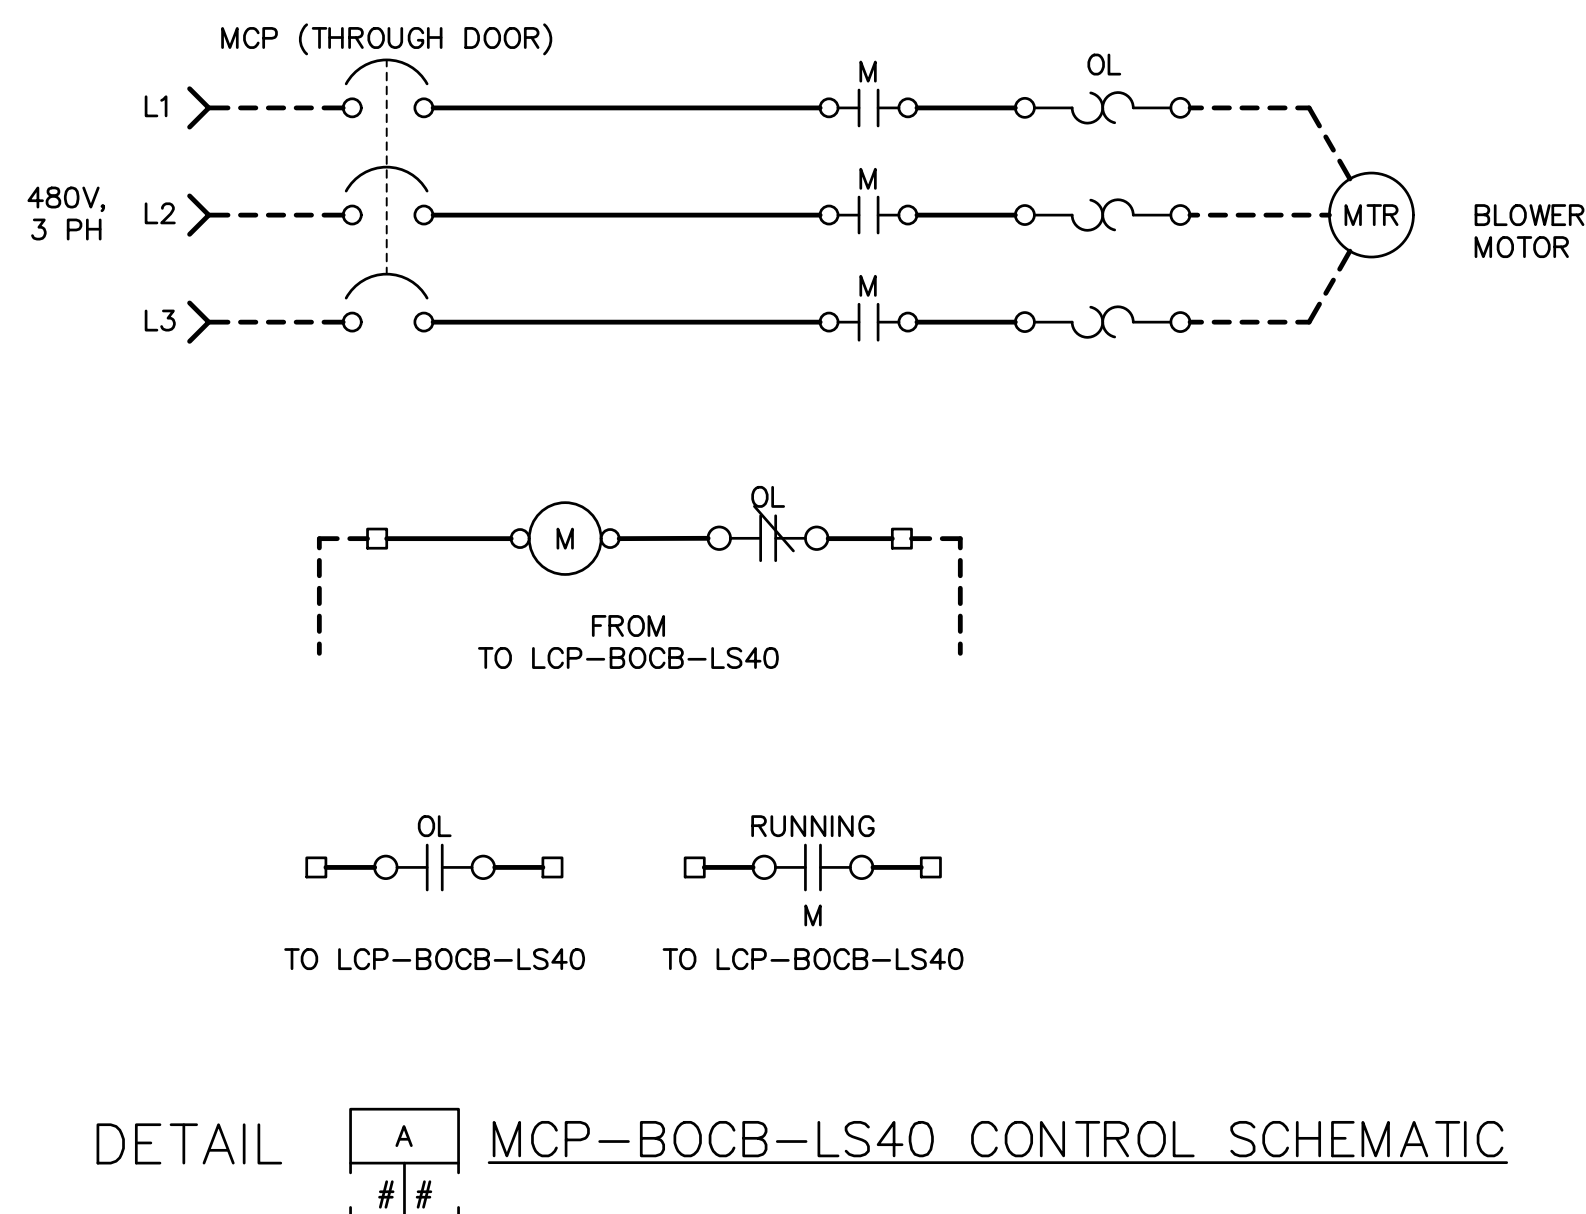

**GENERAL NOTES:**

- FOR REFERENCE ONLY. CONTRACTOR TO LAYOUT AND DESCRIBE PER 17260 SPECIFICATIONS.
- THIS DRAWING DOES NOT INDICATE ALL THE PROJECT REQUIREMENTS. THE PROJECT REQUIREMENTS ARE INDICATED IN VARIOUS ELECTRICAL AND INSTRUMENTATION DRAWINGS AND SPECIFICATIONS. ALL DOCUMENTS MUST BE CAREFULLY INSPECTED AND GATHERED TOGETHER IN ORDER TO INCLUDE THE COLLECTIVE REQUIREMENTS FOR THIS PROJECT.
- WHERE DISCREPANCIES EXIST AMONG VARIOUS DRAWINGS AND/OR SPECIFICATIONS, THE CONTRACTOR SHALL INCLUDE THE ITEM WITH THE MOST STRINGENT REQUIREMENT. FOR EXAMPLE, THE MOST LABORIOUS INSTALLATION, THE LARGER CONDUCTOR AND CONDUIT, THE HIGHER RATING DEVICE AND EQUIPMENT, THE FURTHER DISTANCE, ETC...
- THE CONTROL SCHEMATICS ARE SHOWN TO FURTHER CONVEY THE DESIGN INTENT AND CONTROL STRATEGY FOR THE SHOWN EQUIPMENT AND DEVICES. THE CONTRACTOR SHALL DESIGN WIRING DIAGRAMS BY INCORPORATING THE CONTROL SCHEMATICS HEREIN, THE P&IDS, CONTROL STRATEGIES, AND INCORPORATING THE ACTUAL SUBMITTED EQUIPMENT AND DEVICES.
- WHEN THE CONTROL SCHEMATICS ARE EXISTING AND WE ARE MODIFYING THEM: THE CONTRACTOR SHALL ALLOW 16 HOURS BY A PROFICIENT CONTROL ELECTRICIAN TO AS-BUILD THE CONTROLS ASSOCIATED WITH THIS CONTROL SCHEMATIC. THE AS-BUILT CONTROL SCHEMATIC SHOULD BE SKETCHED AND SUBMITTED TO THE ENGINEER FOR FURTHER MODIFICATION IF NECESSARY.
- THE TEMPORARY CONTROLS WILL HAVE TO BE AS-BUILT BY THE CONTRACTOR AND SHALL BE OF THE EXISTING EQUIPMENT BEING DUPLICATED.

**IMPORTANT NOTE:**  
1. THE CONTROL SCHEMATICS SHOWN HERE INDICATE THE CONTROL STRATEGY FOR THE SHOWN EQUIPMENT AND DEVICES. THE CONTRACTOR SHALL SUBMIT 17260 WIRING DIAGRAMS INDICATIVE OF THE ACTUAL EQUIPMENT AND DEVICES BEING INSTALLED.

FACILITY DRAWINGS  
This drawing was supplied by a Consultant Engineer from a past construction project. The original contractor drawing was modified based on information provided by the Contractor to provide the Record Drawing. The City does not warrant the accuracy and reliability of any and all data and/or portrayal of facilities as they exist in the field.

REVISION	DATE	CAD FILE NAME	DWG NUMBER	REMARKS



			NO.	BY	DATE	CKD	REVISIONS	REMARKS	DES		CITY OF PHOENIX WATER SERVICES DEPARTMENT  LIFT STATION 40 REFURBISHMENT	ELECTRICAL  CONTROL SCHEMATIC - 3	COPYRIGHT © 2007-JANUARY
										City of Phoenix	CONTROL SCHEMATIC - 3	DATE: 08/2024 <b>E-21</b> SHEET 112 OF 134 CAD FILE: CSELS40ES03.dwg	



THIS DRAWING MUST BE FIELD VERIFIED BEFORE USE  
DRAWING NOT TO SCALE UNLESS SCALE BAR IS PRESENT

FOR CONSTRUCTION


"PER CITY OF PHOENIX CODE CHAPTER 2, SECTION 2-28, THESE PLANS ARE FOR OFFICIAL USE ONLY AND MAY NOT BE SHARED WITH OTHERS EXCEPT AS REQUIRED TO FULFILL THE OBLIGATIONS OF THE CONTRACTOR'S CONTRACT WITH THE CITY OF PHOENIX."  
THIS DOCUMENT MUST BE KEPT SECURE AT ALL TIMES.

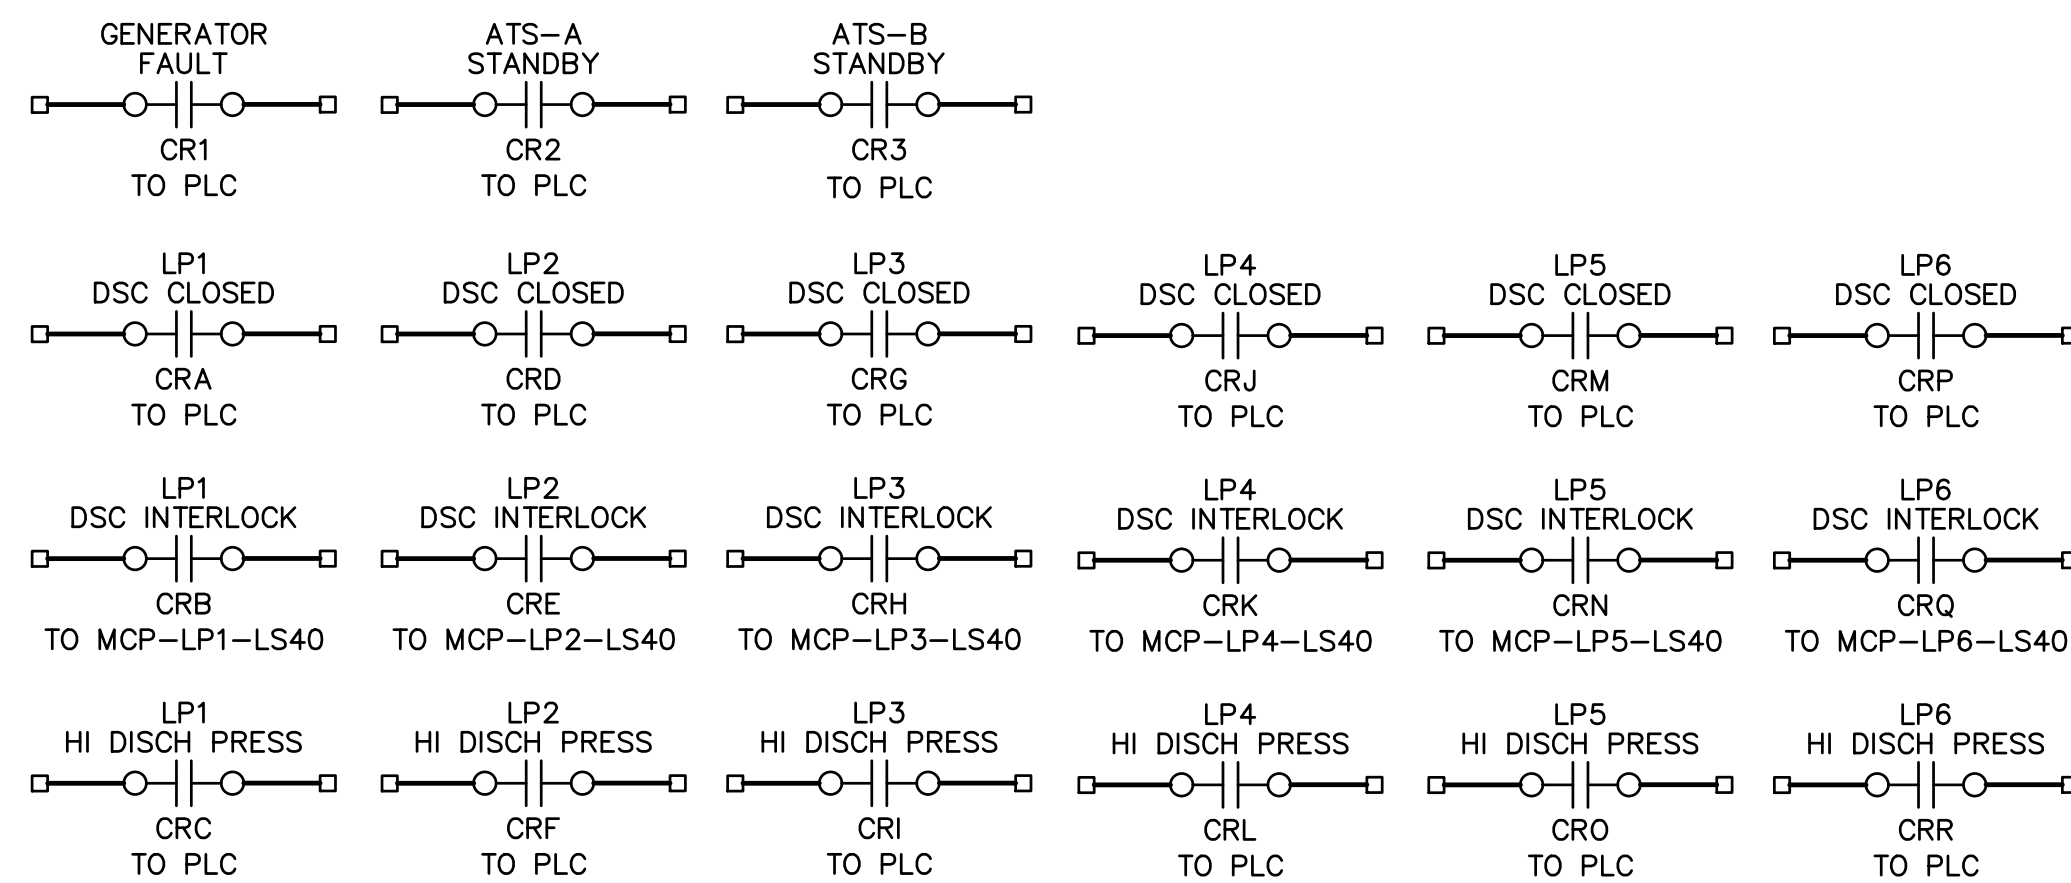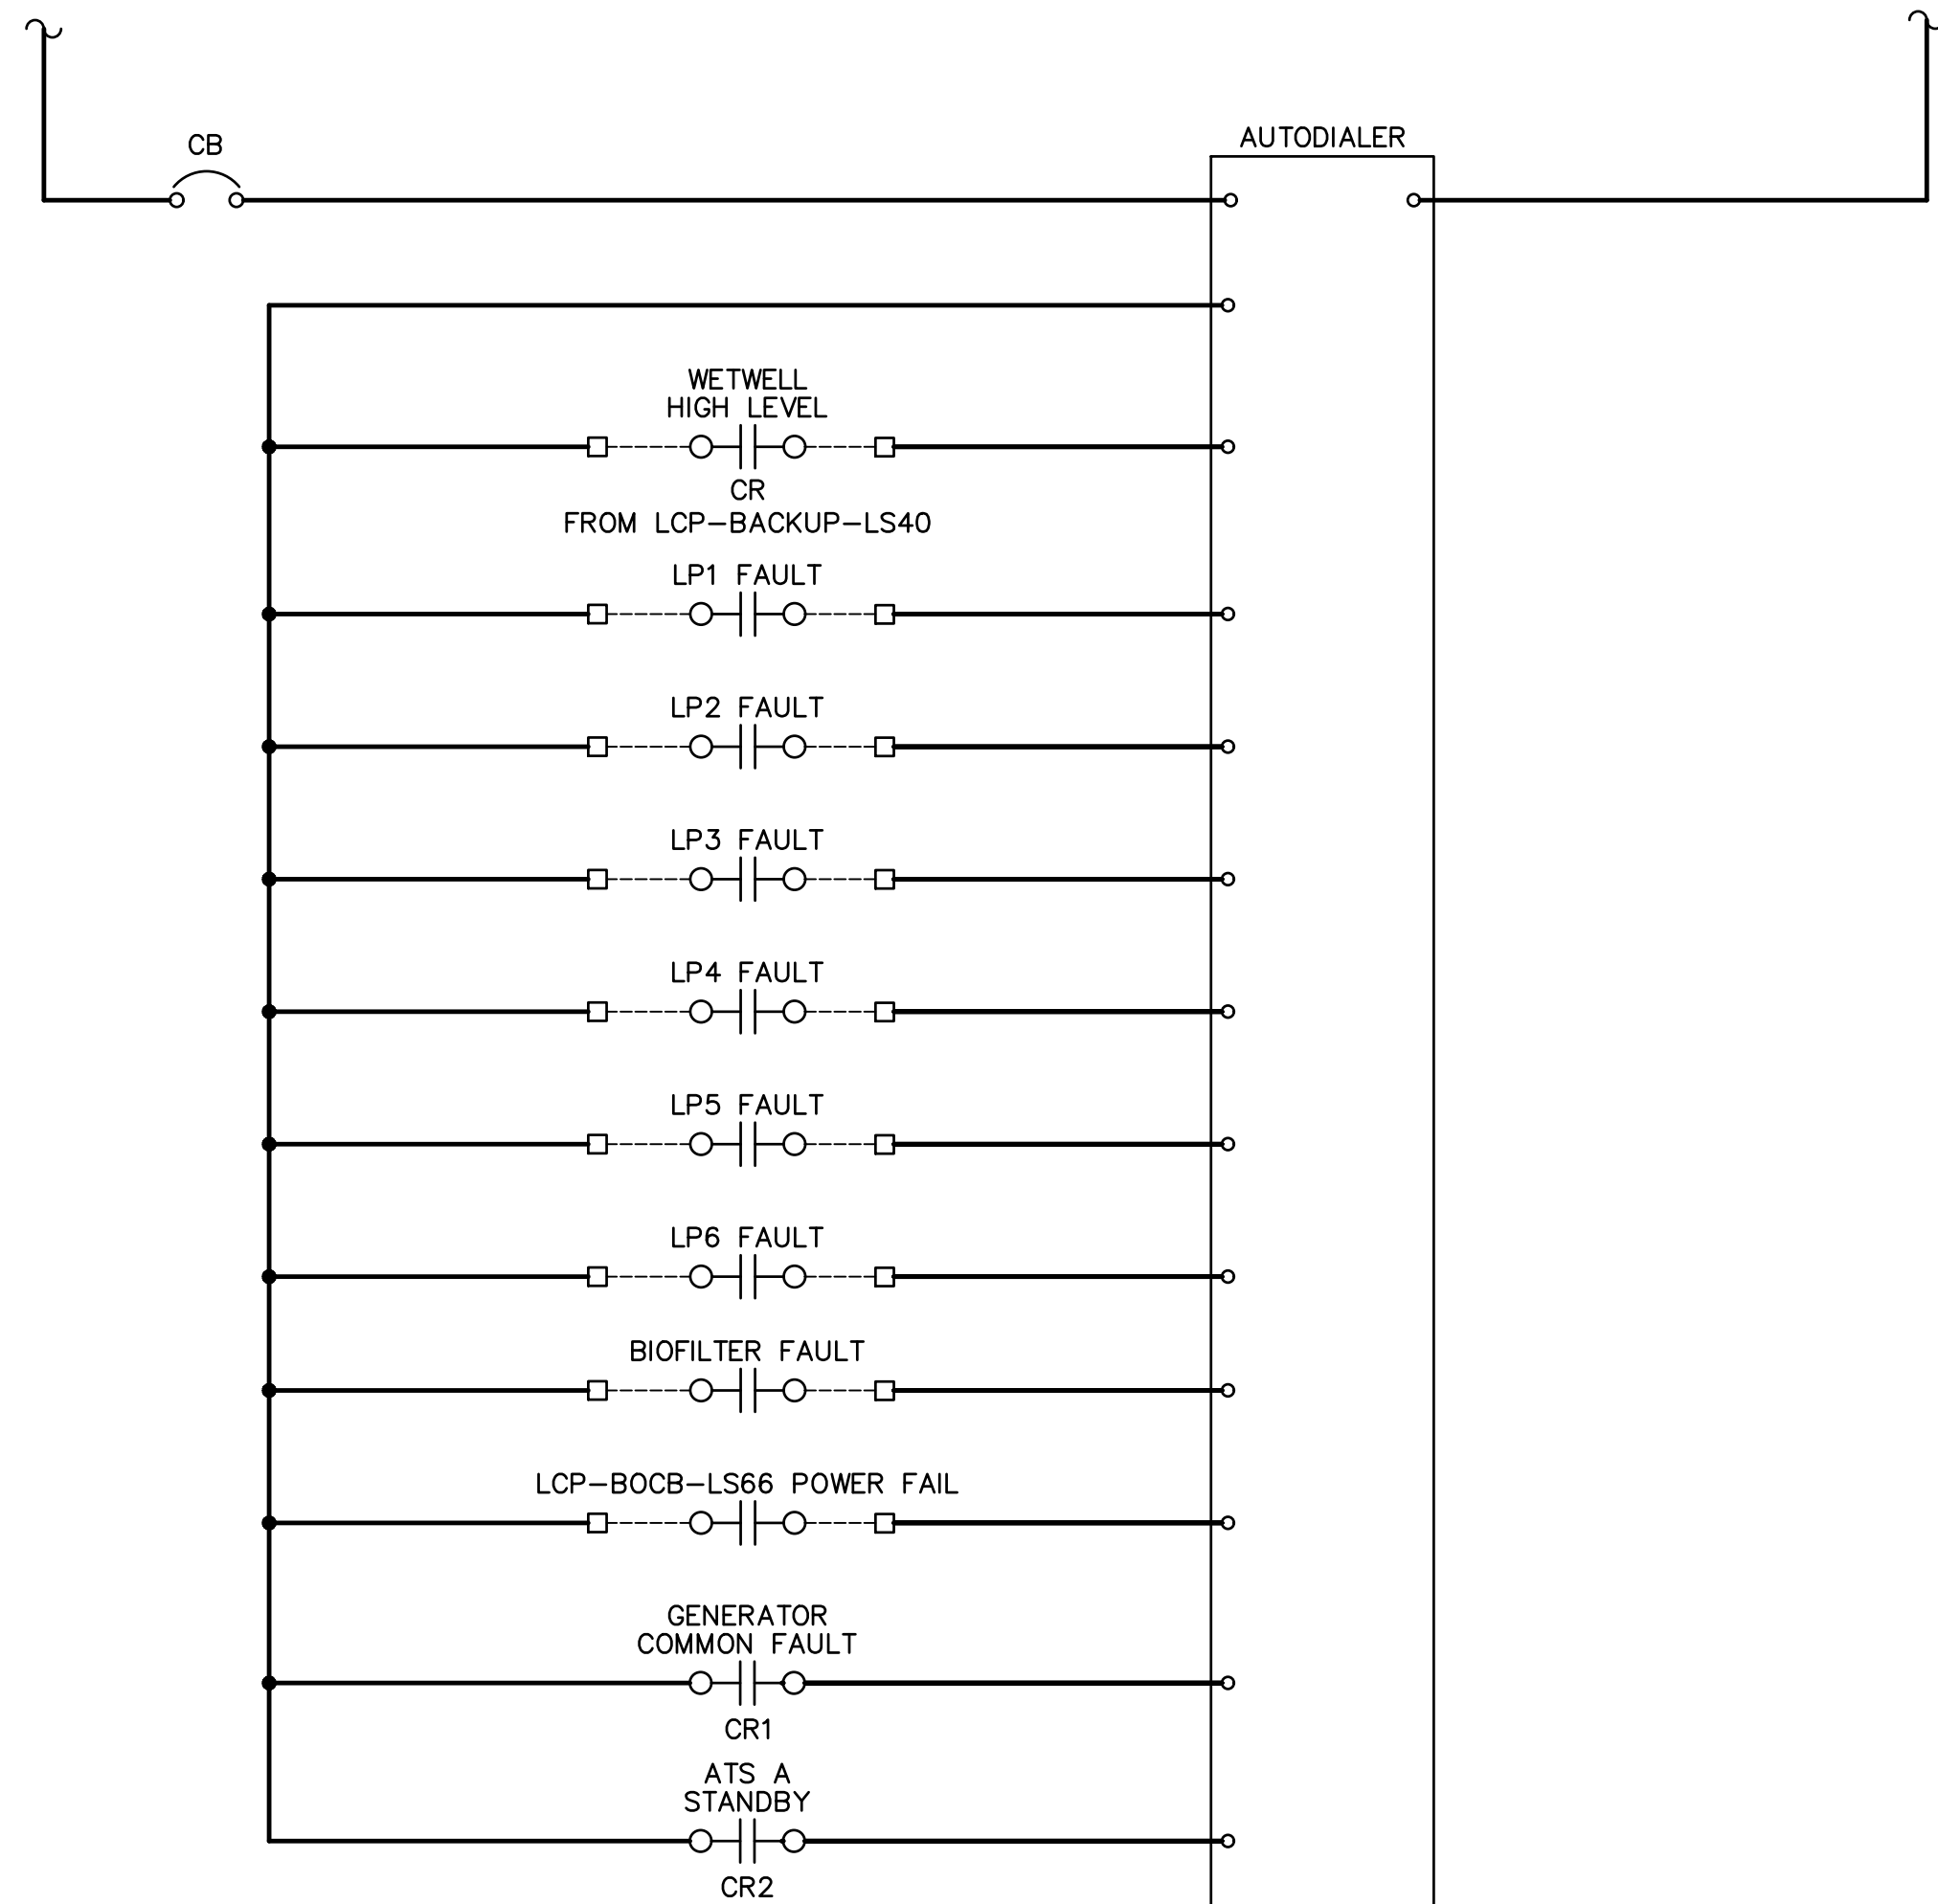

DETAIL A CONTROL SCHEMATIC LCP-PCP-LS40  
# # TYPICAL

GENERAL NOTES:

- FOR REFERENCE ONLY. CONTRACTOR TO LAYOUT AND DESCRIBE PER 17260 SPECIFICATIONS.
- THIS DRAWING DOES NOT INDICATE ALL THE PROJECT REQUIREMENTS. THE PROJECT REQUIREMENTS ARE INDICATED IN VARIOUS ELECTRICAL AND INSTRUMENTATION DRAWINGS AND SPECIFICATIONS. ALL DOCUMENTS MUST BE CAREFULLY INSPECTED AND GATHERED TOGETHER IN ORDER TO INCLUDE THE COLLECTIVE REQUIREMENTS FOR THIS PROJECT.
- WHERE DISCREPANCIES EXIST AMONG VARIOUS DRAWINGS AND/OR SPECIFICATIONS, THE CONTRACTOR SHALL INCLUDE THE ITEM WITH THE MOST STRINGENT REQUIREMENT. FOR EXAMPLE, THE MOST LABORIOUS INSTALLATION, THE LARGER CONDUCTOR AND CONDUIT, THE HIGHER RATING DEVICE AND EQUIPMENT, THE FURTHER DISTANCE, ETC...
- THE CONTROL SCHEMATICS ARE SHOWN TO FURTHER CONVEY THE DESIGN INTENT AND CONTROL STRATEGY FOR THE SHOWN EQUIPMENT AND DEVICES. THE CONTRACTOR SHALL DESIGN WIRING DIAGRAMS BY INCORPORATING THE CONTROL SCHEMATICS HEREIN, THE P&IDS, CONTROL STRATEGIES, AND INCORPORATING THE ACTUAL SUBMITTED EQUIPMENT AND DEVICES.
- WHEN THE CONTROL SCHEMATICS ARE EXISTING AND WE ARE MODIFYING THEM: THE CONTRACTOR SHALL ALLOW 16 HOURS BY A PROFICIENT CONTROL ELECTRICIAN TO AS-BUILD THE CONTROLS ASSOCIATED WITH THIS CONTROL SCHEMATIC. THE AS-BUILT CONTROL SCHEMATIC SHOULD BE SKETCHED AND SUBMITTED TO THE ENGINEER FOR FURTHER MODIFICATION IF NECESSARY.
- THE TEMPORARY CONTROL WILL HAVE TO BE AS-BUILT BY THE CONTRACTOR AND SHALL BE OF THE EXISTING EQUIPMENT BEING DUPLICATED.

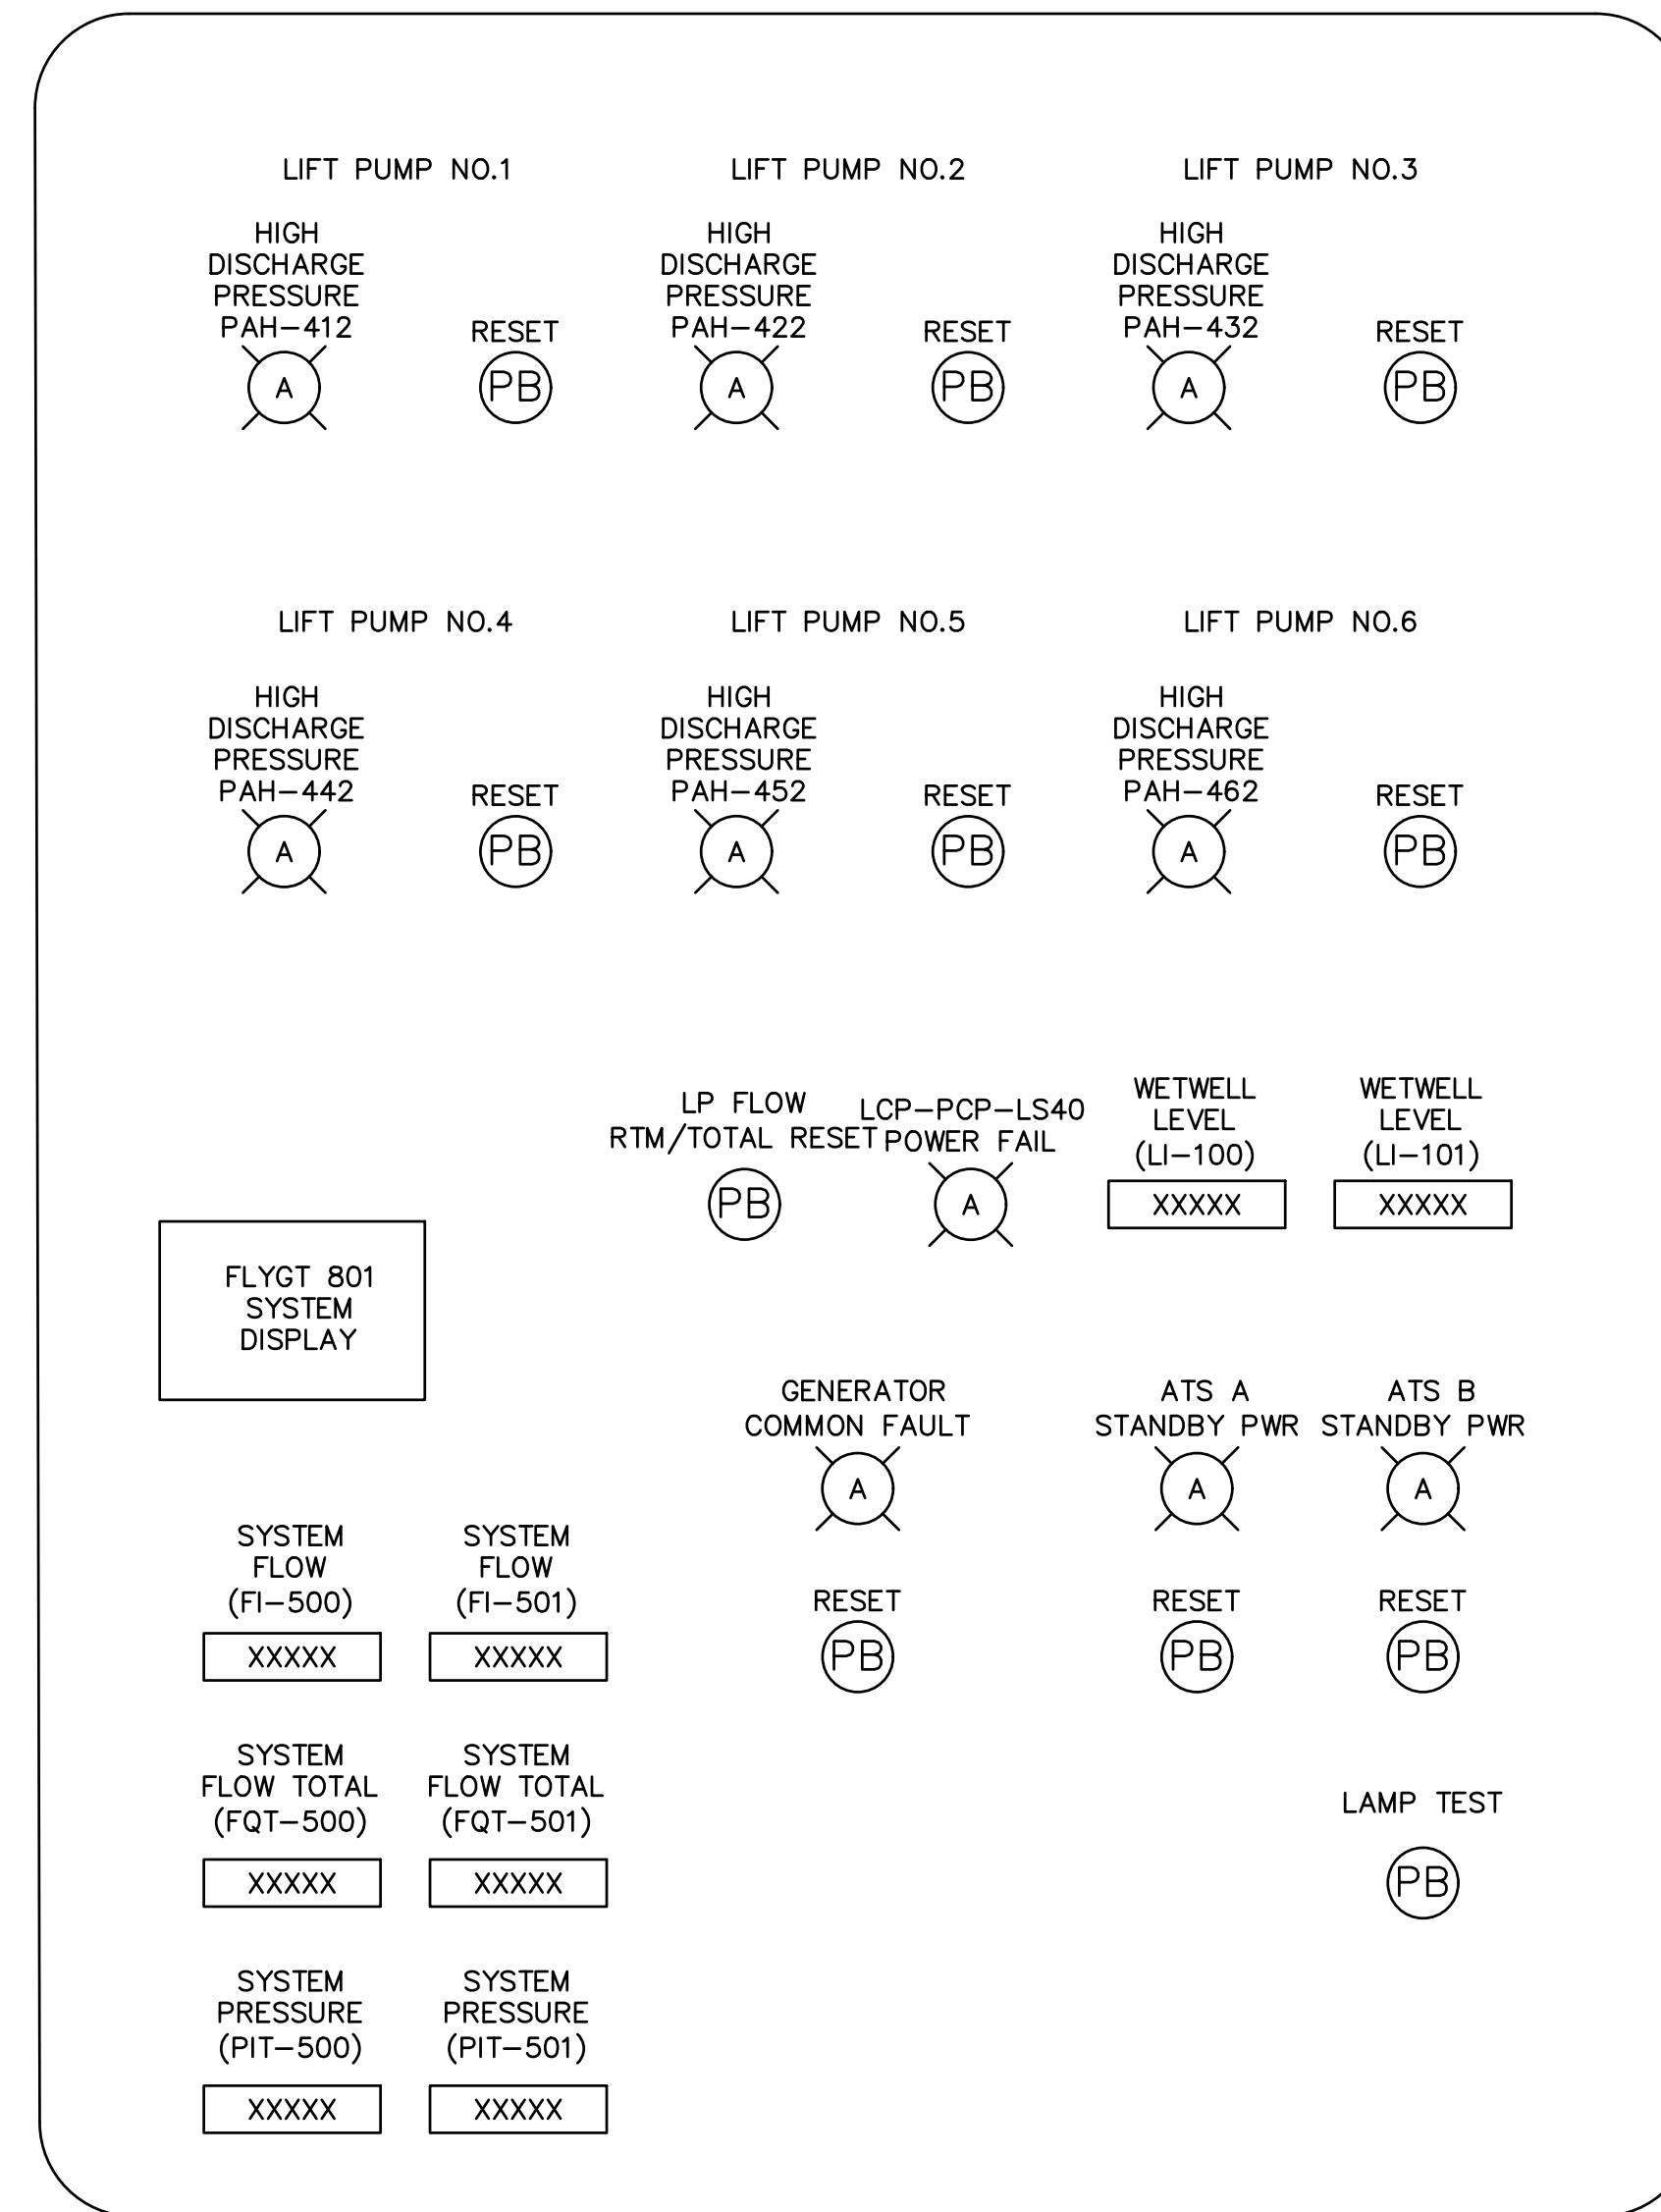

DETAIL B LCP-PCP-LS40 SWING-OUT PANEL ELEVATION  
# # SCALE: N.T.S.

IMPORTANT NOTE:

- THE CONTROL SCHEMATICS SHOWN HERE INDICATE THE CONTROL STRATEGY FOR THE SHOWN EQUIPMENT AND DEVICES. THE CONTRACTOR SHALL SUBMIT 17260 WIRING DIAGRAMS INDICATIVE OF THE ACTUAL EQUIPMENT AND DEVICES BEING INSTALLED.

FACILITY DRAWINGS  
This drawing was supplied by a Consultant Engineer from a past construction project. The original contractor drawing was modified based on information provided by the Contractor to provide the Record Drawing. The City does not warrant the accuracy and reliability of the drawings and any portrayal of facilities as they exist in the field.

REVISION	DWG NUMBER	CAD FILE NAME	DATE	PROJECT NAME	PROJECT NO.	REFERENCE CID NUMBER	REMARKS



REVISIONS				
NO.	BY	DATE	CKD	REMARKS

DES RB  
DWN BB  
CKD  
VB



CITY OF PHOENIX  
WATER SERVICES DEPARTMENT

LIFT STATION 40  
REFURBISHMENT

ELECTRICAL

CONTROL SCHEMATIC - 4

COPYRIGHT © 2007-JANUARY

CITY PROJECT NO. WS90400085

DATE: 08/2024



E-22 SHEET 113 OF 134

CAD FILE: CSELS40ES04.dwg


THIS DRAWING MUST BE FIELD VERIFIED BEFORE USE  
DRAWING NOT TO SCALE UNLESS SCALE BAR IS PRESENT

FOR CONSTRUCTION

\*PER CITY OF PHOENIX CODE CHAPTER 2, SECTION 2-28, THESE PLANS ARE FOR OFFICIAL USE ONLY AND MAY NOT BE SHARED WITH OTHERS EXCEPT AS REQUIRED TO FULFILL THE OBLIGATIONS OF THE CONTRACTOR'S CONTRACT WITH THE CITY OF PHOENIX. THIS DOCUMENT MUST BE KEPT SECURE AT ALL TIMES.

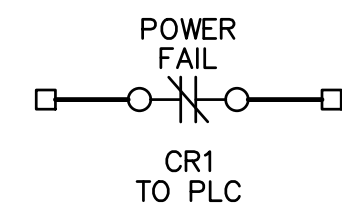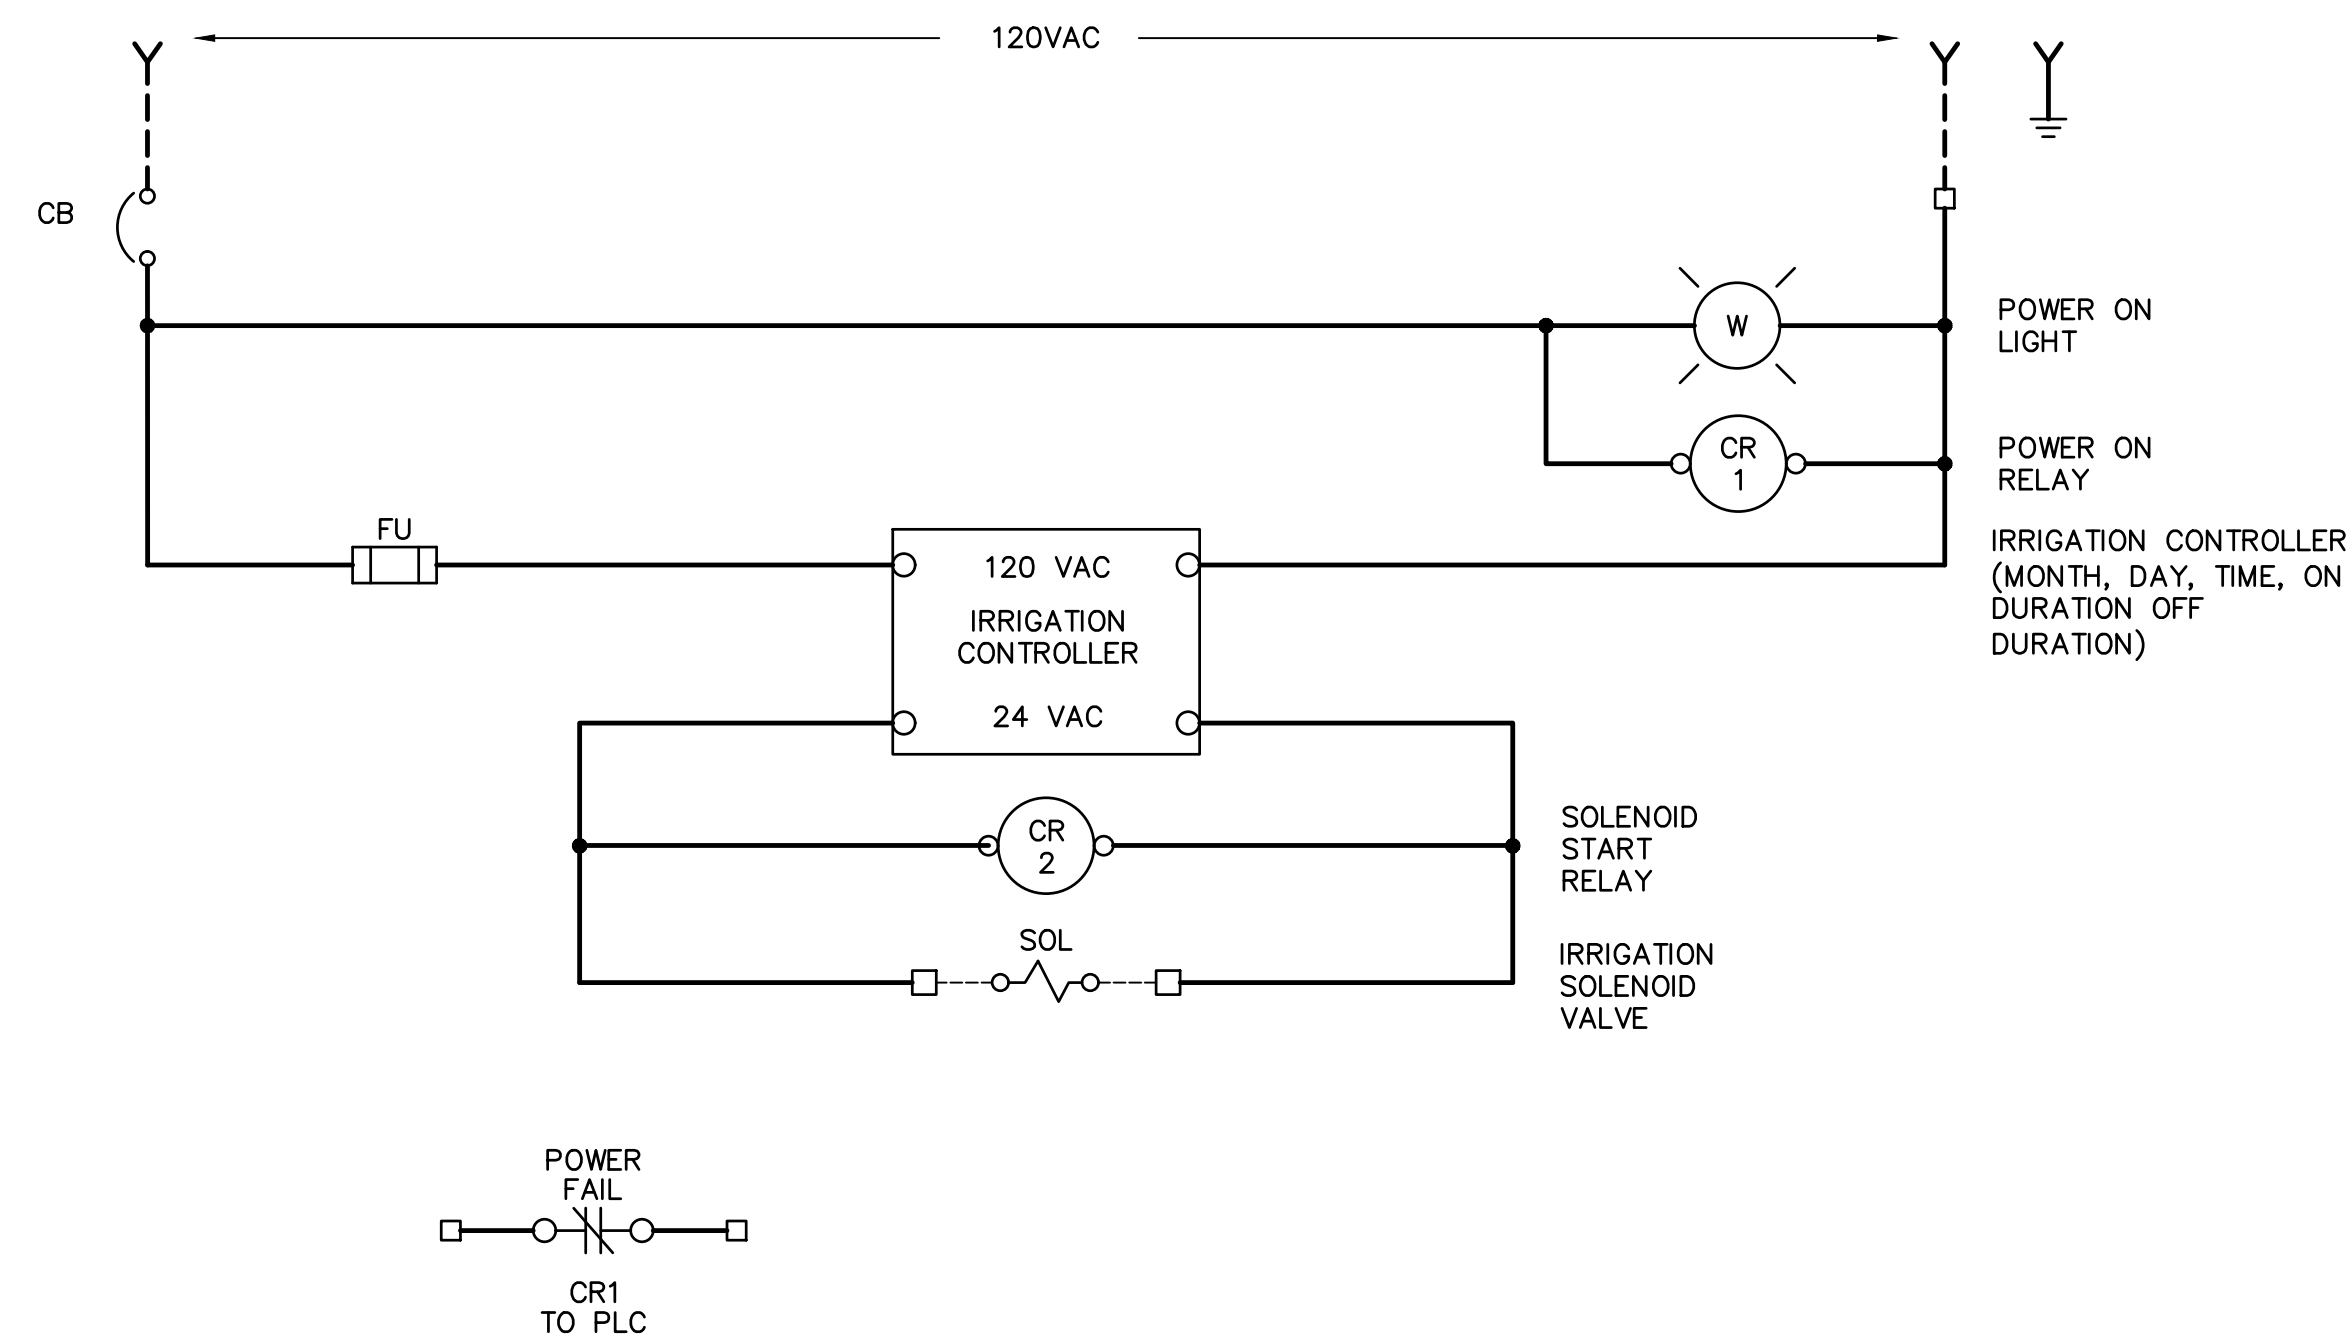

DETAIL A CONTROL SCHEMATIC LCP-IBS-LS40  
# # TYPICAL

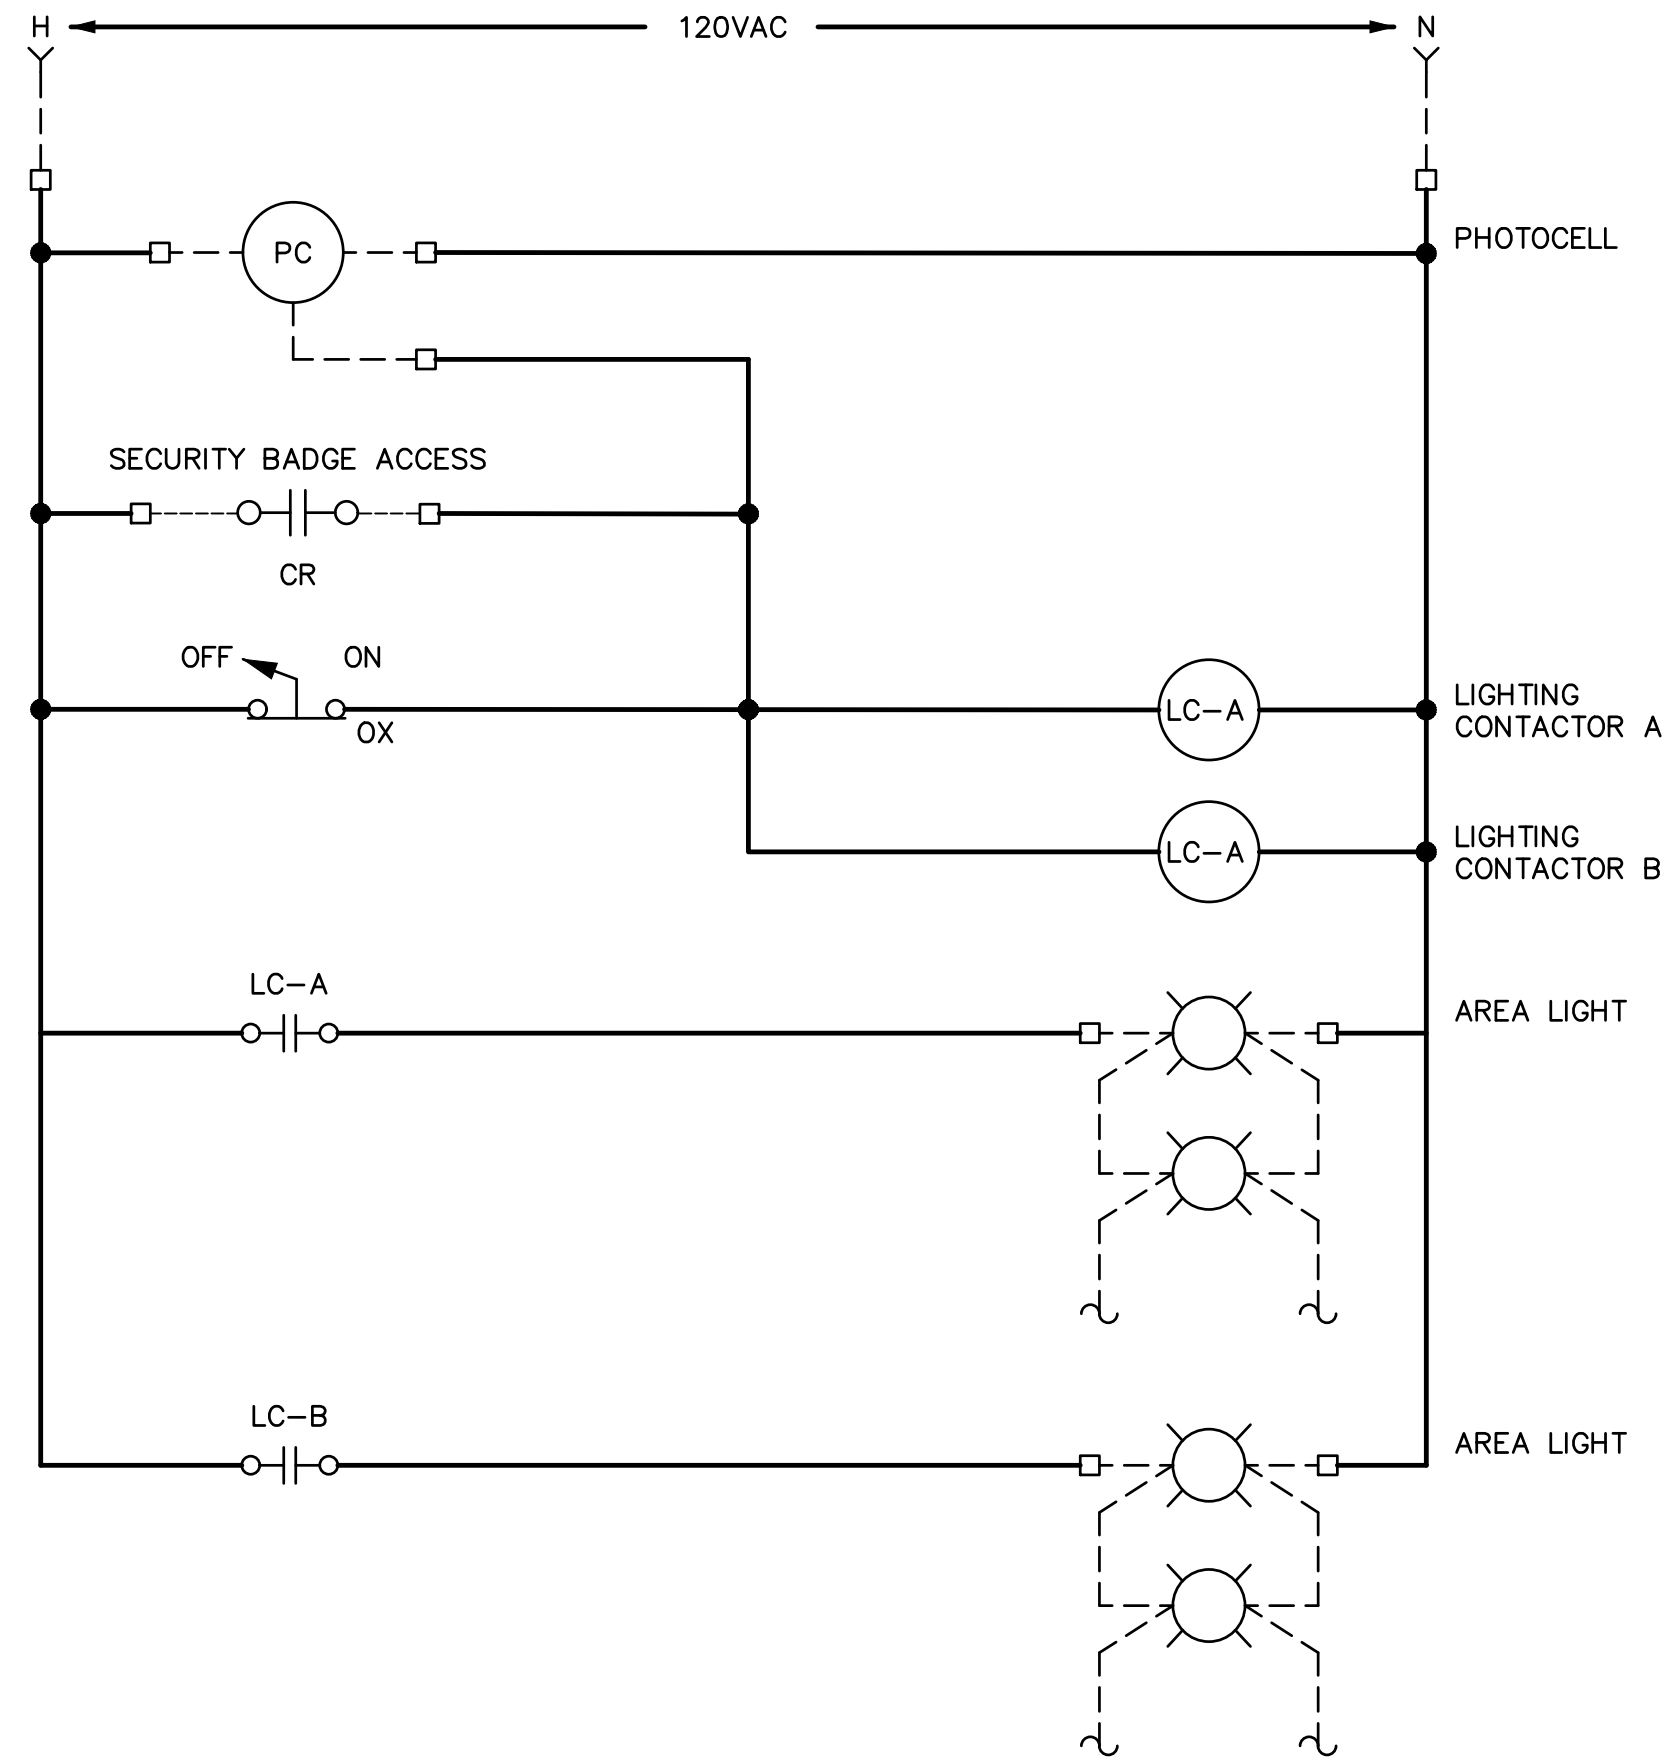

DETAIL B ALCP-LS40  
# # N.T.S.

GENERAL NOTES:


- FOR REFERENCE ONLY. CONTRACTOR TO LAYOUT AND DESCRIBE PER 17260 SPECIFICATIONS.
- THIS DRAWING DOES NOT INDICATE ALL THE PROJECT REQUIREMENTS. THE PROJECT REQUIREMENTS ARE INDICATED IN VARIOUS ELECTRICAL AND INSTRUMENTATION DRAWINGS AND SPECIFICATIONS. ALL DOCUMENTS MUST BE CAREFULLY INSPECTED AND GATHERED TOGETHER IN ORDER TO INCLUDE THE COLLECTIVE REQUIREMENTS FOR THIS PROJECT.
- WHERE DISCREPANCIES EXIST AMONG VARIOUS DRAWINGS AND/OR SPECIFICATIONS, THE CONTRACTOR SHALL INCLUDE THE ITEM WITH THE MOST STRINGENT REQUIREMENT. FOR EXAMPLE, THE MOST LABORIOUS INSTALLATION, THE LARGER CONDUCTOR AND CONDUIT, THE HIGHER RATING DEVICE AND EQUIPMENT, THE FURTHER DISTANCE, ETC...
- THE CONTROL SCHEMATICS ARE SHOWN TO FURTHER CONVEY THE DESIGN INTENT AND CONTROL STRATEGY FOR THE SHOWN EQUIPMENT AND DEVICES. THE CONTRACTOR SHALL DESIGN WIRING DIAGRAMS BY INCORPORATING THE CONTROL SCHEMATICS HEREIN, THE P&IDS, CONTROL STRATEGIES, AND INCORPORATING THE ACTUAL SUBMITTED EQUIPMENT AND DEVICES.
- WHEN THE CONTROL SCHEMATICS ARE EXISTING AND WE ARE MODIFYING THEM: THE CONTRACTOR SHALL ALLOW 16 HOURS BY A PROFICIENT CONTROL ELECTRICIAN TO AS-BUILD THE CONTROLS ASSOCIATED WITH THIS CONTROL SCHEMATIC. THE AS-BUILT CONTROL SCHEMATIC SHOULD BE SKETCHED AND SUBMITTED TO THE ENGINEER FOR FURTHER MODIFICATION IF NECESSARY.
- THE TEMPORARY CONTROLS WILL HAVE TO BE AS-BUILT BY THE CONTRACTOR AND SHALL BE OF THE EXISTING EQUIPMENT BEING DUPLICATED.

IMPORTANT NOTE:


- THE CONTROL SCHEMATICS SHOWN HERE INDICATE THE CONTROL STRATEGY FOR THE SHOWN EQUIPMENT AND DEVICES. THE CONTRACTOR SHALL SUBMIT 17260 WIRING DIAGRAMS INDICATIVE OF THE ACTUAL EQUIPMENT AND DEVICES BEING INSTALLED.

FACILITY DRAWINGS  
This drawing was supplied by a Consultant Engineer from a past construction project. The original contractor drawing was modified based on information provided by the Contractor to provide the Record Drawing. The City does not warrant the accuracy and reliability of the information and accuracy of the drawings as they exist in the field.

REVISION	ENGINEERING COMPANY	PROJECT NO.	PROJECT NAME	DATE	CAD FILE NAME	DWG NUMBER	REMARKS

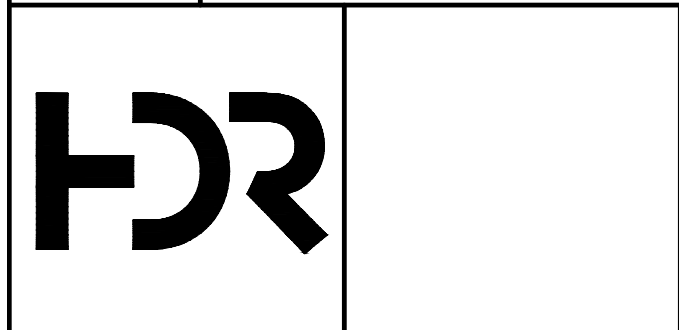

REVISIONS					
NO.	BY	DATE	CKD	REMARKS	

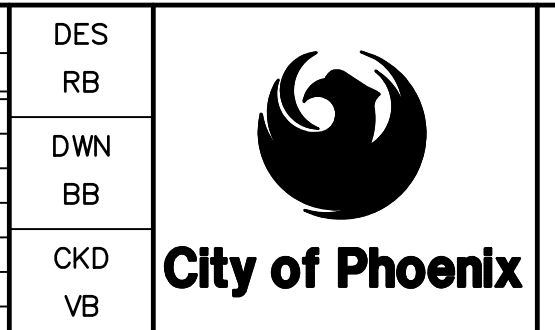

CITY OF PHOENIX  
WATER SERVICES DEPARTMENT  
  
LIFT STATION 40  
REFURBISHMENT


ELECTRICAL  
  
CONTROL SCHEMATIC - 5

COPYRIGHT © 2007-JANUARY  
CITY PROJECT NO. WS90400085  
DATE: 08/2024  
E-23 SHEET 114 OF 134  
CAD FILE: CSELS40ES05.dwg

THIS DRAWING MUST BE FIELD VERIFIED BEFORE USE  
DRAWING NOT TO SCALE UNLESS SCALE BAR IS PRESENT

**FOR CONSTRUCTION**

PER CITY OF PHOENIX CODE CHAPTER 2, SECTION 2-28, THESE PLANS ARE FOR OFFICIAL USE ONLY AND MAY NOT BE SHARED WITH OTHERS EXCEPT AS REQUIRED TO FULFILL THE OBLIGATIONS OF THE CONTRACTOR'S CONTRACT WITH THE CITY OF PHOENIX.  
THIS DOCUMENT MUST BE KEPT SECURE AT ALL TIMES.


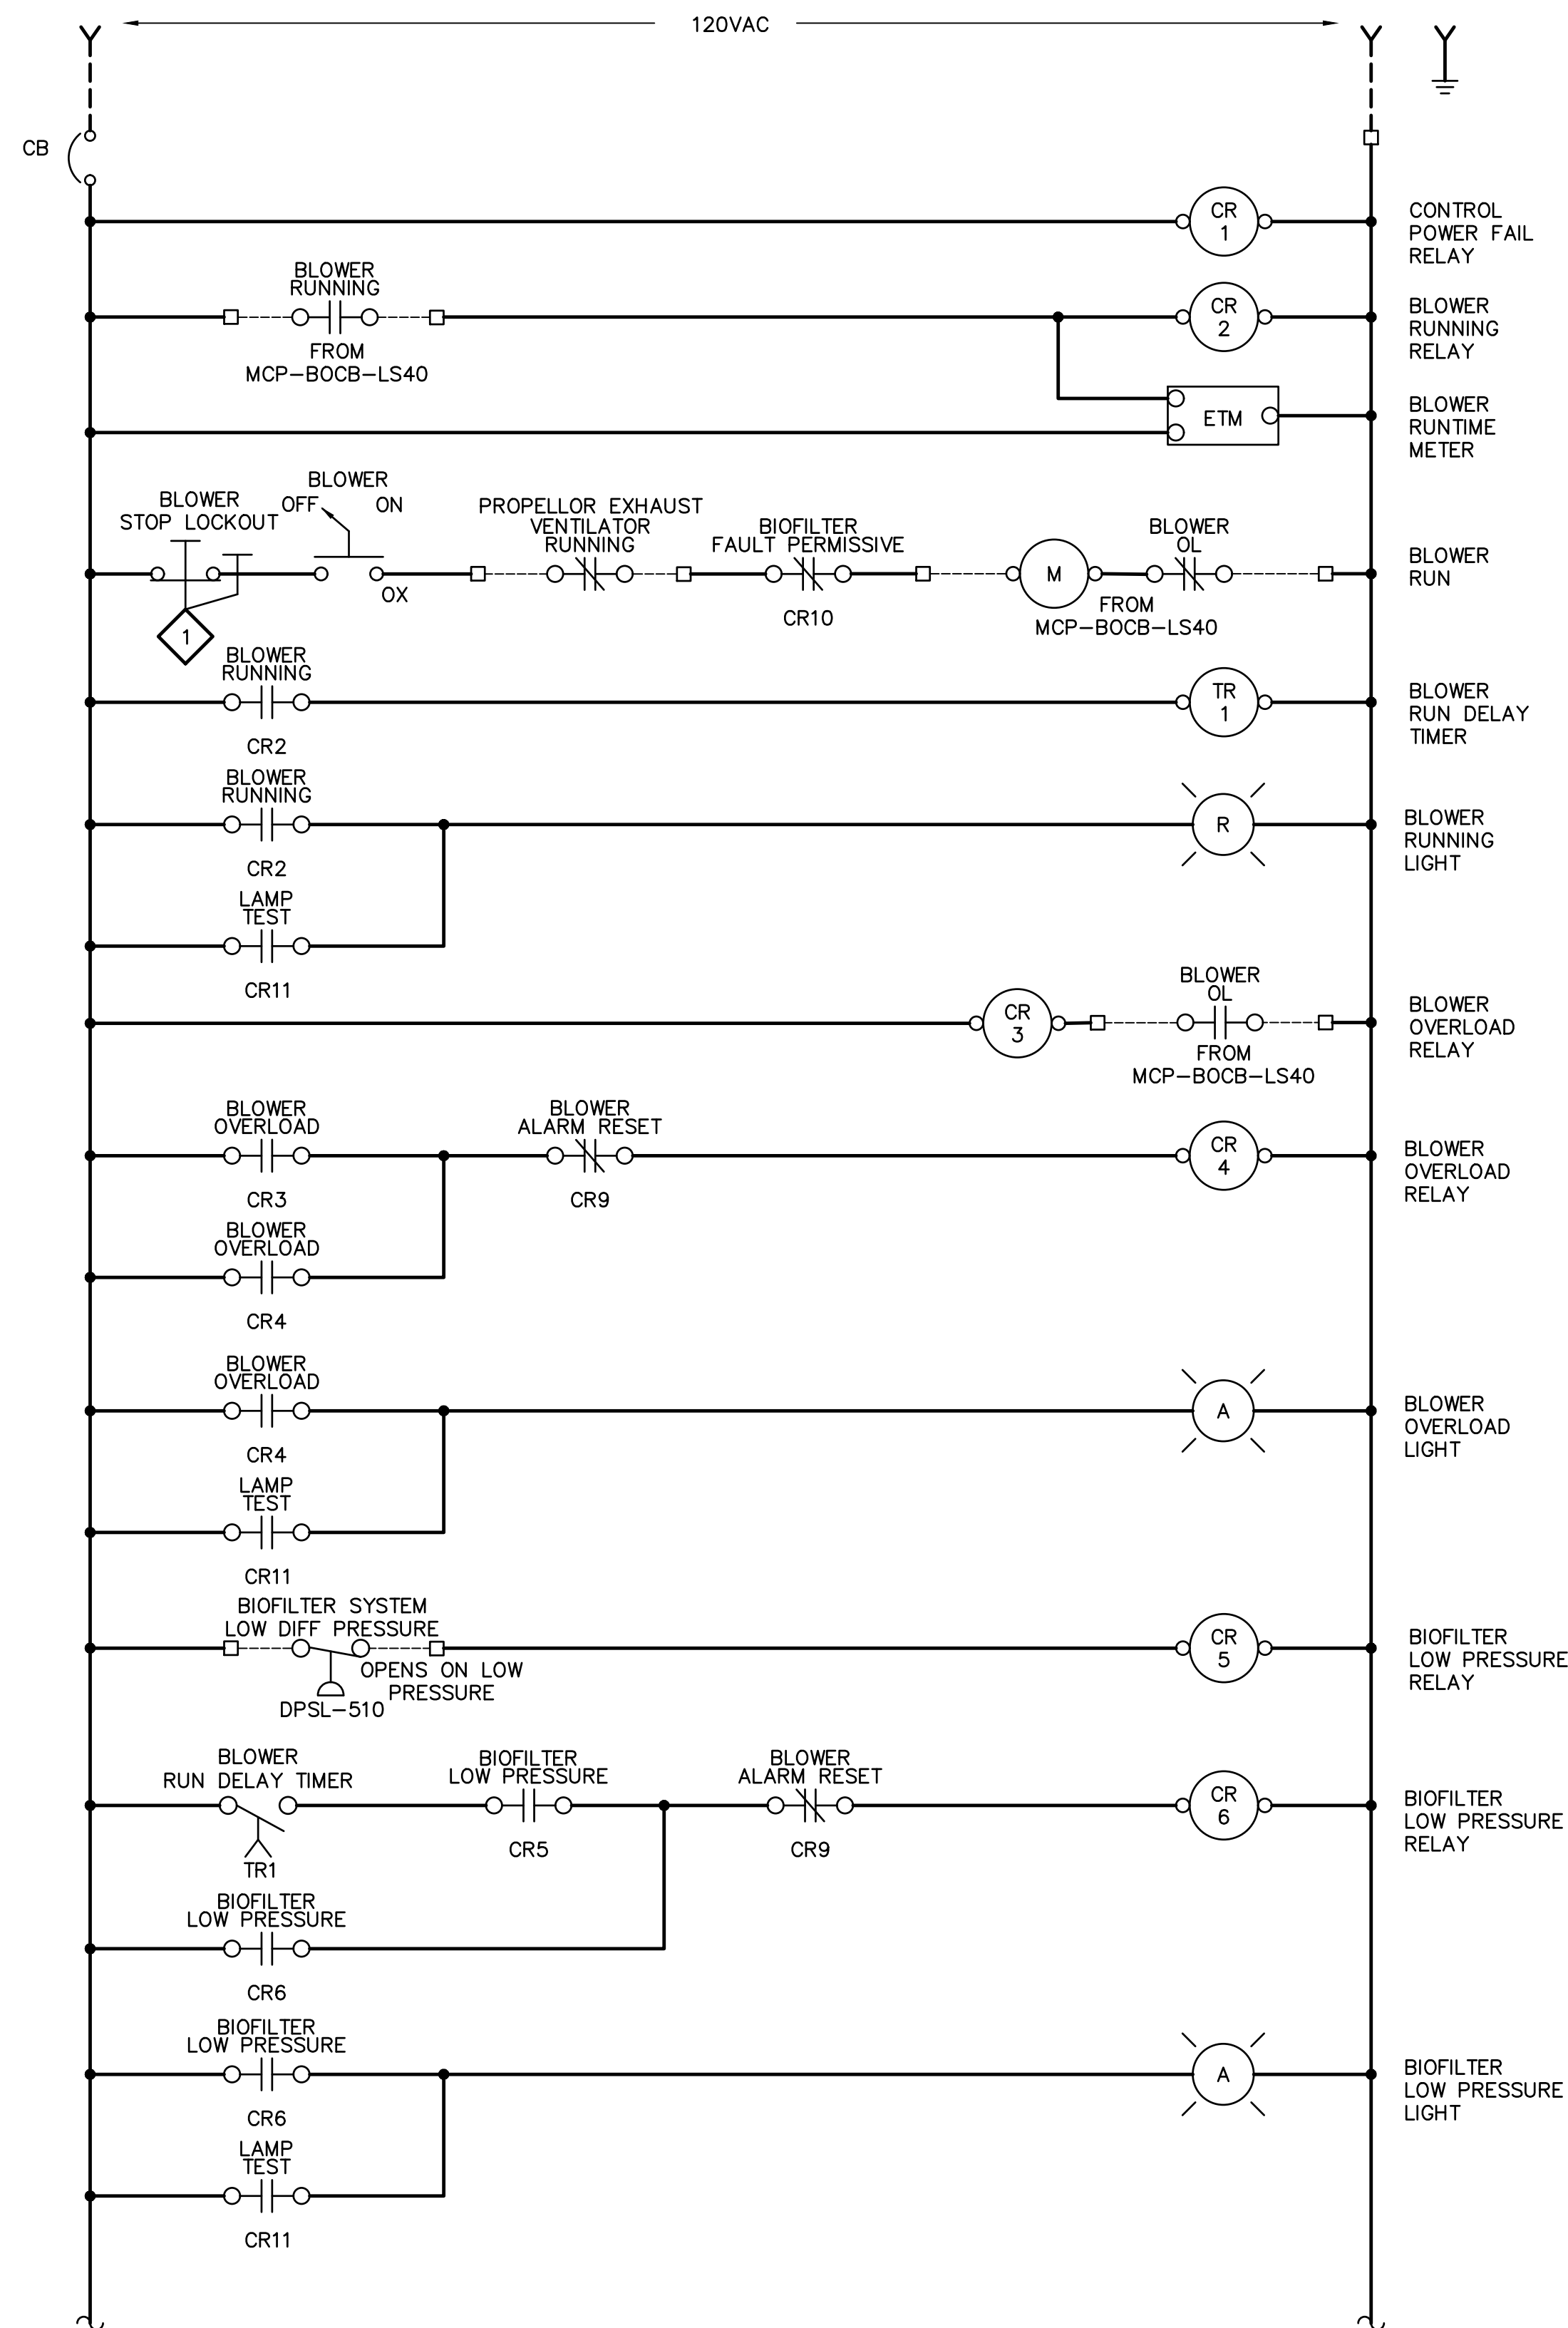


**KEY NOTES:**

- 1 NEMA 4X RATED NONILLUMINATED PUSH BUTTON COVER TYPE LOCKOUT, CAN BE PADLOCKED.

**GENERAL NOTES:**

- FOR REFERENCE ONLY. CONTRACTOR TO LAYOUT AND DESCRIBE PER 17260 SPECIFICATIONS.
- THIS DRAWING DOES NOT INDICATE ALL THE PROJECT REQUIREMENTS. THE PROJECT REQUIREMENTS ARE INDICATED IN VARIOUS ELECTRICAL AND INSTRUMENTATION DRAWINGS AND SPECIFICATIONS. ALL DOCUMENTS MUST BE CAREFULLY INSPECTED AND GATHERED TOGETHER IN ORDER TO INCLUDE THE COLLECTIVE REQUIREMENTS FOR THIS PROJECT.
- WHERE DISCREPANCIES EXIST AMONG VARIOUS DRAWINGS AND/OR SPECIFICATIONS, THE CONTRACTOR SHALL INCLUDE THE ITEM WITH THE MOST STRINGENT REQUIREMENT. FOR EXAMPLE, THE MOST LABORIOUS INSTALLATION, THE LARGER CONDUCTOR AND CONDUIT, THE HIGHER RATING DEVICE AND EQUIPMENT, THE FURTHER DISTANCE, ETC...
- THE CONTROL SCHEMATICS ARE SHOWN TO FURTHER CONVEY THE DESIGN INTENT AND CONTROL STRATEGY FOR THE SHOWN EQUIPMENT AND DEVICES. THE CONTRACTOR SHALL DESIGN WIRING DIAGRAMS BY INCORPORATING THE CONTROL SCHEMATICS HEREIN, THE P&IDs, CONTROL STRATEGIES, AND INCORPORATING THE ACTUAL SUBMITTED EQUIPMENT AND DEVICES.
- WHEN THE CONTROL SCHEMATICS ARE EXISTING AND WE ARE MODIFYING THEM: THE CONTRACTOR SHALL ALLOW 16 HOURS BY A PROFICIENT CONTROL ELECTRICIAN TO AS-BUILD THE CONTROLS ASSOCIATED WITH THIS CONTROL SCHEMATIC. THE AS-BUILT CONTROL SCHEMATIC SHOULD BE SKETCHED AND SUBMITTED TO THE ENGINEER FOR FURTHER MODIFICATION IF NECESSARY.
- THE TEMPORARY CONTROL WILL HAVE TO BE AS-BUILT BY THE CONTRACTOR AND SHALL BE OF THE EXISTING EQUIPMENT BEING DUPLICATED.

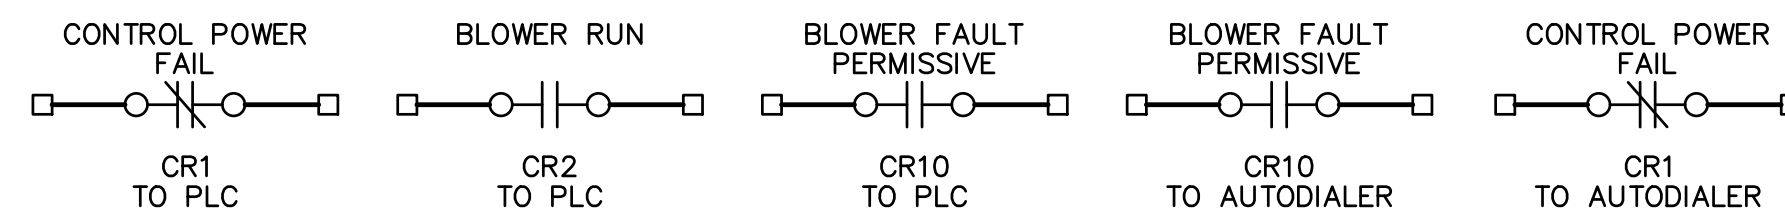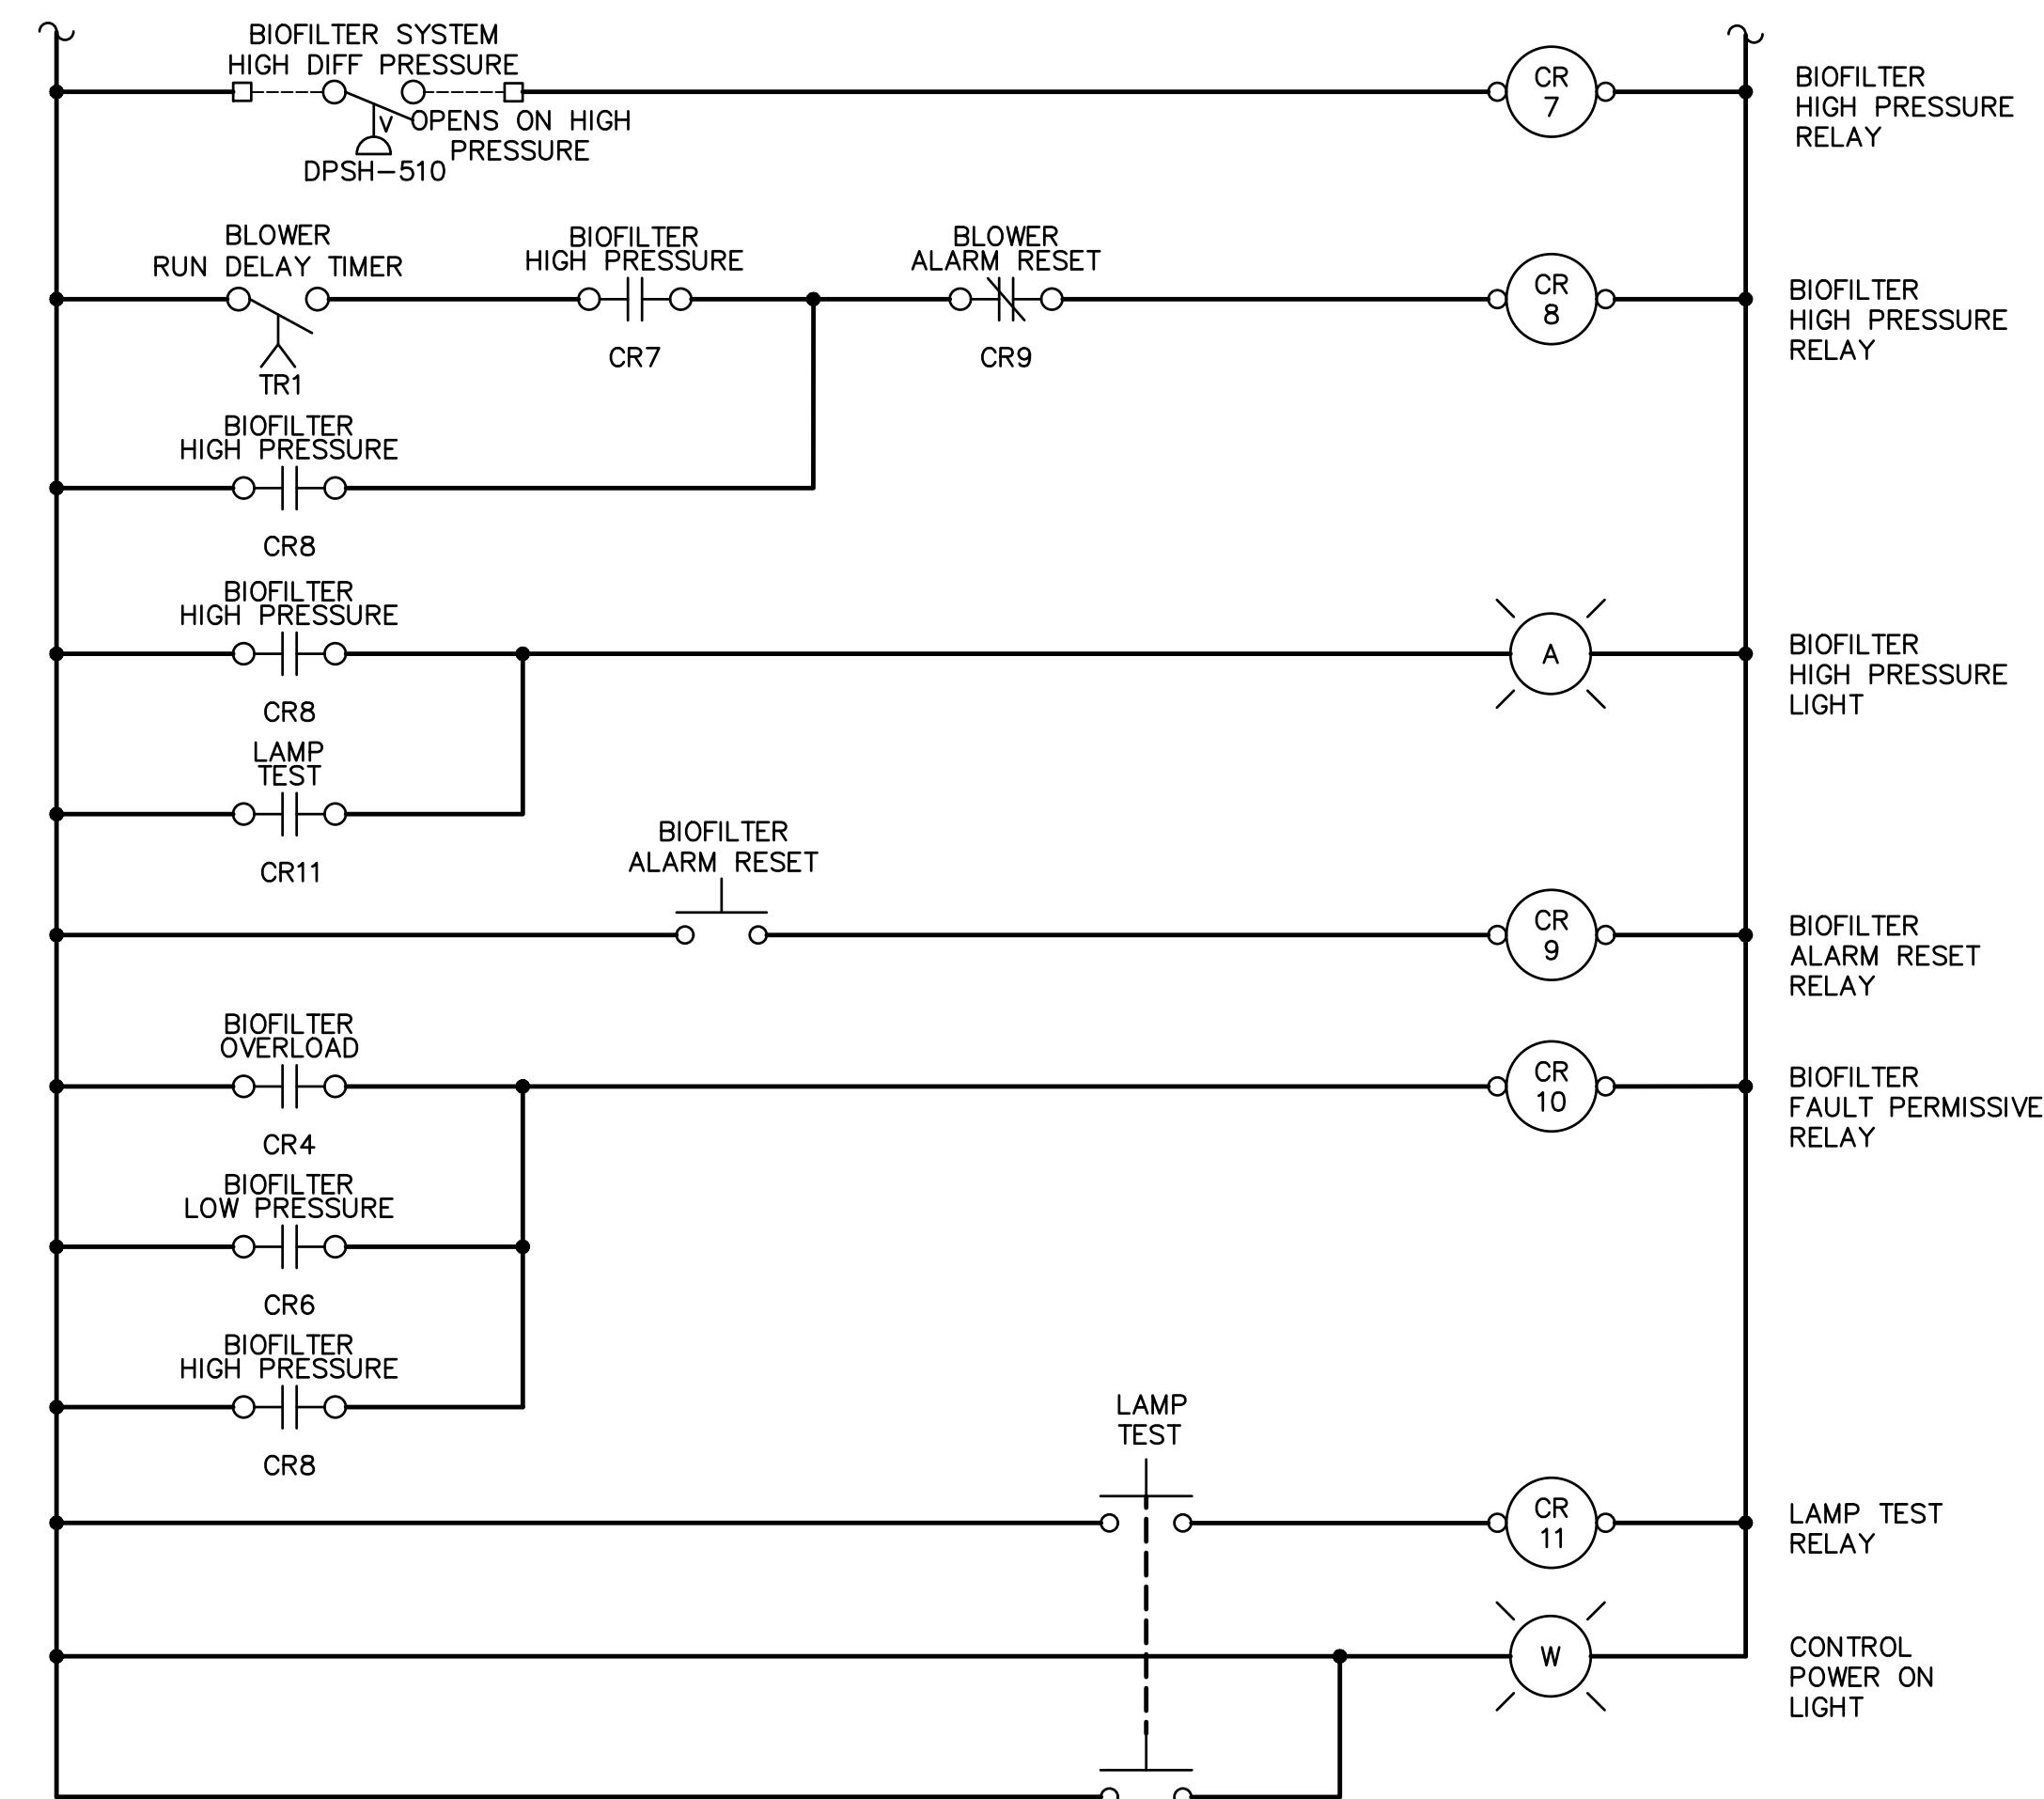

DETAIL **A** CONTROL SCHEMATIC LCP-BOCB-LS40  
# # TYPICAL

**IMPORTANT NOTE:**

- THE CONTROL SCHEMATICS SHOWN HERE INDICATE THE CONTROL STRATEGY FOR THE SHOWN EQUIPMENT AND DEVICES. THE CONTRACTOR SHALL SUBMIT 17260 WIRING DIAGRAMS INDICATIVE OF THE ACTUAL EQUIPMENT AND DEVICES BEING INSTALLED.




FACILITY DRAWINGS  
This drawing was supplied by a Consultant Engineer from a past construction project. The original contractor drawing was modified based on information provided by the Contractor to provide the Record Drawing. The City does not warrant the accuracy and reliability of the drawings and any portrayal of facilities as they exist in the field.

REVISION	DWG NUMBER	CAD FILE NAME	DATE	PROJECT NAME	PROJECT NO.	REFERENCE CID NUMBER	REMARKS

THIS DRAWING MUST BE FIELD VERIFIED BEFORE USE  
DRAWING NOT TO SCALE UNLESS SCALE BAR IS PRESENT

**FOR CONSTRUCTION**

"PER CITY OF PHOENIX CODE CHAPTER 2, SECTION 2-28, THESE PLANS ARE FOR OFFICIAL USE ONLY AND MAY NOT BE SHARED WITH OTHERS EXCEPT AS REQUIRED TO FULFILL THE OBLIGATIONS OF THE CONTRACTOR'S CONTRACT WITH THE CITY OF PHOENIX."  
THIS DOCUMENT MUST BE KEPT SECURE AT ALL TIMES.

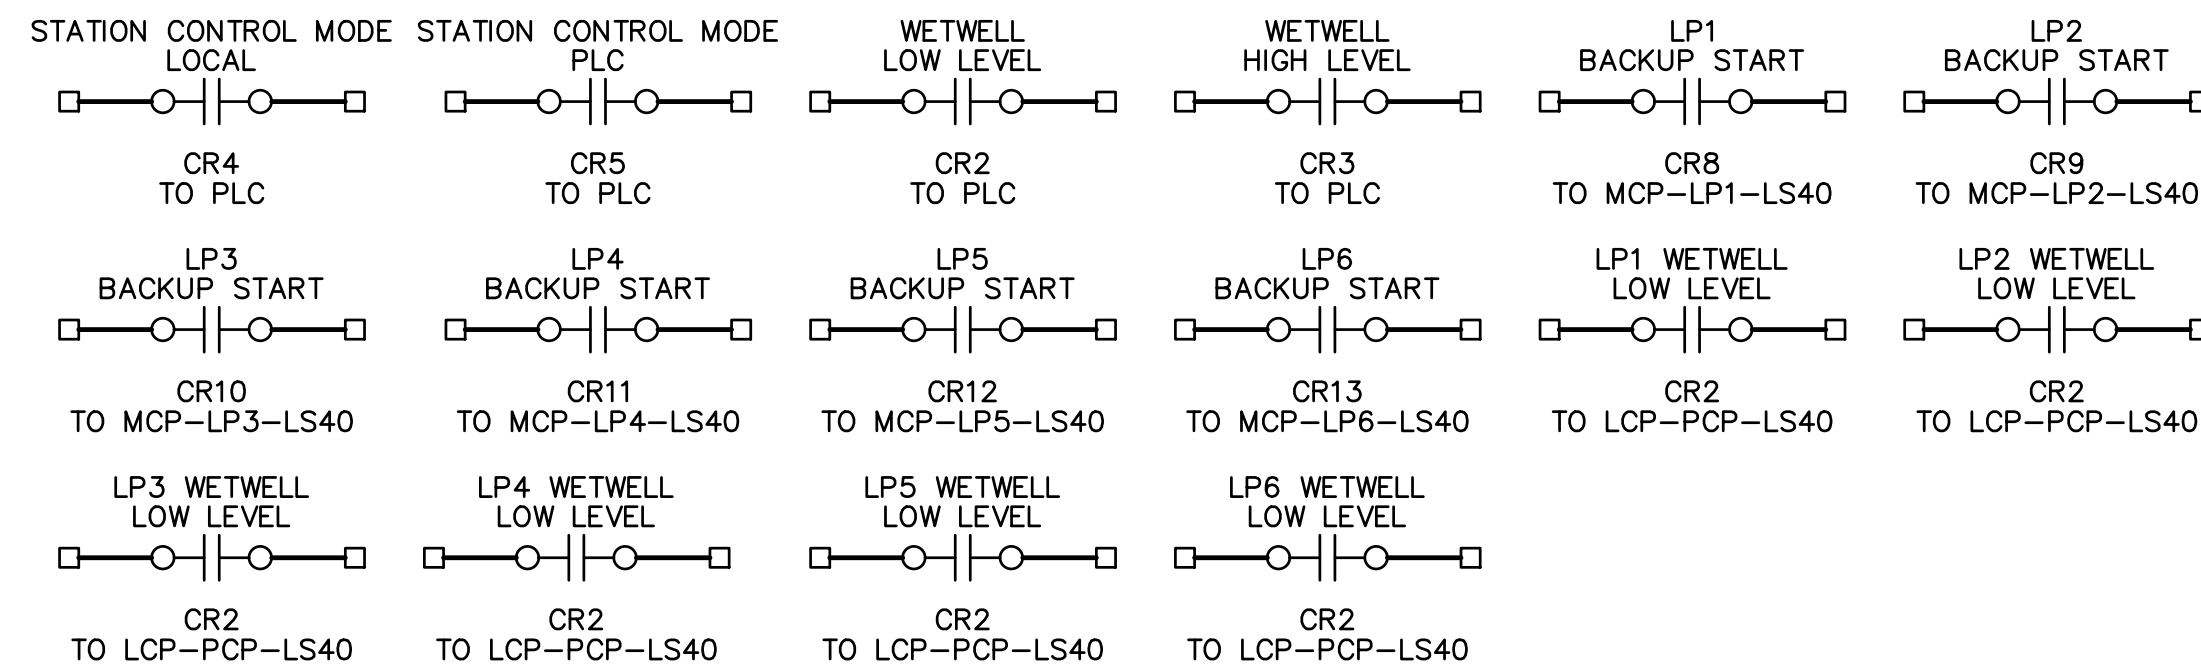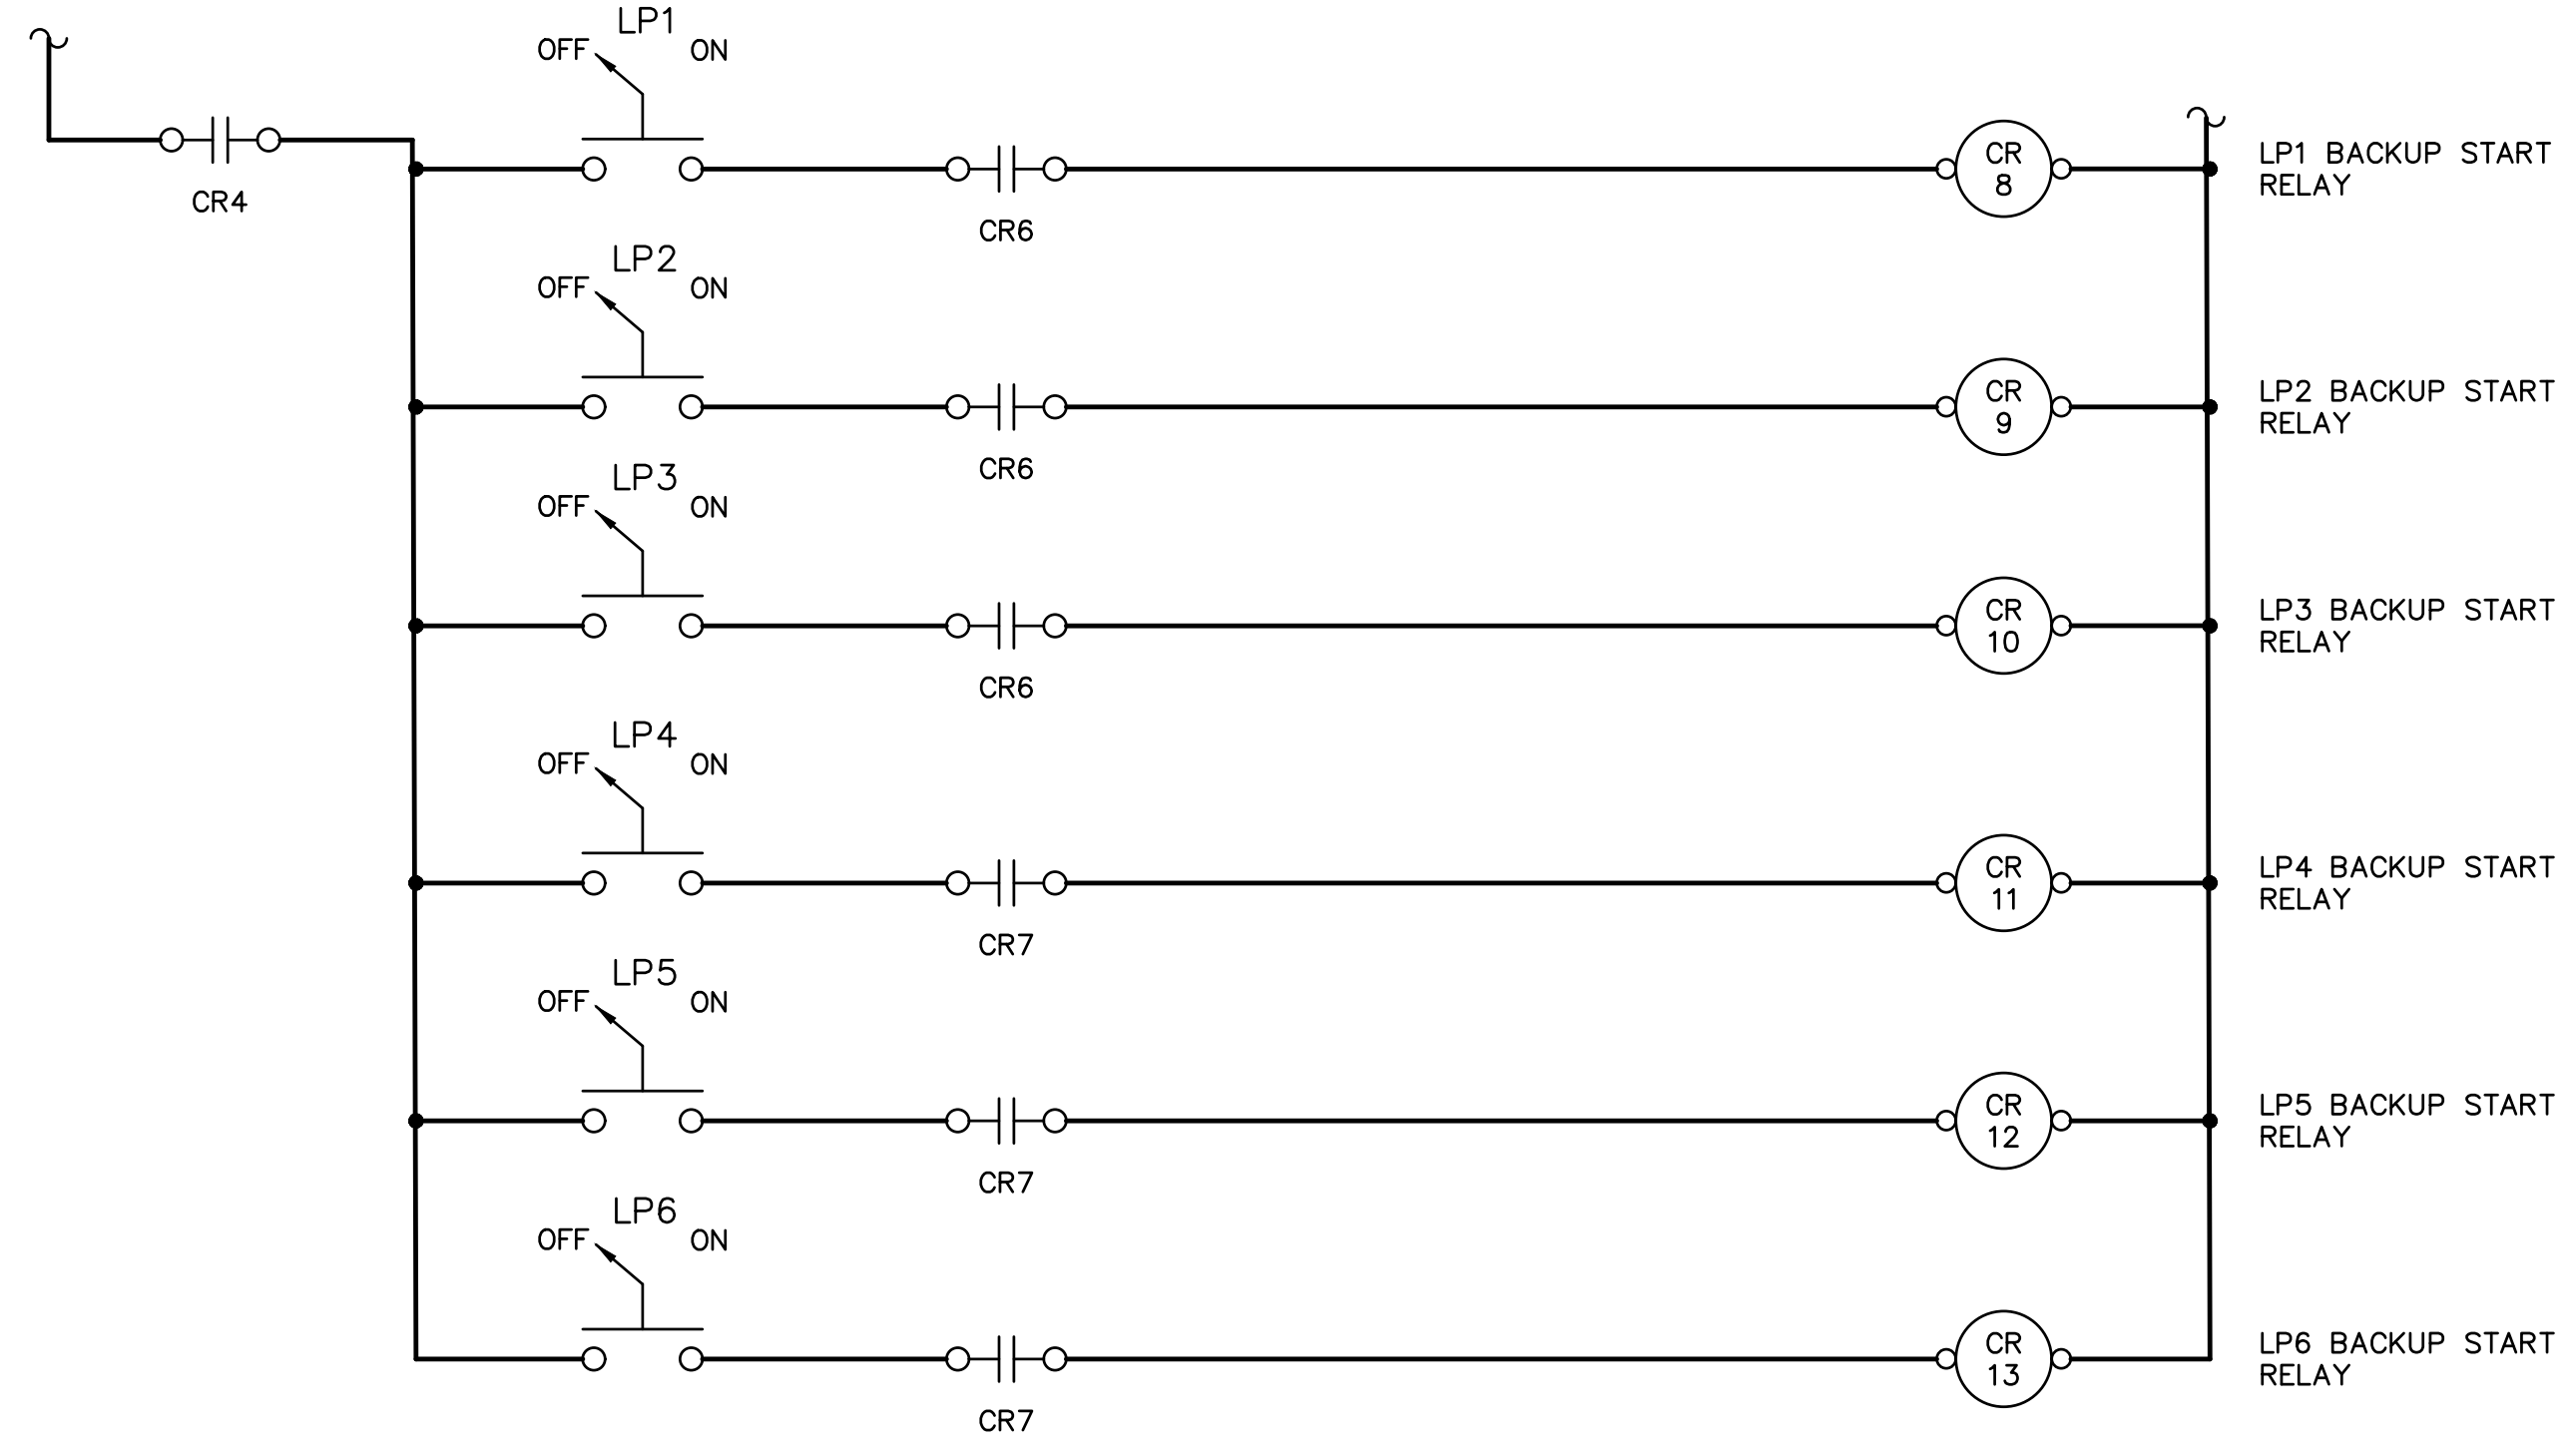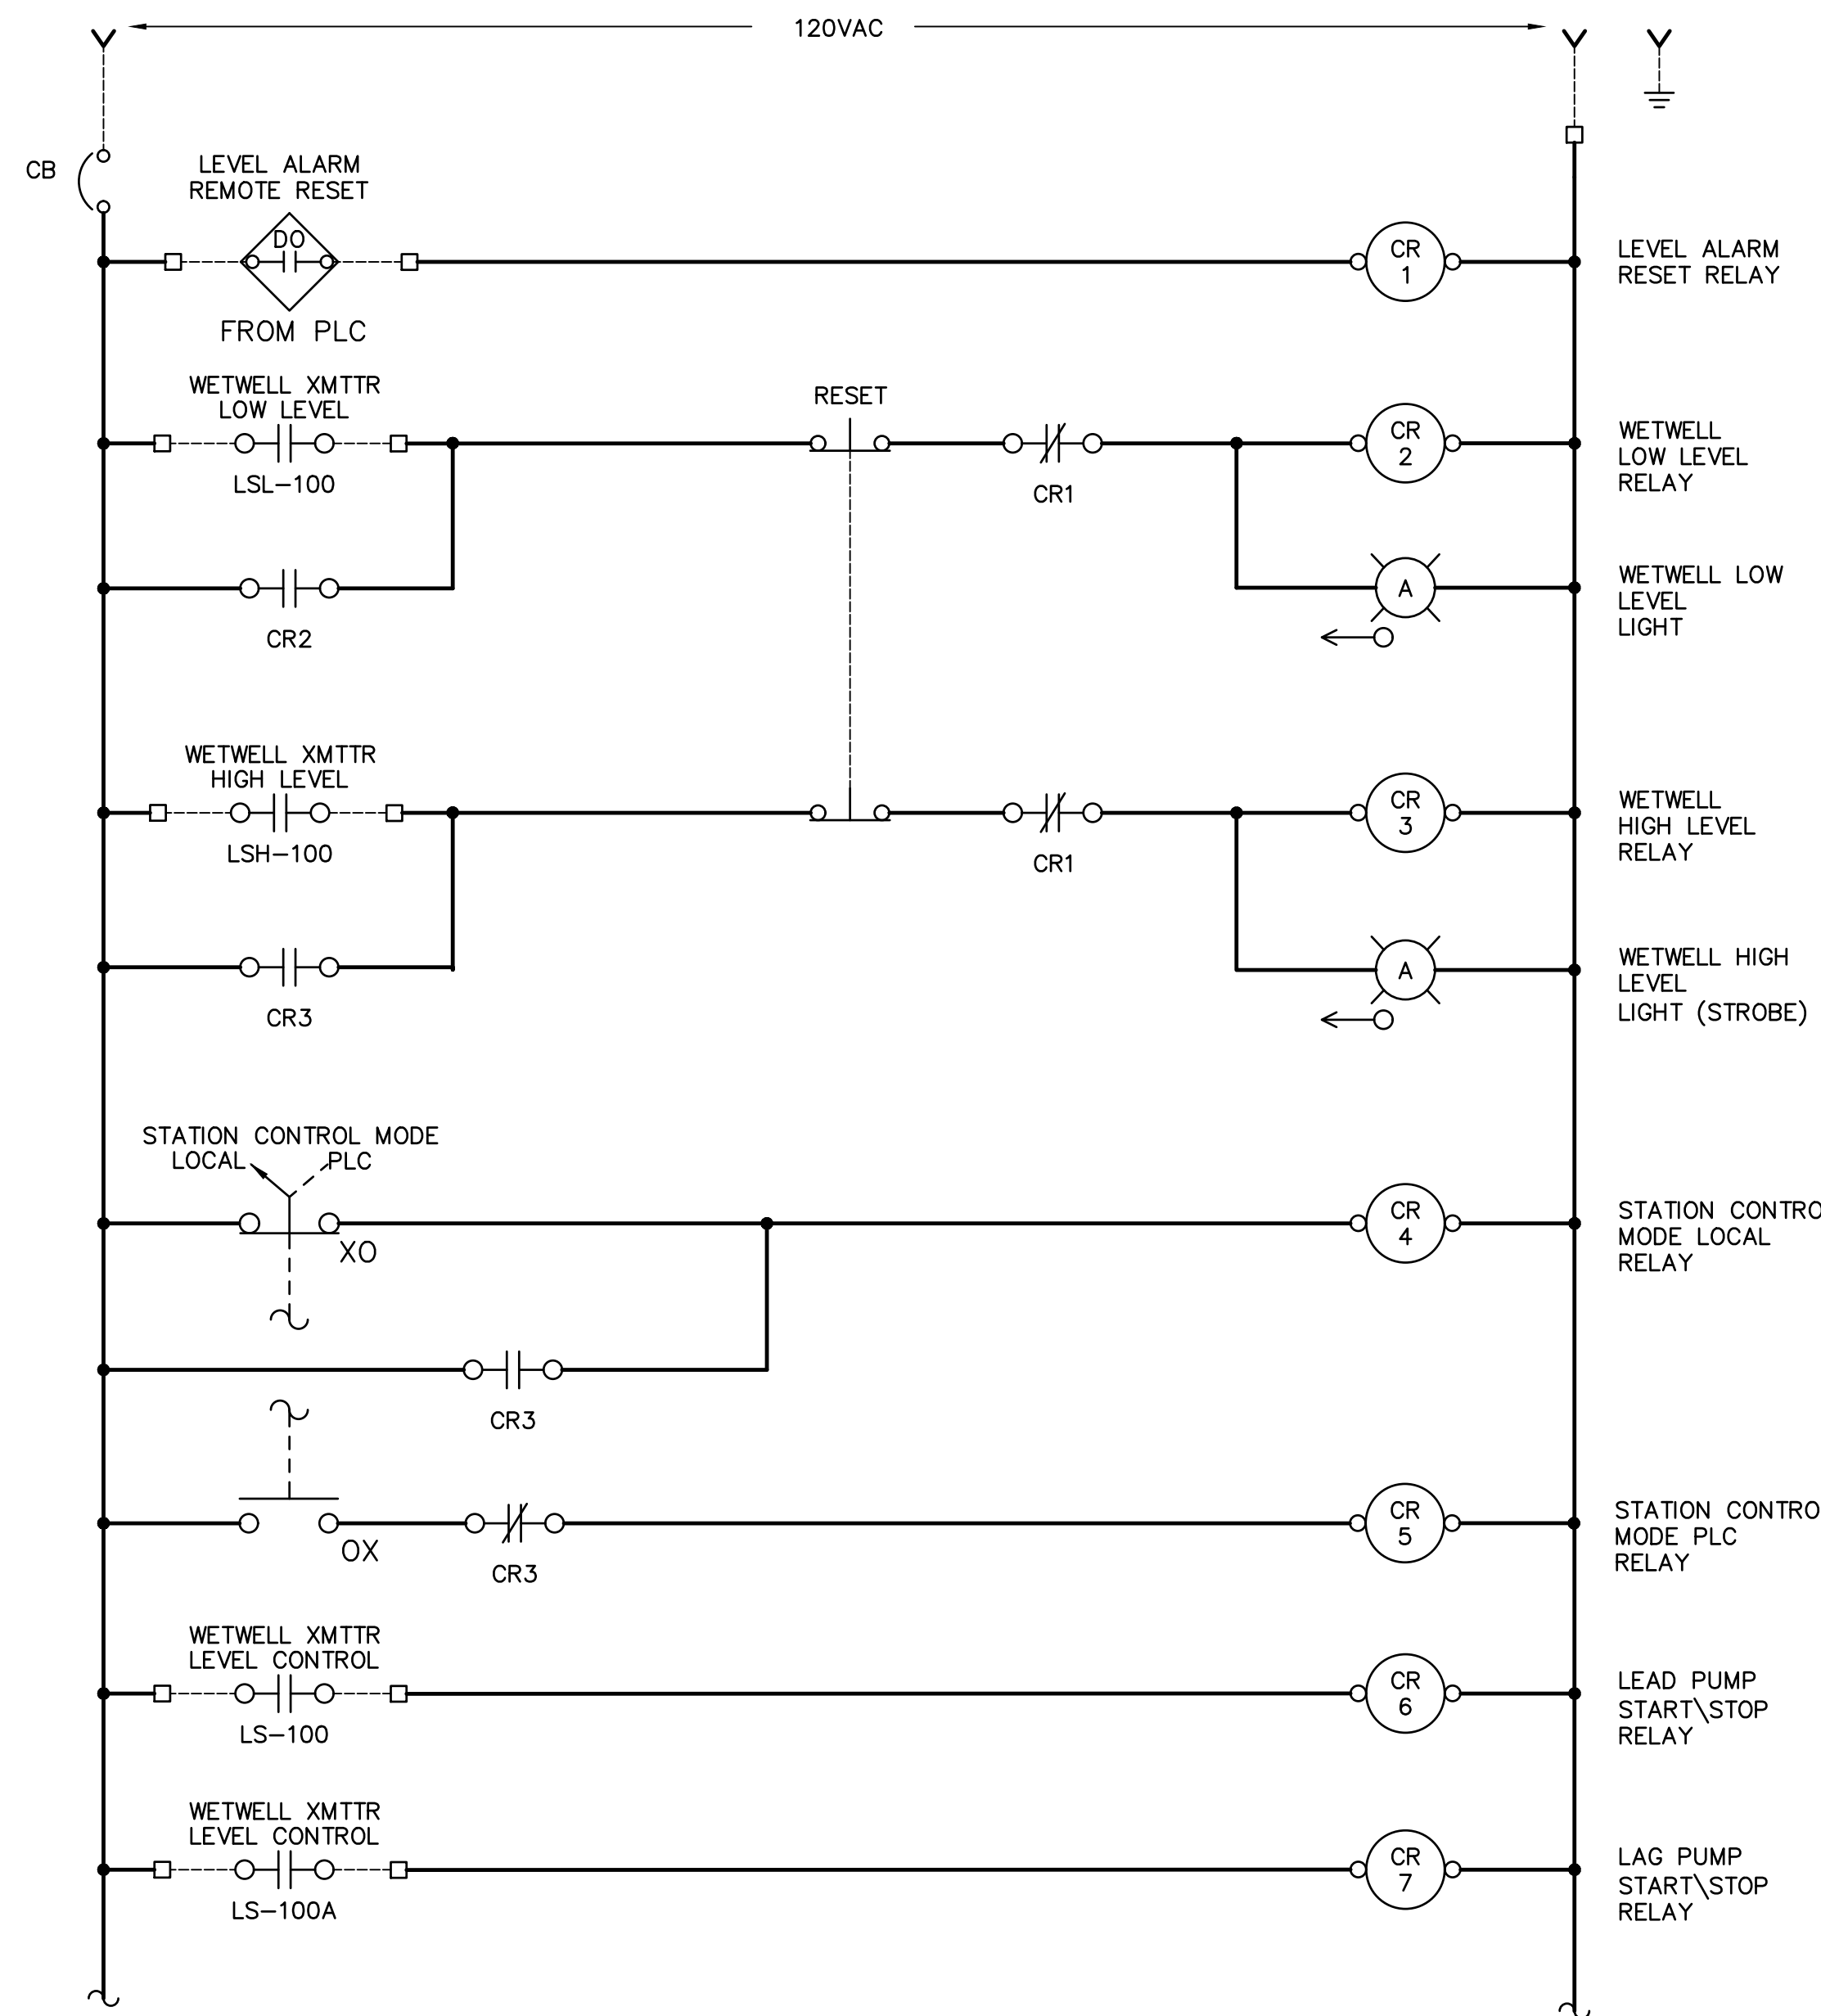

DETAIL 

A
##

 CONTROL SCHEMATIC LCP-BACKUP-LS40

**IMPORTANT NOTE:**  
THE CONTROL SCHEMATICS SHOWN HERE INDICATE THE CONTROL STRATEGY FOR THE SHOWN EQUIPMENT AND DEVICES. THE CONTRACTOR SHALL SUBMIT 17260 WIRING DIAGRAMS INDICATIVE OF THE ACTUAL EQUIPMENT AND DEVICES BEING INSTALLED.

GENERAL NOTES:

- FOR REFERENCE ONLY. CONTRACTOR TO LAYOUT AND DESCRIBE PER 17260 SPECIFICATIONS.
- THIS DRAWING DOES NOT INDICATE ALL THE PROJECT REQUIREMENTS. THE PROJECT REQUIREMENTS ARE INDICATED IN VARIOUS ELECTRICAL AND INSTRUMENTATION DRAWINGS AND SPECIFICATIONS. ALL DOCUMENTS MUST BE CAREFULLY INSPECTED AND GATHERED TOGETHER IN ORDER TO INCLUDE THE COLLECTIVE REQUIREMENTS FOR THIS PROJECT.
- WHERE DISCREPANCIES EXIST AMONG VARIOUS DRAWINGS AND/OR SPECIFICATIONS, THE CONTRACTOR SHALL INCLUDE THE ITEM WITH THE MOST STRINGENT REQUIREMENT. FOR EXAMPLE, THE MOST LABORIOUS INSTALLATION, THE LARGER CONDUCTOR AND CONDUIT, THE HIGHER RATING DEVICE AND EQUIPMENT, THE FURTHER DISTANCE, ETC...
- THE CONTROL SCHEMATICS ARE SHOWN TO FURTHER CONVEY THE DESIGN INTENT AND CONTROL STRATEGY FOR THE SHOWN EQUIPMENT AND DEVICES. THE CONTRACTOR SHALL DESIGN WIRING DIAGRAMS BY INCORPORATING THE CONTROL SCHEMATICS HEREIN, THE P&IDS, CONTROL STRATEGIES, AND INCORPORATING THE ACTUAL SUBMITTED EQUIPMENT AND DEVICES.
- WHEN THE CONTROL SCHEMATICS ARE EXISTING AND WE ARE MODIFYING THEM: THE CONTRACTOR SHALL ALLOW 16 HOURS BY A PROFICIENT CONTROL ELECTRICIAN TO AS-BUILD THE CONTROLS ASSOCIATED WITH THIS CONTROL SCHEMATIC. THE AS-BUILT CONTROL SCHEMATIC SHOULD BE SKETCHED AND SUBMITTED TO THE ENGINEER FOR FURTHER MODIFICATION IF NECESSARY.
- THE TEMPORARY CONTROLS WILL HAVE TO BE AS-BUILT BY THE CONTRACTOR AND SHALL BE OF THE EXISTING EQUIPMENT BEING DUPLICATED.


FACILITY DRAWINGS  
This drawing was supplied by a Consultant Engineer from a past construction project. The original contractor drawing was modified based on information provided by the Contractor to provide the Record Drawing. The City does not warrant the accuracy and reliability of the drawings and accuracy of any facilities as they exist in the field.

REVISION	DATE	CAD FILE NAME	DWG NUMBER	REMARKS

			<table border="1" style="width: 100%; border-collapse: collapse;"> <thead> <tr> <th colspan="5">REVISIONS</th> </tr> <tr> <th>NO.</th> <th>BY</th> <th>DATE</th> <th>CKD</th> <th>REMARKS</th> </tr> </thead> <tbody> <tr><td> </td><td> </td><td> </td><td> </td><td> </td></tr> <tr><td> </td><td> </td><td> </td><td> </td><td> </td></tr> <tr><td> </td><td> </td><td> </td><td> </td><td> </td></tr> <tr><td> </td><td> </td><td> </td><td> </td><td> </td></tr> </tbody> </table>	REVISIONS					NO.	BY	DATE	CKD	REMARKS																					DES RB  DWN BB  CKD VB		CITY OF PHOENIX WATER SERVICES DEPARTMENT  LIFT STATION 40 REFURBISHMENT	ELECTRICAL  CONTROL SCHEMATIC - 7	COPYRIGHT © 2007-JANUARY CITY PROJECT NO. WS90400085 DATE: 08/2024 E-25 SHEET 116 OF 134 CAD FILE: CSELS40ES07.dwg
			REVISIONS																																			
NO.	BY	DATE	CKD	REMARKS																																		
FOR CITY OF PHOENIX USE ONLY - REFERENCE CID NUMBER: # _____ REVISION ENGINEERING COMPANY PROJECT NO. _____																																						

**FOR CONSTRUCTION**

THIS DRAWING MUST BE FIELD VERIFIED BEFORE USE  
DRAWING NOT TO SCALE UNLESS SCALE BAR IS PRESENT

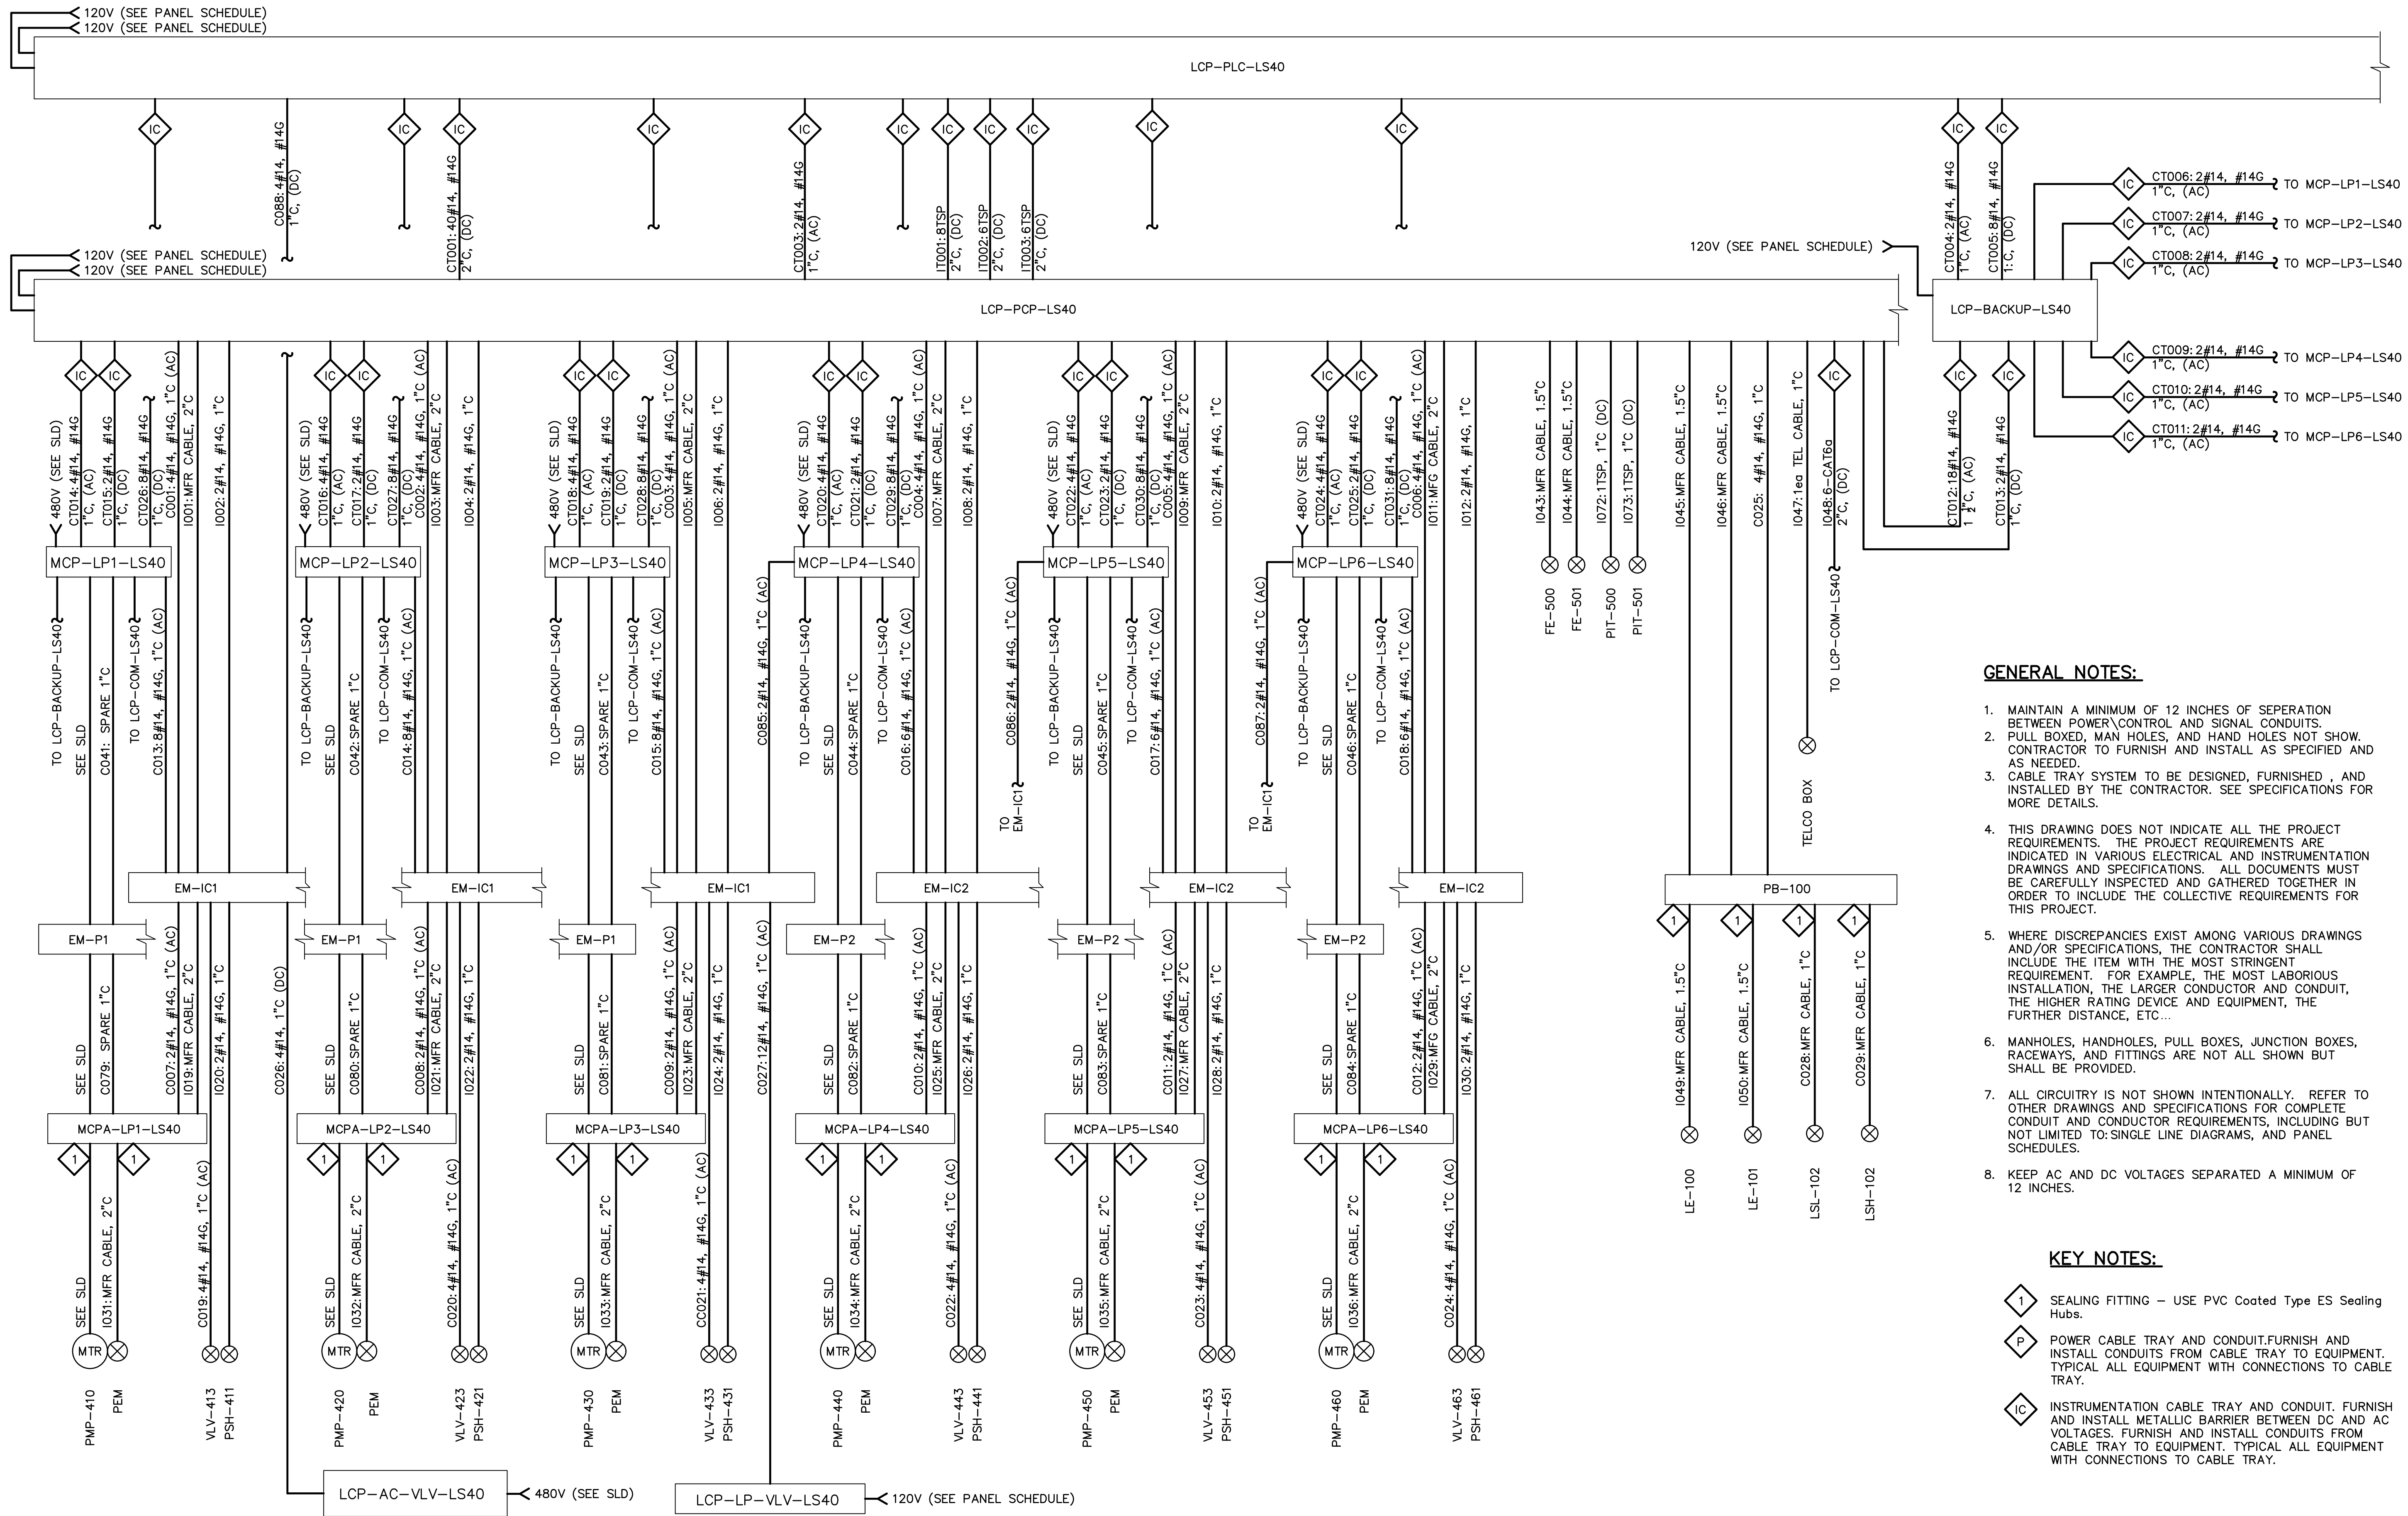




**GENERAL NOTES:**

- MAINTAIN A MINIMUM OF 12 INCHES OF SEPARATION BETWEEN POWER CONTROL AND SIGNAL CONDUITS.
- PULL BOXED, MAN HOLES, AND HAND HOLES NOT SHOW. CONTRACTOR TO FURNISH AND INSTALL AS SPECIFIED AND AS NEEDED.
- CABLE TRAY SYSTEM TO BE DESIGNED, FURNISHED, AND INSTALLED BY THE CONTRACTOR. SEE SPECIFICATIONS FOR MORE DETAILS.
- THIS DRAWING DOES NOT INDICATE ALL THE PROJECT REQUIREMENTS. THE PROJECT REQUIREMENTS ARE INDICATED IN VARIOUS ELECTRICAL AND INSTRUMENTATION DRAWINGS AND SPECIFICATIONS. ALL DOCUMENTS MUST BE CAREFULLY INSPECTED AND GATHERED TOGETHER IN ORDER TO INCLUDE THE COLLECTIVE REQUIREMENTS FOR THIS PROJECT.
- WHERE DISCREPANCIES EXIST AMONG VARIOUS DRAWINGS AND/OR SPECIFICATIONS, THE CONTRACTOR SHALL INCLUDE THE ITEM WITH THE MOST STRINGENT REQUIREMENT. FOR EXAMPLE, THE MOST LABORIOUS INSTALLATION, THE LARGER CONDUCTOR AND CONDUIT, THE HIGHER RATING DEVICE AND EQUIPMENT, THE FURTHER DISTANCE, ETC...
- MANHOLES, HANDHOLES, PULL BOXES, JUNCTION BOXES, RACEWAYS, AND FITTINGS ARE NOT ALL SHOWN BUT SHALL BE PROVIDED.
- ALL CIRCUITRY IS NOT SHOWN INTENTIONALLY. REFER TO OTHER DRAWINGS AND SPECIFICATIONS FOR COMPLETE CONDUIT AND CONDUCTOR REQUIREMENTS, INCLUDING BUT NOT LIMITED TO: SINGLE LINE DIAGRAMS, AND PANEL SCHEDULES.
- KEEP AC AND DC VOLTAGES SEPARATED A MINIMUM OF 12 INCHES.


- KEY NOTES:**
- 1 SEALING FITTING - USE PVC Coated Type ES Sealing Hubs.
  - P POWER CABLE TRAY AND CONDUIT. FURNISH AND INSTALL CONDUITS FROM CABLE TRAY TO EQUIPMENT. TYPICAL ALL EQUIPMENT WITH CONNECTIONS TO CABLE TRAY.
  - IC INSTRUMENTATION CABLE TRAY AND CONDUIT. FURNISH AND INSTALL METALLIC BARRIER BETWEEN DC AND AC VOLTAGES. FURNISH AND INSTALL CONDUITS FROM CABLE TRAY TO EQUIPMENT. TYPICAL ALL EQUIPMENT WITH CONNECTIONS TO CABLE TRAY.

FACILITY DRAWINGS  
This drawing was supplied by a Consultant Engineer from a past construction project. The original contractor drawing was modified based on information provided by the Contractor to provide the Record Drawing. The City does not warrant the accuracy and reliability of the drawings and accuracy of any information provided by the Contractor to provide the Record Drawing. The City does not warrant the accuracy and reliability of the drawings and accuracy of any information provided by the Contractor to provide the Record Drawing.

REVISION	DATE	CAD FILE NAME	DWG NUMBER	REMARKS

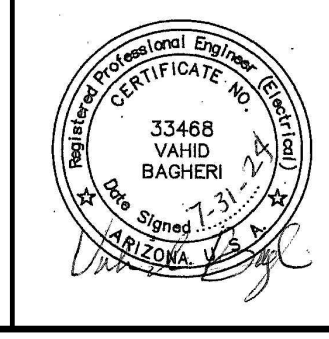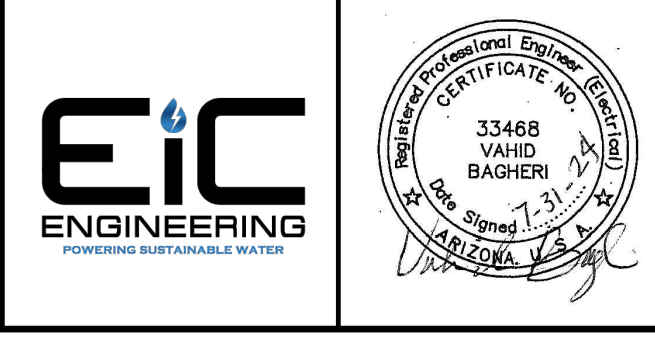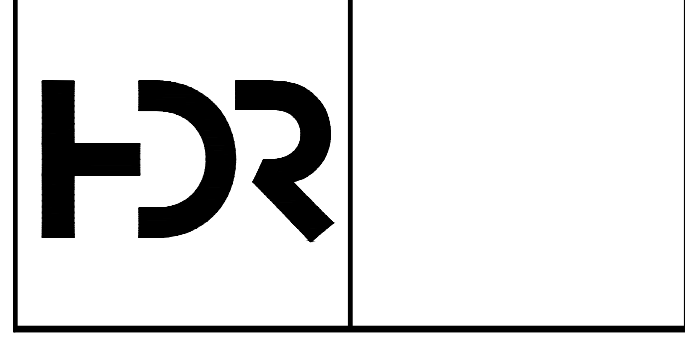

REVISIONS				
NO.	BY	DATE	CKD	REMARKS

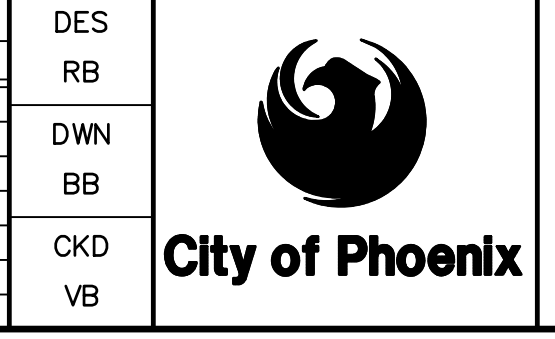

CITY OF PHOENIX  
WATER SERVICES DEPARTMENT  
**LIFT STATION 40  
REFURBISHMENT**


ELECTRICAL  
**CONDUIT BLOCK DIAGRAMS**

COPYRIGHT © 2007-JANUARY  
CITY PROJECT NO. WS90400085  
DATE: 08/2024  
E-26 SHEET 117 OF 134  
CAD FILE: CSELS40EC01.dwg

THIS DRAWING MUST BE FIELD VERIFIED BEFORE USE  
DRAWING NOT TO SCALE UNLESS SCALE BAR IS PRESENT



**FOR CONSTRUCTION**

PER CITY OF PHOENIX CODE CHAPTER 2, SECTION 2-28, THESE PLANS ARE FOR OFFICIAL USE ONLY AND MAY NOT BE SHARED WITH OTHERS EXCEPT AS REQUIRED TO FULFILL THE OBLIGATIONS OF THE CONTRACTOR'S CONTRACT WITH THE CITY OF PHOENIX.  
THIS DOCUMENT MUST BE KEPT SECURE AT ALL TIMES.

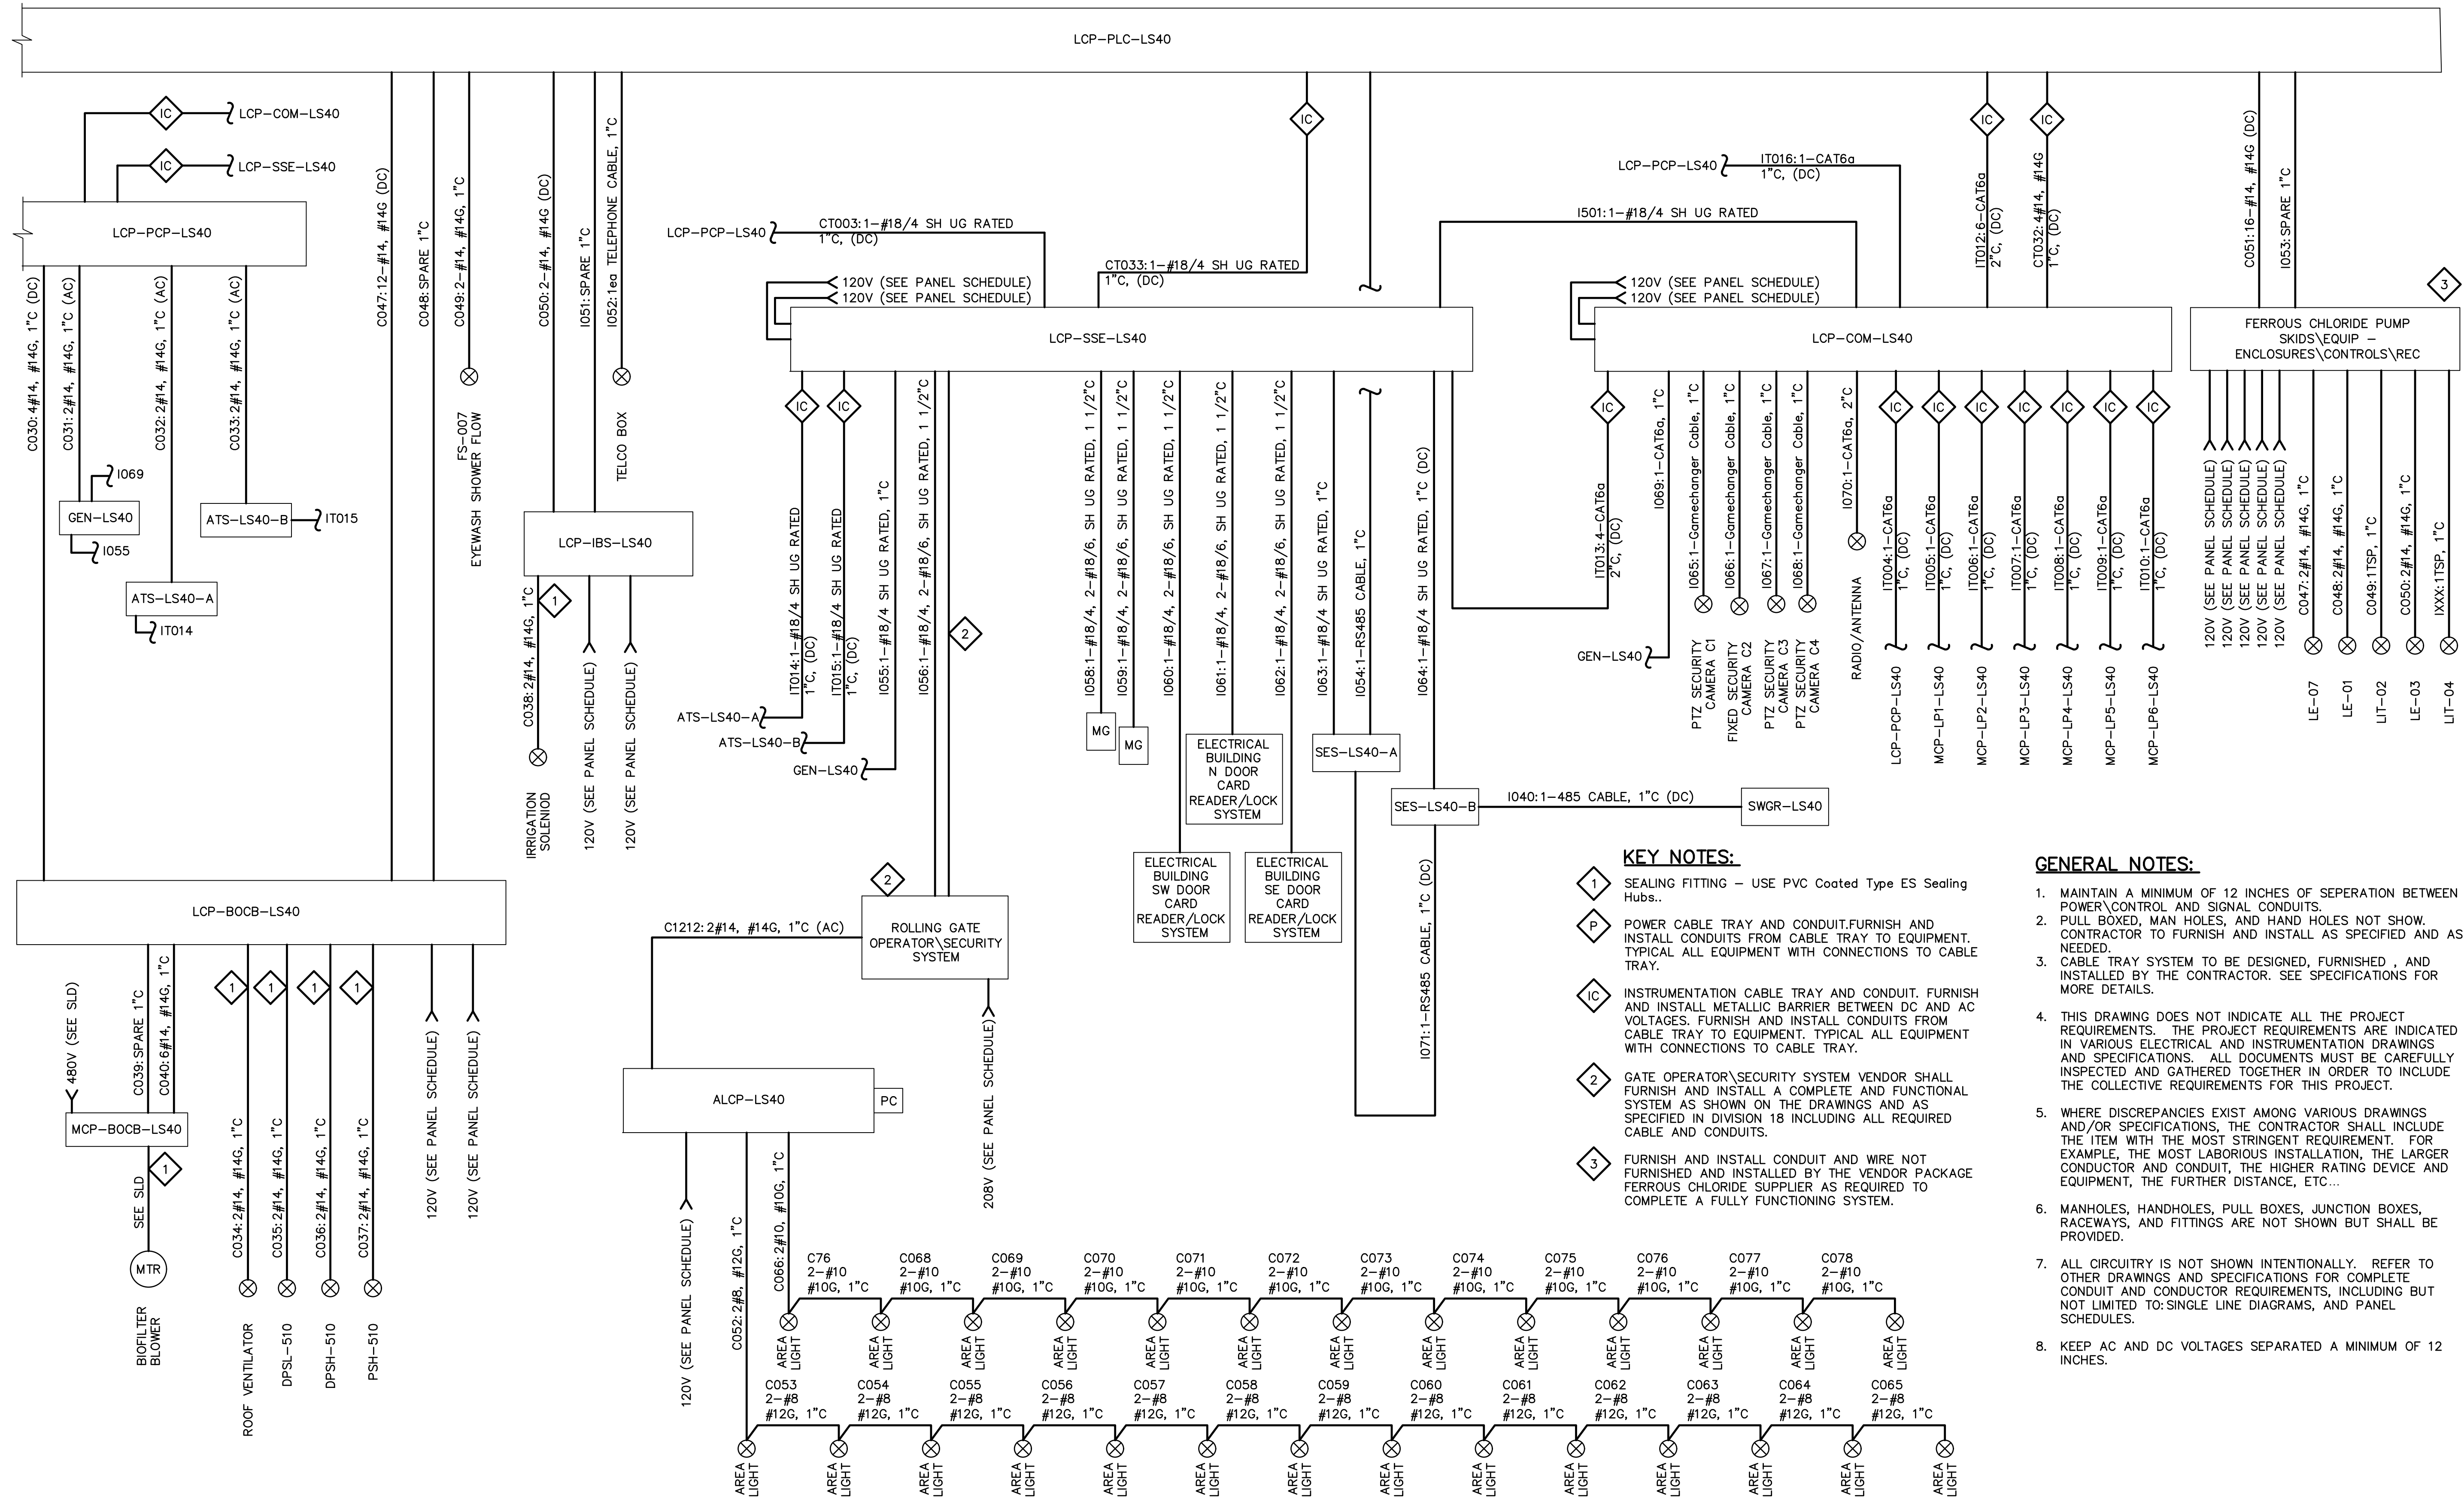


- KEY NOTES:**
- 1 SEALING FITTING - USE PVC Coated Type ES Sealing Hubs..
  - 2 POWER CABLE TRAY AND CONDUIT. FURNISH AND INSTALL CONDUITS FROM CABLE TRAY TO EQUIPMENT. TYPICAL ALL EQUIPMENT WITH CONNECTIONS TO CABLE TRAY.
  - 3 INSTRUMENTATION CABLE TRAY AND CONDUIT. FURNISH AND INSTALL METALLIC BARRIER BETWEEN DC AND AC VOLTAGES. FURNISH AND INSTALL CONDUITS FROM CABLE TRAY TO EQUIPMENT. TYPICAL ALL EQUIPMENT WITH CONNECTIONS TO CABLE TRAY.
  - 4 GATE OPERATOR\SECURITY SYSTEM VENDOR SHALL FURNISH AND INSTALL A COMPLETE AND FUNCTIONAL SYSTEM AS SHOWN ON THE DRAWINGS AND AS SPECIFIED IN DIVISION 18 INCLUDING ALL REQUIRED CABLE AND CONDUITS.
  - 5 FURNISH AND INSTALL CONDUIT AND WIRE NOT FURNISHED AND INSTALLED BY THE VENDOR PACKAGE FERROUS CHLORIDE SUPPLIER AS REQUIRED TO COMPLETE A FULLY FUNCTIONING SYSTEM.

- GENERAL NOTES:**
1. MAINTAIN A MINIMUM OF 12 INCHES OF SEPERATION BETWEEN POWER\CONTROL AND SIGNAL CONDUITS.
  2. PULL BOXED, MAN HOLES, AND HAND HOLES NOT SHOWN. CONTRACTOR TO FURNISH AND INSTALL AS SPECIFIED AND AS NEEDED.
  3. CABLE TRAY SYSTEM TO BE DESIGNED, FURNISHED, AND INSTALLED BY THE CONTRACTOR. SEE SPECIFICATIONS FOR MORE DETAILS.
  4. THIS DRAWING DOES NOT INDICATE ALL THE PROJECT REQUIREMENTS. THE PROJECT REQUIREMENTS ARE INDICATED IN VARIOUS ELECTRICAL AND INSTRUMENTATION DRAWINGS AND SPECIFICATIONS. ALL DOCUMENTS MUST BE CAREFULLY INSPECTED AND GATHERED TOGETHER IN ORDER TO INCLUDE THE COLLECTIVE REQUIREMENTS FOR THIS PROJECT.
  5. WHERE DISCREPANCIES EXIST AMONG VARIOUS DRAWINGS AND/OR SPECIFICATIONS, THE CONTRACTOR SHALL INCLUDE THE ITEM WITH THE MOST STRINGENT REQUIREMENT. FOR EXAMPLE, THE MOST LABORIOUS INSTALLATION, THE LARGER CONDUCTOR AND CONDUIT, THE HIGHER RATING DEVICE AND EQUIPMENT, THE FURTHER DISTANCE, ETC...
  6. MANHOLES, HANDHOLES, PULL BOXES, JUNCTION BOXES, RACEWAYS, AND FITTINGS ARE NOT SHOWN BUT SHALL BE PROVIDED.
  7. ALL CIRCUITRY IS NOT SHOWN INTENTIONALLY. REFER TO OTHER DRAWINGS AND SPECIFICATIONS FOR COMPLETE CONDUIT AND CONDUCTOR REQUIREMENTS, INCLUDING BUT NOT LIMITED TO: SINGLE LINE DIAGRAMS, AND PANEL SCHEDULES.
  8. KEEP AC AND DC VOLTAGES SEPARATED A MINIMUM OF 12 INCHES.

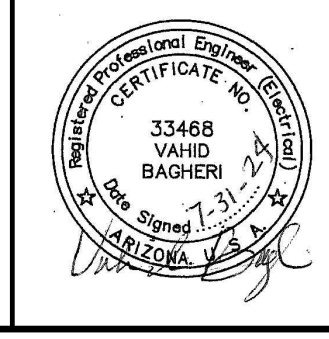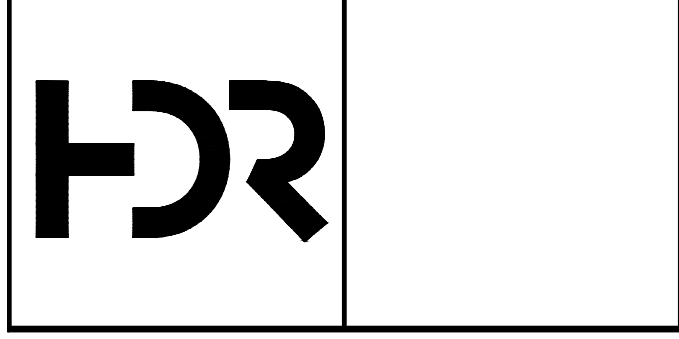

REVISIONS				
NO.	BY	DATE	CKD	REMARKS

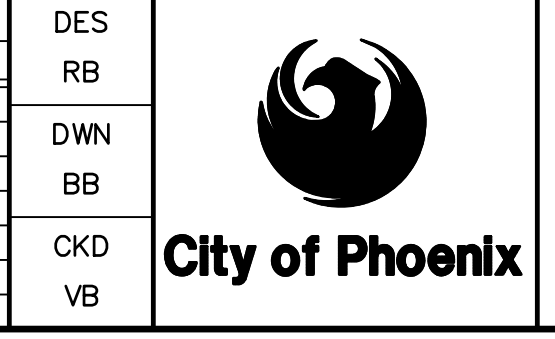

CITY OF PHOENIX  
WATER SERVICES DEPARTMENT  
**LIFT STATION 40  
REFURBISHMENT**

ELECTRICAL  
**CONDUIT BLOCK DIAGRAMS**

COPYRIGHT © 2007-JANUARY  
CITY PROJECT NO. WS90400085  
DATE: 08/2024  
E-27 SHEET 118 OF 134  
CAD FILE: CSELS40EC02.dwg

REVISION	ENGINEERING COMPANY	PROJECT NO.	PROJECT NAME	DATE	CAD FILE NAME	DWG NUMBER	REMARKS

FOR CITY OF PHOENIX USE ONLY - REFERENCE CID NUMBER: #  
# # #

FACILITY DRAWINGS  
This drawing was supplied by a Consultant Engineer from a past construction project. The original contractor to provide the Record Drawing on information provided by the Contractor to provide the Record Drawing. The City does not warrant the accuracy and reliability of the information and accuracy of the drawings and facilities as they exist in the field.


THIS DRAWING MUST BE FIELD VERIFIED BEFORE USE  
DRAWING NOT TO SCALE UNLESS SCALE BAR IS PRESENT

FOR CONSTRUCTION

PER CITY OF PHOENIX CODE CHAPTER 2, SECTION 2-28, THESE PLANS ARE FOR OFFICIAL USE ONLY AND MAY NOT BE SHARED WITH OTHERS EXCEPT AS REQUIRED TO FULFILL THE OBLIGATIONS OF THE CONTRACTOR'S CONTRACT WITH THE CITY OF PHOENIX. THIS DOCUMENT MUST BE KEPT SECURE AT ALL TIMES.

**GENERAL NOTES:**

1. THE TYPICAL DETAILS ARE NOT REFERENCED ON EACH AND EVERY DRAWING. THE TYPICAL DETAILS ARE NOT REFERENCED ON EACH AND EVERY TYPE OF INSTALLATION. THE TYPICAL DETAILS HOWEVER SHALL BE ADHERED TO WHERE THE INSTALLATION APPLIES.
2. WHERE THE INSTALLATION OF TYPICAL DETAILS CANNOT BE PERFORMED EXACTLY PER THE TYPICAL DETAIL, SIMILAR INSTALLATION DETAIL MAY BE ACCEPTABLE. SUBMIT SIMILAR INSTALLATION DETAIL FOR REVIEW BY THE ENGINEER PRIOR TO ANY WORK.

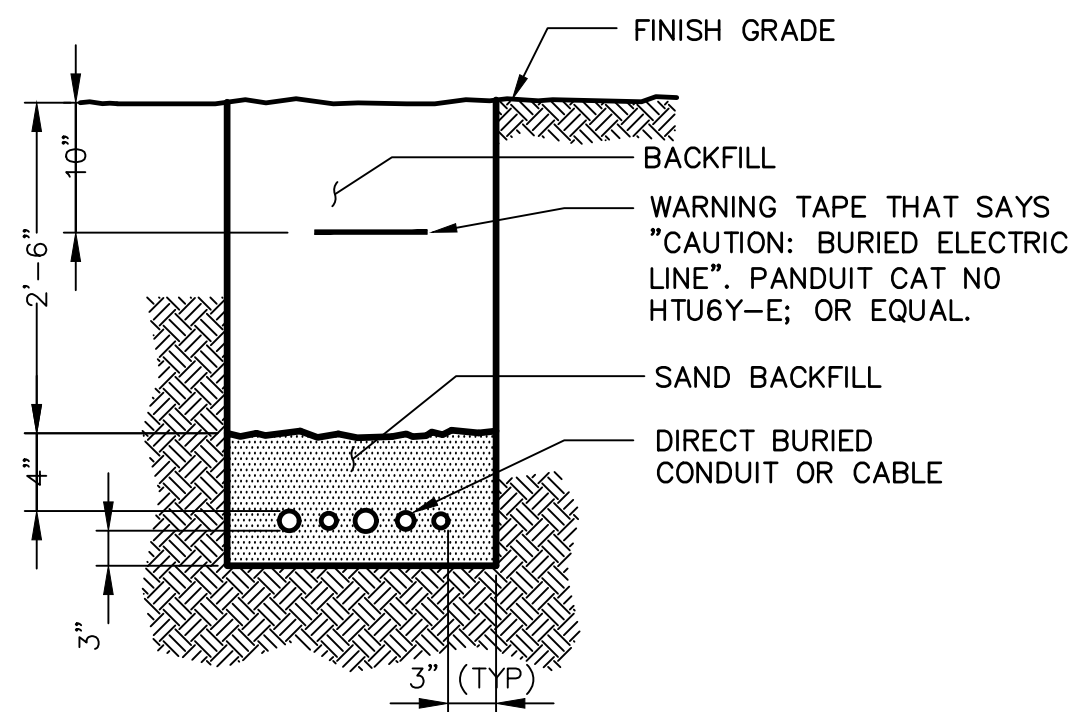


**NOTES:**

1. ALL DIMENSIONS ARE MINIMUM UNLESS OTHERWISE INDICATED ON THE DRAWINGS.
2. REFER TO SPECIFICATIONS FOR TRENCH BACKFILL REQUIREMENTS.

DETAIL E100 # # DIRECT BURIED CONDUIT OR CABLE

SCALE = NONE

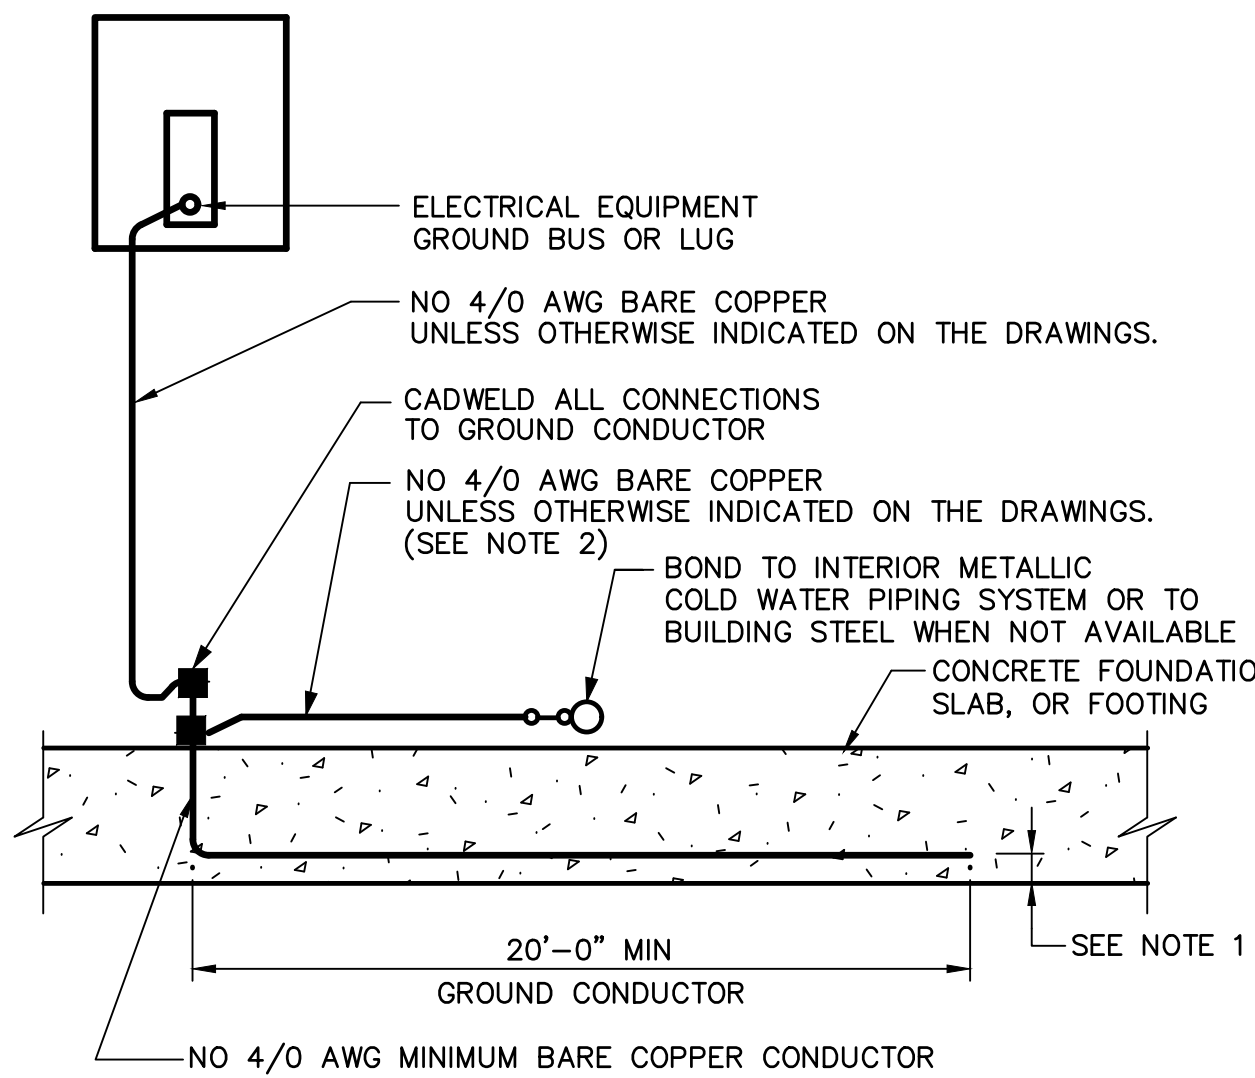


**NOTE:**

1. 1" CLEAR FOR ELEVATED SLABS. 3" CLEAR FOR SLABS ON GRADE OR FOOTING.
2. PLACE ALL CONDUCTOR IN CONDUIT WHERE EXPOSED TO POSSIBLE PHYSICAL DAMAGE.

DETAIL E104 # # CONCRETE ENCASED GROUND

N.T.S.

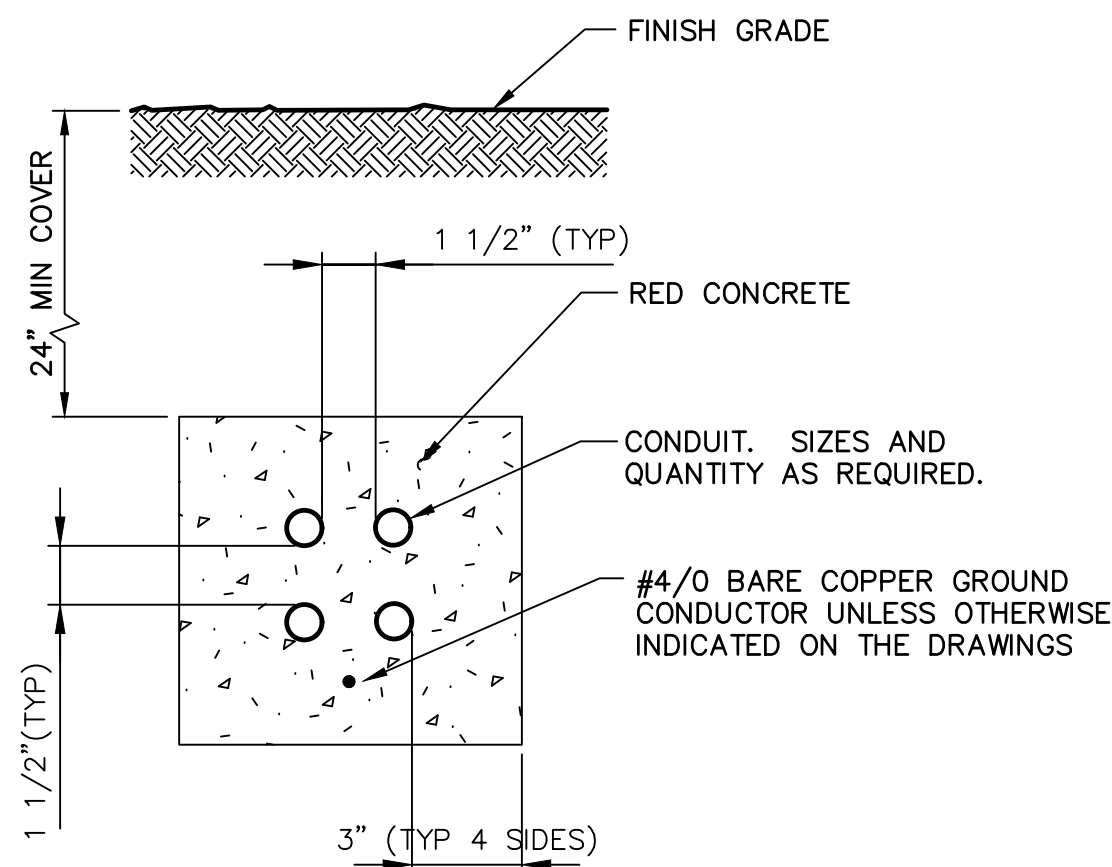


**NOTES:**

1. ALL DIMENSIONS ARE MINIMUM UNLESS OTHERWISE INDICATED ON THE DRAWINGS.
2. THIS ENCASEMENT IS FOR NON-TRAFFIC AREAS ONLY, OR WHERE SPECIFICALLY INDICATED ON THE DRAWINGS.


DETAIL E101 # # UNREINFORCED ENCASEMENT FOR ELECTRICAL CONDUITS IN NON-TRAFFIC RATED AREAS

SCALE = NONE

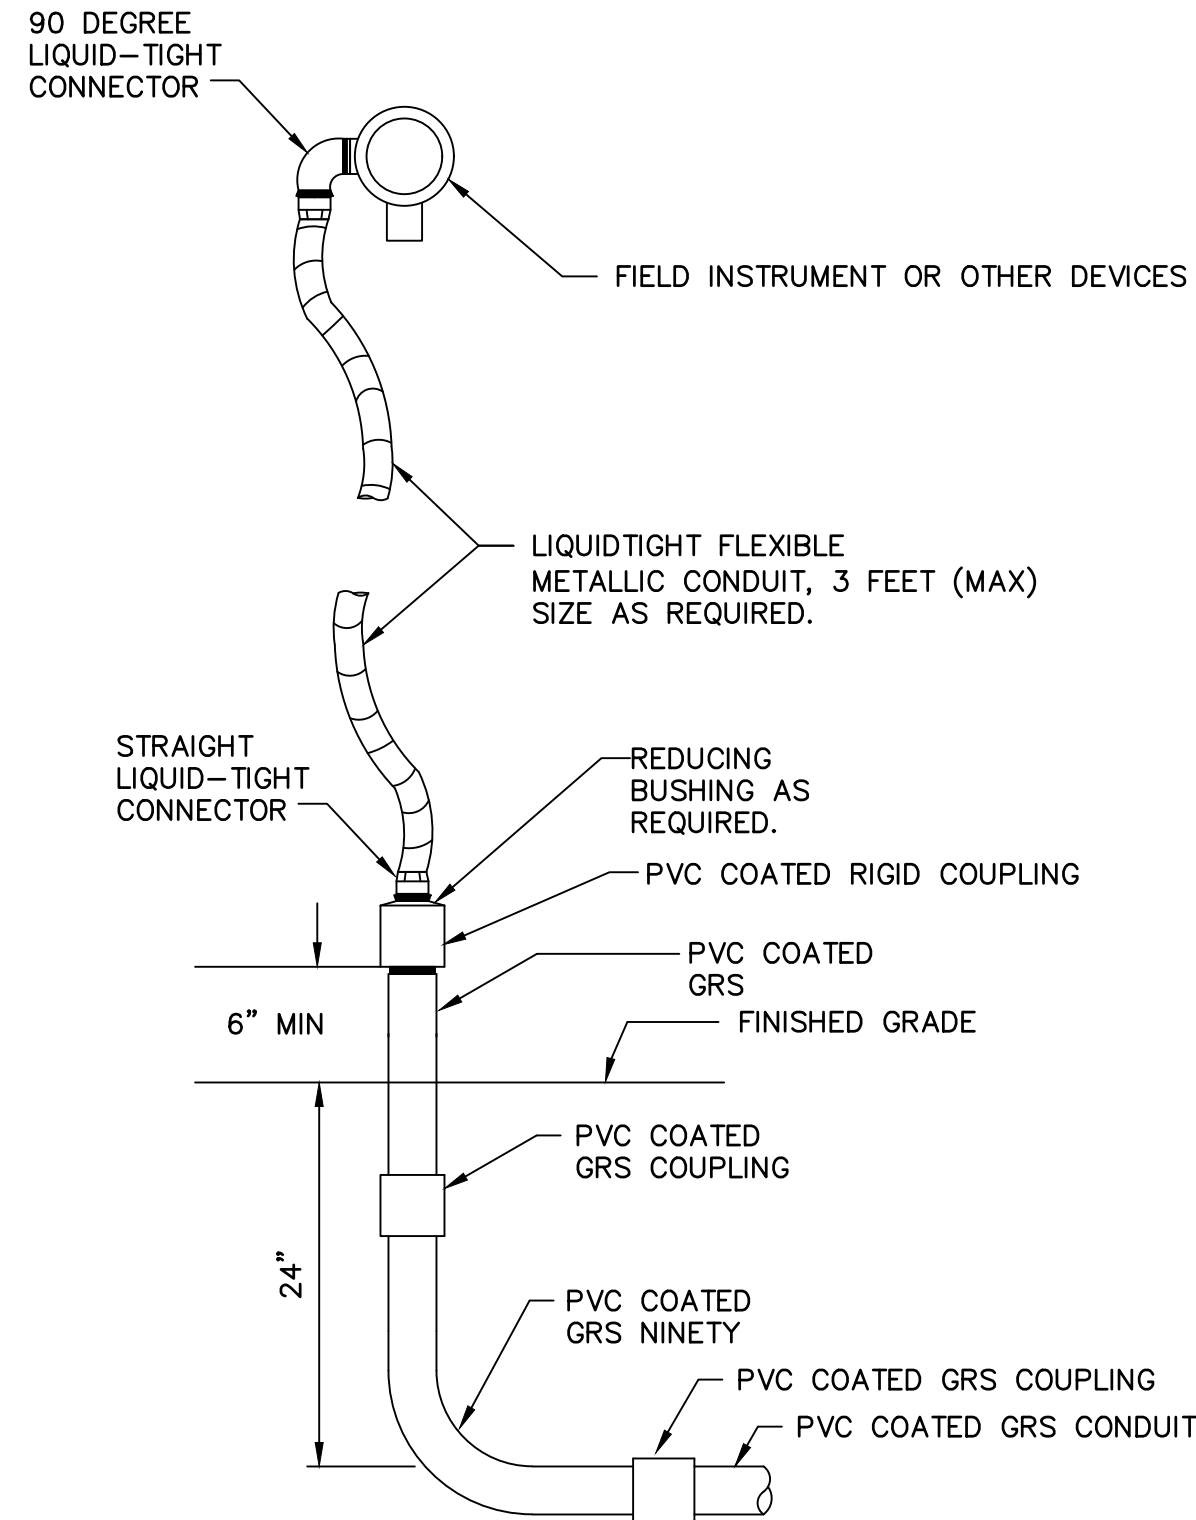

DETAIL E200 # # PVC-COATED-GRS STUB UPS

N.T.S.

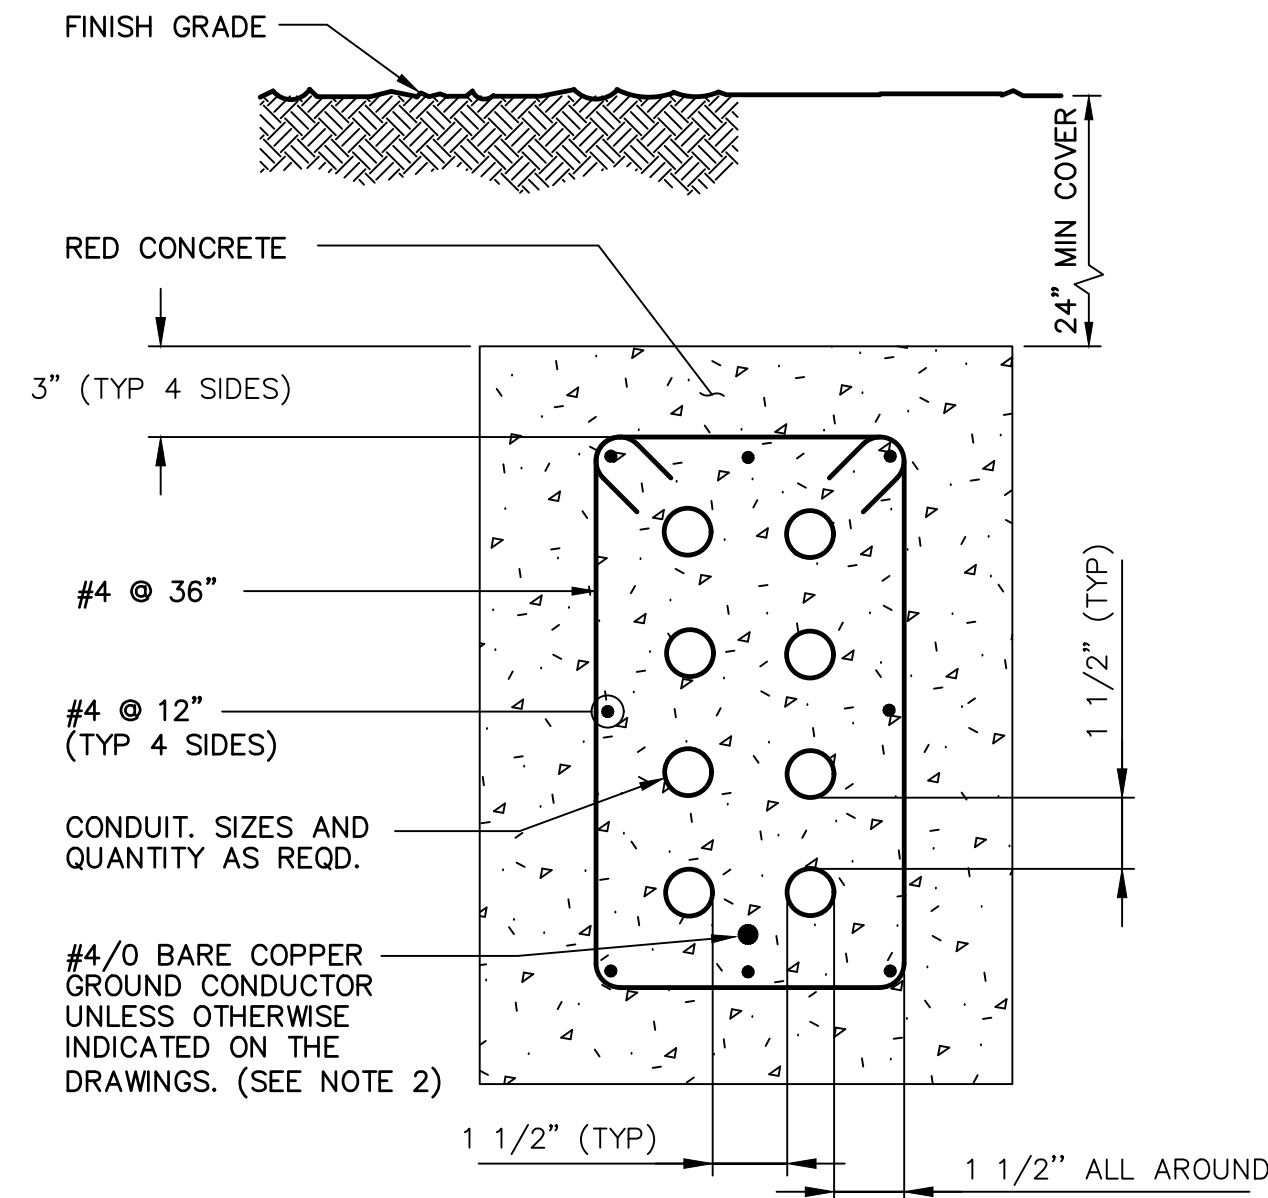


**NOTES:**

1. ALL DIMENSIONS ARE MINIMUM UNLESS OTHERWISE INDICATED ON THE DRAWINGS.
2. PROVIDE 250 KCMIL BARE COPPER IN ALL MEDIUM VOLTAGE DUCTBANKS.
3. SPACING SHALL B2 7-1/2" ON CENTER FOR MEDIUM VOLTAGE DUCTBANKS.

DETAIL E102 # # REINFORCED ENCASEMENT FOR ELECTRICAL CONDUITS IN TRAFFIC RATED AREAS

SCALE = NONE

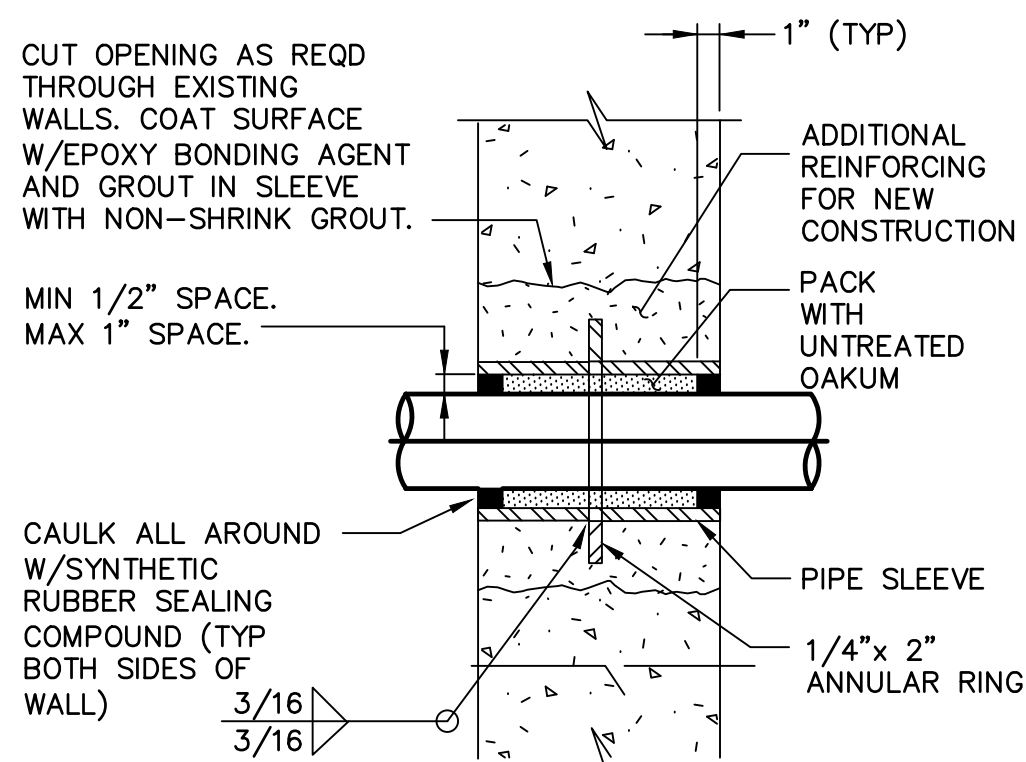


**NOTES:**

1. FOR NEW CONSTRUCTION, SLEEVES SHALL BE CAST INTO WALL. BLOCKOUTS AND SUBSEQUENT GROUTING IN SLEEVES WILL NOT BE PERMITTED UNLESS A KEYS WATERSTOP JOINT IS PROVIDED.
2. 6" SLEEVES AND SMALLER SHALL BE SCH 40 STL PIPE.
3. SLEEVES LARGER THAN 6" SHALL BE 1/4" THICK STL PIPE.
4. NEOPRENE LINK SEAL W/STL BOLTS MAY BE SUBSTITUTED FOR OAKUM & SYNTHETIC RUBBER SEAL. IF LINK SEALS ARE USED IN WALLS THICKER THAN 12", LINK SEAL SHALL BE INSTALLED AT BOTH ENDS OF WALL SLEEVE. SLEEVE DIAMETER SHALL BE PER LINK SEAL MANUFACTURER'S RECOMMENDATION.
5. SLEEVE SHALL BE HOT-DIP GALVANIZED AFTER FABRICATION.

DETAIL E300 # # SLEEVE - INSTALLATION THROUGH WALLS AND FLOOR SLABS

N.T.S.

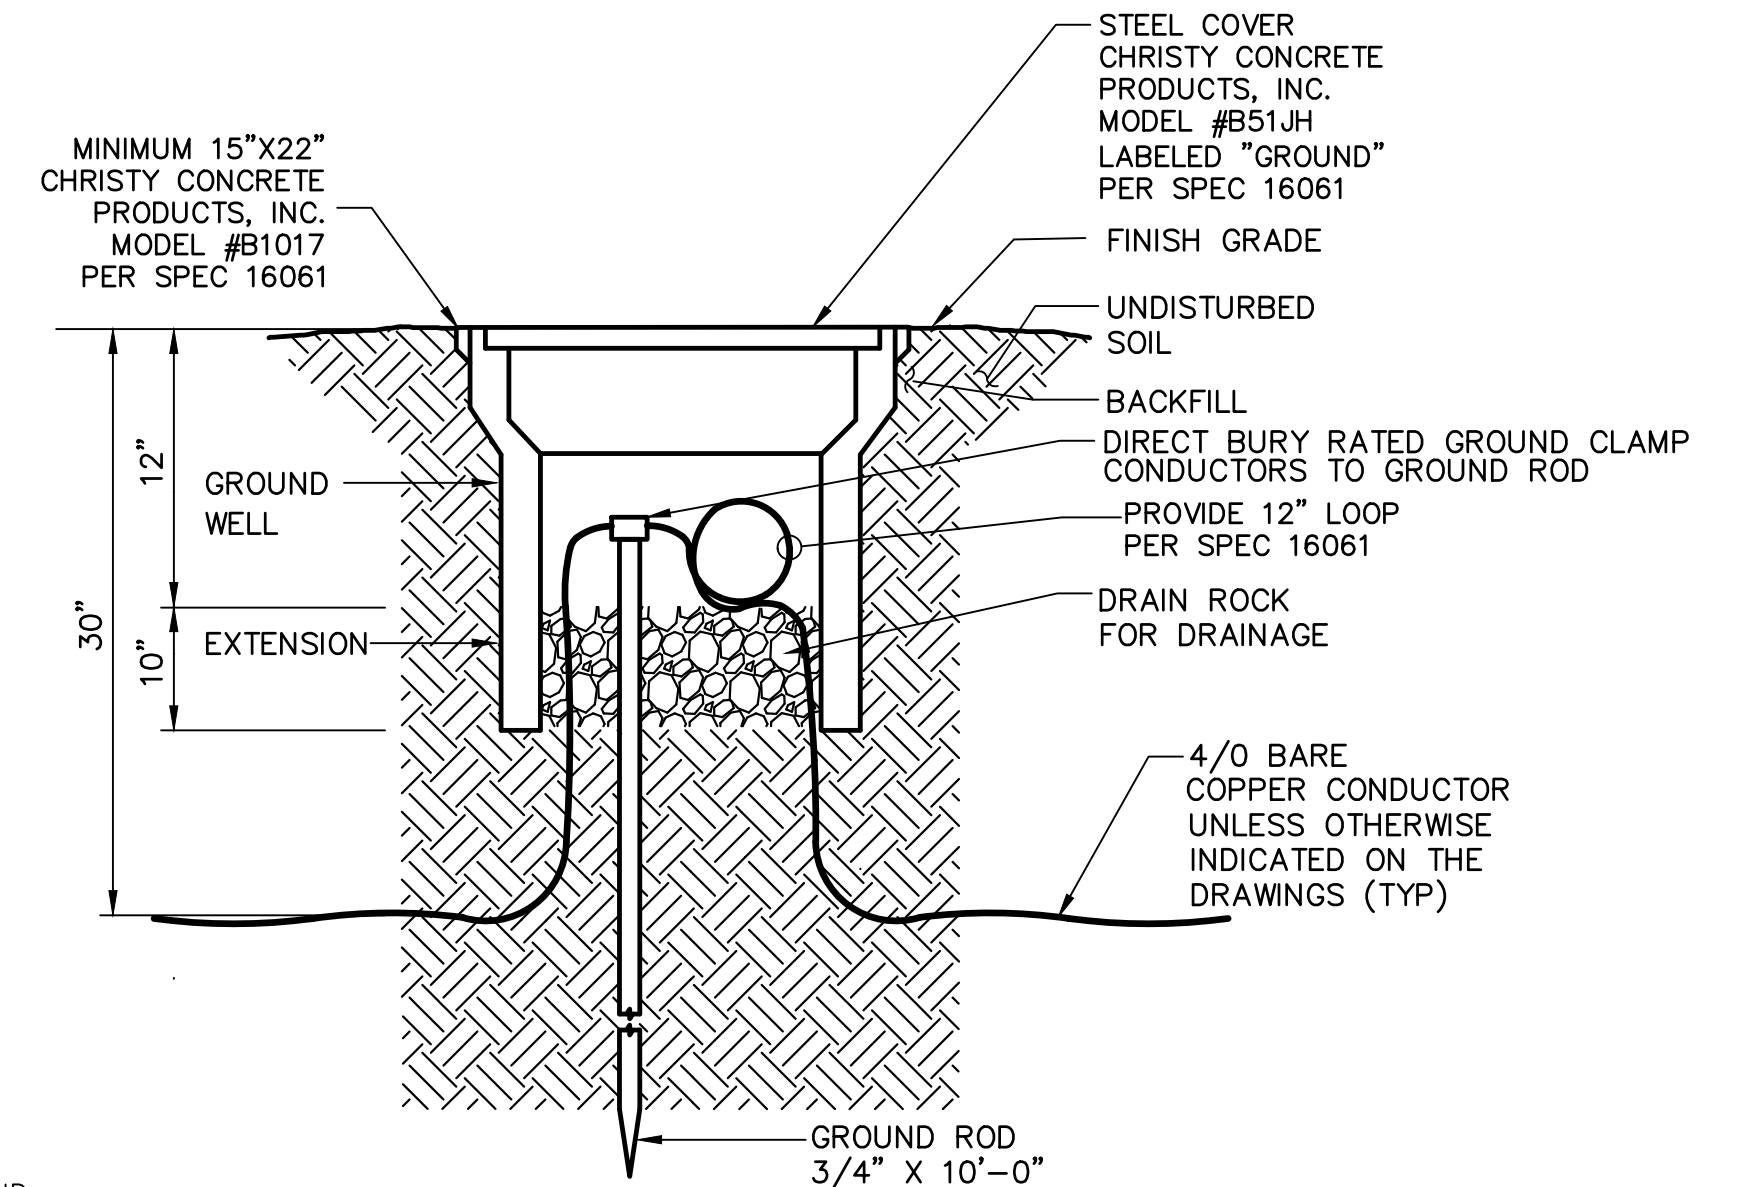


**NOTES:**

1. REFER TO SPECIFICATION 16061.

DETAIL E103 # # GROUND ROD INSTALLATION

N.T.S.

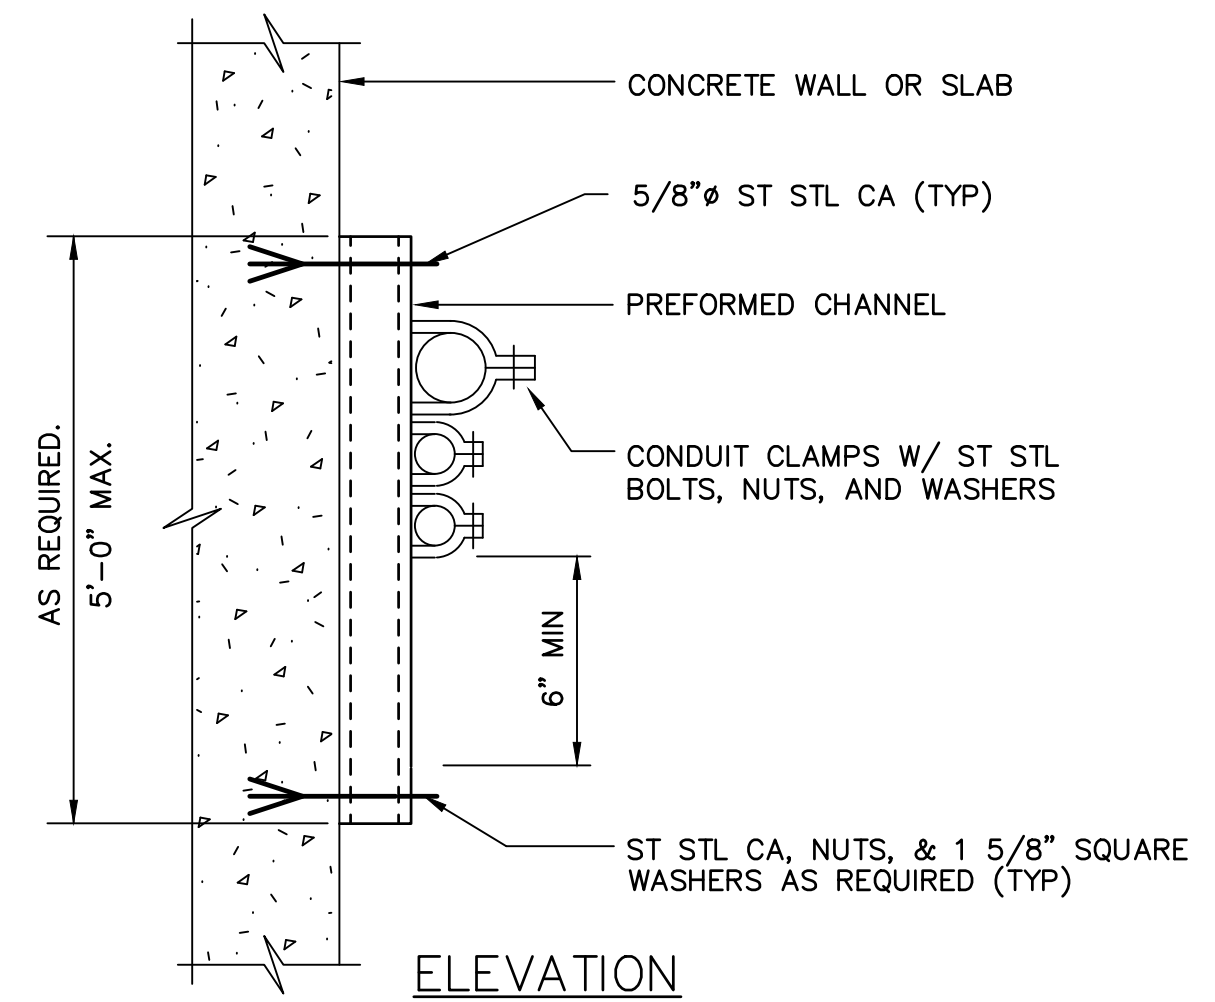

**NOTES:**

1. THIS DETAIL TYPICAL FOR BOTH VERTICAL AND HORIZONTAL MOUNTING.
2. PREFORMED CHANNEL, FITTINGS, AND CLAMPS SHALL BE STAINLESS STEEL. FIELD COAT ALL CUTS PER SPECIFICATIONS.
3. CHANNELS TO BE SPACED AT 5'-0" OC MAXIMUM.
4. PROVIDE STAINLESS STEEL CHANNEL AND MOUNTING HARDWARE.

DETAIL E301 # # CONDUIT SUPPORT

N.T.S.

REVISIONS				
NO.	BY	DATE	CKD	REMARKS

DES  
RB  
DWN  
BB  
CKD  
VB



CITY OF PHOENIX  
WATER SERVICES DEPARTMENT  
  
LIFT STATION 40  
REFURBISHMENT

ELECTRICAL  
  
ELECTRICAL DETAILS 1

COPYRIGHT © 2007-JANUARY  
CITY PROJECT NO. WS90400085  
DATE: 08/2024  
E-28 SHEET 119 OF 134  
CAD FILE: CEELS40ED01.dwg


FACILITY DRAWINGS  
This drawing was supplied by a Consultant Engineer from a past construction project. The original contractor drawing was modified based on information provided by the Contractor to provide the Record Drawing. The City does not warrant the accuracy and/or completeness and accurate portrayal of facilities as they exist in the field.

REVISIONS	DWG NUMBER	CAD FILE NAME	DATE	PROJECT NAME	PROJECT NO.	REFERENCE CID NUMBER


THIS DRAWING MUST BE FIELD VERIFIED BEFORE USE  
DRAWING NOT TO SCALE UNLESS SCALE BAR IS PRESENT

FOR CONSTRUCTION


"PER CITY OF PHOENIX CODE CHAPTER 2, SECTION 2-28, THESE PLANS ARE FOR OFFICIAL USE ONLY AND MAY NOT BE SHARED WITH OTHERS EXCEPT AS REQUIRED TO FULFILL THE OBLIGATIONS OF THE CONTRACTOR'S CONTRACT WITH THE CITY OF PHOENIX."  
THIS DOCUMENT MUST BE KEPT SECURE AT ALL TIMES.

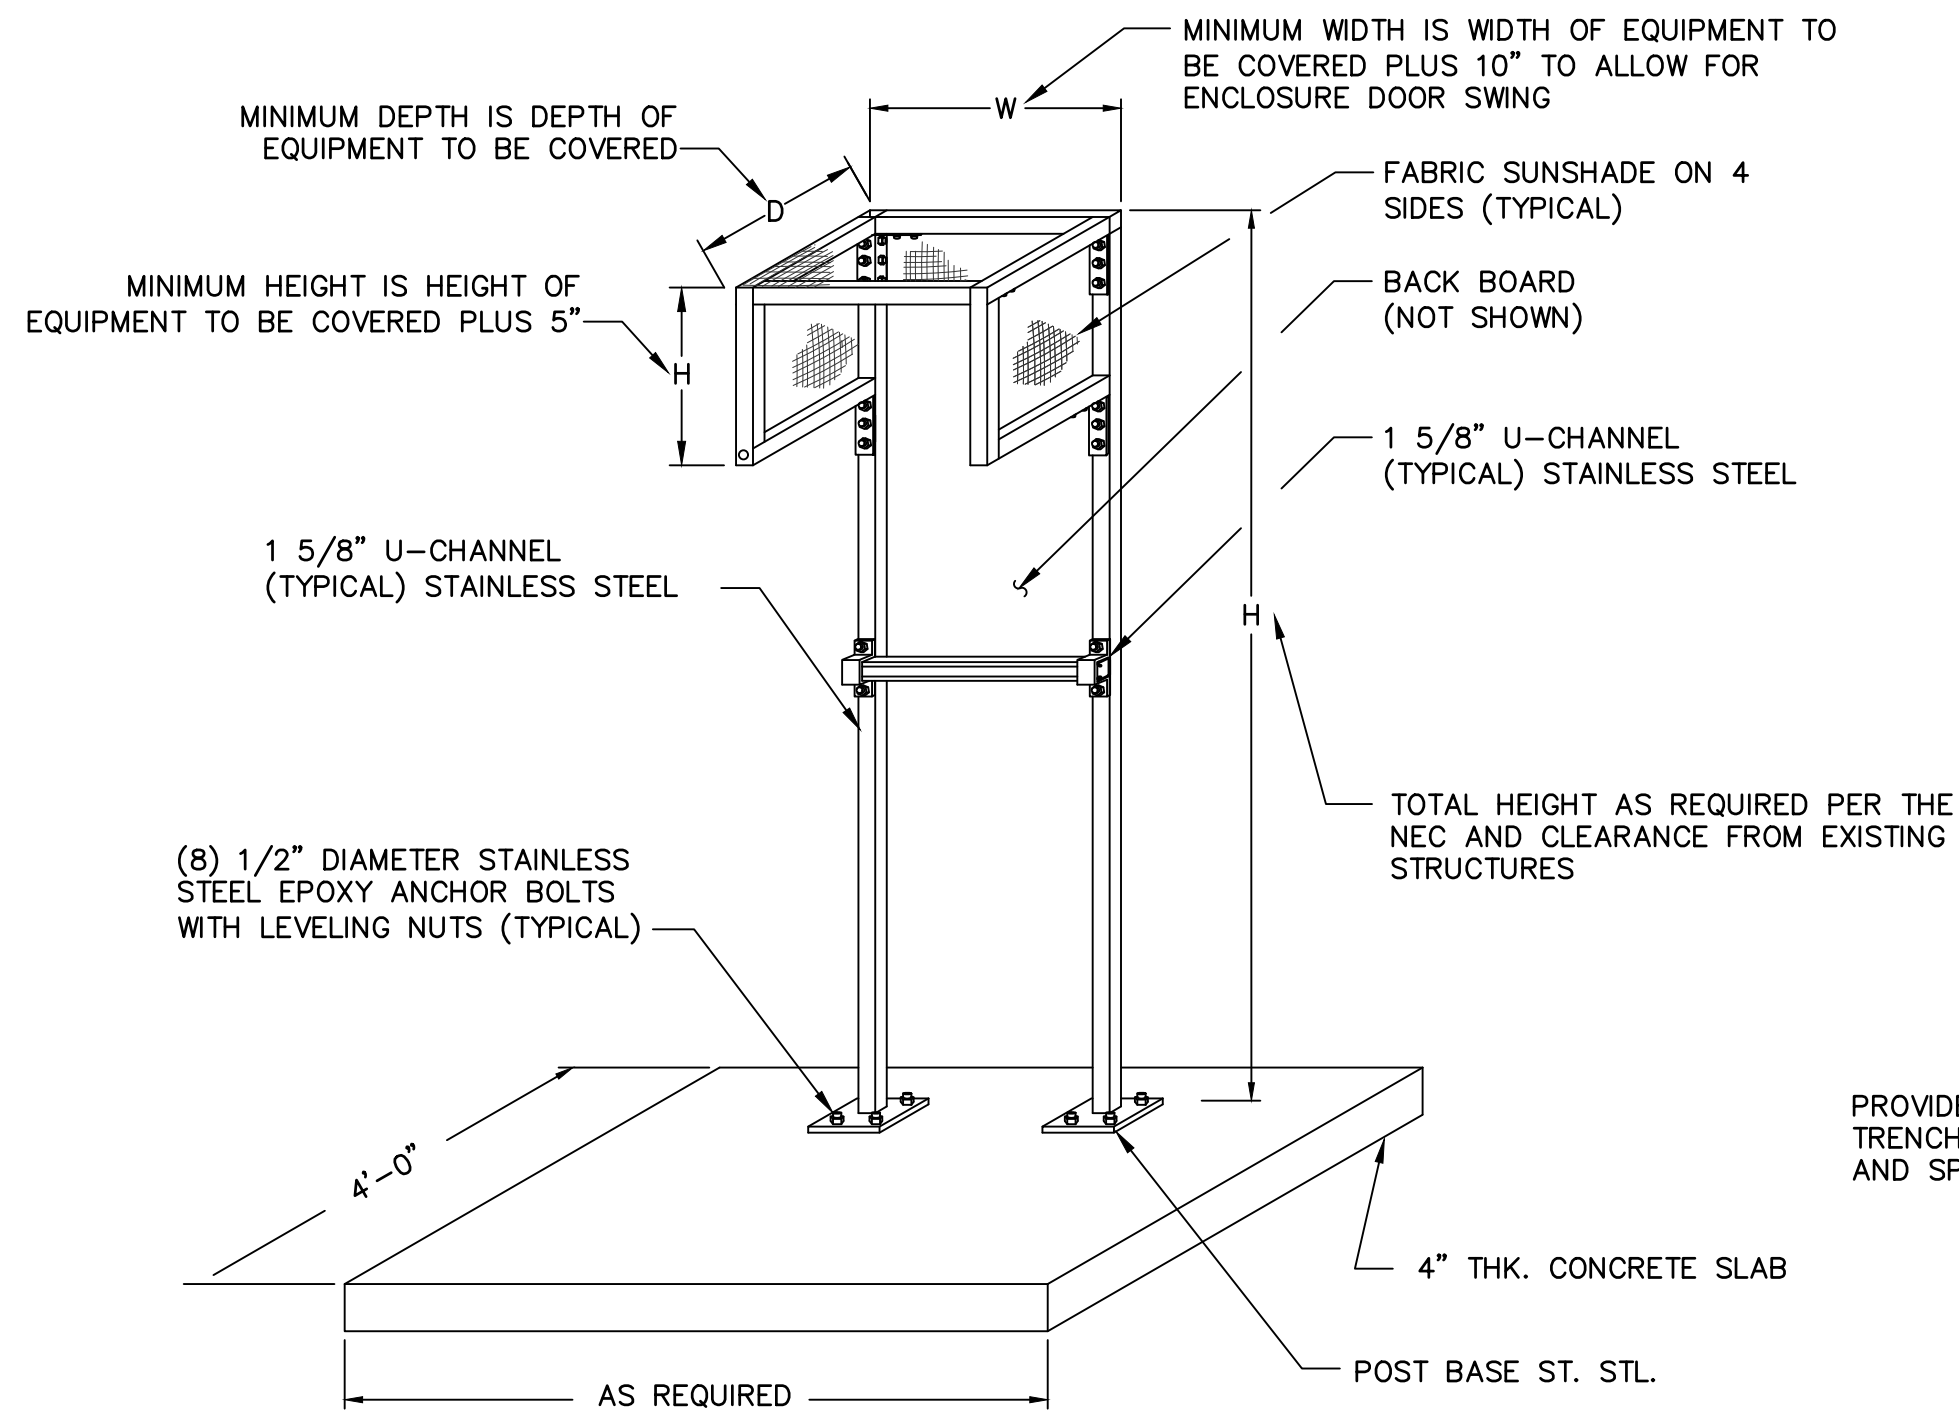



**E400** EQUIPMENT SUNSHADE  
# #  
N.T.S.

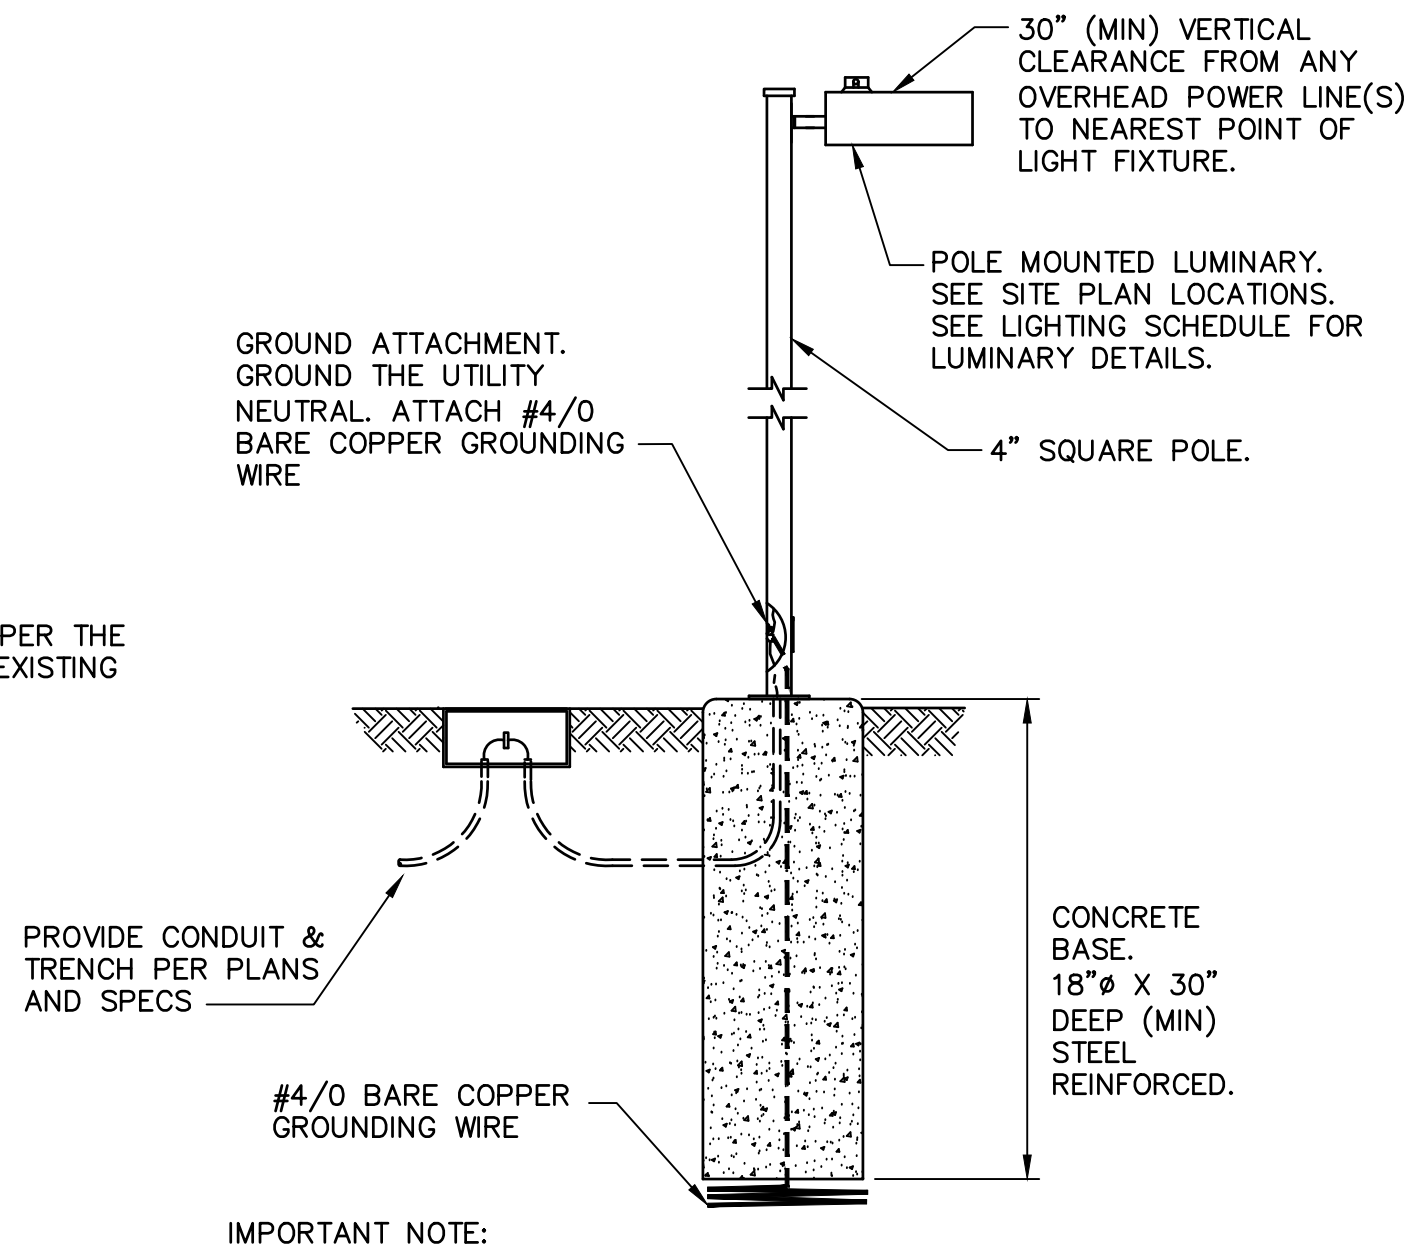

**E500** POLE MOUNTED LIGHT DETAIL  
# #  
N.T.S.

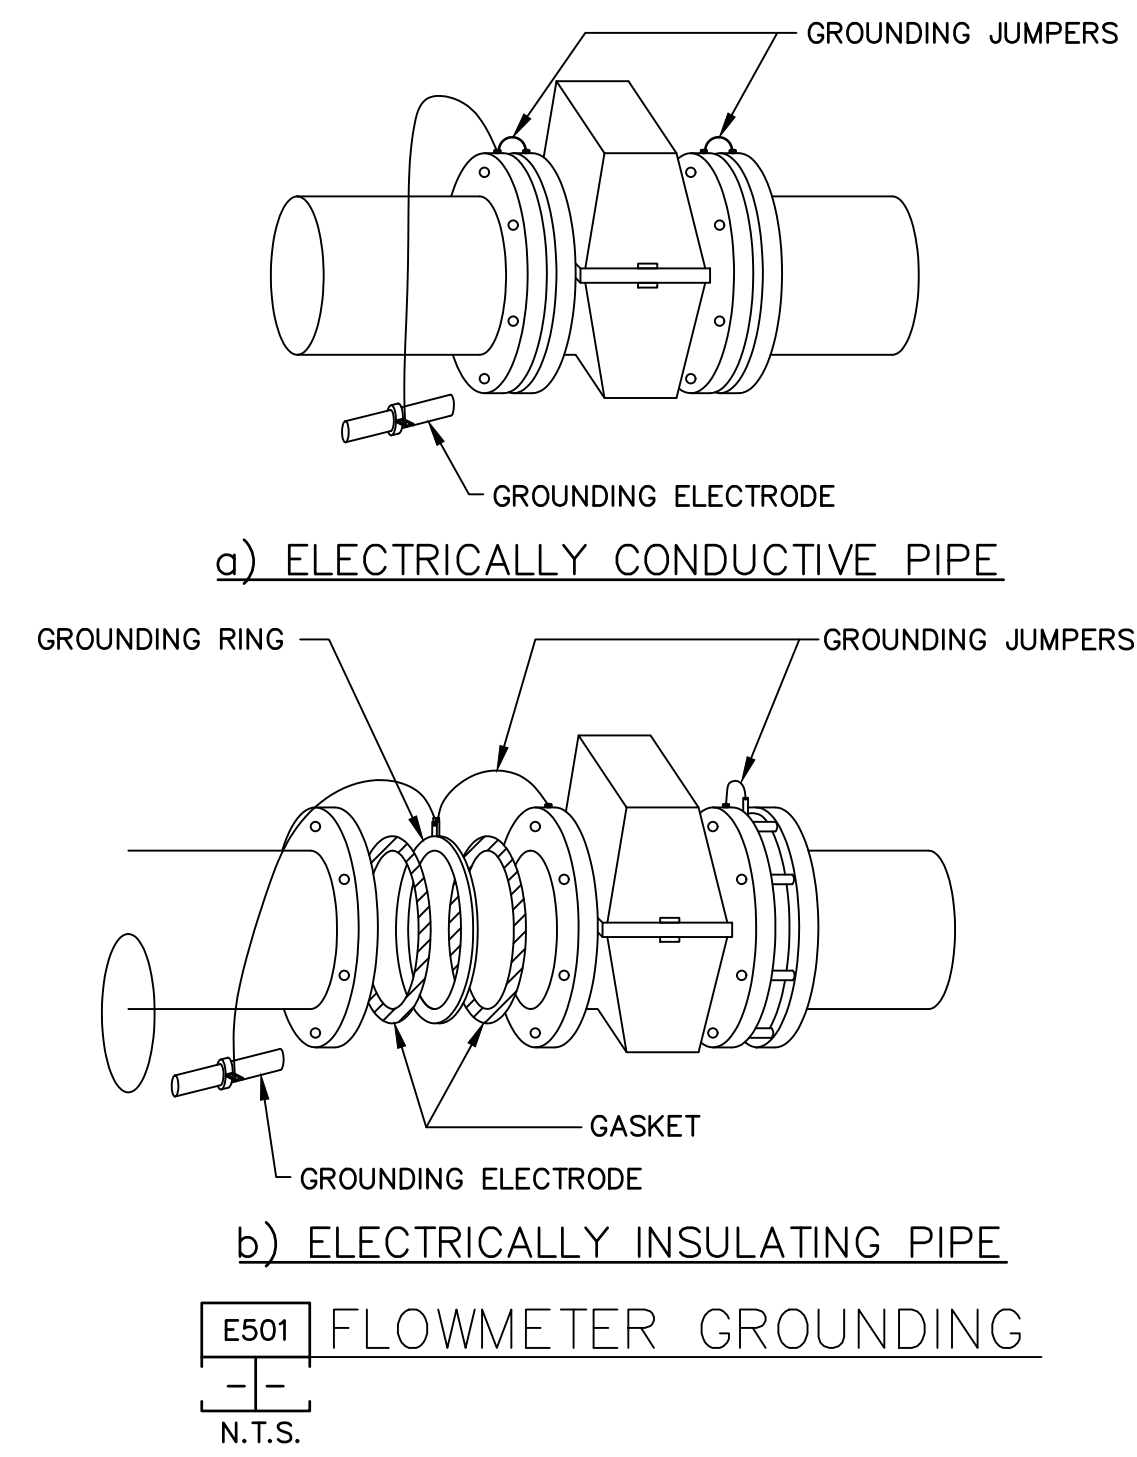


**E501** FLOWMETER GROUNDING  
# #  
N.T.S.

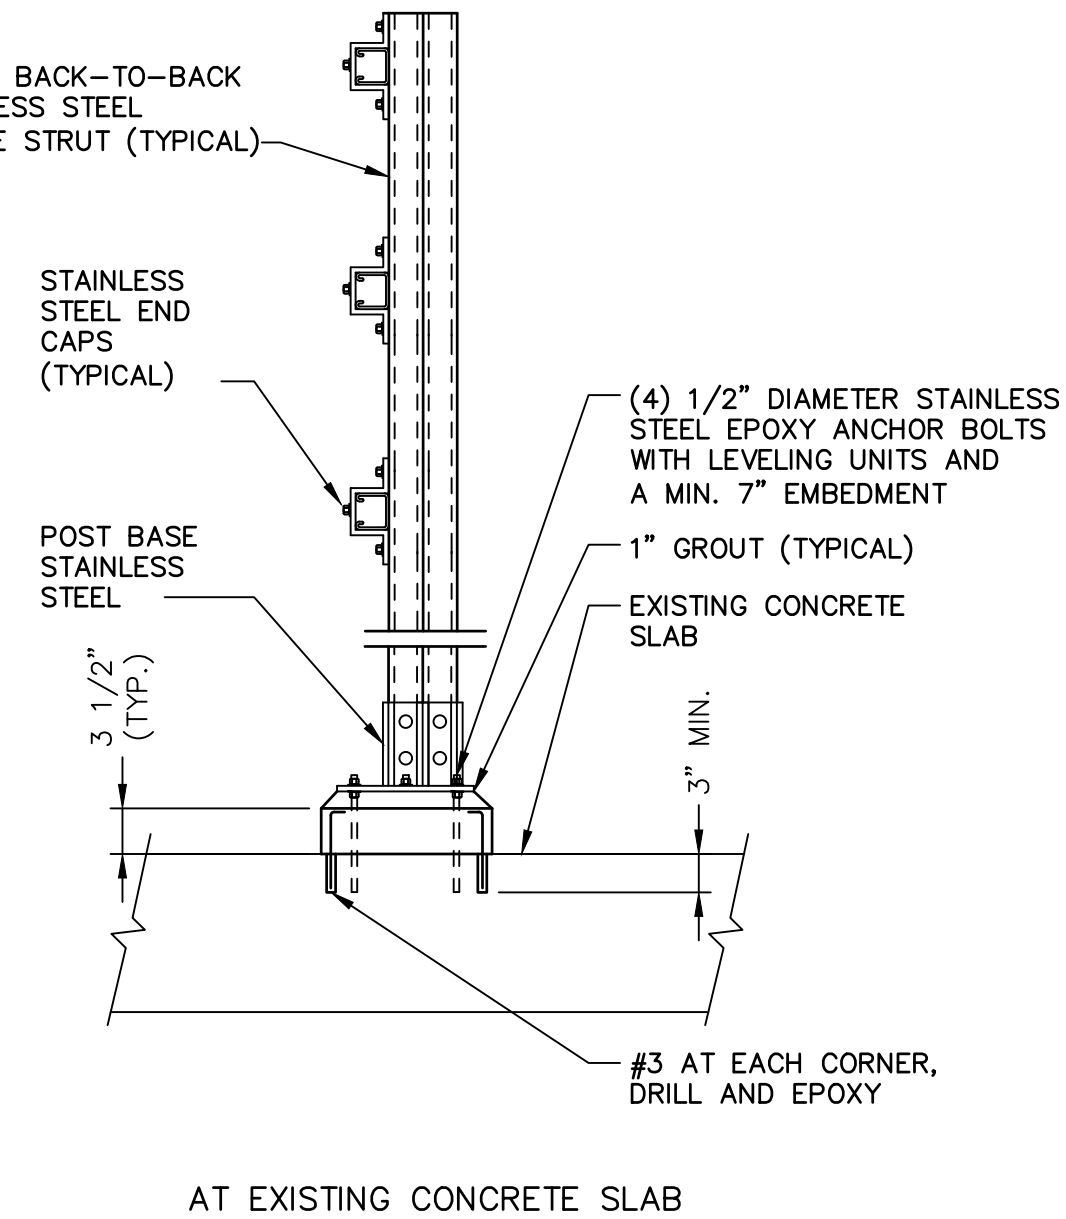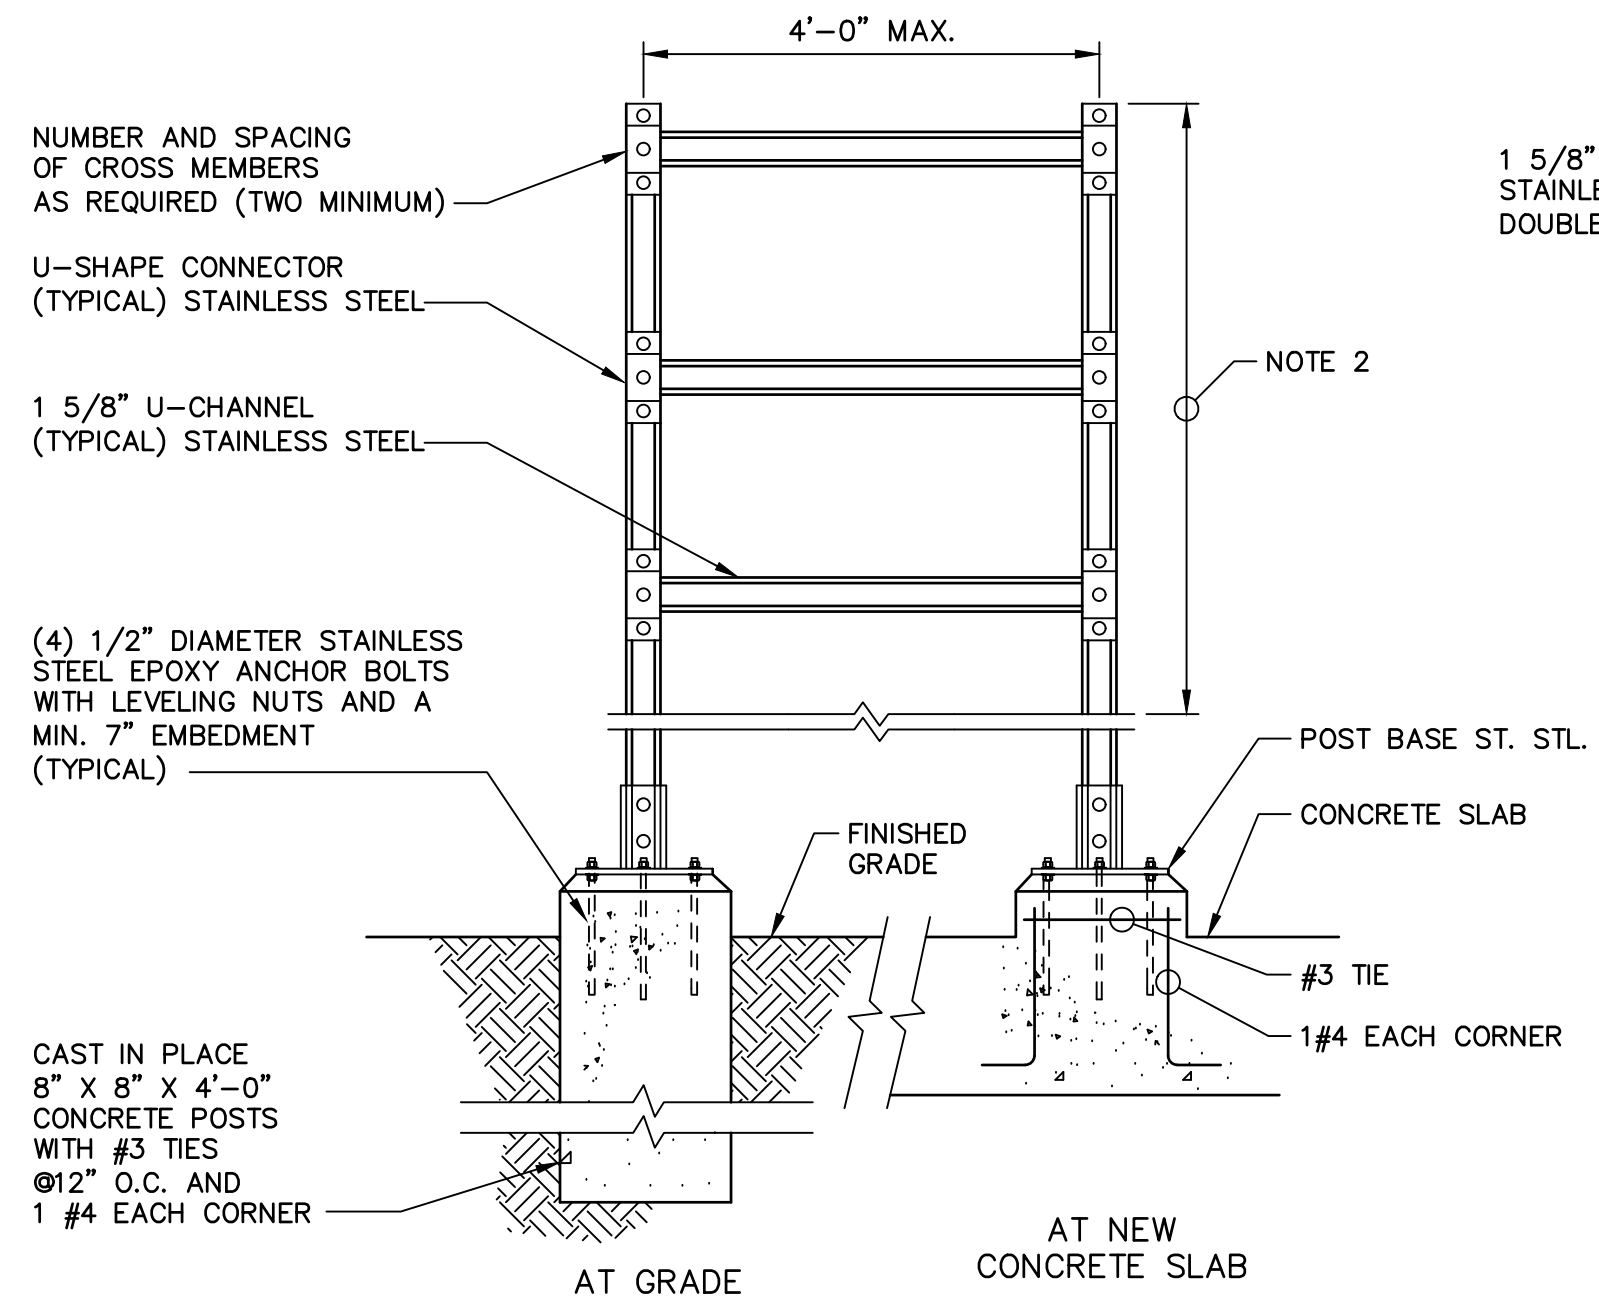

- NOTES:**
- EQUIPMENT FOOTPRINT AREAS ARE MOUNTED ON THE RACK, 1/4" PLATE CAN BE UTILIZED SPANNING FROM THE TOP TO THE BOTTOM CROSS MEMBER IN LIEU OF MULTIPLE CROSS MEMBERS.
  - EQUIPMENT SHALL BE MOUNTED SO THAT INDICATION, ADJUSTMENTS, OR OPERATING HANDLES ARE FOUR TO FIVE FEET ABOVE FLOOR OR PLATFORM.
  - ANCHORAGE MATERIALS AND METHODS AS REQUIRED.
  - MATERIALS AND HARDWARE SHALL CONFORM TO THE REQUIREMENTS OF THE SPECIFICATIONS AND INDUSTRY ESTABLISHED STANDARDS.


**E502** EQUIPMENT SUPPORT STRUCTURE  
# #  
N.T.S.

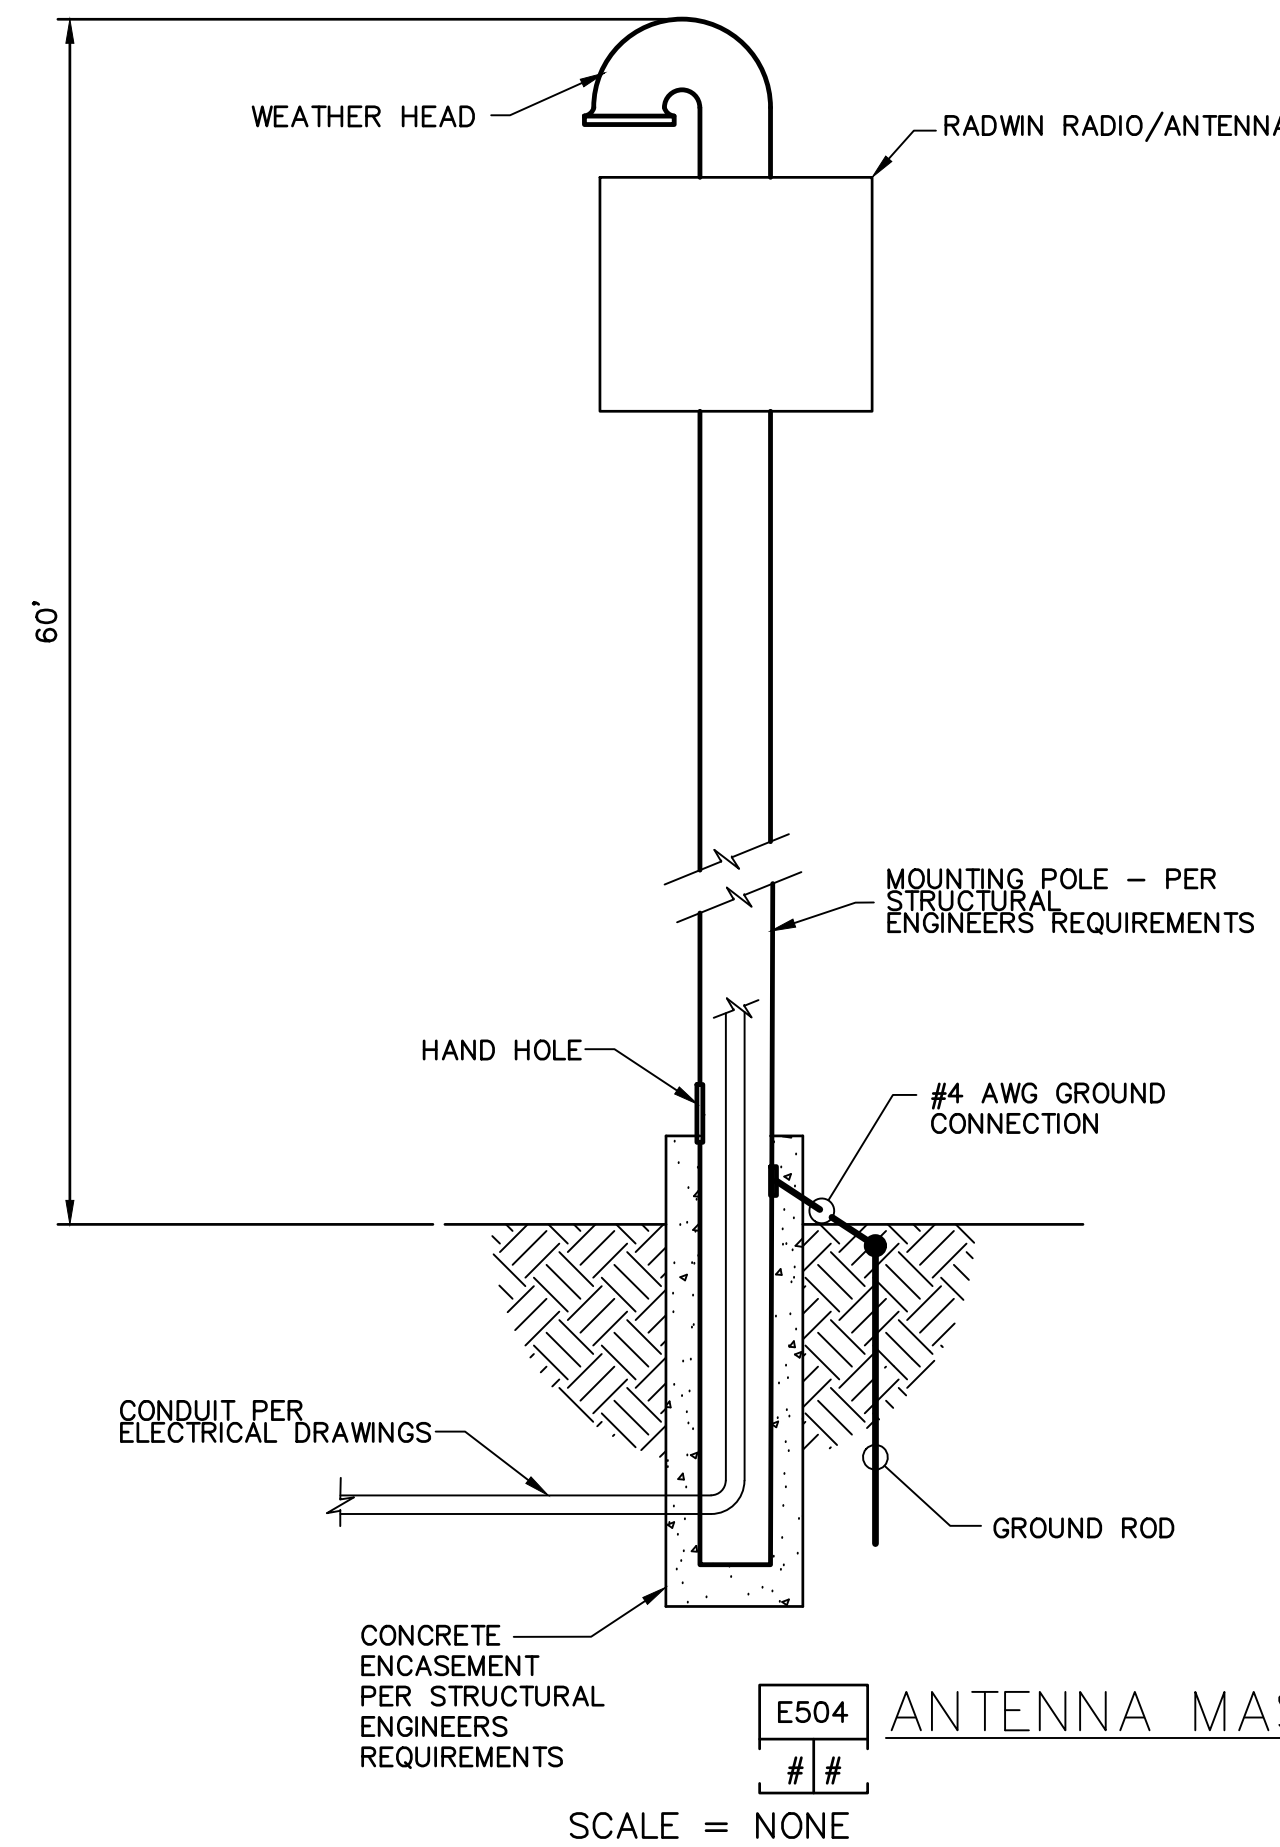

**E504** ANTENNA MAST DETAIL  
# #  
SCALE = NONE

**GENERAL NOTES:**

- THE TYPICAL DETAILS ARE NOT REFERENCED ON EACH AND EVERY DRAWING. THE TYPICAL DETAILS ARE NOT REFERENCED ON EACH AND EVERY TYPE OF INSTALLATION. THE TYPICAL DETAILS HOWEVER SHALL BE ADHERED TO WHERE THE INSTALLATION APPLIES.
- WHERE THE INSTALLATION OF TYPICAL DETAILS CANNOT BE PERFORMED EXACTLY PER THE TYPICAL DETAIL, SIMILAR INSTALLATION DETAIL MAY BE ACCEPTABLE. SUBMIT SIMILAR INSTALLATION DETAIL FOR REVIEW BY THE ENGINEER PRIOR TO ANY WORK.

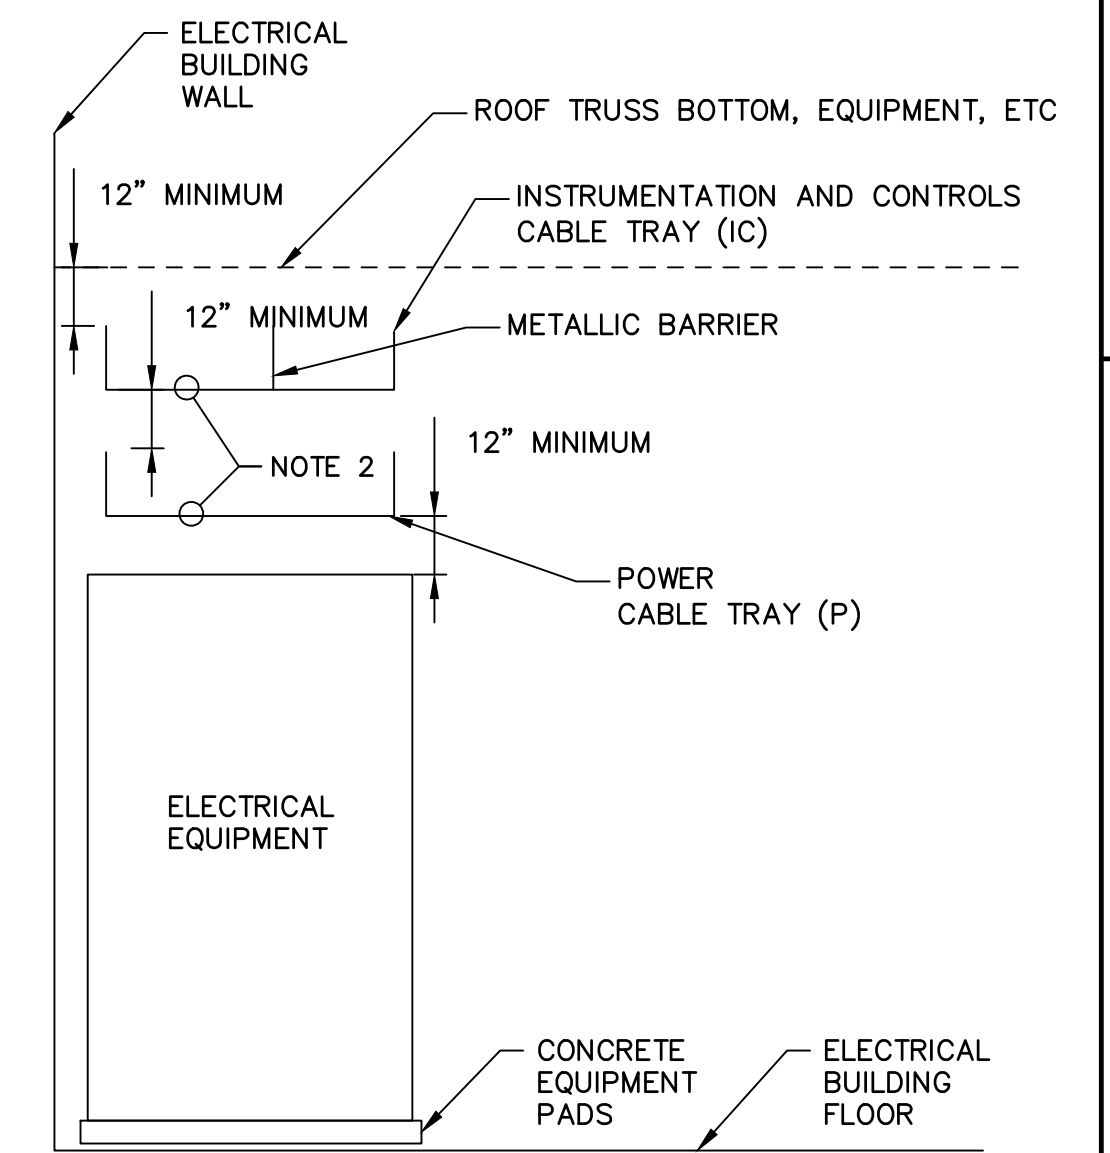

- NOTES:**
- CABLE TRAY SYSTEM TO BE DESIGNED, FURNISHED, AND INSTALLED BY THE CONTRACTOR. SEE SPECIFICATIONS FOR MORE DETAILS.
  - CABLE TRAY SHALL BE A MINIMUM OF 6" HIGH AND 36" WIDE.
  - KEEP AC AND DC IN (IC) TRAY SEPARATED USING METALLIC BARRIERS.

**E525** CABLE TRAY DETAIL  
# #  
N.T.S.

REVISIONS				
NO.	BY	DATE	CKD	REMARKS

DES RB  
DWN BB  
CKD VB

CITY OF PHOENIX  
WATER SERVICES DEPARTMENT

LIFT STATION 40  
REFURBISHMENT

ELECTRICAL

ELECTRICAL DETAILS 2

COPYRIGHT © 2007-JANUARY

CITY PROJECT NO. WS90400085

DATE: 08/2024

E-29 SHEET 120 OF 134

CAD FILE: CELS40EED02.dwg

FACILITY DRAWINGS  
This drawing was supplied by a Consultant Engineer from a past construction project. The original contractor drawing was modified based on information provided by the Contractor to provide the Record Drawing. The City does not warrant the accuracy and reliability of any drawings and/or portrayal of facilities as they exist in the field.

REVISION	DWG NUMBER	CAD FILE NAME	DATE	PROJECT NAME	PROJECT NO.	REFERENCE CID NUMBER


FOR CITY OF PHOENIX USE ONLY - REFERENCE CID NUMBER: #



THIS DRAWING MUST BE FIELD VERIFIED BEFORE USE  
DRAWING NOT TO SCALE UNLESS SCALE BAR IS PRESENT


FOR CONSTRUCTION

"PER CITY OF PHOENIX CODE CHAPTER 2, SECTION 2-28, THESE PLANS ARE FOR OFFICIAL USE ONLY AND MAY NOT BE SHARED WITH OTHERS EXCEPT AS REQUIRED TO FULFILL THE OBLIGATIONS OF THE CONTRACTOR'S CONTRACT WITH THE CITY OF PHOENIX."  
THIS DOCUMENT MUST BE KEPT SECURE AT ALL TIMES.

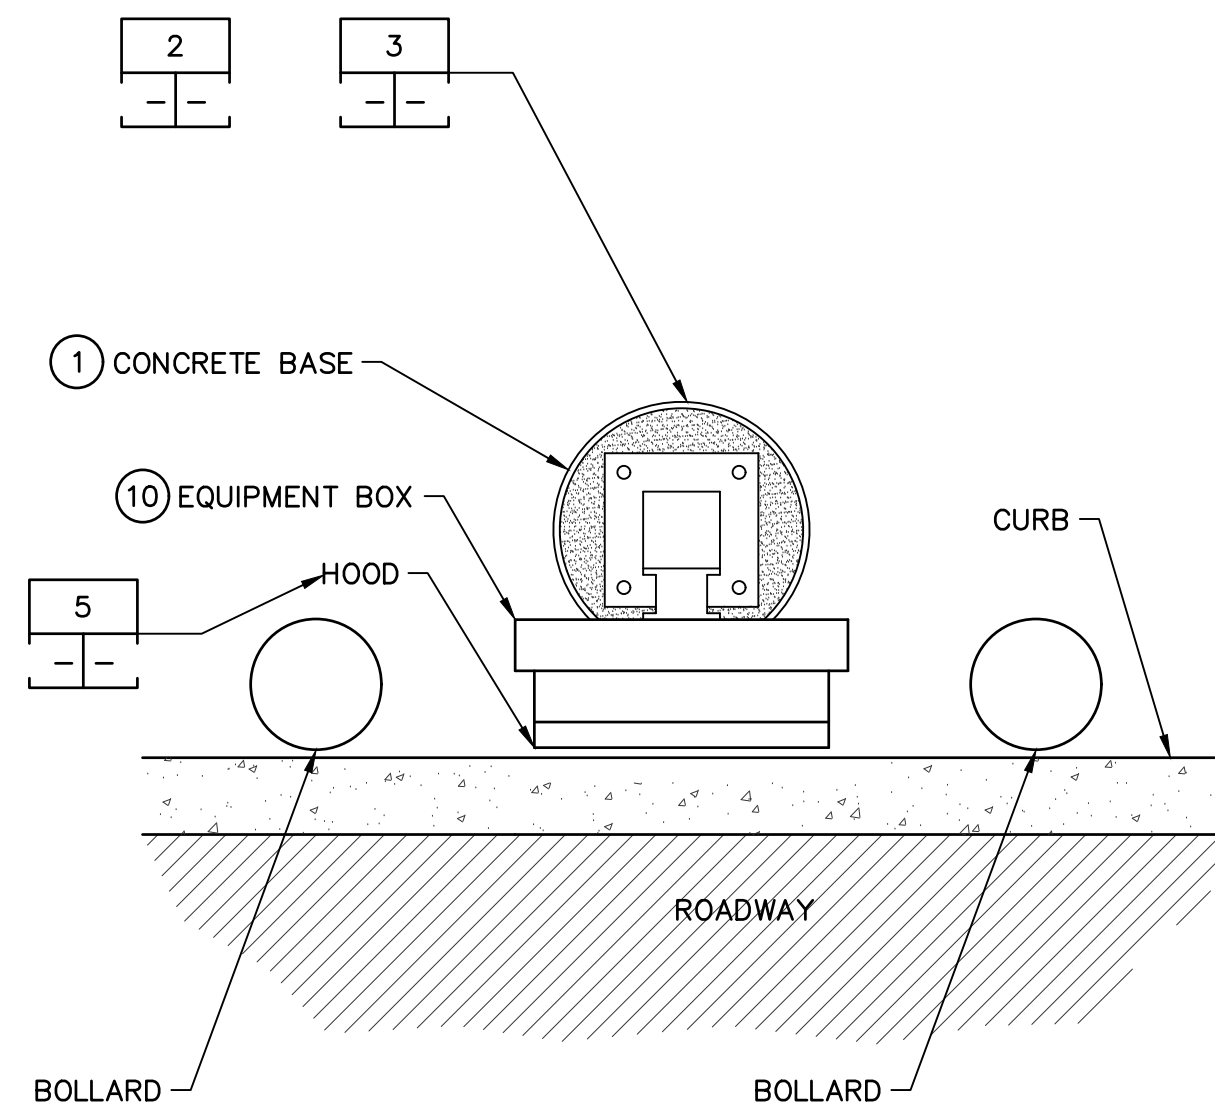

**CARD READER PEDESTAL – TOP VIEW**

DETAIL 1  
NOT TO SCALE

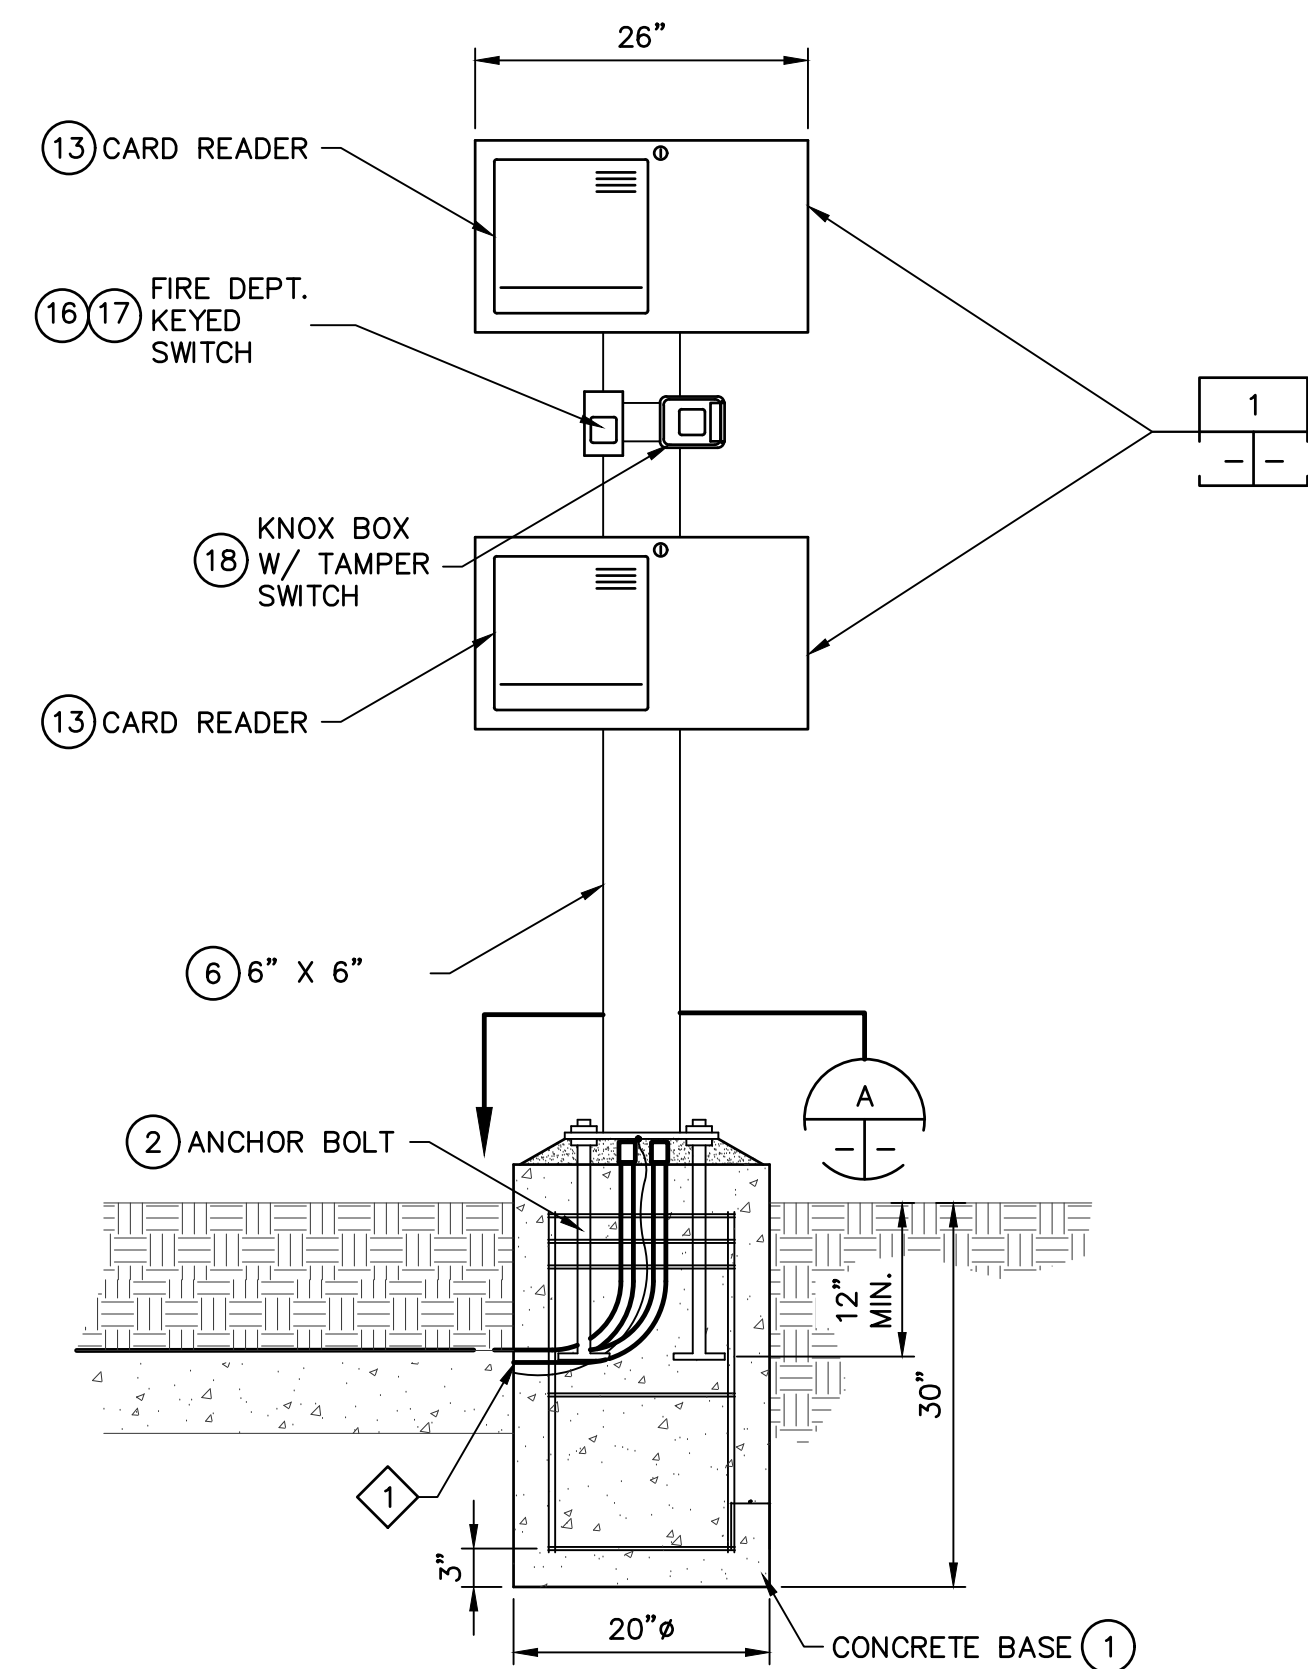


**CARD READER PEDESTAL – FRONT VIEW**

DETAIL 2  
NOT TO SCALE

ITEM	QTY.	DESCRIPTION	MANUFACTURER	PART NUMBER	NOTES
1	1	CONCRETE BASE	-----	3000 PSI	
2	4	ANCHOR BOLTS	-----	0.75" GRADE 5	
3	6	REINFORCING BAR	-----	#6	
4	3	REINFORCING BAR	-----	#4	
5	1	BASE PLATE	-----	0.50" STEEL	
6	1	MAIN TUBE	-----	6" X 6" X 0.125" TUBE STEEL	
7	1	LOWER TUBE	-----	4" X 4" X 0.125" TUBE STEEL	
8	1	MIDDLE TUBE	-----	4" X 4" X 0.125" TUBE STEEL	"T" SHAPE TUBE
9	1	UPPER TUBE	-----	4" X 4" X 0.125" TUBE STEEL	
10	2	EQUIPMENT BOX	-----	3/16" STEEL	
11	2	HINGE	-----	316 STAINLESS STEEL	
12	2	LOCK SET, CAM TYPE	COMPX	C4152	WWW.COMPXNET.COM
13	2	CARD READER	INDALA	ASR 620	
14	2	STANDOFF, CARD READER	-----	12" H X 12"W X 4"D PLASTIC	
15	0	CCTV CAMERA	HONEYWELL	V60 CCTV	
16	1	SWITCH BOX	THOMAS & BETTS	IH3-1-LM	WWW.TNB.COM
17	1	FIRE DEPT. KEYED SWITCH	KNOX COMPANY	MODEL 3502 SINGLE SWITCH	WWW.KNOXBOX.COM
18	1	KNOX BOX, HINGED DOOR	KNOX COMPANY	3200 SERIES SURFACE MOUNTED	WWW.KNOXBOX.COM
19	0	CARD READER	INDALA	FP5067B	
20	2	BOX, RECEPTACLE	THOMAS & BETTS	IH3-1	WWW.TNB.COM
21	2	COVER, RECEPTACLE	THOMAS & BETTS	CCG	WWW.TNB.COM
22	2	RECEPTACLE	HUBBEL INC	GF5362	WWW.HUBBEL-WIRING.COM
23	2	PLUNGER, TAMPER	GE (SENTROL)	3015	WWW.GEINDUSTRIAL.COM
24	2	TERMINAL BLOCK, 10 POLE	MARATHON	KULKA 100 SERIES	WWW.MARATHONSP.COM
25	-	NOT USED	-	-	
26	2	POWER SUPPLY, 12VDC	OMRON (OR EQUAL)	S82K-00712 (OR EQUAL)	WWW.OMRON.CA
27	2	LIGHT FIXTURE	TBD	-	

**CARD READER PEDESTAL – LIST OF ITEMS**

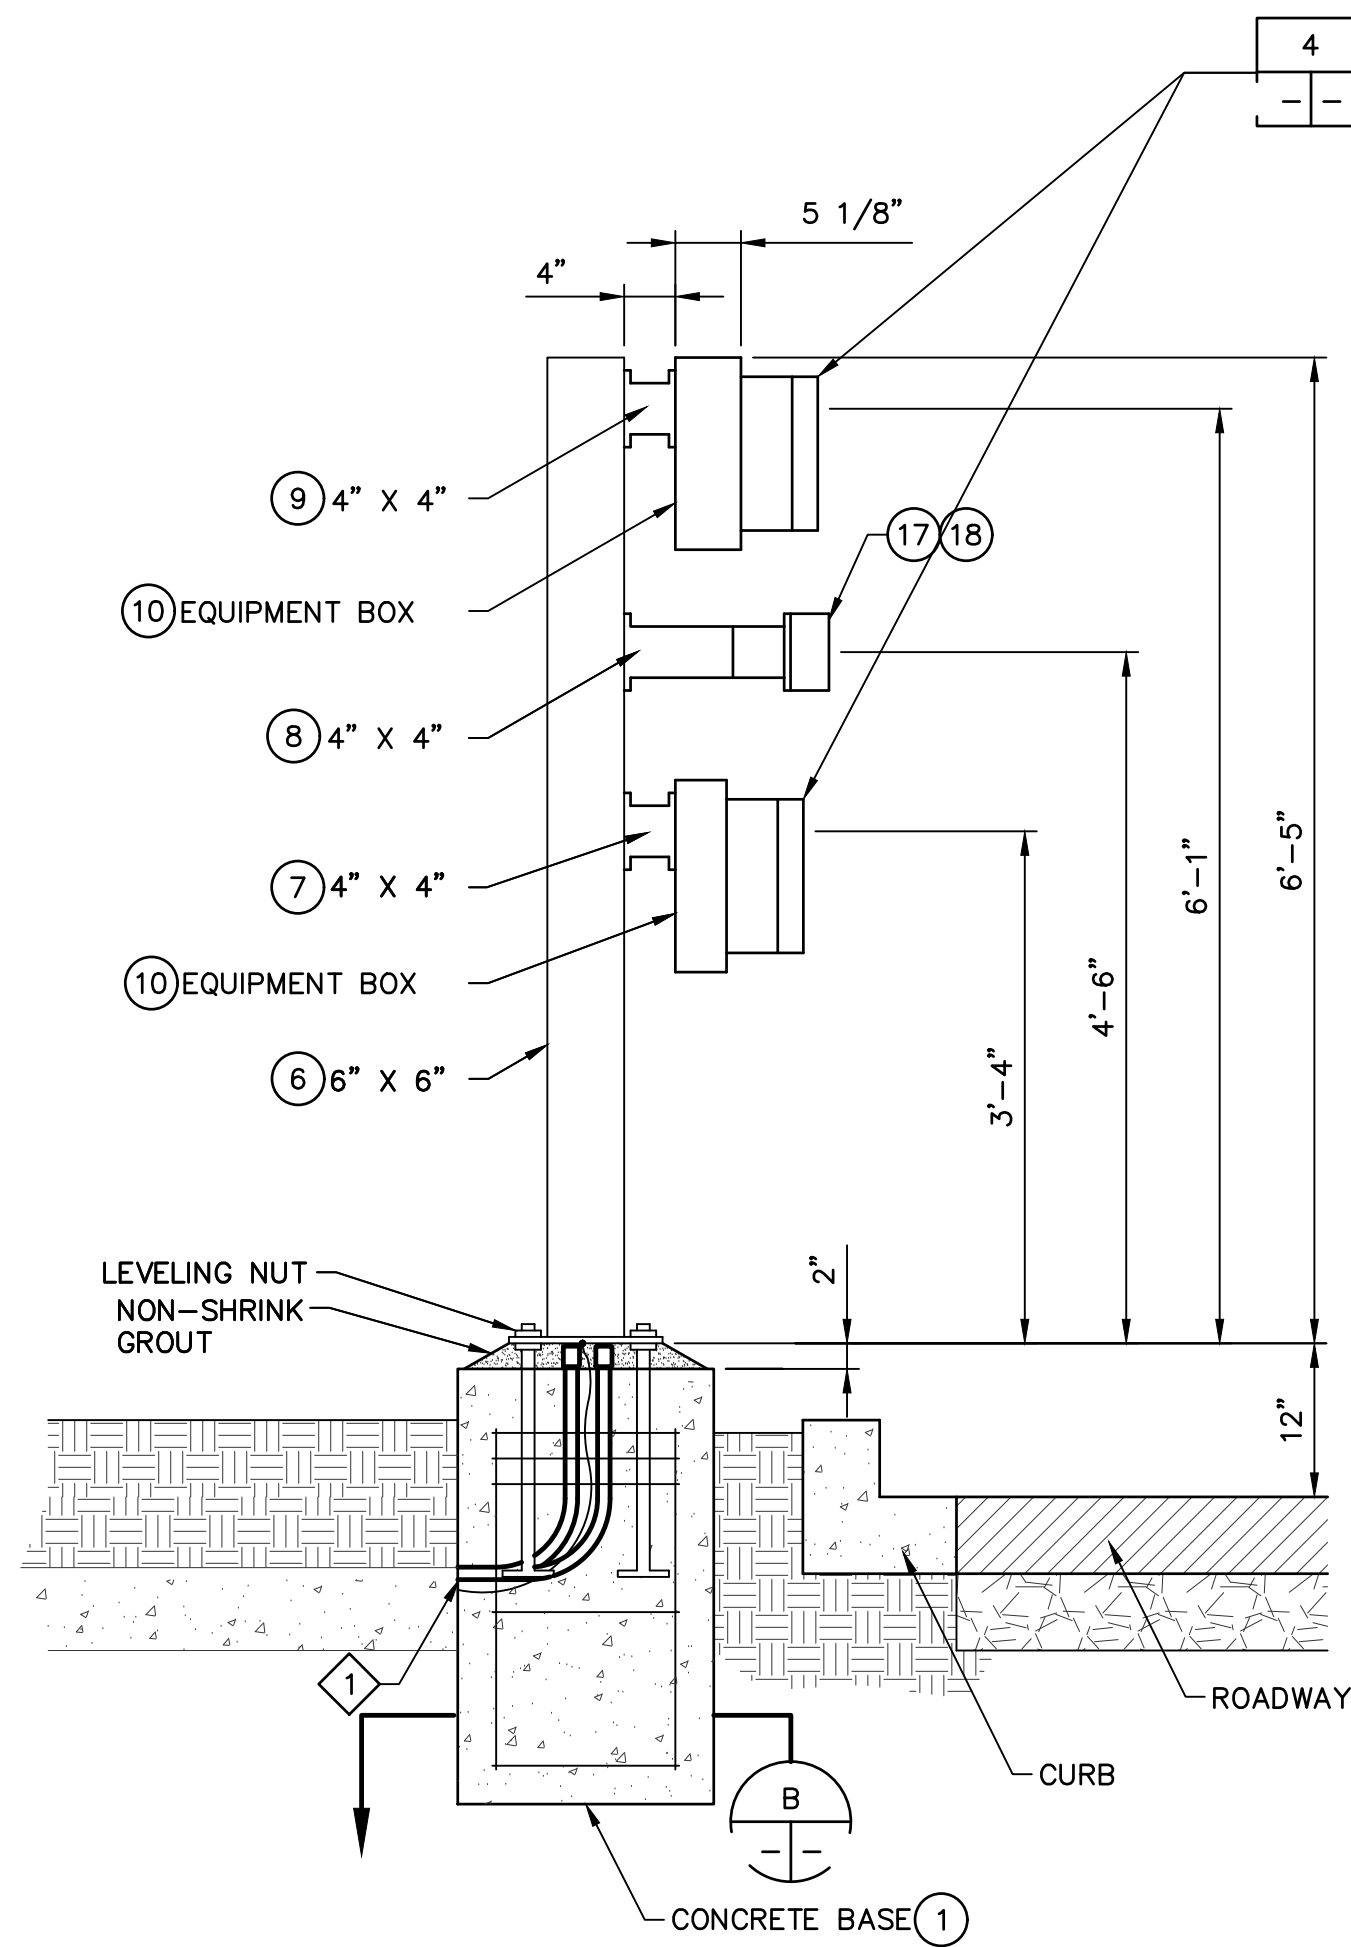

**CARD READER PEDESTAL – SIDE VIEW**


DETAIL 3  
NOT TO SCALE

**GENERAL NOTES:**

1. THE TYPICAL DETAILS ARE NOT REFERENCED ON EACH AND EVERY DRAWING. THE TYPICAL DETAILS ARE NOT REFERENCED ON EACH AND EVERY TYPE OF INSTALLATION. THE TYPICAL DETAILS HOWEVER SHALL BE ADHERED TO WHERE THE INSTALLATION APPLIES.
2. WHERE THE INSTALLATION OF TYPICAL DETAILS CANNOT BE PERFORMED EXACTLY PER THE TYPICAL DETAIL, SIMILAR INSTALLATION DETAIL MAY BE ACCEPTABLE. SUBMIT SIMILAR INSTALLATION DETAIL FOR REVIEW BY THE ENGINEER PRIOR TO ANY WORK.


**NOTES**

REFER TO SITE PLANS FOR CONDUIT ORIENTATION

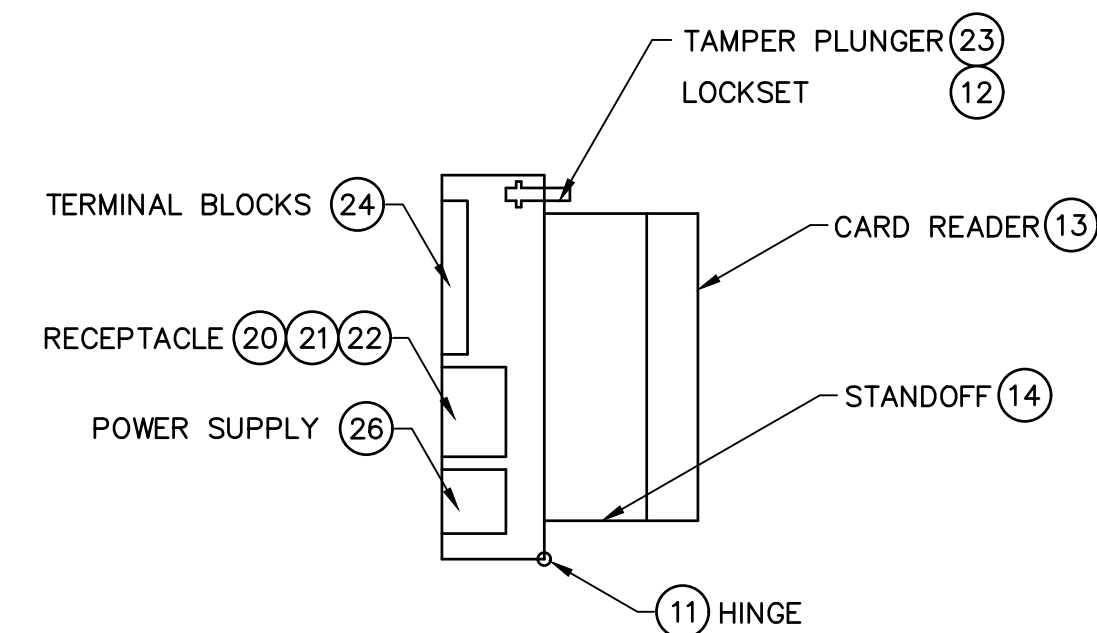


**EQUIPMENT BOX – SIDE VIEW**

DETAIL 4  
NOT TO SCALE

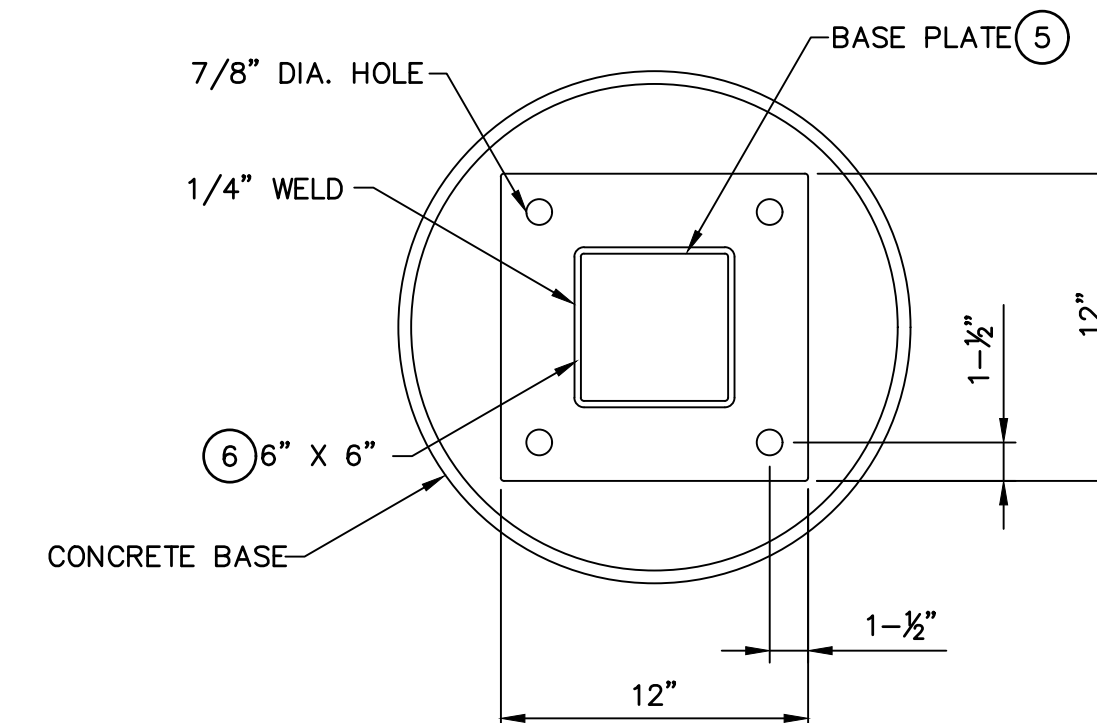



**SECTION A**

NOT TO SCALE

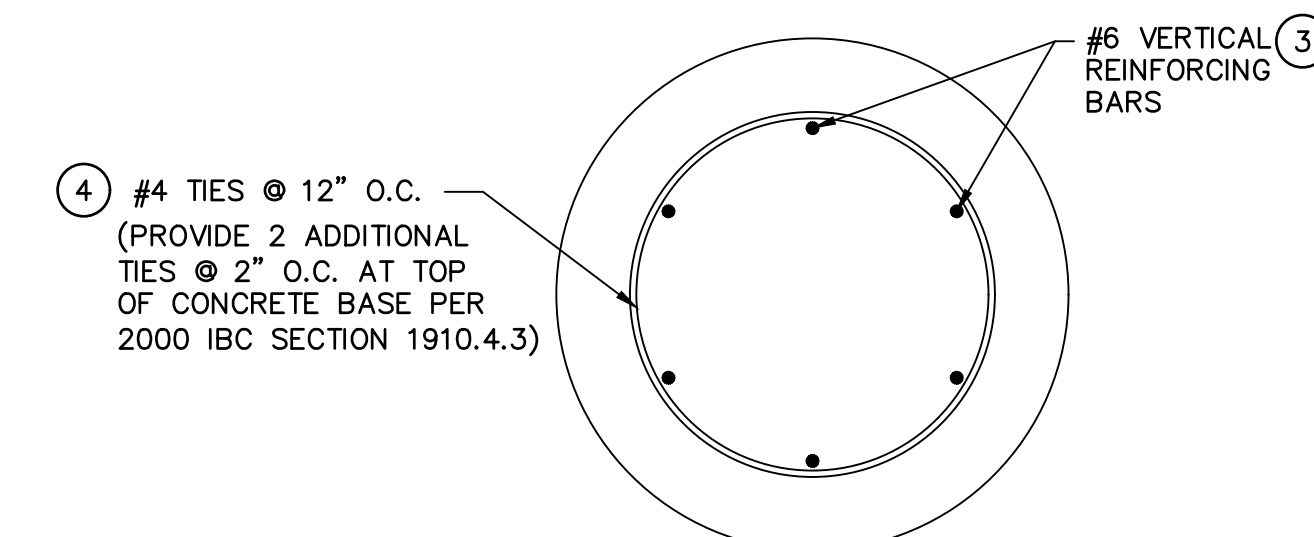


**SECTION B**

NOT TO SCALE

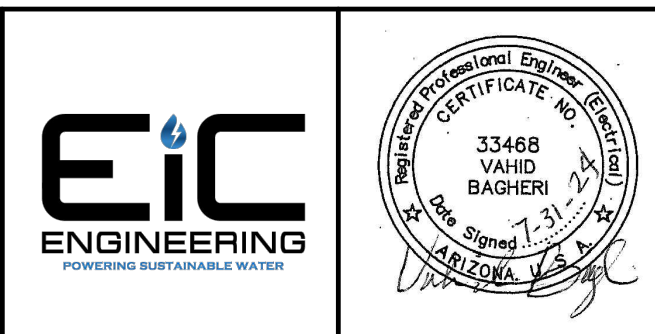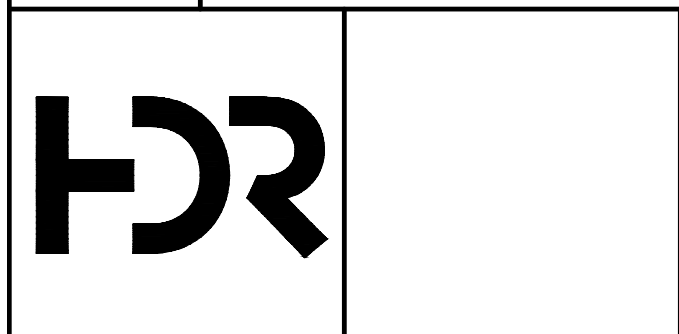

REVISIONS				
NO.	BY	DATE	CKD	REMARKS

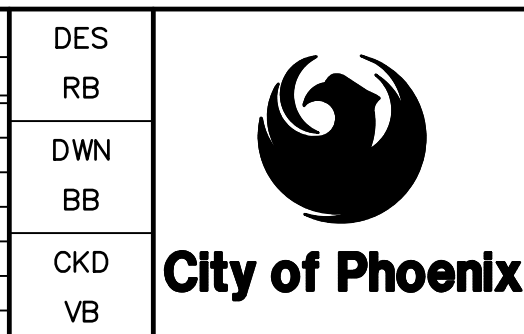

CITY OF PHOENIX  
WATER SERVICES DEPARTMENT  
**LIFT STATION 40  
REFURBISHMENT**

ELECTRICAL  
**ELECTRICAL DETAILS 3**

COPYRIGHT © 2007–JANUARY  
CITY PROJECT NO. WS90400085  
DATE: 08/2024  
E-30 SHEET 121 OF 134  
CAD FILE: CEELS40EED03.dwg




FACILITY DRAWINGS  
This drawing was supplied by a Consultant Engineer from a past construction project. The original constructor drawing was modified based on information provided by the Contractor to provide the Record Drawing. The City does not warrant the accuracy and/or completeness of any and accurate portrayal of facilities as they exist in the field.

REVISION	DATE	CAD FILE NAME	DWG NUMBER	REMARKS


THIS DRAWING MUST BE FIELD VERIFIED BEFORE USE  
DRAWING NOT TO SCALE UNLESS SCALE BAR IS PRESENT

FOR CONSTRUCTION

"PER CITY OF PHOENIX CODE CHAPTER 2, SECTION 2-28, THESE PLANS ARE FOR OFFICIAL USE ONLY AND MAY NOT BE SHARED WITH OTHERS EXCEPT AS REQUIRED TO FULFILL THE OBLIGATIONS OF THE CONTRACTOR'S CONTRACT WITH THE CITY OF PHOENIX."  
THIS DOCUMENT MUST BE KEPT SECURE AT ALL TIMES.

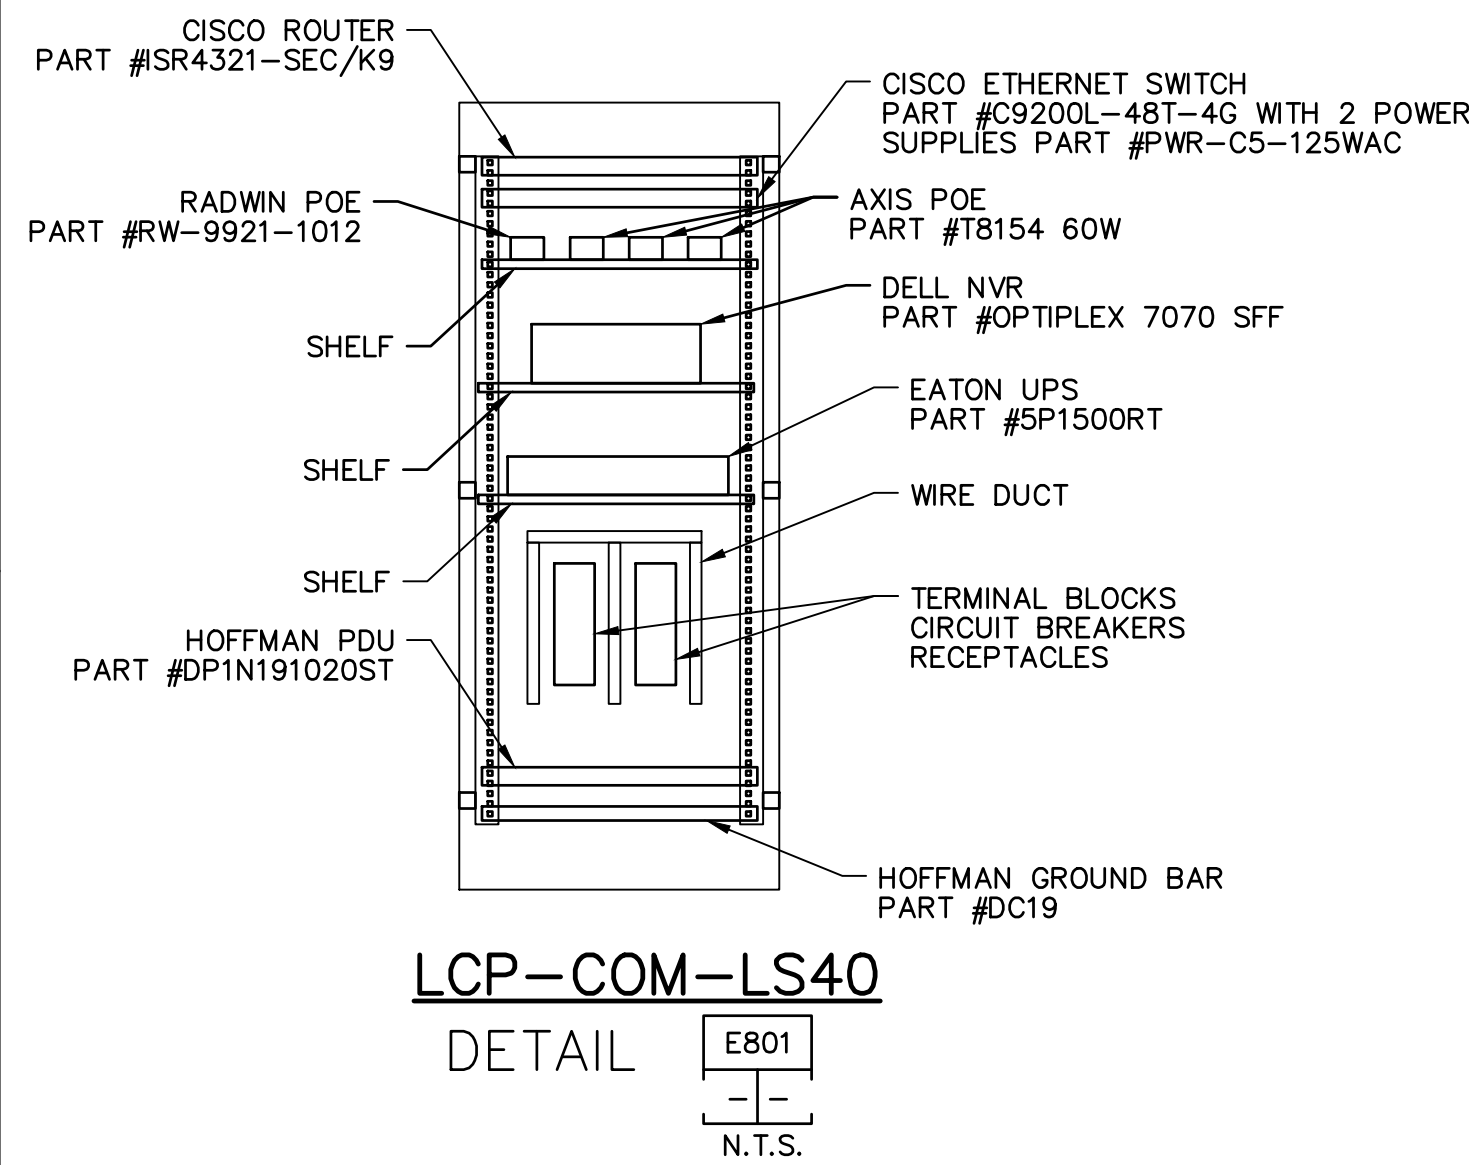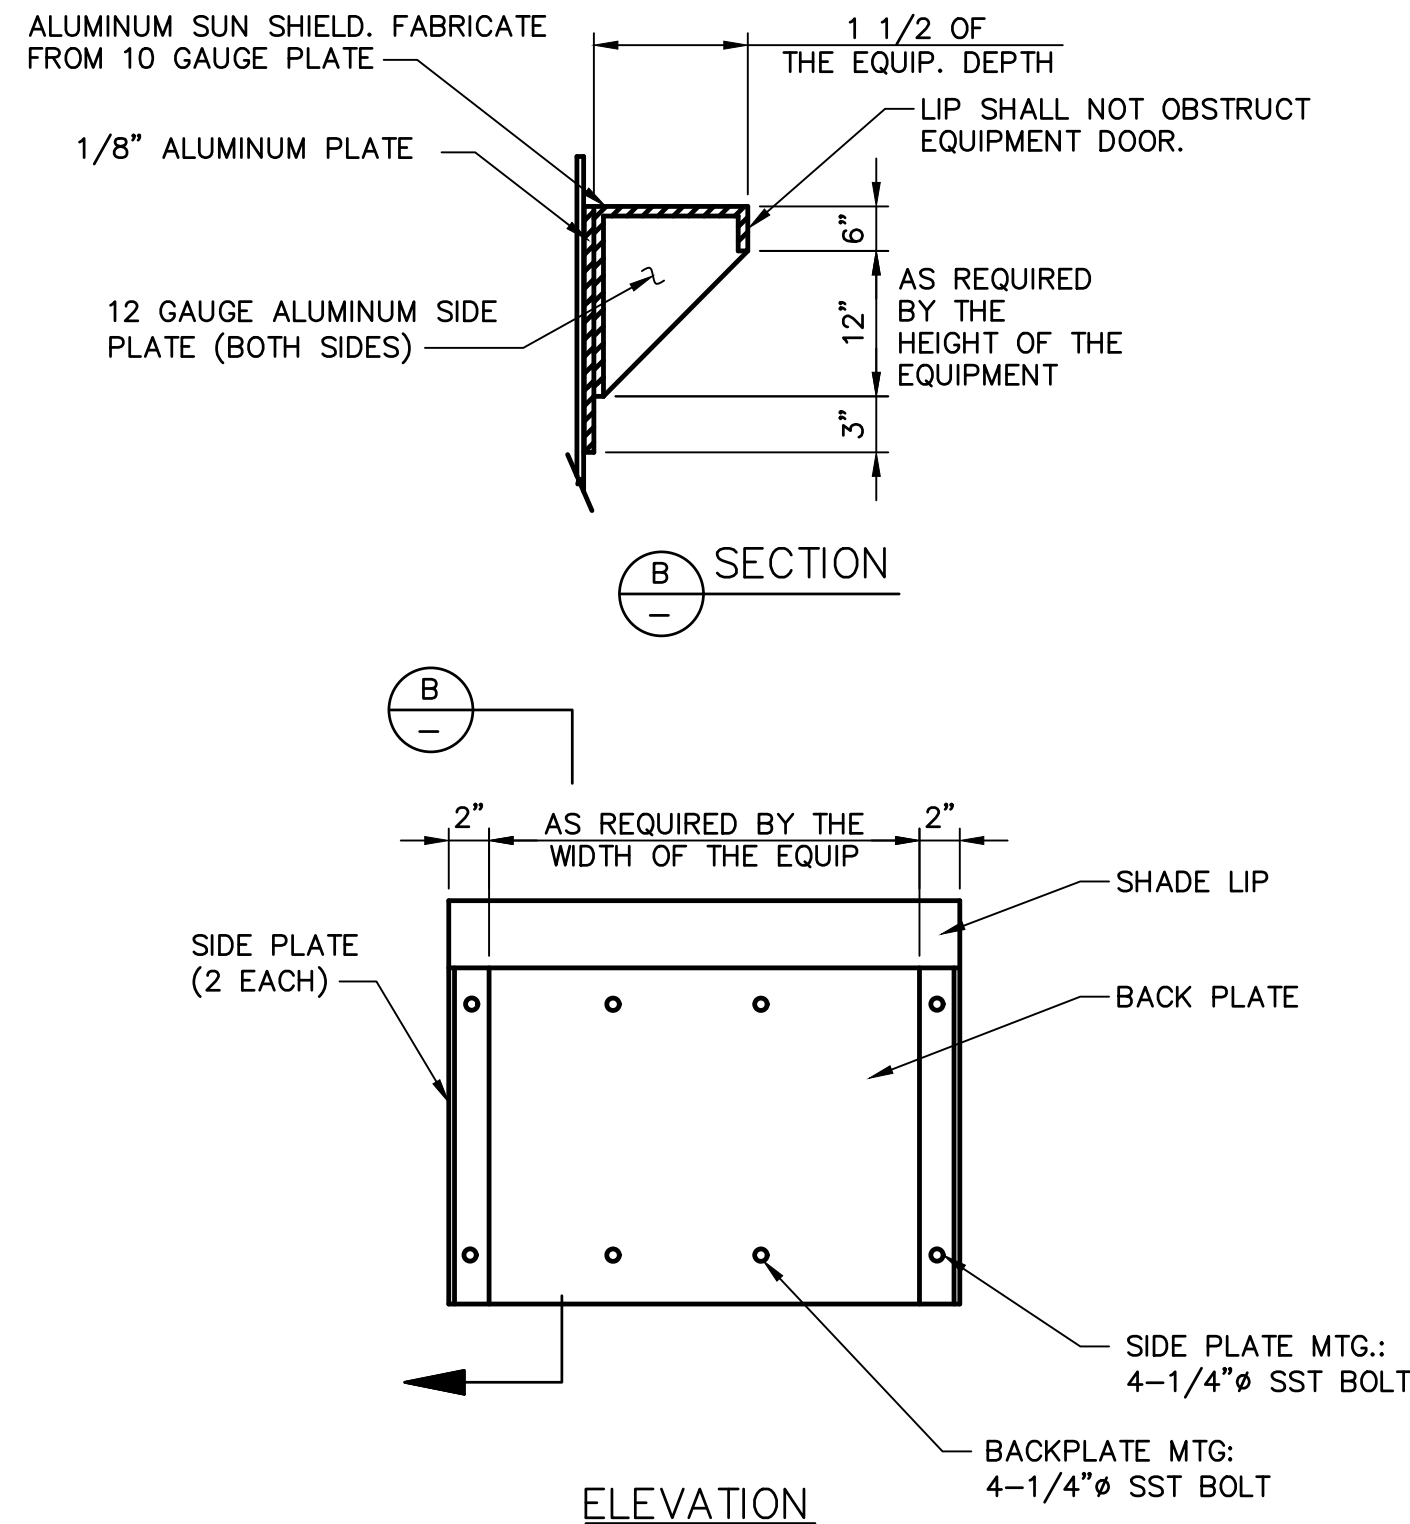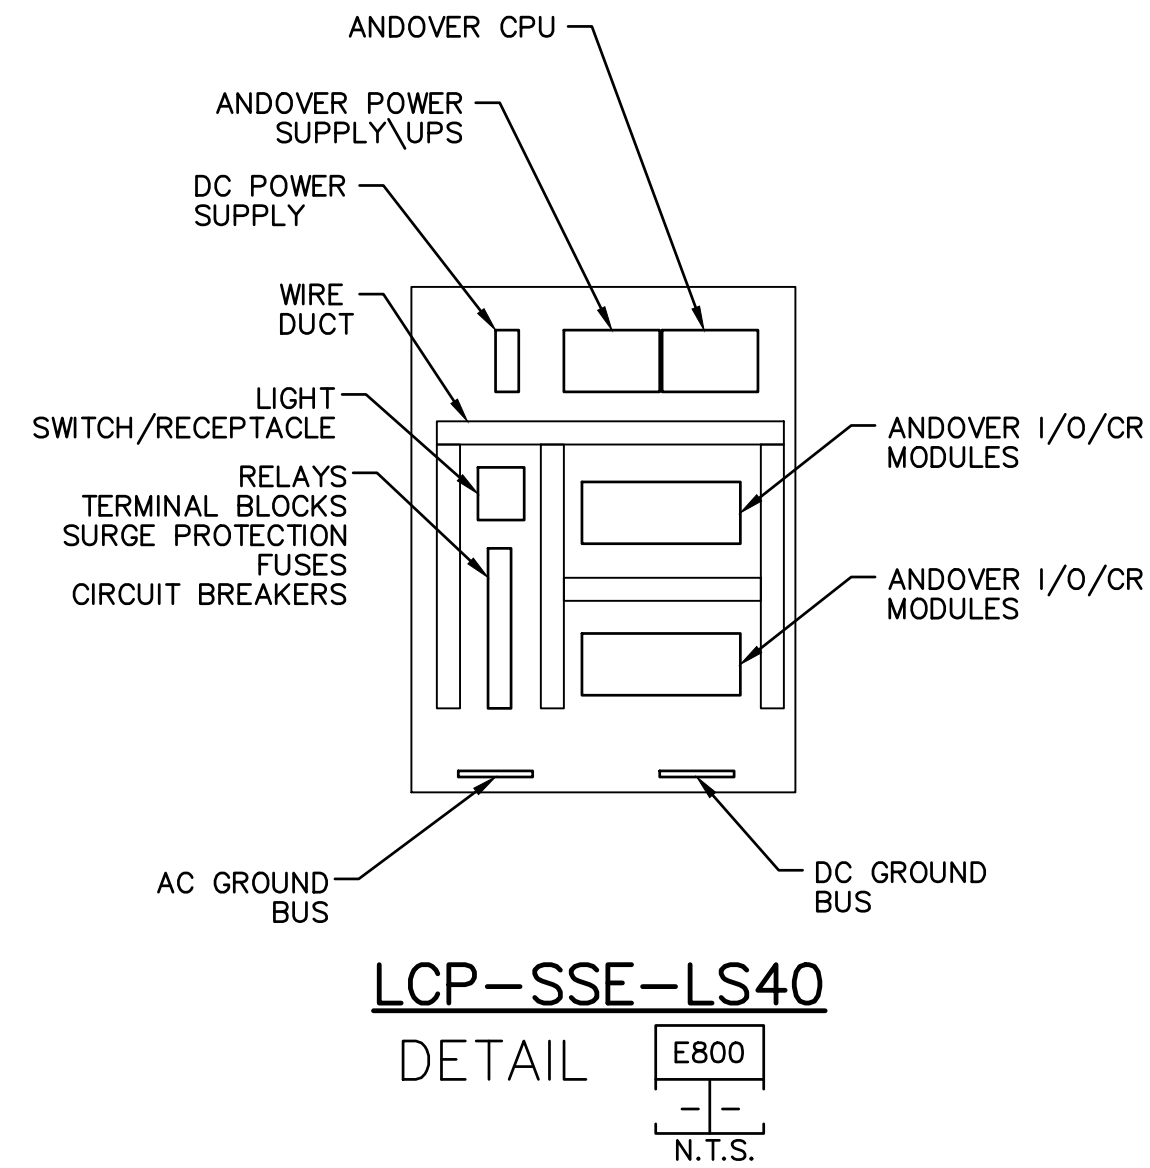

NOTE:  
SUBMIT FABRICATION DRAWINGS FOR EACH SUN SHIELD FOR ENGINEER'S APPROVAL PRIOR TO MANUFACTURING THE SUN SHIELDS.

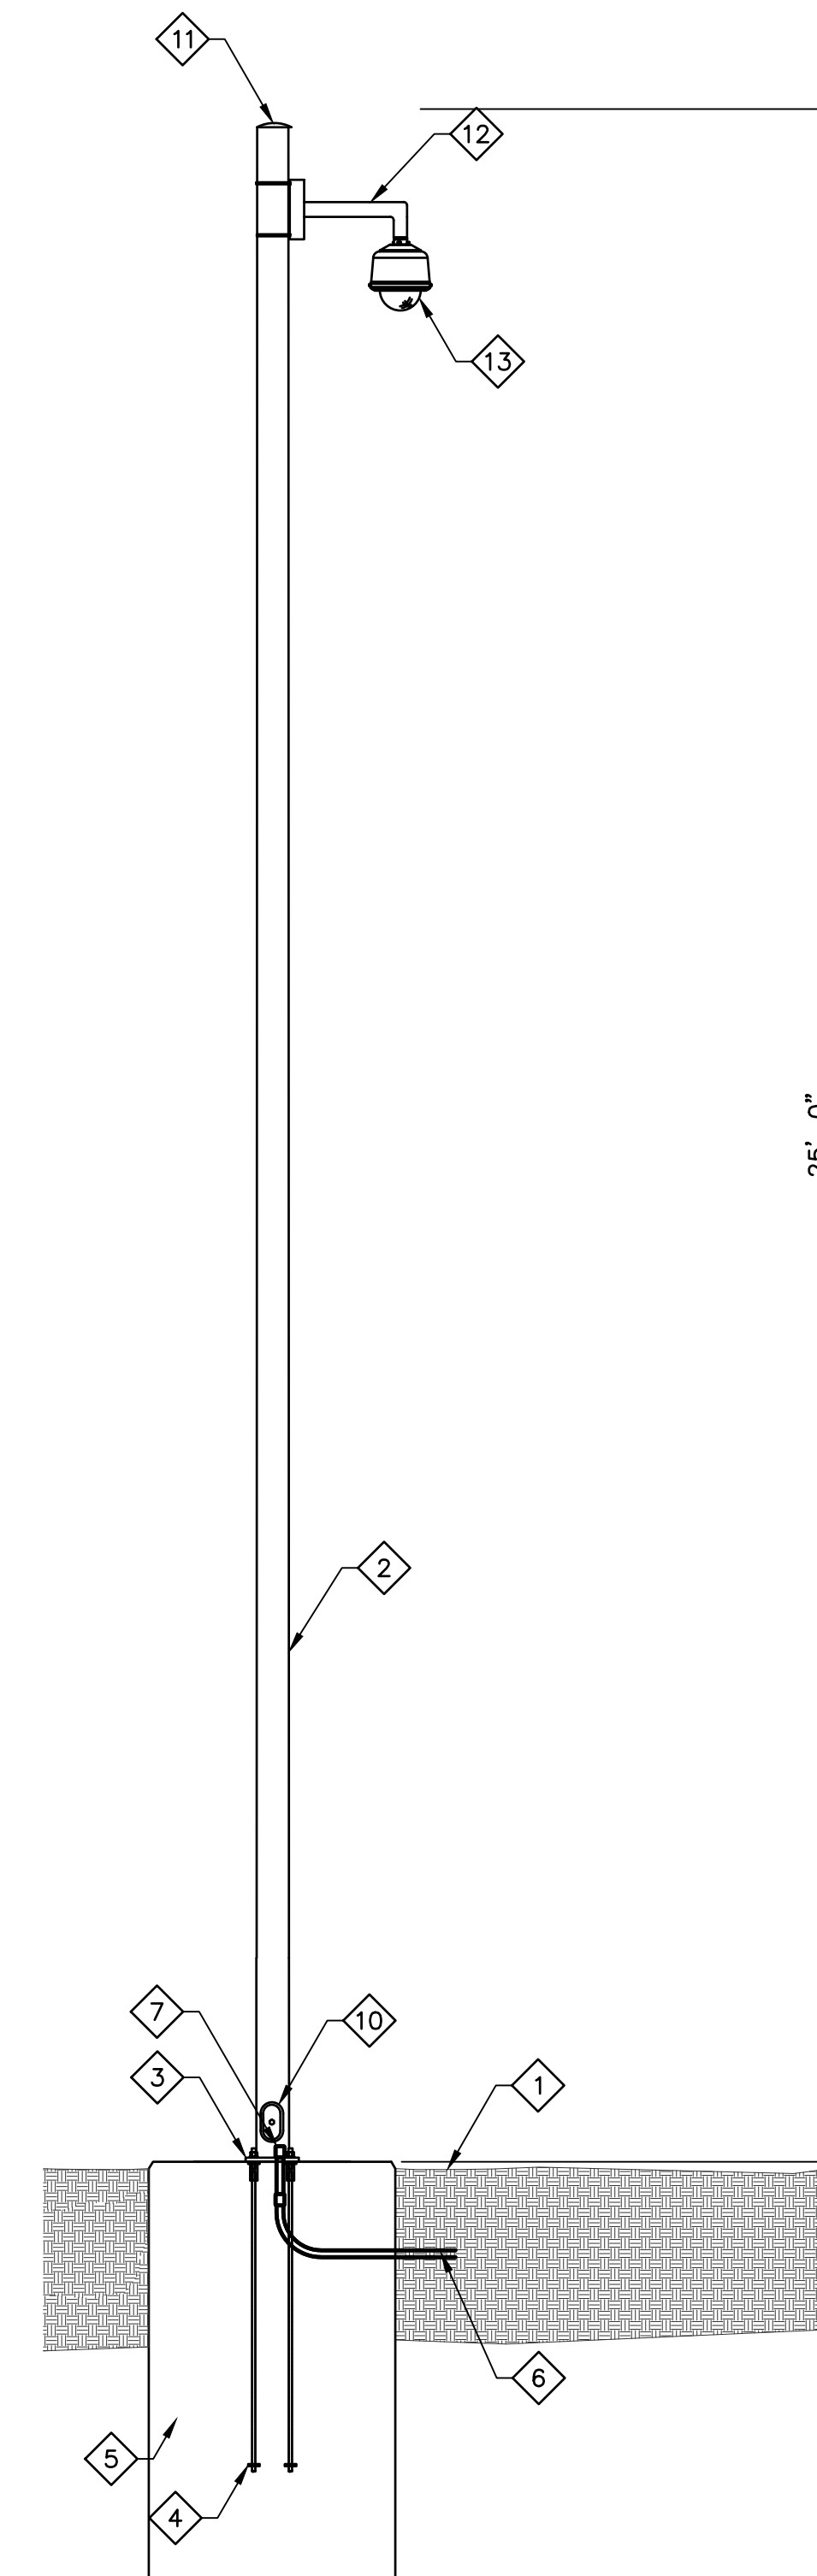

**CONSTRUCTION NOTES**

- 1 FINISHED GRADE - SLOPE AWAY FROM FOUNDATION.
- 2 MANUFACTURER'S SHOP DRAWING SHALL CONFIRM THAT THE POLE WILL DEFLECT NO MORE THAN ONE (1) INCH AT THE TOP OF THE POLE GIVEN A MAXIMUM WIND VELOCITY OF 30 MPH (WITH 1.3 GUST FACTOR).
- 3 BASE PLATE LAYOUT AND BOLT CIRCLE TO BE AS SHOWN ON MANUFACTURER'S SHOP DRAWINGS.
- 4 ANCHOR BOLTS FABRICATED AND INSTALLED PER MANUFACTURER'S SHOP DRAWINGS.
- 5 CONCRETE FOUNDATION. REFER TO SPECIFICATIONS AND DETAILS 1 ON E SHEET 015 FOR DETAILS.
- 6 SEE ELECTRICAL PLANS FOR CONDUIT SIZE AND QUANTITY.
- 9 CONDUIT END BELL. CONDUIT SHALL PROJECT A MINIMUM OF 2" AND A MAXIMUM OF 4" ABOVE BOTTOM OF BASE PLATE.
- 10 HAND HOLE PER MANUFACTURER'S DESIGN WITH MINIMUM DIMENSIONS OF 4" X 6-1/2".
- 11 REMOVABLE POLE CAP SECURED WITH SET SCREWS.
- 12 AXIS T91B67.
- 13 PTZ/FIXED CAMERA. SEE SPECIFICATION SECTION 18930 FOR CAMERA DETAILS. SEE DRAWINGS FOR CAMERA QUANTITIES ON POLE.

**NOTES**

1. PROVIDE ALL WORK IN ACCORDANCE WITH THE PROJECT SPECIFICATIONS.
2. THE EXACT LOCATION OF ALL EQUIPMENT SHALL BE VERIFIED IN THE FIELD WITH THE OWNER PRIOR TO ROUGH-IN.
3. ALL MOUNTING EQUIPMENT AND HARDWARE SHALL BE GRADE 316 STAINLESS STEEL.
4. ALL WORK SHALL COMPLY WITH CITY OF PHOENIX DEVELOPMENT SERVICES DEPARTMENT ACCESS CONTROL SYSTEM TECHNICAL GUIDELINE. OBTAIN A COPY AS NEEDED.
5. NOT ALL DETAILS NECESSARILY USED.
6. DIMENSIONS NOT SHOWN SHALL BE AS DETERMINED BY THE MANUFACTURER AND OR SPECIFICATIONS AND OTHER DRAWINGS. CONTRACTOR TO SUPPLY SHOP DRAWINGS AT LEAST 3 WEEKS PRIOR TO ORDERING MATERIALS. SHOP DRAWINGS SHALL BE SEALED BY A PROFESSIONAL ENGINEER LICENSED IN THE STATE OF ARIZONA, AND SHALL BE APPROVED IN WRITING BY THE OWNER PRIOR TO ORDERING MATERIALS.
7. PANEL LAYOUT IS FOR REFERENCE ONLY. NOT ALL COMPONENTS ARE SHOWN. CONTRACTOR TO FURNISH AND INSTALL PANELS AS REQUIRED BY THE SPECIFICATIONS AND DRAWINGS.

**GENERAL NOTES:**

1. THE TYPICAL DETAILS ARE NOT REFERENCED ON EACH AND EVERY DRAWING. THE TYPICAL DETAILS ARE NOT REFERENCED ON EACH AND EVERY TYPE OF INSTALLATION. THE TYPICAL DETAILS HOWEVER SHALL BE ADHERED TO WHERE THE INSTALLATION APPLIES.
2. WHERE THE INSTALLATION OF TYPICAL DETAILS CANNOT BE PERFORMED EXACTLY PER THE TYPICAL DETAIL, SIMILAR INSTALLATION DETAIL MAY BE ACCEPTABLE. SUBMIT SIMILAR INSTALLATION DETAIL FOR REVIEW BY THE ENGINEER PRIOR TO ANY WORK.

FACILITY DRAWINGS  
This drawing was supplied by a Consultant Engineer from a past construction project. The original construction drawing was modified based on information provided by the Contractor to provide the Record Drawing. The City does not warrant the accuracy and/or the existence and accurate portrayal of facilities as they exist in the field.


REVISION	DWG NUMBER	CAD FILE NAME	DATE	PROJECT NAME	PROJECT NO.	PROJECT NO.


			<table border="1" style="width: 100%;"> <thead> <tr> <th colspan="5">REVISIONS</th> </tr> <tr> <th>NO.</th> <th>BY</th> <th>DATE</th> <th>CKD</th> <th>REMARKS</th> </tr> </thead> <tbody> <tr><td> </td><td> </td><td> </td><td> </td><td> </td></tr> <tr><td> </td><td> </td><td> </td><td> </td><td> </td></tr> <tr><td> </td><td> </td><td> </td><td> </td><td> </td></tr> <tr><td> </td><td> </td><td> </td><td> </td><td> </td></tr> <tr><td> </td><td> </td><td> </td><td> </td><td> </td></tr> <tr><td> </td><td> </td><td> </td><td> </td><td> </td></tr> </tbody> </table>	REVISIONS					NO.	BY	DATE	CKD	REMARKS																															DES RB DWN BB CKD VB		CITY OF PHOENIX WATER SERVICES DEPARTMENT  LIFT STATION 40 REFURBISHMENT	ELECTRICAL  ELECTRICAL DETAILS 4	COPYRIGHT © 2007-JANUARY CITY PROJECT NO. WS90400085 DATE: 08/2024 E-31 SHEET 122 OF 134 CAD FILE: CEELS40ED04.dwg
			REVISIONS																																													
NO.	BY	DATE	CKD	REMARKS																																												


THIS DRAWING MUST BE FIELD VERIFIED BEFORE USE  
DRAWING NOT TO SCALE UNLESS SCALE BAR IS PRESENT


FOR CONSTRUCTION


"PER CITY OF PHOENIX CODE CHAPTER 2, SECTION 2-28, THESE PLANS ARE FOR OFFICIAL USE ONLY AND MAY NOT BE SHARED WITH OTHERS EXCEPT AS REQUIRED TO FULFILL THE OBLIGATIONS OF THE CONTRACTOR'S CONTRACT WITH THE CITY OF PHOENIX."  
THIS DOCUMENT MUST BE KEPT SECURE AT ALL TIMES.

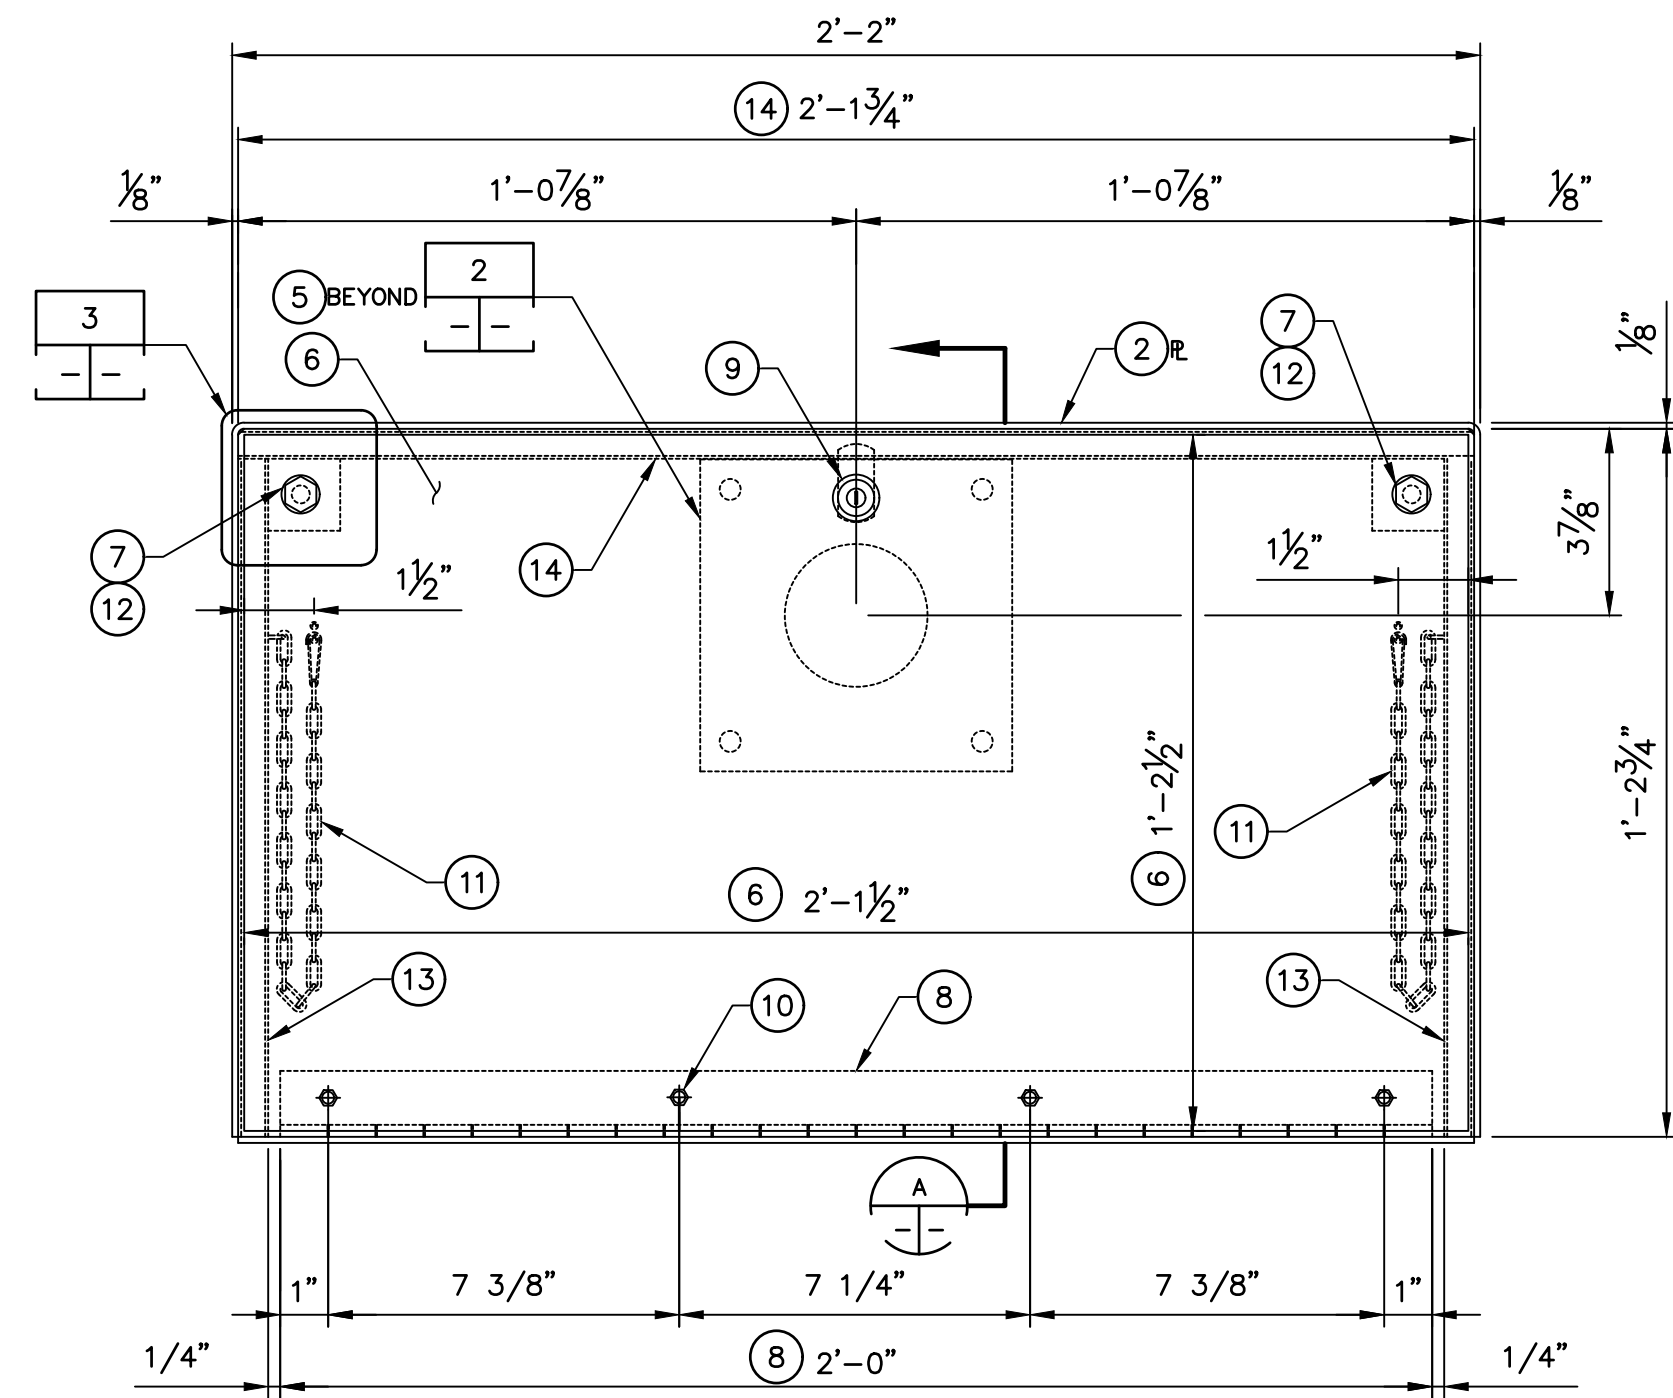


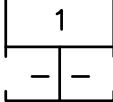READER BOX  
DETAIL   
NOT TO SCALE

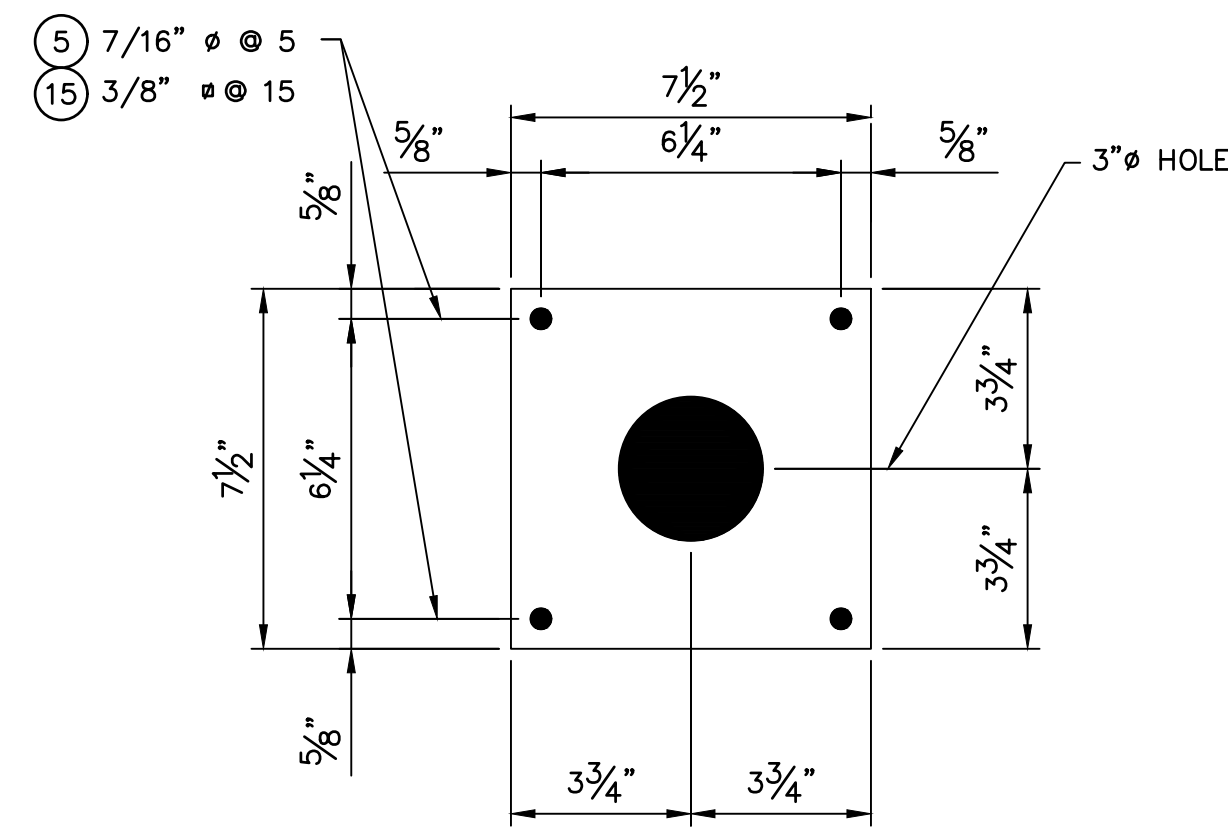

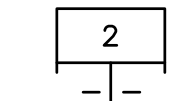
DETAIL 2  
SUPPORT PLATE'S  
DETAIL   
NOT TO SCALE

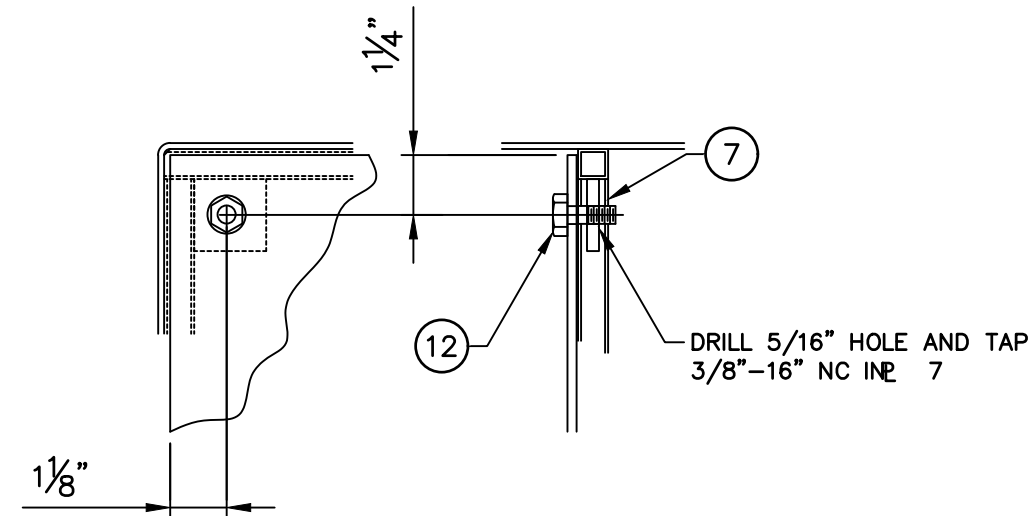

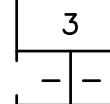DETAIL 3  
DETAIL   
NOT TO SCALE

GENERAL NOTES:


1. THE TYPICAL DETAILS ARE NOT REFERENCED ON EACH AND EVERY DRAWING. THE TYPICAL DETAILS ARE NOT REFERENCED ON EACH AND EVERY TYPE OF INSTALLATION. THE TYPICAL DETAILS HOWEVER SHALL BE ADHERED TO WHERE THE INSTALLATION APPLIES.
2. WHERE THE INSTALLATION OF TYPICAL DETAILS CANNOT BE PERFORMED EXACTLY PER THE TYPICAL DETAIL, SIMILAR INSTALLATION DETAIL MAY BE ACCEPTABLE. SUBMIT SIMILAR INSTALLATION DETAIL FOR REVIEW BY THE ENGINEER PRIOR TO ANY WORK.

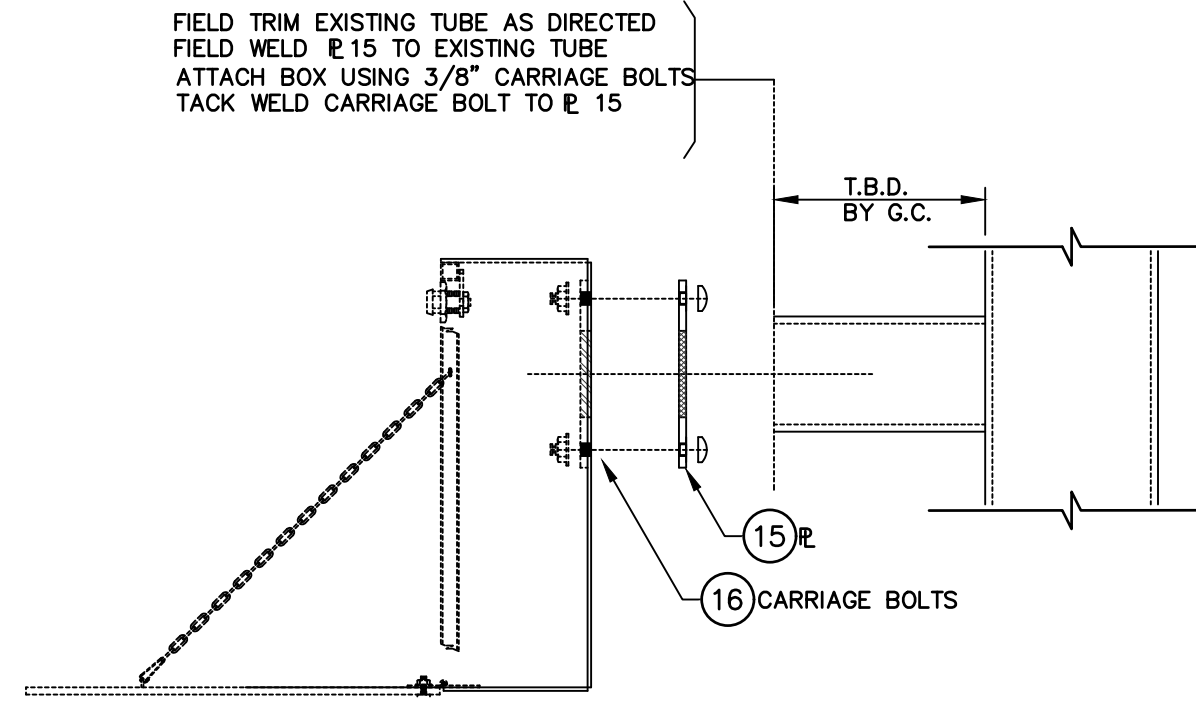



INSTALLATION NOTES


READER BOX AND PEDESTAL HOOD BILL OF MATERIALS (TYP.)


ITEM	QTY.	DESCRIPTION	LENGTH	REMARKS
1	1	READER BOX		
2	1	10 GA X 11 7/8"	4'-7 1/4"	BEND
3	1	10 GA X 14 3/4"	2'-1 3/4"	
4	1	10 GA X 5	2'-1 3/4"	
5	1	1/4" X 7 1/2"	7 1/2"	
6	1	ALUM. D 3/16" X 14 1/2"	2'-1 1/2"	
7	2	3/8" X 1 1/2"	1 1/2"	DRILL & TAP
8	1	2 1/2" X .073 PIANO HINGE	2'-0"	MCMASTER 15665A355
9	1	COMP-X CAMLOCK		CHICAGO PART 4152
10	4	3/16" X 5/8" TAMPER PROOF SCREW W/ LOCKNUT AND S.S. WASH.		
11	2	1/8" CHAIN W/ SNAP HOOK	1'-4"	W/ EYE BOLTS
12	2	3/8" X 1 1/2" S.S. BOLT		
13	2	TS 10 X 10 X .063	1'-2 1/16"	
14	1	TS 10 X 10 X .063	2'-1 3/4"	
FIELD PARTS				
15	1	1/4" X 7 1/2"	7 1/2"	
16	4	3/8" X 1 1/4" CARRIAGE BOLTS		W/ LOCKNUT
17	1	PEDESTAL HOOD		PEDESTAL PRO MODEL HOOD-CS-06X6

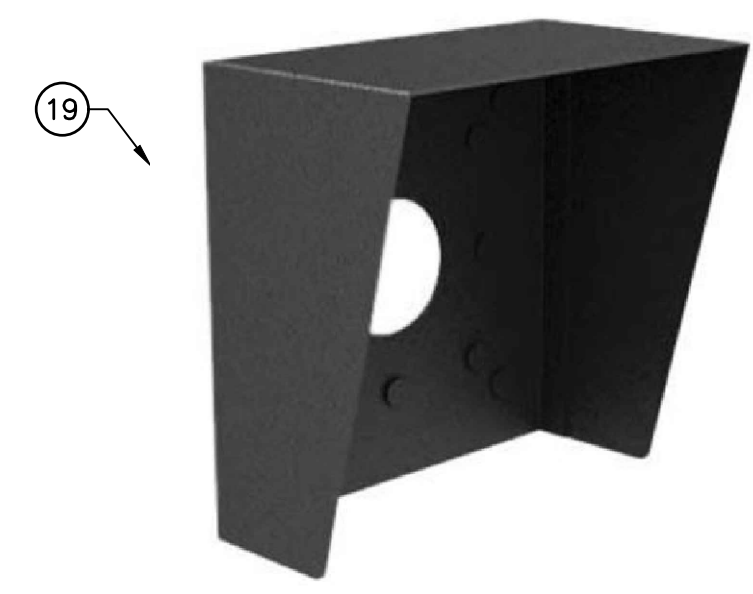


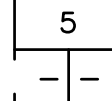DETAIL 5  
DETAIL   
NOT TO SCALE

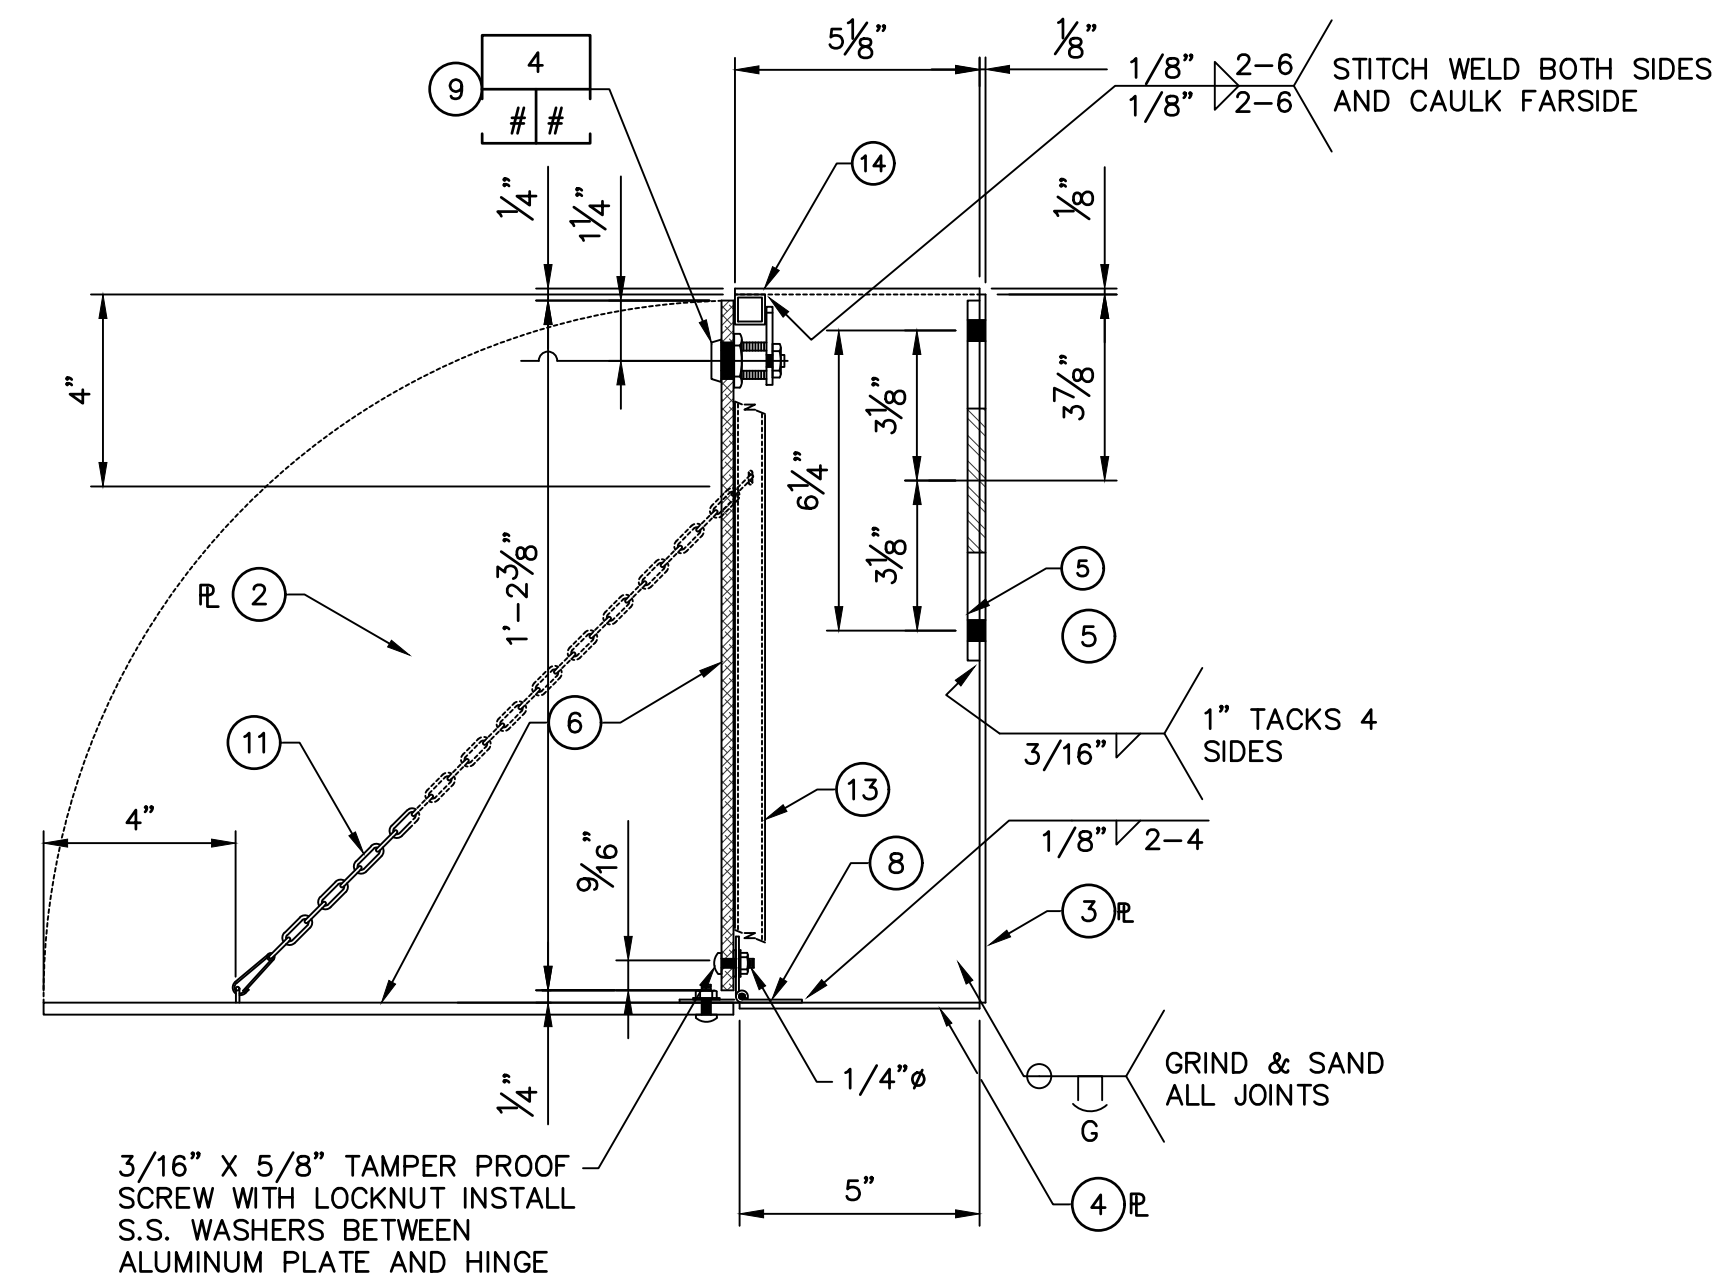

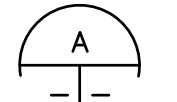SECTION A-A  
SECTION   
NOT TO SCALE

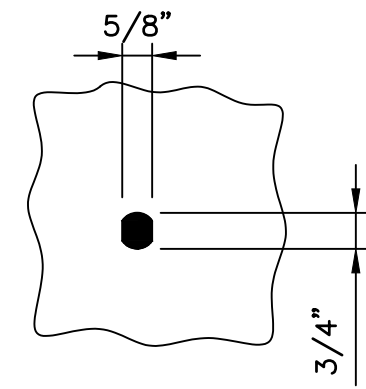

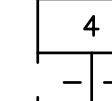DETAIL 4  
DETAIL   
NOT TO SCALE

- NOTES**
- 1 ALL HARDWARE SHALL BE STAINLESS STEEL
  - 2 EASE ALL CORNERS AND EDGES
  - 3 PC MK LEFT END NEAR SIDE AS DETAILED UNLESS NOTED OTHERWISE, THE FOLLOWING SHALL APPLY:
  - 4 MATERIAL TO BE : ASTM: PIPE: REBAR A 706 GR 60 TUBE:
  - 5 WELD ROD ~ REBAR E90XX SERIES ~ OTHER E70XX SERIES OR WIRE EQUIVALENT PER AWS
  - 6 CLEANING: SSPC-SP2 ~ PAINT 1 S/C STD PRIMER
  - 7 OPEN HOLES ARE NOTED

FACILITY DRAWINGS  
This drawing was supplied by a Consultant Engineer from a past construction project. The original construction drawing was modified based on information provided by the Contractor to provide the Record Drawing. The City does not warrant the accuracy and reliability of the drawing and its portrayal of facilities as they exist in the field.


REVISION	DATE	CAD FILE NAME	DWG NUMBER	REMARKS
1				
2				
3				
4				
5				

			<table border="1"> <thead> <tr> <th colspan="5">REVISIONS</th> </tr> <tr> <th>NO.</th> <th>BY</th> <th>DATE</th> <th>CKD</th> <th>REMARKS</th> </tr> </thead> <tbody> <tr><td> </td><td> </td><td> </td><td> </td><td> </td></tr> <tr><td> </td><td> </td><td> </td><td> </td><td> </td></tr> <tr><td> </td><td> </td><td> </td><td> </td><td> </td></tr> <tr><td> </td><td> </td><td> </td><td> </td><td> </td></tr> <tr><td> </td><td> </td><td> </td><td> </td><td> </td></tr> <tr><td> </td><td> </td><td> </td><td> </td><td> </td></tr> </tbody> </table>	REVISIONS					NO.	BY	DATE	CKD	REMARKS																															DES RB DWN BB CKD VB		CITY OF PHOENIX WATER SERVICES DEPARTMENT  LIFT STATION 40 REFURBISHMENT	ELECTRICAL  ELECTRICAL DETAILS 5	COPYRIGHT © 2007-JANUARY CITY PROJECT NO. WS90400085 DATE: 08/2024 E-32 SHEET 123 OF 134 CAD FILE: CSELS40EED05.dwg
			REVISIONS																																													
NO.	BY	DATE	CKD	REMARKS																																												

THIS DRAWING MUST BE FIELD VERIFIED BEFORE USE  
DRAWING NOT TO SCALE UNLESS SCALE BAR IS PRESENT


FOR CONSTRUCTION

PER CITY OF PHOENIX CODE CHAPTER 2, SECTION 2-28, THESE PLANS ARE FOR OFFICIAL USE ONLY AND MAY NOT BE SHARED WITH OTHERS EXCEPT AS REQUIRED TO FULFILL THE OBLIGATIONS OF THE CONTRACTOR'S CONTRACT WITH THE CITY OF PHOENIX. THIS DOCUMENT MUST BE KEPT SECURE AT ALL TIMES.

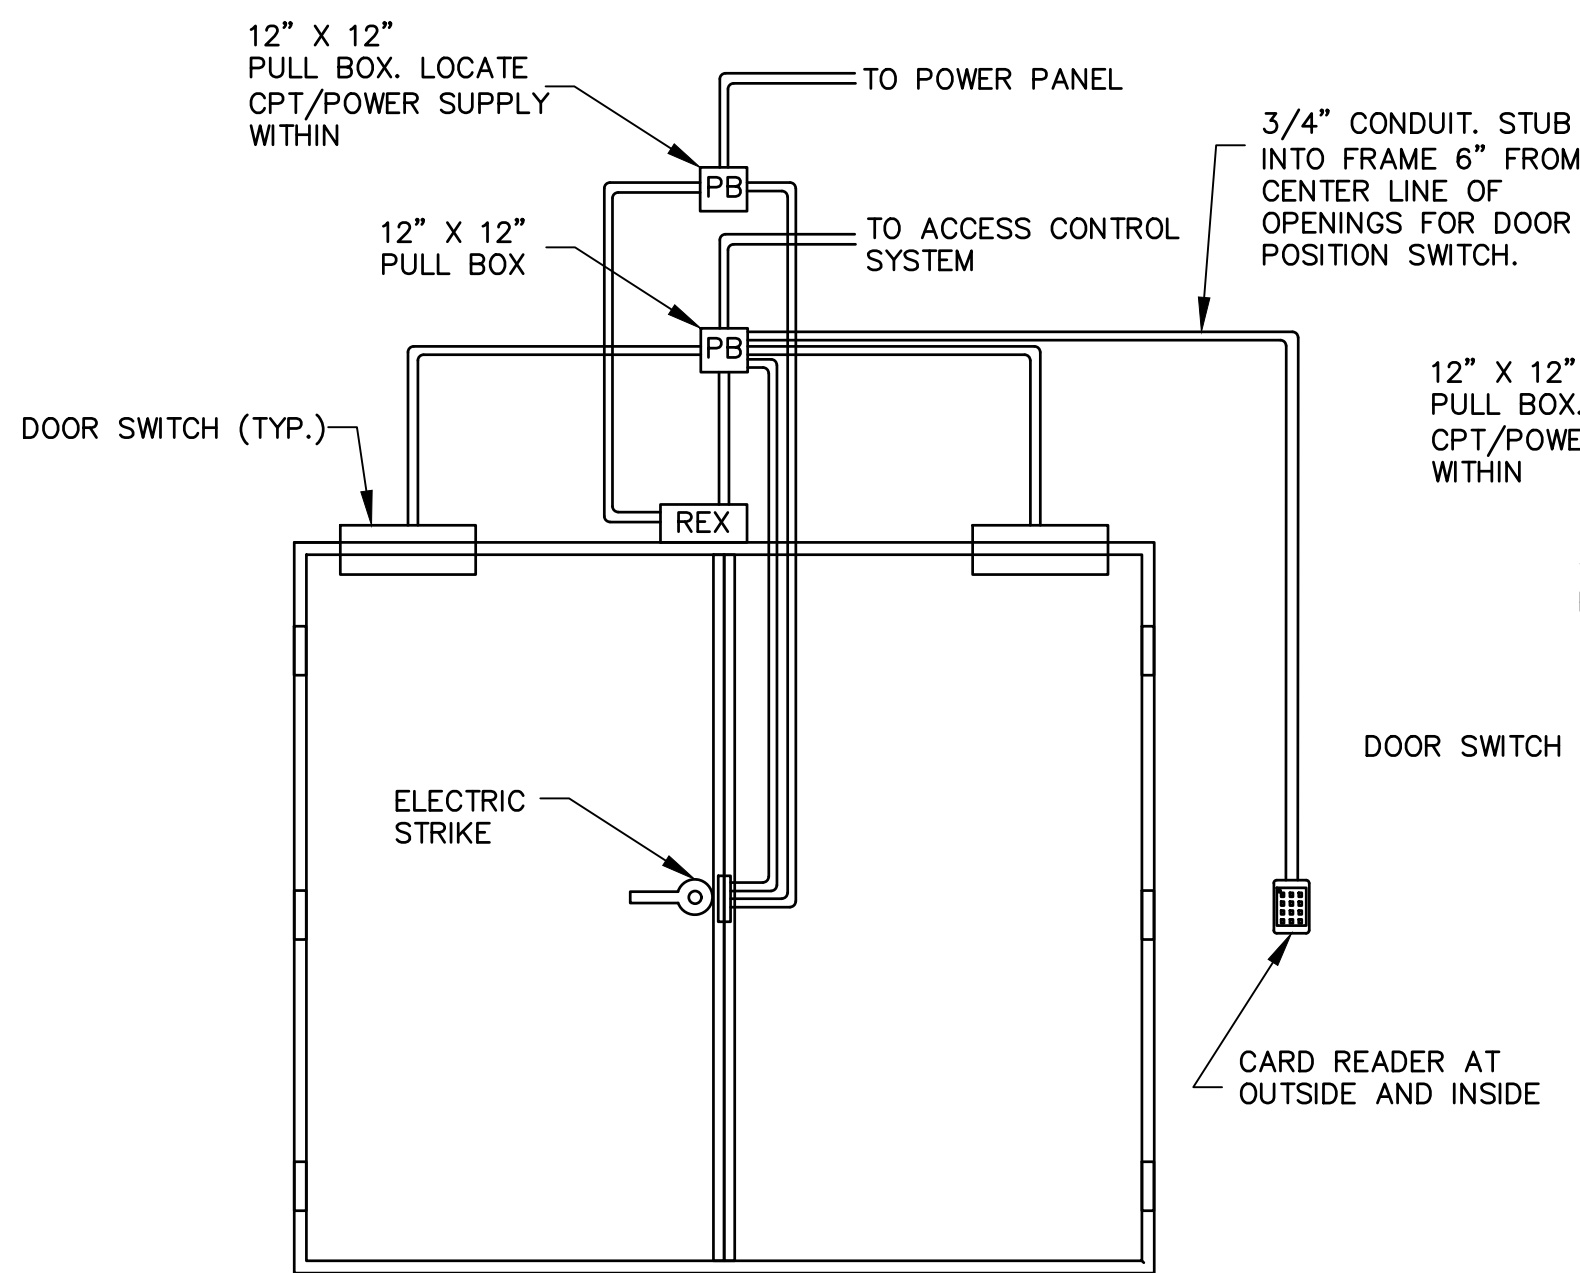


**DOUBLE DOOR DETAIL**

DETAIL 900  
NTS

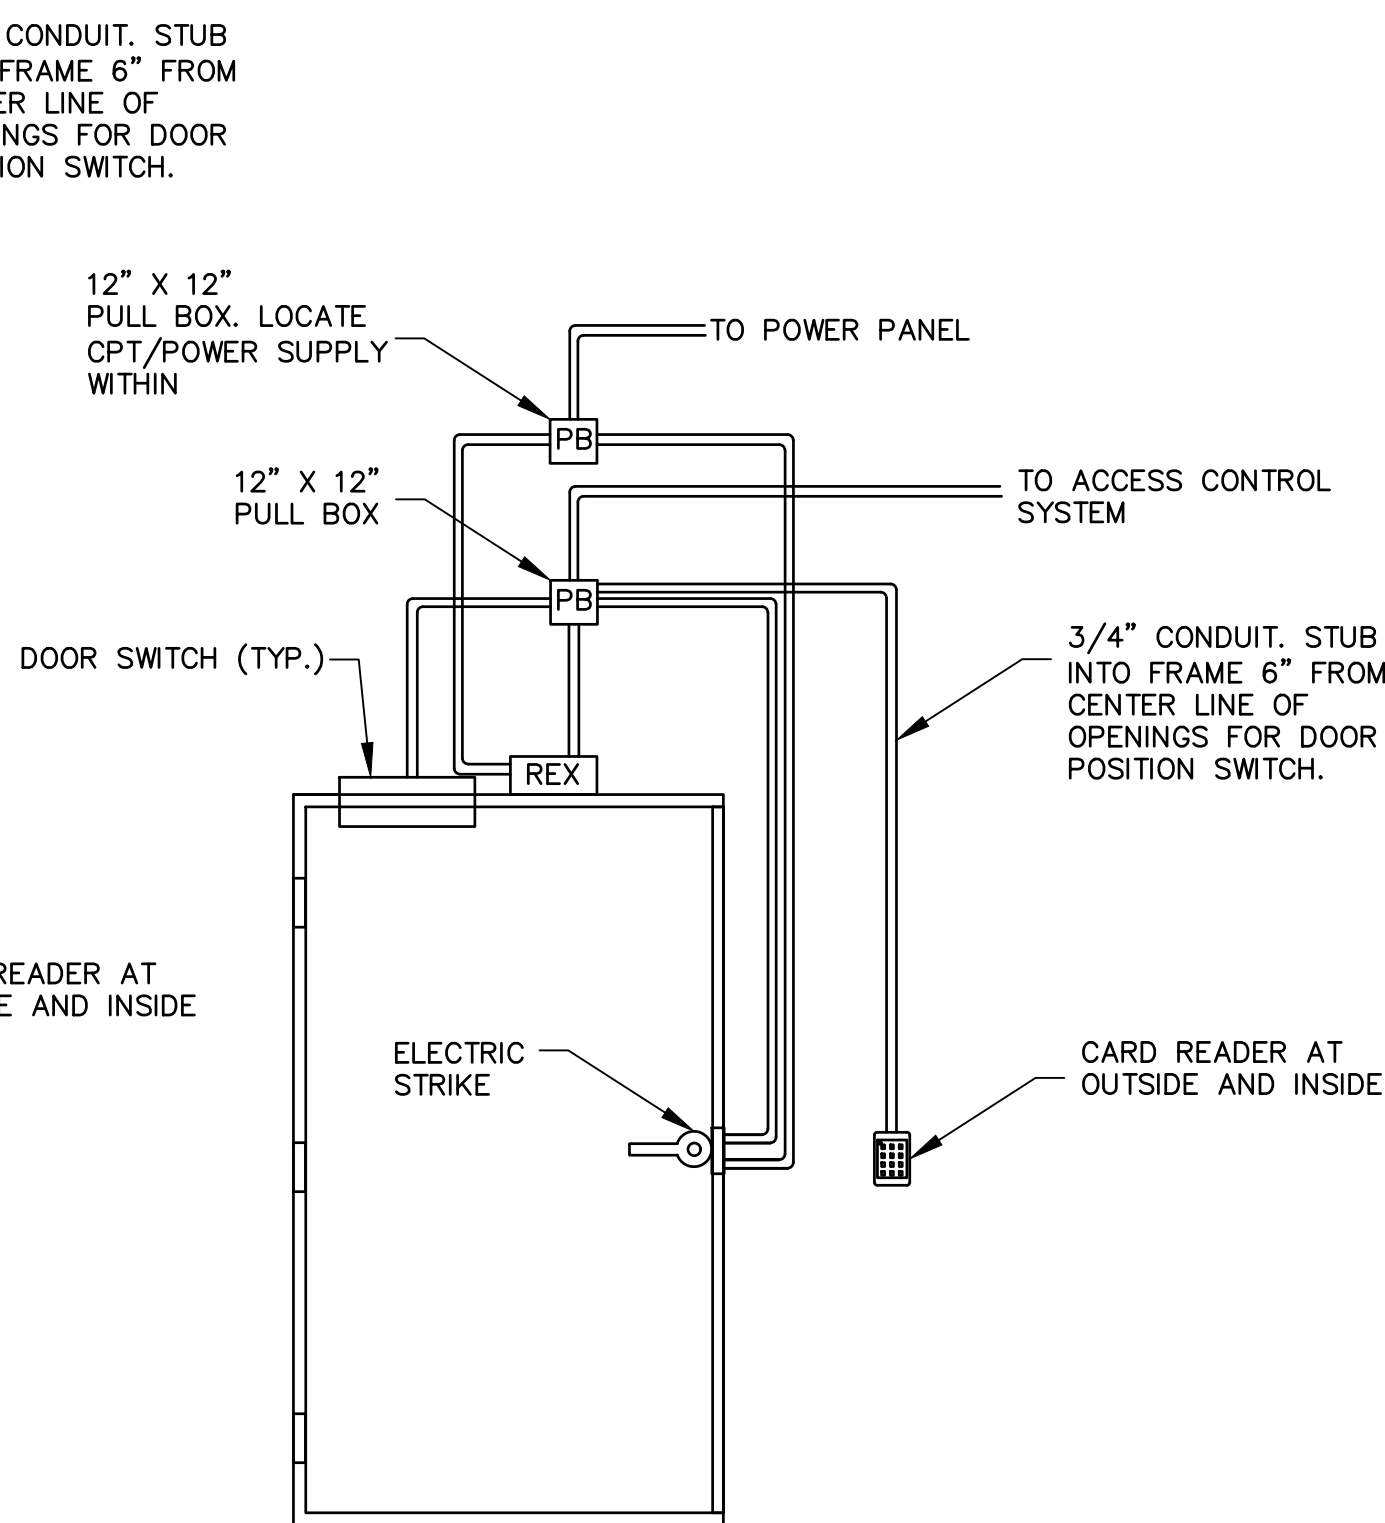


**SINGLE DOOR DETAIL**

DETAIL 901  
NTS

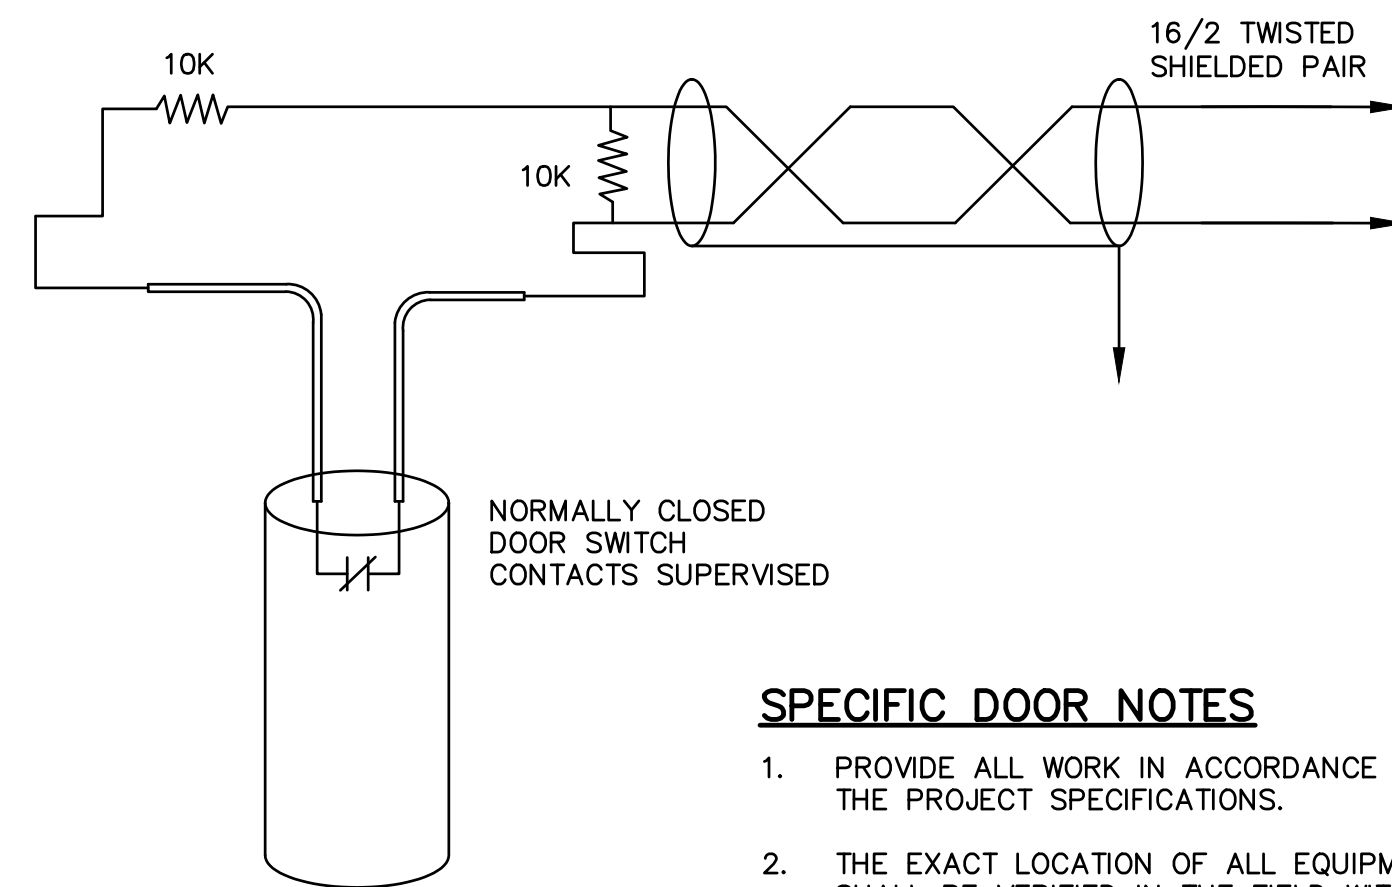

**TYPICAL DOOR SWITCH**

DETAIL 6  
NTS

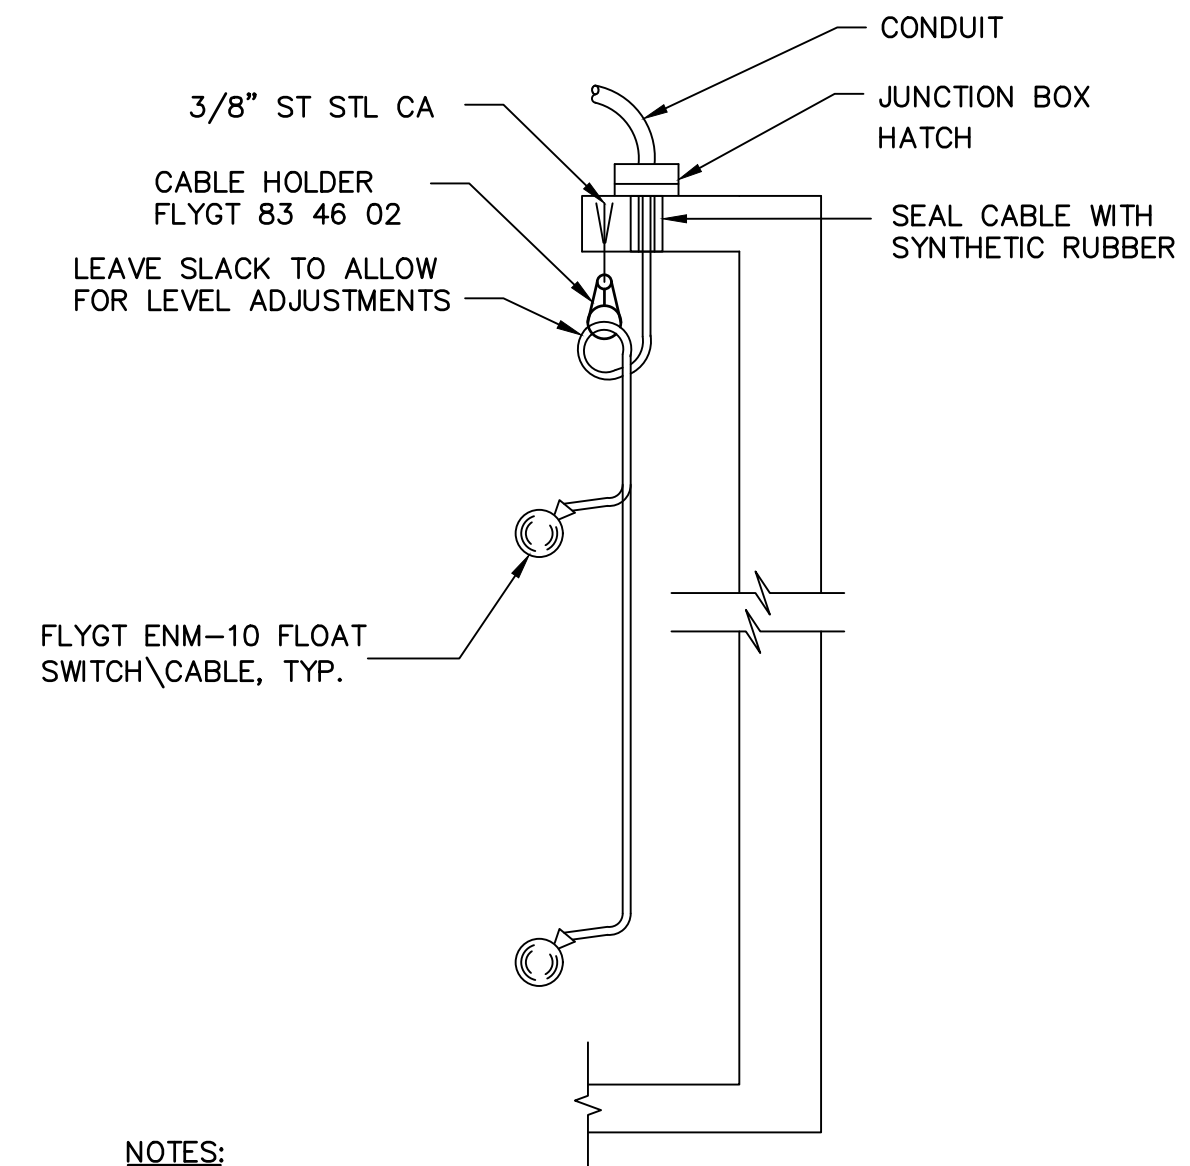

**WETWELL FLOAT SWITCH MOUNTING**

SCALE = NONE

**SPECIFIC DOOR NOTES**


1. PROVIDE ALL WORK IN ACCORDANCE WITH THE PROJECT SPECIFICATIONS.
2. THE EXACT LOCATION OF ALL EQUIPMENT SHALL BE VERIFIED IN THE FIELD WITH THE OWNER PRIOR TO ROUGH-IN.
3. ALL MOUNTING EQUIPMENT AND HARDWARE SHALL BE STAINLESS STEEL.
4. ALL WORK SHALL COMPLY WITH CITY OF PHOENIX DEVELOPMENT SERVICES DEPARTMENT ACCESS CONTROL SYSTEM TECHNICAL GUIDELINE. OBTAIN A COPY AS NEEDED.
5. NOT ALL DETAILS NECESSARILY USED.

- NOTES:
1. ATTACH CABLES TO JUNCTION BOX WITH NYLON FITTING, STAINLESS STEEL CORD GRIP: HUBBELL SERIES 74 OR EQUAL.

SYMBOL	VOLTAGE/WATTAGE	LAMP TYPE	MOUNTING	DESCRIPTION	MANUFACTURER	REMARKS
A1	120V/54W	LED	CEILING 8' AFF	POLYESTER FIBERGLASS NON-CORROSIVE HOUSING WITH ACRYLIC LENS, WEATHER TIGHT WET LOCATION LISTED, IP65 OUTDOOR RATED	LITHONIA # FEM L48 4000LM IMAFM MD MVOLT GZ 30K 80CRI	LUMINARIES IN CHEMICAL ROOM
A2	120V/54W	LED	CEILING 8' AFF	POLYESTER FIBERGLASS NON-CORROSIVE HOUSING WITH ACRYLIC LENS, WEATHER TIGHT WET LOCATION LISTED, IP65 OUTDOOR RATED. SAME AS A1 EXCEPT WITH BATTERY BACK UP AND NIGHT LIGHT WIRED.	LITHONIA # FEM L48 4000LM IMAFM MD MVOLT GZ 30K 80CRI E10WMCP	LUMINARIES IN CHEMICAL ROOM
A3	120V/32W	LED	CEILING 8' AFF	4', 3500K LED WHITE LIGHTING STRIPS. UL LISTED. PENDANT AND SURFACE MOUNTED, INDOOR LOCATION.	LITHONIA LIGHTING, CLX LED STRIP LIGHTING CLX-L48-5000-HFE-SBLW-WDL-MVOLT-35K-80CRI	LUMINARIES IN ELECTRICAL ROOM
A4	120V/32W	LED	CEILING 8' AFF	4', 3500K LED WHITE LIGHTING STRIPS. UL LISTED. PENDANT AND SURFACE MOUNTED, INDOOR LOCATION. SAME AS A3 EXCEPT WITH BATTERY BACK UP AND NIGHT LIGHT WIRED.	LITHONIA LIGHTING, CLX LED STRIP LIGHTING CLX-L48-5000-HFE-SBLW-WDL-MVOLT-35K-80CRI	LUMINARIES IN ELECTRICAL ROOM
B	120V/12W	LED	WALL	WST LED, PERFORMANCE PACKAGE 1, 40000 K, VISIOAL COMFORT FORWARD THROW, MVOLT	LITHONIA WST LED P1 40K VF MVOLT PE (FINISH)	TASK LUMINARIES 10' AFF ABOVE DOOR TRANSOM
C	120V/1W	LED	WALL	RED LED, 1W, 120V, NICKEL CADMIUM BATTERY, UL DAMP LOCATION LISTED	LITHONIA LQM-S-W-3-R-120/277-EL-N	EXIT SIGN LUMINARIES ABOVE DOORS
D	120V/49W EACH	LED	4" SQ. POLE	DSXO LED P2 40K TSW MVOLT FOR TWIN HEADS NOTE: USE "TFTM" DISTRIBUTION IN PLACE OF "TSW" FOR NON-TWIN HEAD	LITHONIA DSXO LED P2 40K TFTM MVOLT SPA (FINISH) / SSS 12.5' W/2.5' BASE	HEIGHT OF POLE NOT TO EXCEED HEIGHT OF WALL. NOTE EACH POLE HAS A MANUAL ON/OFF TOGGLE SWITCH TO OPERATE ASSOCIATED LIGHTS.

**LUMINAIRE SCHEDULE**

DETAIL 1000  
NTS

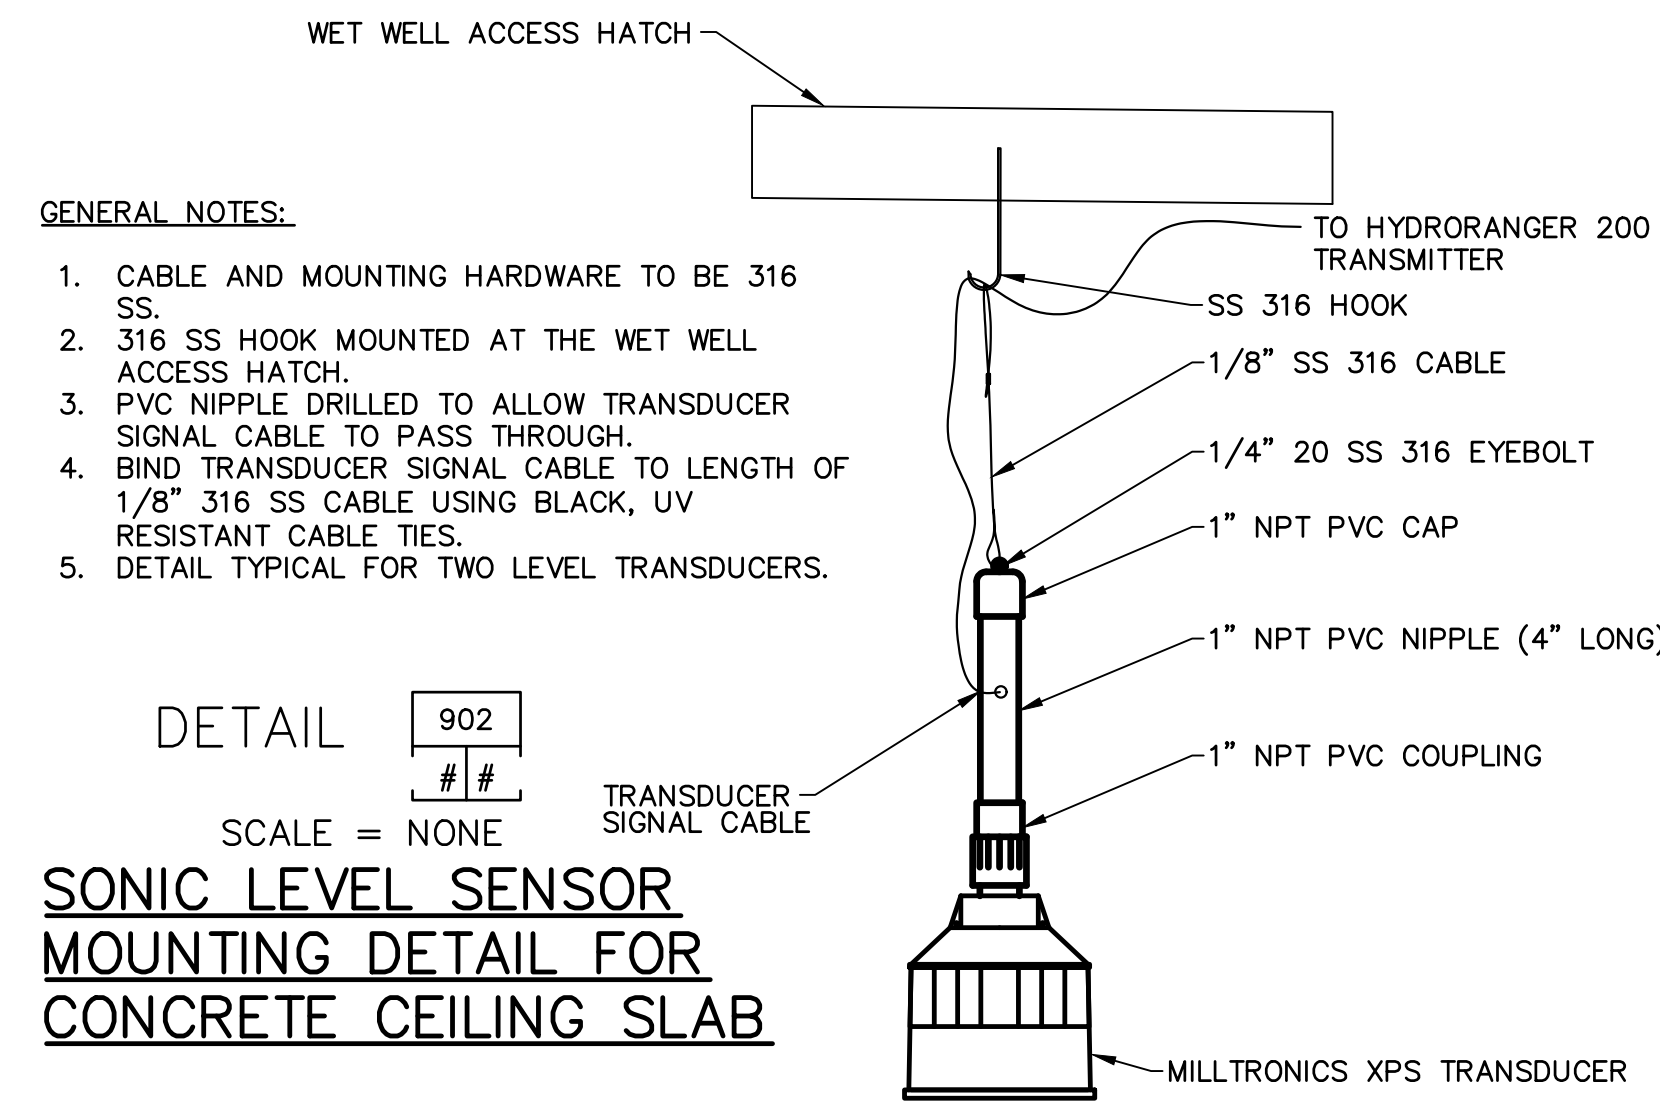

**SONIC LEVEL SENSOR MOUNTING DETAIL FOR CONCRETE CEILING SLAB**

DETAIL 902  
SCALE = NONE

**GENERAL NOTES:**

1. THIS DRAWING DOES NOT INDICATE ALL THE PROJECT REQUIREMENTS. THE PROJECT REQUIREMENTS ARE INDICATED IN VARIOUS ELECTRICAL AND INSTRUMENTATION DRAWINGS AND SPECIFICATIONS. ALL DOCUMENTS MUST BE CAREFULLY INSPECTED AND GATHERED TOGETHER IN ORDER TO INCLUDE THE COLLECTIVE REQUIREMENTS FOR THIS PROJECT.
2. WHERE DISCREPANCIES EXIST AMONG VARIOUS DRAWINGS AND/OR SPECIFICATIONS, THE CONTRACTOR SHALL INCLUDE THE ITEM WITH THE MOST STRINGENT REQUIREMENT. FOR EXAMPLE, THE MOST LABORIOUS INSTALLATION, THE LARGER CONDUCTOR AND CONDUIT, THE HIGHER RATING DEVICE AND EQUIPMENT, THE FURTHER DISTANCE, ETC...
3. INSTALL RECEPTACLES AND DATA OUTLETS AT 18 INCHES ABOVE FINISHED FLOOR.
4. FURNISH AND INSTALL A 20-AMP, 120V, WEATHERPROOF, GFCI RECEPTACLE WITHIN 25 FEET OF ALL HVAC EQUIPMENT EVEN IF THEY ARE NOT INDICATED ON THE DRAWINGS.
5. INSTALL RECEPTACLES AT 18 INCHES ABOVE FINISHED FLOOR.
6. INSTALL LIGHT SWITCHES AT 42 INCHES ABOVE FINISHED FLOOR.
7. INSTALL WALL MOUNTED LIGHT FIXTURES AT 8 FEET ABOVE FINISHED FLOOR.
8. ALL OUTDOOR LIGHT FIXTURES SHALL BE EQUIPPED WITH FULL CUT-OFF SHIELDS EVEN IF IT IS NOT INDICATED ON THE LIGHT FIXTURE SCHEDULE OR ELSEWHERE ON THE DRAWINGS AND/OR SPECIFICATIONS.
9. INSTALL CEILING MOUNTED LIGHT FIXTURES AT 12 FEET ABOVE FINISHED FLOOR.
10. FURNISH AND INSTALL LIGHTING CONTROL PANEL FOR ALL OUTDOOR LIGHTS. THE CONTROL PANEL SHALL MEET OR EXCEED THE FOLLOWING REQUIREMENTS
  - a. BE EQUIPPED WITH A MAIN CIRCUIT BREAKER RATED 65AIC
  - b. BE EQUIPPED WITH A CONTACTOR RATED FOR 30 AMPS
  - c. HAVE A VOLTAGE RATING AS INDICATED BY ITS FEEDER
  - d. TURN LIGHTS ON AND OFF BY A PHOTOCELL REMOTELY LOCATED OUTSIDE THE BUILDING.
  - e. BE EQUIPPED WITH A TIMER THAT LIMITS THE HOURS OF OPERATION DURING PHOTOCELL OPERATION
  - f. HAVE OVERRIDE CAPABILITY TO TURN LIGHTS ON AND OFF REGARDLESS OF PHOTOCELL
  - g. BE EQUIPPED WITH A NEMA 12 ENCLOSURE
  - h. LOCATION OF THE LIGHTING CONTROL PANEL WILL BE DETERMINED DURING CONSTRUCTION. ALLOW FOR 30 FEET OF DISTANCE BETWEEN THE POWER SOURCE AND THE LIGHTING CONTROL PANEL
  - i. LOCATION OF THE PHOTOCELL WILL BE DETERMINED DURING CONSTRUCTION. ALLOW FOR 100 FEET OF DISTANCE BETWEEN THE LIGHTING CONTROL PANEL AND THE PHOTOCELL

			NO.	BY	DATE	CKD	REVISIONS	REMARKS	DES		CITY OF PHOENIX WATER SERVICES DEPARTMENT  LIFT STATION 40 REFURBISHMENT	ELECTRICAL  ELECTRICAL DETAILS 6	COPYRIGHT © 2007-JANUARY
			* * * * * * *										

FACILITY DRAWINGS  
This drawing was supplied by a Consultant Engineer from a past construction project. The original contractor drawing was modified based on information provided by the Contractor to provide the Record Drawing. The City does not warrant the accuracy and reliability of the drawings and accurate portrayal of facilities as they exist in the field.

REVISIONS	DWG NUMBER	CAD FILE NAME	DATE	PROJECT NAME	PROJECT NO.	PROJECT NO.
*	*	*	*	*	*	*
*	*	*	*	*	*	*
*	*	*	*	*	*	*
*	*	*	*	*	*	*
*	*	*	*	*	*	*

THIS DRAWING MUST BE FIELD VERIFIED BEFORE USE  
DRAWING NOT TO SCALE UNLESS SCALE BAR IS PRESENT

FOR CONSTRUCTION

"PER CITY OF PHOENIX CODE CHAPTER 2, SECTION 2-28, THESE PLANS ARE FOR OFFICIAL USE ONLY AND MAY NOT BE SHARED WITH OTHERS EXCEPT AS REQUIRED TO FULFILL THE OBLIGATIONS OF THE CONTRACTOR'S CONTRACT WITH THE CITY OF PHOENIX."  
THIS DOCUMENT MUST BE KEPT SECURE AT ALL TIMES.

INSTRUMENT IDENTIFICATION TABLE		
LETTER	FIRST LETTER	SUCCEEDING LETTERS
	MEASURED OR INITIATING VARIABLE	READOUT OUTPUT OR PASSIVE FUNCTION
A	ANALYSIS	ALARM
B	BURNER, COMBUSTION	CLOSE, STOP, DECREASE
C	CONDUCTIVITY, COMPUTER	CONTROL
D	DENSITY, DIFFERENTIAL	OPEN, START, INCREASE
E	VOLTAGE (EMP)	SENSOR (PRIMARY ELEMENT)
F	FLOW RATE, RATIO (FRACTION)	FORWARD
G	MOISTURE	GLASS, GAUGE, GATE
H	HAND	HIGH, OPENED
I	CURRENT (ELECTRICAL)	INDICATE
J	POWER, SCAN	-
K	TIME, TIME SCHEDULE, TIME RATE OF CHANGE	CONTROL STATION
L	LEVEL	LOW, CLOSED
M	MOTOR, MANUAL	MOMENTARY, MIDDLE, INTERMEDIATE
N	INTRUSION	ON OPERATE, RUNNING
O	-	ORIFICE, RESTRICTION, OVERLOAD
P	PRESSURE, VACUUM	POINT (TEST) CONNECTION
Q	QUANTITY, INTEGRATE, TOTALIZE	-
R	RADIATION	RECORD
S	SPEED, FREQUENCY, MOTION, SAFETY	SWITCH
T	TEMPERATURE	TRANSMIT
U	MULTIVARIABLE	MULTIFUNCTION
V	VIBRATION, VALVE	VALVE, DAMPER, LOUVER
W	WEIGHT, FORCE, TORQUE	WELL
X	UNCLASSIFIED, X-AXIS	UNCLASSIFIED
Y	EVENT, STATE, PRESENCE, Y-AXIS	RELAY, COMPUTE, CONVERT
Z	POSITION, DIMENSION, Z-AXIS	DRIVER, ACTUATOR, OR UNCLASSIFIED FINAL CONTROL ELEMENT



**BASE INSTRUMENTATION SYMBOLS**

	FIELD MOUNTED
	FACE OF MCC OR PANEL MOUNTED
	INTERIOR OF PANEL MOUNTED
	FIELD INDICATOR
	PANEL INDICATOR
	OPERATOR INTERFACE FUNCTION
	AUXILLARY INTERFACE FUNCTION
	PLC FUNCTION
	IN-LINE
	TAPPED OR SAMPLED
	EXPOSED, SUBMERGED PROBE OR GAS DETECTOR

**ANALYSIS INSTRUMENTS**

- ALKY = ALKALINITY
- BOD = BIOCHEMICAL OXYGEN DEMAND
- CH4 = METHANE
- CO2 = CARBON DIOXIDE
- COMB = COMBUSTIBLE GAS
- CL2 = CHLORINE
- CLTR = CHLORINE TOTAL RESIDUAL
- CLFR = CHLORINE FREE RESIDUAL
- CO = CARBON MONOXIDE
- DE = DENSITY
- DO = DISSOLVED OXYGEN
- F = FLUORIDE
- FeCl3 = FERRIC CHLORIDE
- H2S = HYDROGEN SULFIDE
- H2SO4 = SULFURIC ACID
- H3PO4 = PHOSPHORIC ACID
- HC = HYDROCARBONS
- HDNS = HARDNESS
- HUM = HUMIDITY
- MOH = METHANOL
- NH = AMMONIA
- NO = NITRIC OXIDE
- N2 = NITROGEN
- O2 = OXYGEN
- OP = ORTHO PHOSPHATE
- ORP = OXIDATION REDUCTION POTENTIAL
- OUR = OXYGEN UPTAKE RATE
- OZ = OZONE
- PH = pH
- SD = SOLIDS DENSITY
- SO2 = SULPHUR DIOXIDE
- TOC = TOTAL ORGANIC CARBON
- TOD = TOTAL OXYGEN DEMAND
- TRB = TURBIDITY
- TSS = TOTAL SUSPENDED SOLIDS
- LEL = LOWER EXPLOSIVE LIMIT

**HAND SWITCHES/PUSHBUTTONS**

- ACK = ACKNOWLEDGE
- AM = AUTO/MANUAL
- CAM = COMPUTER/AUTO/MANUAL
- CLM = COMPUTER/LOCAL/MANUAL
- CM = COMPUTER/MANUAL
- COC = CLOSE/OPEN/COMPUTER
- ESP = EMERGENCY STOP
- ELOS = EMERGENCY LOCKOUT STOP
- FJ = FORWARD JOG
- FR = FORWARD/REVERSE
- FS = FAST/SLOW
- FOR = FORWARD/OFF/REVERSE
- FOS = FAST/OFF/SLOW
- FWD = FORWARD
- HO = HAND/OFF
- HOA = HAND/OFF/AUTO
- HOC = HAND/OFF/COMPUTER
- HOR = HAND/OFF/REMOTE
- HOAR = HAND/OFF/AUTO/REMOTE
- LC = LOCAL/COMPUTER
- LT = LAMP TEST
- LOC = LOCAL/OFF/COMPUTER
- LOR = LOCAL/OFF/REMOTE
- LOS = LOCKOUT STOP
- LR = LOCAL/REMOTE
- OAC = OPEN/AUTO/CLOSE
- OC = OPEN/CLOSE
- OCC = OPEN/CLOSE/COMPUTER
- OO = ON/OFF
- OSC = OPEN/STOP/CLOSE
- POT = POTENTIOMETER
- REV = REVERSE
- RJ = REVERSE JOG
- ROT = RUN/OFF/TEST
- RS = RESET
- SEL = SELECT
- SIL = SILENCE
- SLOS = START/LOCKOUT STOP
- SM = SYSTEM/MANUAL
- SP = STOP
- SS = START/STOP
- ST = START
- TST = TEST
- UD = UP/DOWN

**SIGNAL CONDITIONERS**

- \* = FUNCTION
- AVG = AVERAGE
- 1:1 = REPEAT
- 1:X = BOOST (X=MULTIPLIER)
- > = SELECT HIGHEST SIGNAL
- < = SELECT LOWEST SIGNAL
- X = BIAS
- % = GAIN ATTENUATE
- Δ = DIFFERENCE
- Σ = SUM
- × = MULTIPLY
- ÷ = DIVIDE
- F(x) = CHARACTERIZED
- √ = SQUARE ROOT
- X<sup>n</sup> = RAISED TO THE NTH POWER

**SIGNAL CONVERTERS**


\* = INITIAL VARIABLE/CONVERTED VARIABLE

- E = VOLTAGE
- F = FREQUENCY
- I = CURRENT
- M = MOTOR
- P = PNEUMATIC
- PF = PULSE FREQUENCY
- PD = PULSE DURATION
- R = RESISTANCE


**INDICATOR LIGHTS**

- LAH = LEVEL ALARM HIGH
- MA = MOTOR OVERLOAD ALARM
- MN = MOTOR RUN STATUS
- PAH = PRESSURE ALARM HIGH
- SA = STROBE ALARM
- YA = VFD FAULT

**SIGNAL LINE LEGEND**

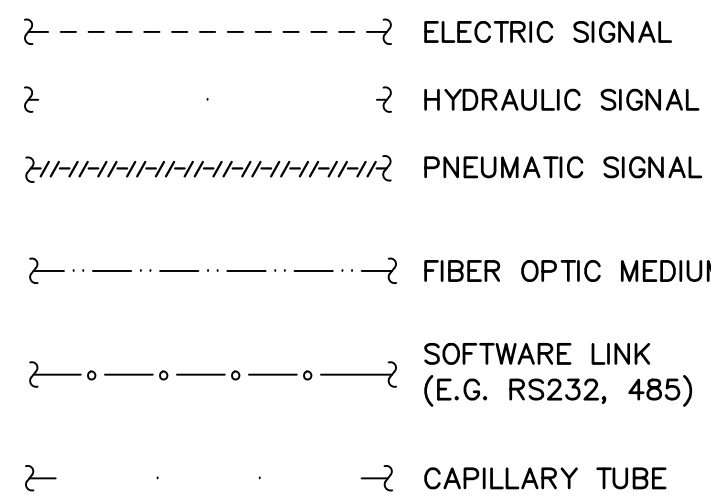


**CONTROL SYSTEM INPUTS & OUTPUTS**

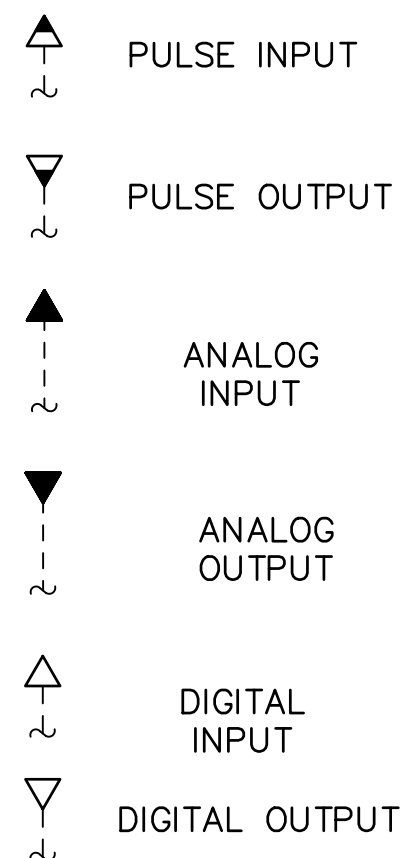

**ELECTRICAL INTERLOCKS**

## = A UNIQUE NUMBER (1 OR 2 DIGITS) ASSIGNED AS REFERENCE TO THE PARTICULAR INTERLOCK

NOTE: IN THE INTERLOCK LEGEND, LOCATED AT THE BOTTOM OF A P&ID, A BRIEF DESCRIPTION OF THE INTERLOCK'S FUNCTION IS PROVIDED AS WELL AS A REFERENCE TO THE CONTROL SCHEMATIC DRAWING NUMBER WHICH REFERENCES THE INTERLOCK.

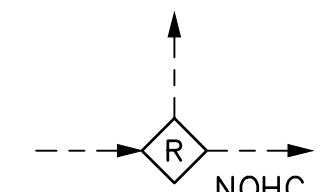

NC = NORMALLY CLOSED  
NO = NORMALLY OPEN  
NOHC = NORMALLY OPEN HELD CLOSED  
R = RELAY WITH EACH SIGNAL LINE LEAVING DENOTING A POLE  
R = RELAY WITH EACH SIGNAL LINE LEAVING DENOTING A POLE

**7-DIGIT SERIALIZED KEY**

XXXXXXXX


NOTE: ALL VALVES, INSTRUMENTS, MOTORS, EQUIPMENT, ETC. ARE TO HAVE A FIXED 7-DIGIT SERIAL NUMBER. THIS NUMBER IS TO BE ASSIGNED TO THE PROJECT BY THE CITY'S PROJECT MANAGER.

**EQUIPMENT PROVIDED BY OTHERS**




V\* = VENDOR PROVIDED INDIVISUAL PIECE OF EQUIPMENT  
O\* = OWNER PROVIDED INDIVISUAL PIECE OF EQUIPMENT

**FLOW STREAM LINE LEGEND**

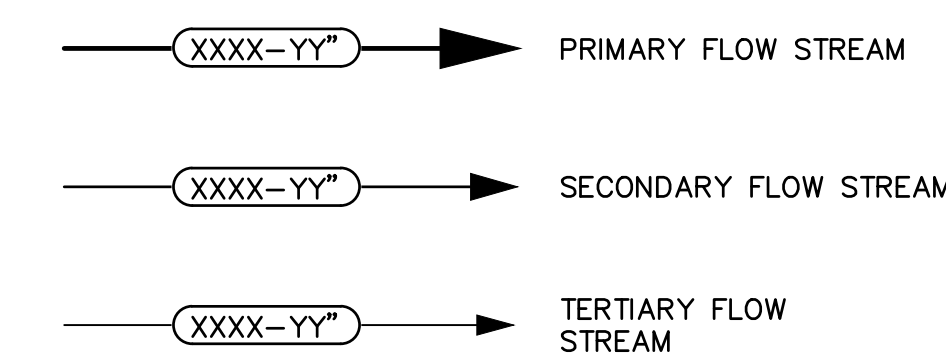



NOTE: XX IDENTIFIES THE FLOWSTREAM. SEE ABBREVIATIONS BELOW. ARROWS AND FLOW STREAM IDENTIFICATION TO BE LOCATED BEFORE AND AFTER EACH PIECE OF EQUIPMENT ON P&ID AS SPACE PERMITS. YY DENOTES LINE SIZE IN INCHES

**DRAWING CONTINUATION LEGEND**

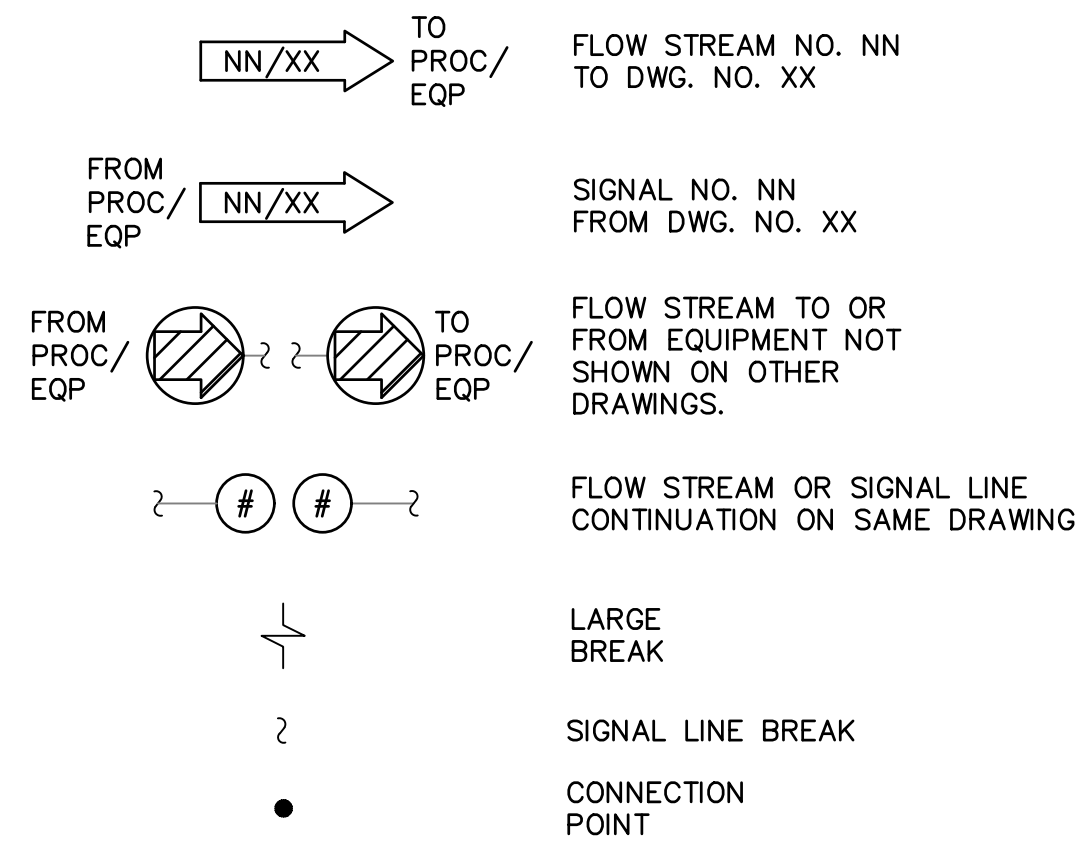


FACILITY DRAWINGS  
This drawing was supplied by a Consultant Engineer from a past construction project. The original constructor drawing was modified based on information provided by the Contractor to provide the Record Drawing. The City does not warrant the accuracy and/or completeness and accuracy portrayal of facilities as they exist in the field.

REVISION	DWG NUMBER	CAD FILE NAME	DATE	PROJECT NAME	PROJECT NO.	PROJECT NO.	PROJECT NO.

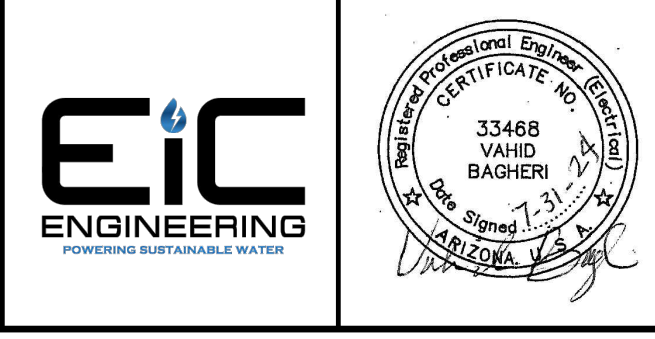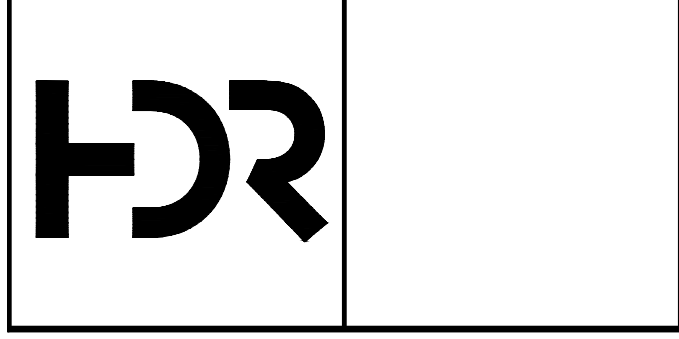

REVISIONS				DES
NO.	BY	DATE	CKD	REMARKS

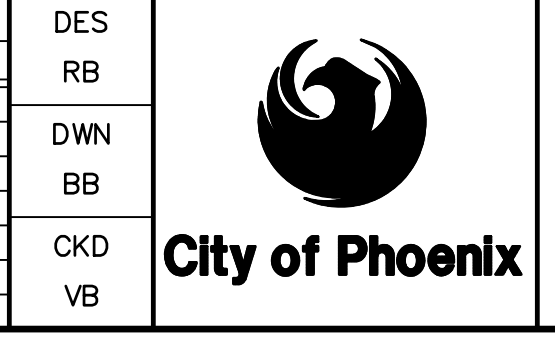

CITY OF PHOENIX  
WATER SERVICES DEPARTMENT  
  
LIFT STATION 40  
REFURBISHMENT

INSTRUMENTATION  
  
SYMBOLS AND LEGENDS 1

COPYRIGHT © 2007-JANUARY  
CITY PROJECT NO. WS90400085  
DATE: 08/2024  
I-01 SHEET 125 OF 134  
CAD FILE: CSLS40A01.dwg


THIS DRAWING MUST BE FIELD VERIFIED BEFORE USE  
DRAWING NOT TO SCALE UNLESS SCALE BAR IS PRESENT

**FOR CONSTRUCTION**

"PER CITY OF PHOENIX CODE CHAPTER 2, SECTION 2-28, THESE PLANS ARE FOR OFFICIAL USE ONLY AND MAY NOT BE SHARED WITH OTHERS EXCEPT AS REQUIRED TO FULFILL THE OBLIGATIONS OF THE CONTRACTOR'S CONTRACT WITH THE CITY OF PHOENIX."  
THIS DOCUMENT MUST BE KEPT SECURE AT ALL TIMES.

**ACTUATOR SYMBOLS**

- CYLINDER ACTUATOR  
XX
- DIAPHRAGM ACTUATOR (PRESSURE BALANCED)  
XX
- DIAPHRAGM ACTUATOR (SPRING OPPOSED)  
XX
- ELECTROHYDRAULIC ACTUATOR  
XX
- ELECTROPNEUMATIC ACTUATOR  
XX
- ELECTRIC ACTUATOR  
XX
- MANUAL ACTUATOR
- POSITIONER  
XX
- PRESSURE RELIEF
- SOLENOID ACTUATOR  
XX

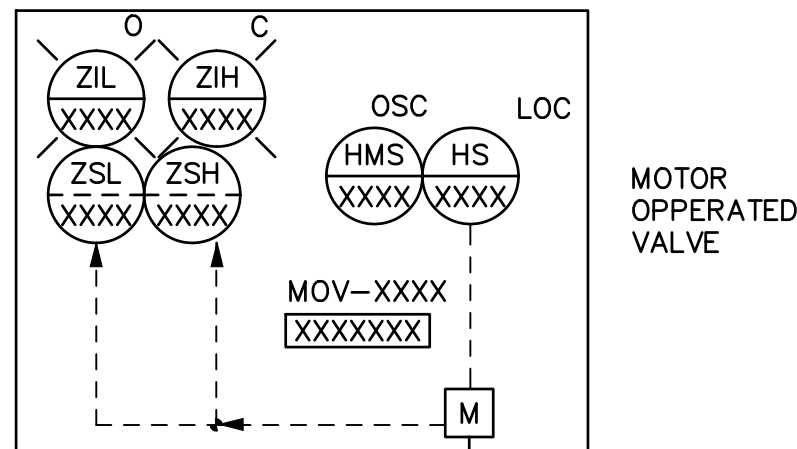

ACTUATOR XX INDICATES STATUS OF  
LEGEND: ACTUATOR ON LOSS OF POWER  
WITH THE FOLLOWING OPTIONS:  
FO = FAIL OPEN,  
FC = FAIL CLOSED,  
FP = FAIL TO PRE-SET POSITION, AND  
BLANK = FAIL TO LAST POSITION.

**COMMUNICATION SYMBOLS**

- RADIO TOWER
- RADIO WAVE PROPAGATION
- YAGI ANTENNA
- OMNIDIRECTIONAL ANTENNA

**EQUIPMENT SYMBOLS**

- BLOWER
- BURNER
- CALIBRATION COLUMN
- CHLORINATOR
- COMPRESSOR (CENTRIFUGAL)
- COMPRESSOR (RECIPROCATING, POSITIVE DISPLACEMENT)
- COMPRESSOR (ROTARY, POSITIVE DISPLACEMENT)
- COMPRESSOR
- COUPLING CONNECTION
- DAMPER
- DIFFUSER
- DISCONNECT SWITCH  
YS = AUXILIARY CONTACT XXXX = LOOP NO.  
XXXV = VOLTAGE
- DRAIN
- EJECTOR
- EMERGENCY EYEWASH & SHOWER
- EVAPORATOR
- FILTER
- FLEXIBLE HOSE
- GRINDER
- HEAT EXCHANGER
- LOAD CELL
- MIXER (STATIC)
- MIXER
- LARGE MOTOR
- SMALL MOTOR
- OIL EXPANSION CHAMBER
- PULSATION DAMPENER
- REDUCER
- ROTARY CHEMICAL FEEDER
- SEPARATOR
- SILENCER
- STRAINER
- TURBINE
- VENT TO ATMOSPHERE
- CONDENSATION DRAIN
- OPERATOR INTERFACE TERMINAL
- ALARM SIREN  
Y = H-PROCESS ALARM HORN  
S = PERSONNEL SAFETY SIREN
- STROBE  
AAH = ALARM STROBE  
XXXX = LOOP NO.

**FLOW ELEMENTS**

- ADFM ACOUSTIC DOPPLER FLOW METER
- BATCHMETER (PROPELLER/VALVE)
- DENSITY (MICROWAVE)
- FLUME FLOW ELEMENT
- MAGNETIC FLOW ELEMENT (IN LINE)
- MAGNETIC FLOW ELEMENT (INSERTION)
- MASS FLOW CORIOLIS TYPE
- MASS FLOW THERMAL METER
- ORIFICE PLATE FLOW ELEMENT
- PRIMARY FLOW ELEMENT: PILOT TUBE
- ROTAMETER FLOW ELEMENT
- SONIC (CLAMP ON)
- SONIC FLOW ELEMENT (IN LINE)
- TARGET TYPE FLOW ELEMENT
- TOTALIZING ELEMENT: POSITIVE DISPLACEMENT FLOW
- TURBINE OR PROPELLER FLOW ELEMENT
- V-NOTCH WEIR
- VENTURI TUBE FLOW ELEMENT
- VORTEX FLOW ELEMENT

**GATE SYMBOLS**

- SLIDE GATE
- SLUICE GATE

**LEVEL ELEMENTS**

- BUBBLER LEVEL ELEMENT
- CAPACITANCE LEVEL ELEMENT
- CONDUCTIVITY LEVEL ELEMENT
- FLOAT LEVEL ELEMENT
- RADAR LEVEL ELEMENT
- RESISTIVE TAPE LEVEL ELEMENT
- SUBMERSIBLE LEVEL
- ULTRASONIC LEVEL ELEMENT
- SIGHT GLASS

**PUMP SYMBOLS**

\* INDICATES SPEED  
CS = COSTANT SPEED  
2S = TWO SPEED  
VS = VARIABLE SPEED  
VT = VARIABLE STROKE (PER METERING PUMPS ONLY)  
BLANK = UNKNOWN

- CENTRIFUGAL PUMP
- DIAPHRAGM PUMP
- METERING, PERISTALTIC, OR PROPORTIONING PUMP
- PISTON PUMP
- PROGRESSIVE CAVITY PUMP
- ROTARY PUMP
- SCREW (LIFT) PUMP POSITIVE DISPLACEMENT
- SUBMERSIBLE SUMP PUMP
- VERTICAL TURBINE PUMP

**VALVE SYMBOLS**

- 3-WAY VALVE
- 4-WAY VALVES
- BACKFLOW PREVENTER
- BACKPRESSURE REGULATOR SELF CONTAINED
- BALL CHECK VALVE
- BALL VALVE
- BUTTERFLY VALVE
- DIAPHRAGM SEAL
- DIAPHRAGM VALVE
- FLAPPER CHECK VALVE
- FLOW STRAIGHTENER
- GATE VALVE
- GLOBE VALVE
- KNIFE VALVE
- NEEDLE VALVE
- PETCOCK
- PINCH VALVE
- PLUG VALVE
- PRESSURE REGULATING VALVE SELF CONTAINED
- PRESSURE RELIEF VALVE
- RUPTURE DISK (PRESSURE RELIEF)
- RUPTURE DISK (VACUUM RELIEF)
- SWING CHECK VALVE
- TELESCOPING VALVE
- VACUUM RELIEF VALVE
- VEE BALL VALVE

FACILITY DRAWINGS  
This drawing was supplied by a Consultant Engineer from a past construction project. The original contractor to provide the Record Drawing on information provided by the Contractor to provide the Record Drawing. The City does not warrant the accuracy and reliability of the information and accuracy of the data provided in the field.

REVISION	ENGINEERING COMPANY	PROJECT NO.	PROJECT NAME	DATE	CAD FILE NAME	DWG NUMBER	REMARKS

			REVISIONS					DES RB		CITY OF PHOENIX WATER SERVICES DEPARTMENT	INSTRUMENTATION	COPYRIGHT © 2007-JANUARY
			NO.	BY	DATE	CKD	REMARKS					
<b>City of Phoenix</b> <b>LIFT STATION 40 REFURBISHMENT</b> <b>SYMBOLS AND LEGENDS 2</b>												
CITY PROJECT NO. WS90400085										DATE: 08/2024		
1-02										SHEET 126 OF 134		
CAD FILE: CSLS40IA02.dwg												

THIS DRAWING MUST BE FIELD VERIFIED BEFORE USE  
DRAWING NOT TO SCALE UNLESS SCALE BAR IS PRESENT

FOR CONSTRUCTION

\*PER CITY OF PHOENIX CODE CHAPTER 2, SECTION 2-28, THESE PLANS ARE FOR OFFICIAL USE ONLY AND MAY NOT BE SHARED WITH OTHERS EXCEPT AS REQUIRED TO FULFILL THE OBLIGATIONS OF THE CONTRACTOR'S CONTRACT WITH THE CITY OF PHOENIX.  
THIS DOCUMENT MUST BE KEPT SECURE AT ALL TIMES.

COMPUTER CONTROL SYSTEM TAG EXTENSIONS

DIGITAL INPUT (STATUS)	DESCRIPTION	DIGITAL INPUT (ALARM)	DESCRIPTION	DIGITAL INPUT (ALARM) (CONTINUED)	DESCRIPTION	ANALOG INPUT	DESCRIPTION	ANALOG OUTPUT	DESCRIPTION		
ATS Switch Activated ATS Switch Disabled ATS Switch in Normal Status Breaker Closed Status Breaker Open Status Disconnect Closed Emergency Lockout Stop Switch Status Emergency Mushroom Switch Equipment Closed (Generic) Equipment Hand-Off-Auto Switch Status Equipment at Maximum Capacity Equipment at Minimum Capacity Equipment Opened (Generic) Equipment Ready Equipment Running Status (Generic) Equipment 1/2 Select Switch Status Equipment Start Active Equipment Stop Active Equipment in Test Mode Flow Switch Status Forward Motion Status Gate Open Status Gate Close Status Local/Computer Switch Status Local/Remote Switch Status Panel Ready (circuit breaker common signal) Pump Lead/Lag Switch Status Pump Running Status Reverse Motion Status Valve Open Status Valve Close Status VFD Bypass Mode Selected VFD Running Status	ATSActive ATSDisabled ATSNormal BrkrClsed BrkrOpned DiscClsed ELOS EmergStop EquipClsed EquiplnAuto MaxCap MinCap EquipOpned EquipReady EquipRunStat SelectEquipOne EquipStart EquipStop EquipTestMd FlowPresent FwdMotion GateOpned GateClsed CompMode RemMode PwrFail PumpInLead PumpRunStat RevMotion VivOpned VivClsed VFDBypass VFDRunStat	ATS Low Voltage (Voltage Loss) Blower in Surge Condition Blower Shutdown due to Surge Condition Building Smoke Detector Alarm Chemical Eyewash Activated Door Intrusion Switch Alarm Electrical Breaker Tripped Equipment Alarm (Common or Generic) Equipment Low Battery Feed Pump Diaphragm Leak Generator Battery Low Voltage Generator Battery High Voltage Generator Overcrank Detected Generator Overspeed Detected Generic System Fail High High Density High High Torque Alarm High High Vibration High High Vibration in X Direction High High Vibration in Y Direction High High Vibration in Z Direction High Density High Speed High Torque Alarm High Vibration High Vibration in X Direction High Vibration in Y Direction High Vibration in Z Direction Low Speed Switch Activated Main Power Failure Maintenance Mode Motor Amperage Low Motor Amperage High Motor Bearing High Temperature Motor Failure Motor Overload Alarm Motor Stator Moisture Detect Motor Winding High Temperature No Seal Water Present Pipe Leak Detect Process Chem Concentration Low Low Level Process Chem Concentration Low Level Process Chem Concentration High High Level Process Chem Concentration High Level Process Gas Concentration Low Level Process Gas Concentration Low Low Level Generator Low Oil Pressure Generator Low Low Oil Pressure Generator High High Coolant Temperature Generator High Coolant Temperature Generator Low Coolant Temperature Generator Low Fuel Pressure Generator Battery Charger Fault Generator Emergency Stop Generator High Temperature Generator Ready	ATSLoVolt BlwrSurge BlwrHiSurge SmokeDet EyewashAct Intrusion BrkrTrip EquipAlm LoBatt DiaphLeak GenLoVolt GenHiVolt GenOvrCrnk GenOvrSpd SysFail HiHiDensity HiHiTorq HiHiVib HiHiXVib HiHiYVib HiHiZVib HiDensity HiSpd HiVib HiVibX HiVibY HiVibZ HiDensity HiSpd HiTorq HiVib HiXVib HiYVib HiZVib LowSpd PwrFail MaintMde LoMtrAmps HiMtrAmps MtrBearHiTemp MtrFail MtrOL MtrLeak MtrWindHiTemp NoSealWtr PipeLeak LoLoChemConc LoChemConc HiHiChemConc HiChemConc LoGasConc LoLoGasConc GenLoOilPress GenLoLoOilPress GenHiHiCoolTemp GenHiCoolTemp GenLoCoolTemp GenLoFuelPress GenBattChargFault GenEmergStop GenHiTemp GenReady	Process Gas Concentration High High Level Process Gas Concentration High Level Process Low Low Level Process Low Low Press Process Low Low Temp Process Low Flow Process Low Level Process Low Press Process Low Temp Process High High DPress Process High High Level Process High High Press Process High High Temp Process High DPress Process High Flow Process High Level Process High Press Process High Temp SCR Drive Fail Tank Leak Detect Ultrasonic Meter Loss of Echo Valve Failed Open Valve Failed Close Variable Frequency Drive Fail Sprinkler Water Flow	HiHiGasConc HiGasConc LoLoLevel LoLoPress LoLoTemp LoFlow LoLevel LoPress LoTemp HiHiDPress HiHiLevel HiHiPress HiHiTemp HiDPress HiFlow HiLevel HiPress HiTemp SCRDFail TankLeak EchoLoss OpenFail CloseFail VFDFail Sprkrlflow	Gate Close Command Gate Open Command Motor Forward Command Motor Reverse Command Motor Start Command Motor Start/Stop Command Motor Stop Command PLC/Serial Watchdog Bit Active Process Normal Remote Alarm Acknowledge Remote Chlorine Alarm Remote Common Alarm Remote Over-ride Remote Shutdown Reset Remote Timer Start Remote Timer Stop Valve Close Command Valve Open Command	GateCls GateOpn MtrFwd MtrRev MtrStart MtrStartStop MtrStop WtchDogbit ProcNorm RemAlmAck RemClAlm RemCmnAlm RemOvrRide RemReset RemStart TimerStop VivCls VivOpn	Counter in Time Engine RPM Equipment Position (Generic) Gate Position (0-100%) Generator Coolant Temperature Generator Oil Pressure Generator Speed Lamp Intensity Lamp Transmittance MCC or Switchgear AMPS AC MCC or Switchgear KW hours MCC or Switchgear Power Factor MCC or Switchgear VAR-hours MCC or Switchgear Volts AC MCC or Switchgear Volt-Amps MCC or Switchgear Volt-Amps Reactive MCC or Switchgear Watts Motor Bearing Temperature Motor AC Amperage Peristaltic Pump Speed Process Chemical Concentration Measurement Process Density or TSS Measurement Process Differential Pressure Process Dissolved Oxygen Measurement Process Flow Rate Process Gas Concentration Measurement Process Level Measurement Process Oxidation Reduction Potential Process pH Process Pressure Measurement Process Temperature Measurement Process Turbidity Measurement SCR Drive Speed Feedback Valve Position (0-100%) Variable Frequency Drive AMPS Variable Frequency Drive Frequency Variable Frequency Drive Speed Feedback Variable Frequency Drive Volts Vibration (Generic) Vibration in X Direction Vibration in Y Direction Vibration in Z Direction Water Hardness Measurement	Time RPM EquipPos GatePos GenCoolTemp GenOilPress Genspeed Intensity Transmittance Amps KWH PwrFactor VARH Volts Volt-Amps KVARs KW MtrBearTemp MtrAmps PmpSpeed ChemConc Density DPress DissOxy Flow GasConc Level ORP PH Press Temp Turbidity SCRDSpeed VivPos VFDamps VDFreq VFDspeed VFDvolts Vib XVib YVib ZVib Hardness	Equipment Position Control Flow Pacing Control Generic Process Setpoint Control Peristaltic Pump Speed Control SCR Drive Speed Control SCR Drive Stroke Control Valve Positioning Control Variable Frequency Drive Control	EquipPosCtrl FlowPaceCtrl SetpCtrl PmpSpdCtrl SCRDSpeedCtrl SCRStrokeCtrl VivPosCtrl VFDspeedCtrl
						<b>COMMON SOFTWARE GENERATED TAGS</b>		<b>DESCRIPTION</b>			
						PLC/Serial Equipment Communication Failed Pump or Equipment Accumulated Running Hours		CommFail Runtime			

NOTE: THESE TAG EXTENSIONS ARE THE CURRENT STANDARD. THEY ARE IN USE AT THE CAVE CREEK, UNION HILLS, AND NORTH GATEWAY FACILITIES.

COMPUTER CONTROL SYSTEM TAG EXTENSIONS

DIGITAL INPUTS	DESCRIPTION	MISC. USES	DIGITAL INPUTS	DESCRIPTION	MISC. USES	DIGITAL INPUTS	DESCRIPTION	MISC. USES	ANALOG OUTPUTS	DESCRIPTION	MISC. USES
AH AL EH EL FA FH FL HA IA IH IL JN JB LA	ALARM HIGH ALARM LOW VOLTAGE HIGH VOLTAGE LOW FLOW ALARM FLOW HIGH FLOW LOW HORN ALARM CURRENT ALARM CURRENT HIGH CURRENT LOW POWER ON POWER OFF LEVEL ALARM	FLOW HIGH HIGH, FLOW LOW LOW	PA PH PL SA SH SL TA TH TL UA	PRESSURE ALARM PRESSURE HIGH PRESSURE LOW SPEED ALARM SPEED HIGH SPEED LOW TEMPERATURE ALARM TEMPERATURE HIGH TEMPERATURE LOW MULTI-VARIABLE ALARM	PRESS. HIGH HIGH, PRESS. LOW LOW, PRESS. DIFFERENTIAL SPEED HIGH HIGH, SPEED LOW LOW MOTOR WINDINGS, TEMP, HIGH HIGH, TEMP, LOW LOW MOTOR BEARINGS EYEWASH, VFD DRIVE FAULT, SYSTEM FAIL ALARM, GRINDER JAMMED, HVAC ALARM HAZ/MAT ALARM, FAIL TO START, FIRE ALARM, MODULE FAILURE VIBRATION ALARM VIBRATION HIGH TORQUE ALARM TORQUE LOW TORQUE HIGH UNCLASSIFIED ALARM UNCLASSIFIED PREALARM UNCLASSIFIED RECORD	YA YB YC YD YF YM YN YR YX ZA ZB ZC ZD ZH ZL	SWITCH POSITION AUTO LOCK OUT STOP SWITCH POSITION SWITCH POSITION SWITCH POSITION FORWARD SWITCH POSITION REMOTE SWITCH POSITION SWITCH POSITION REVERSE SWITCH POSITION UNCLASSIFIED POSITION A POSITION B POSITION C POSITION D POSITION HIGH POSITION LOW	MOISTURE DETECTION, SWITCH POSITION 1, SWITCH TO EMERGENCY SWITCH POSITION 2, SWITCH TO NORMAL SWITCH POSITION 3, SWITCH TO NORMAL SWITCH POSITION 4 IN COMPUTER, EMERGENCY STOP, IN REMOTE, IN AUTO SWITCH POSITION REVERSE IN MANUAL, NORMAL MODE, L.O. STOP READY USED FOR 3 WAY VALVES, FAIL TO OPEN USED FOR 3 WAY VALVES, FAIL TO CLOSED FAIL TO MOVE TO THE OPEN POSITION FAIL TO MOVE TO THE CLOSE POSITION ON, OPENED OFF, CLOSED	FA FB FC KC LC VA VB VC SC	FLOW CONTROL FLOW CONTROL FLOW CONTROL TIME CONTROL LEVEL CONTROL VALVE CONTROL VALVE CONTROL VALVE CONTROL SPEED CONTROL	FLOW RATE A-USED WHEN MAPPING A REGISTER IN PLC FLOW RATE B-USED WHEN MAPPING A REGISTER IN PLC POSITION A-USED WHEN MAPPING A REGISTER IN PLC POSITION B-USED WHEN MAPPING A REGISTER IN PLC POSITION A-USED WHEN MAPPING A REGISTER IN PLC POSITION B-USED WHEN MAPPING A REGISTER IN PLC
LH LL MA MB MF MN MR MX	LEVEL HIGH LEVEL LOW MOTOR ALARM MOTOR OFF MOTOR FORWARD MOTOR ON MOTOR REVERSE MOTOR UNCLASSIFIED	OVERLOADS, DIAPHRAGM FAILURE	VA VH WA WL WH XA XH XR	VIBRATION ALARM VIBRATION HIGH TORQUE ALARM TORQUE LOW TORQUE HIGH UNCLASSIFIED ALARM UNCLASSIFIED PREALARM UNCLASSIFIED RECORD	INTRUSION ALARM, SENSOR FAILURE, MEDIA FAILURE, PULL CORD, FIRE ALARM, LEAK ALARM TRUCK DRIVER ID	DD LD MB MD ME MF MR SD UT VA VB VC VD UD	AUTODIALER ON LIGHTS ON MOTOR STOP MOTOR START MOTOR EMERGENCY STOP MOTOR FORWARD MOTOR REVERSE SYSTEM START RESET VALVE POSITION A VALVE CLOSE VALVE CONTROL VALVE OPEN MULTIVARIABLE ALARM	ACKNOWLEDGE ANNUNCIATOR USED FOR 3 WAY VALVES POSITION B (USED FOR 3 WAY VALVES) DIGITAL CONTROL OF VALVES ACTIVATES LOCAL ANNUNCIATOR	AI EI FI II JI LI PI SI TI VI WI ZI	ANALYSIS INDICATION VOLTAGE INDICATION FLOW INDICATION CURRENT INDICATION POWER INDICATION LEVEL INDICATION PRESSURE INDICATION SPEED INDICATION TEMPERATURE INDICATION VIBRATION INDICATION WEIGHT INDICATION POSITION INDICATION	WIND DIRECTION POWER FACTOR INDICATION, VARS. FREQUENCY, WATTS TORQUE INDICATION

NOTE: THESE TAG EXTENSIONS ARE BEING PHASED OUT. HOWEVER, THEY ARE STILL IN USE AT THE 23RD AND 91ST AVENUE FACILITIES.


FACILITY DRAWINGS  
This drawing was supplied by a Consultant Engineer from a past construction project. The original contractor to provide the Record Drawing information provided by the Contractor to provide the Record Drawing. The City does not warrant the accuracy of the information and accurate portrayal of facilities as they exist in the field.

REVISIONS	DWG NUMBER	CAD FILE NAME	DATE	PROJECT NAME	PROJECT NO.	REFERENCE CID NUMBER

THIS DRAWING MUST BE FIELD VERIFIED BEFORE USE  
DRAWING NOT TO SCALE UNLESS SCALE BAR IS PRESENT

FOR CONSTRUCTION

PER CITY OF PHOENIX CODE CHAPTER 2, SECTION 2-28, THESE PLANS ARE FOR OFFICIAL USE ONLY AND MAY NOT BE SHARED WITH OTHERS EXCEPT AS REQUIRED TO FULFILL THE OBLIGATIONS OF THE CONTRACTOR'S CONTRACT WITH THE CITY OF PHOENIX. THIS DOCUMENT MUST BE KEPT SECURE AT ALL TIMES.

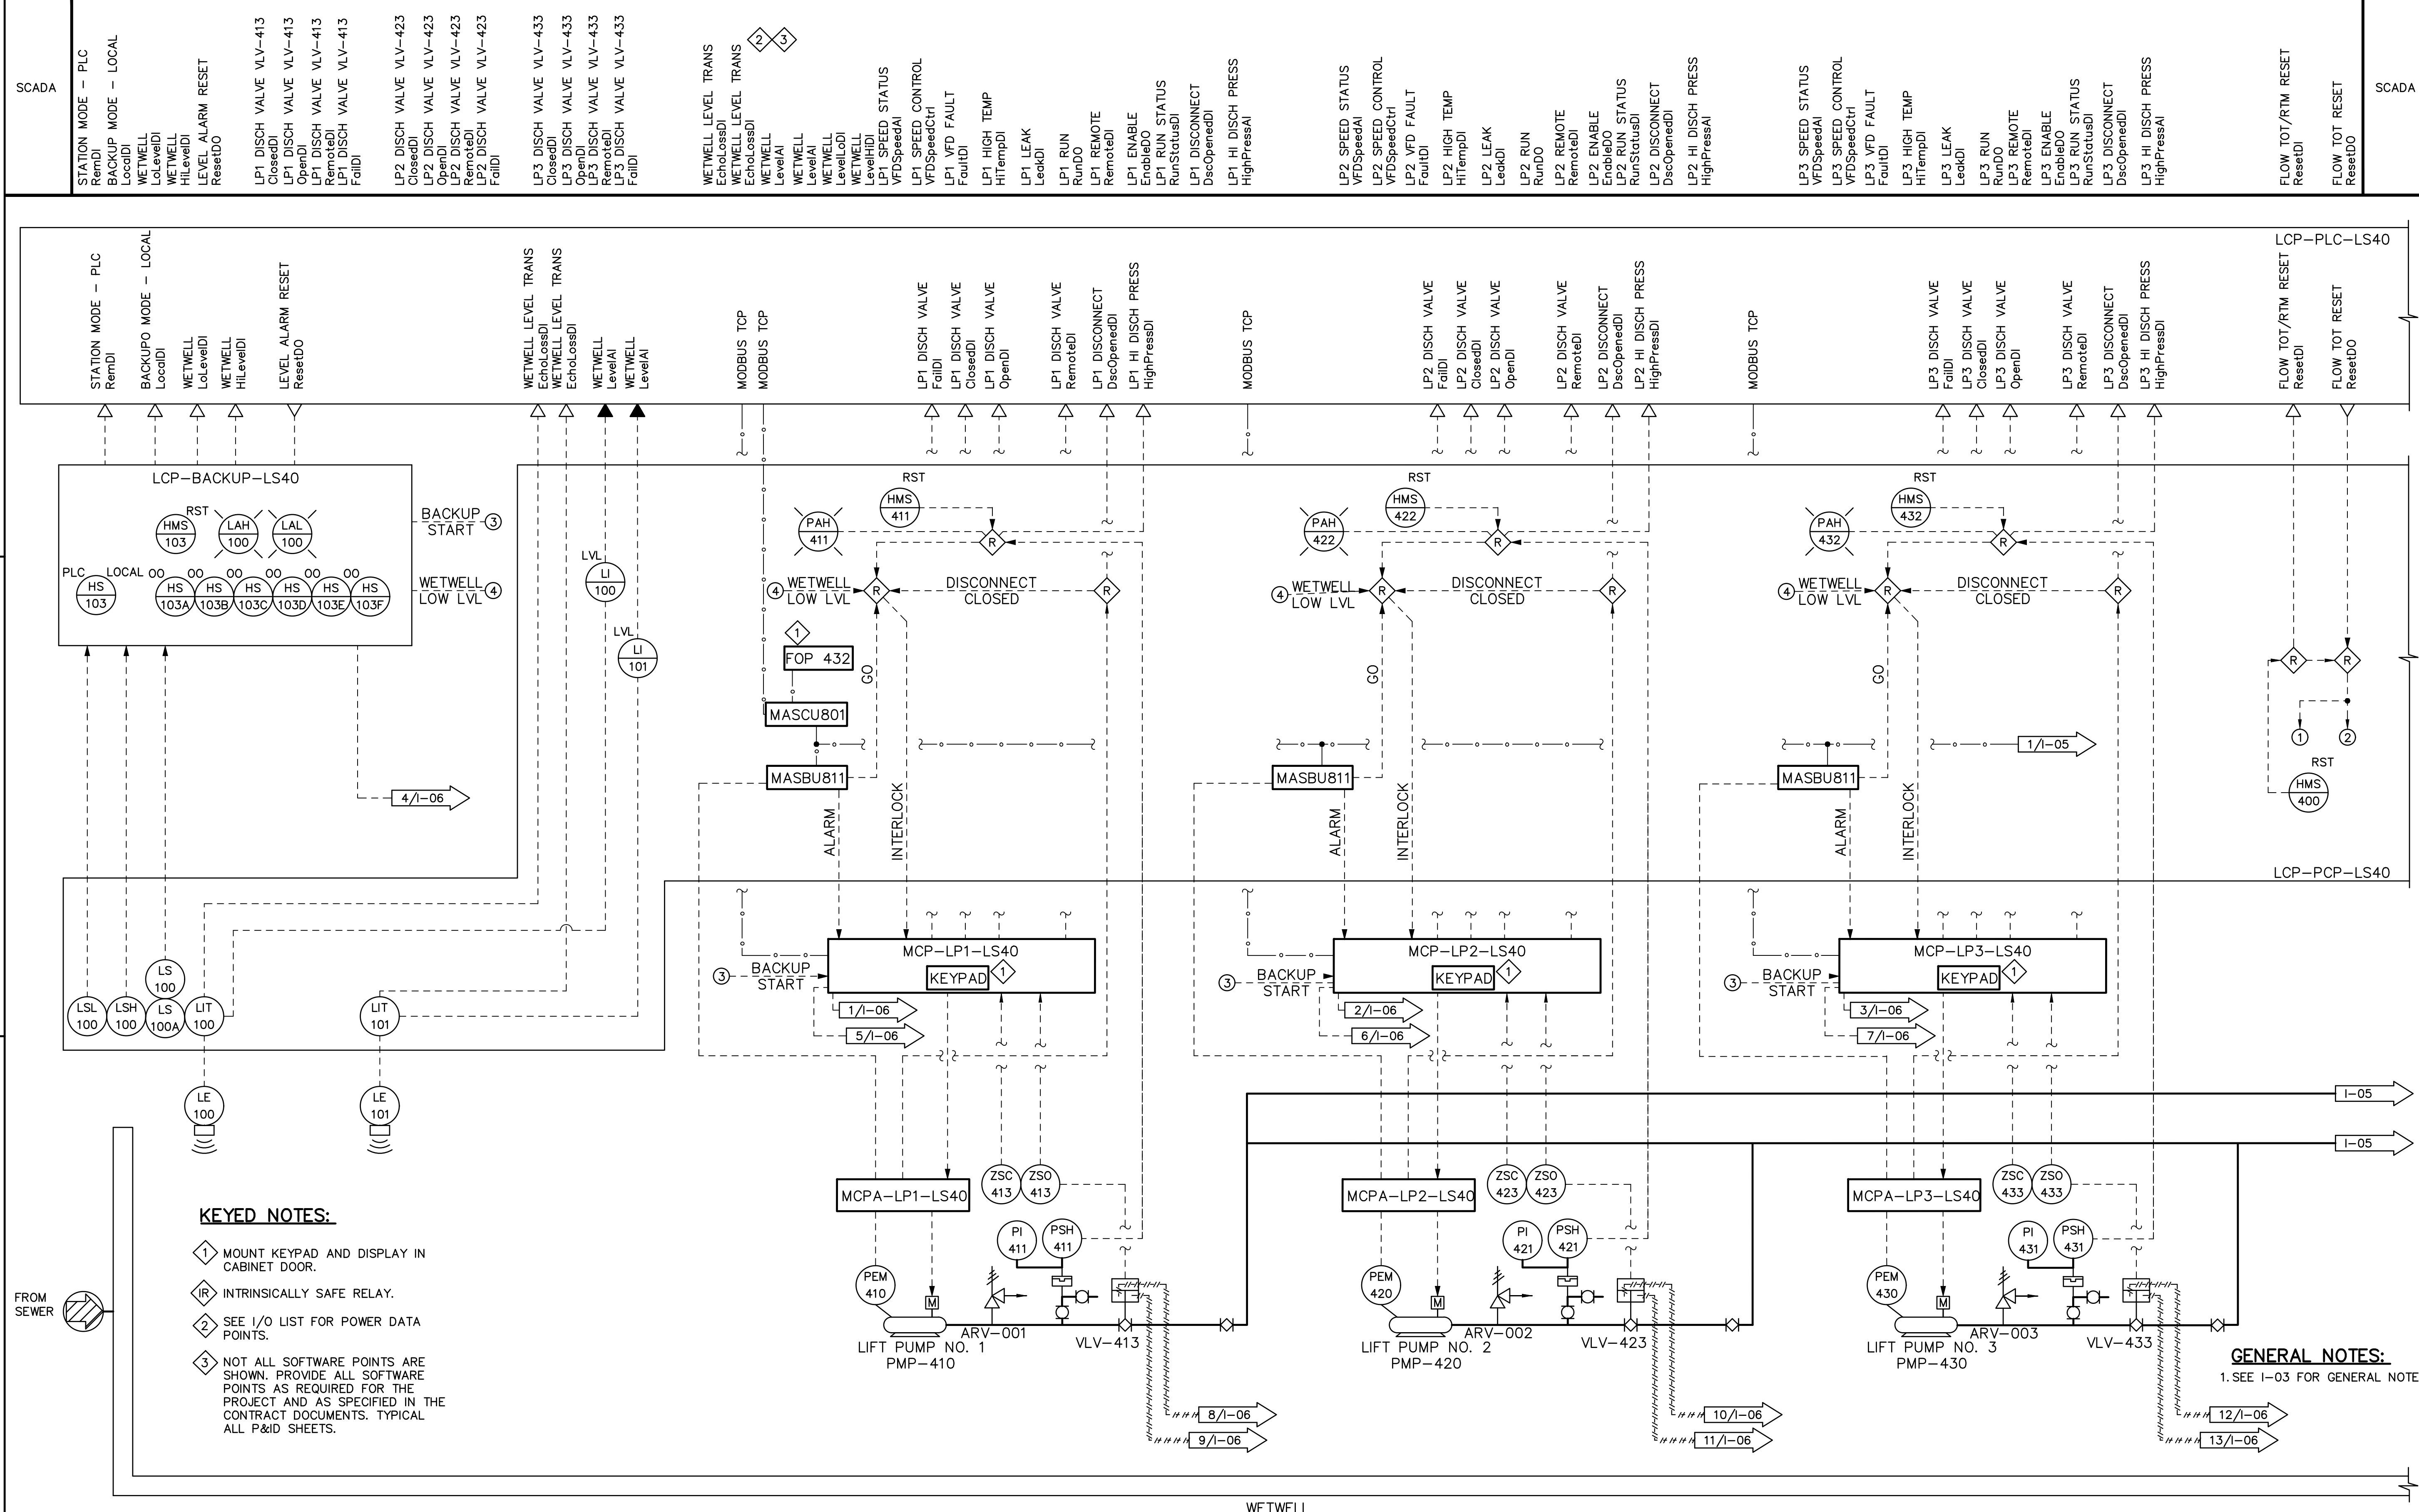



- KEYED NOTES:**
- ① MOUNT KEYPAD AND DISPLAY IN CABINET DOOR.
  - Ⓡ INTRINSICALLY SAFE RELAY.
  - ② SEE I/O LIST FOR POWER DATA POINTS.
  - ③ NOT ALL SOFTWARE POINTS ARE SHOWN. PROVIDE ALL SOFTWARE POINTS AS REQUIRED FOR THE PROJECT AND AS SPECIFIED IN THE CONTRACT DOCUMENTS. TYPICAL ALL P&ID SHEETS.

**GENERAL NOTES:**  
1. SEE I-03 FOR GENERAL NOTES.

REVISIONS					DES	CITY OF PHOENIX WATER SERVICES DEPARTMENT	INSTRUMENTATION	COPYRIGHT © 2007-JANUARY
NO.	BY	DATE	CKD	REMARKS				
					RB	 CITY OF PHOENIX WATER SERVICES DEPARTMENT LIFT STATION 40 REFURBISHMENT	INSTRUMENTATION  P&ID SHEET 1	CITY PROJECT NO. WS90400085 DATE: 08/2024 I-04 SHEET 128 OF 134 CAD FILE: CSLS40IN01.dwg
					DWN			
					BB			
					CKD			
					VB			

FACILITY DRAWINGS  
 This drawing was supplied by a Consultant Engineer from a past construction project. The original construction drawing was modified based on information provided by the Contractor to provide the Record Drawing. The City does not warrant the accuracy and reliability of the information and portrayal of facilities as they exist in the field.

REVISION	DWG NUMBER	CAD FILE NAME	DATE	PROJECT NAME	PROJECT NO.	REFERENCE CID NUMBER

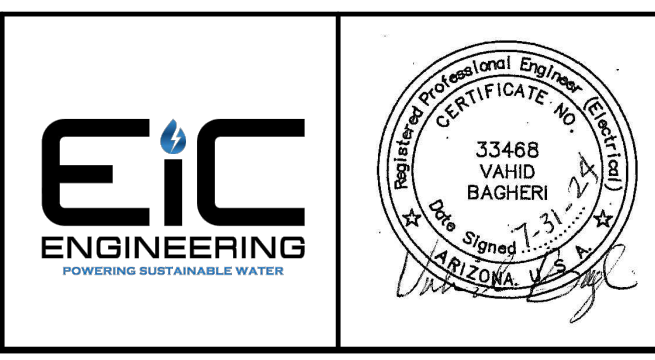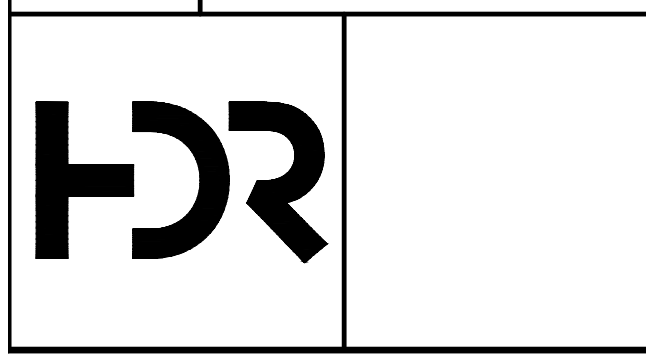









**FOR CONSTRUCTION**

PER CITY OF PHOENIX CODE CHAPTER 2, SECTION 2-28, THESE PLANS ARE FOR OFFICIAL USE ONLY AND MAY NOT BE SHARED WITH OTHERS EXCEPT AS REQUIRED TO FULFILL THE OBLIGATIONS OF THE CONTRACTOR'S CONTRACT WITH THE CITY OF PHOENIX. THIS DOCUMENT MUST BE KEPT SECURE AT ALL TIMES.

THIS DRAWING MUST BE FIELD VERIFIED BEFORE USE. DRAWING NOT TO SCALE UNLESS SCALE BAR IS PRESENT

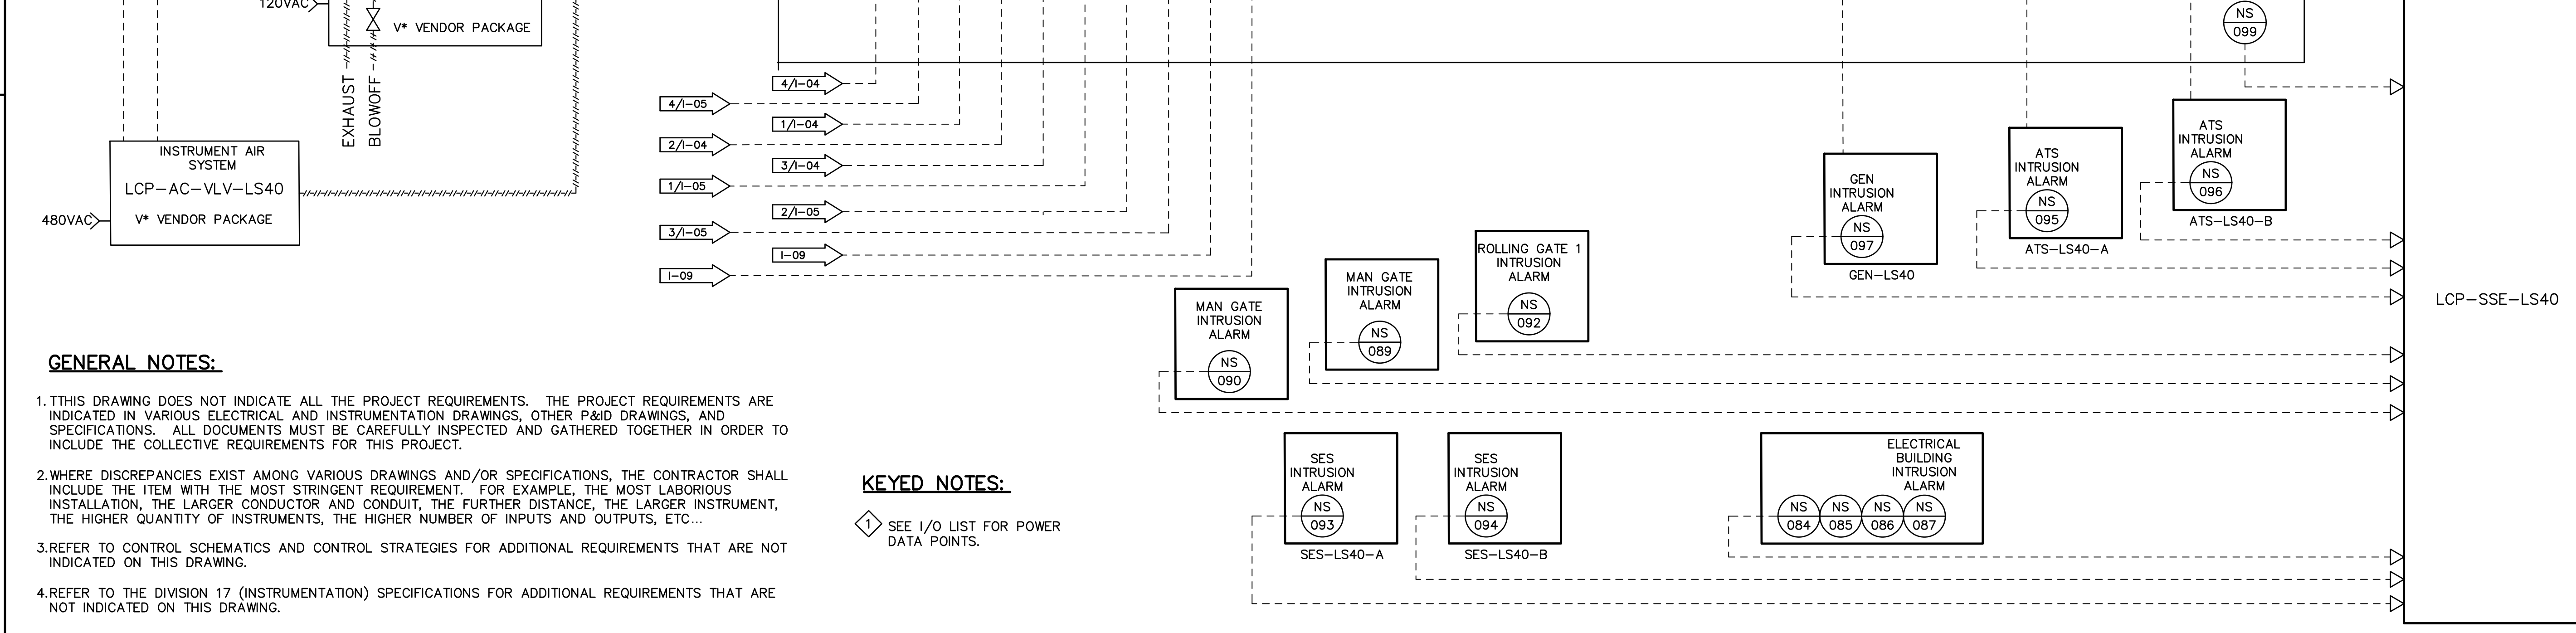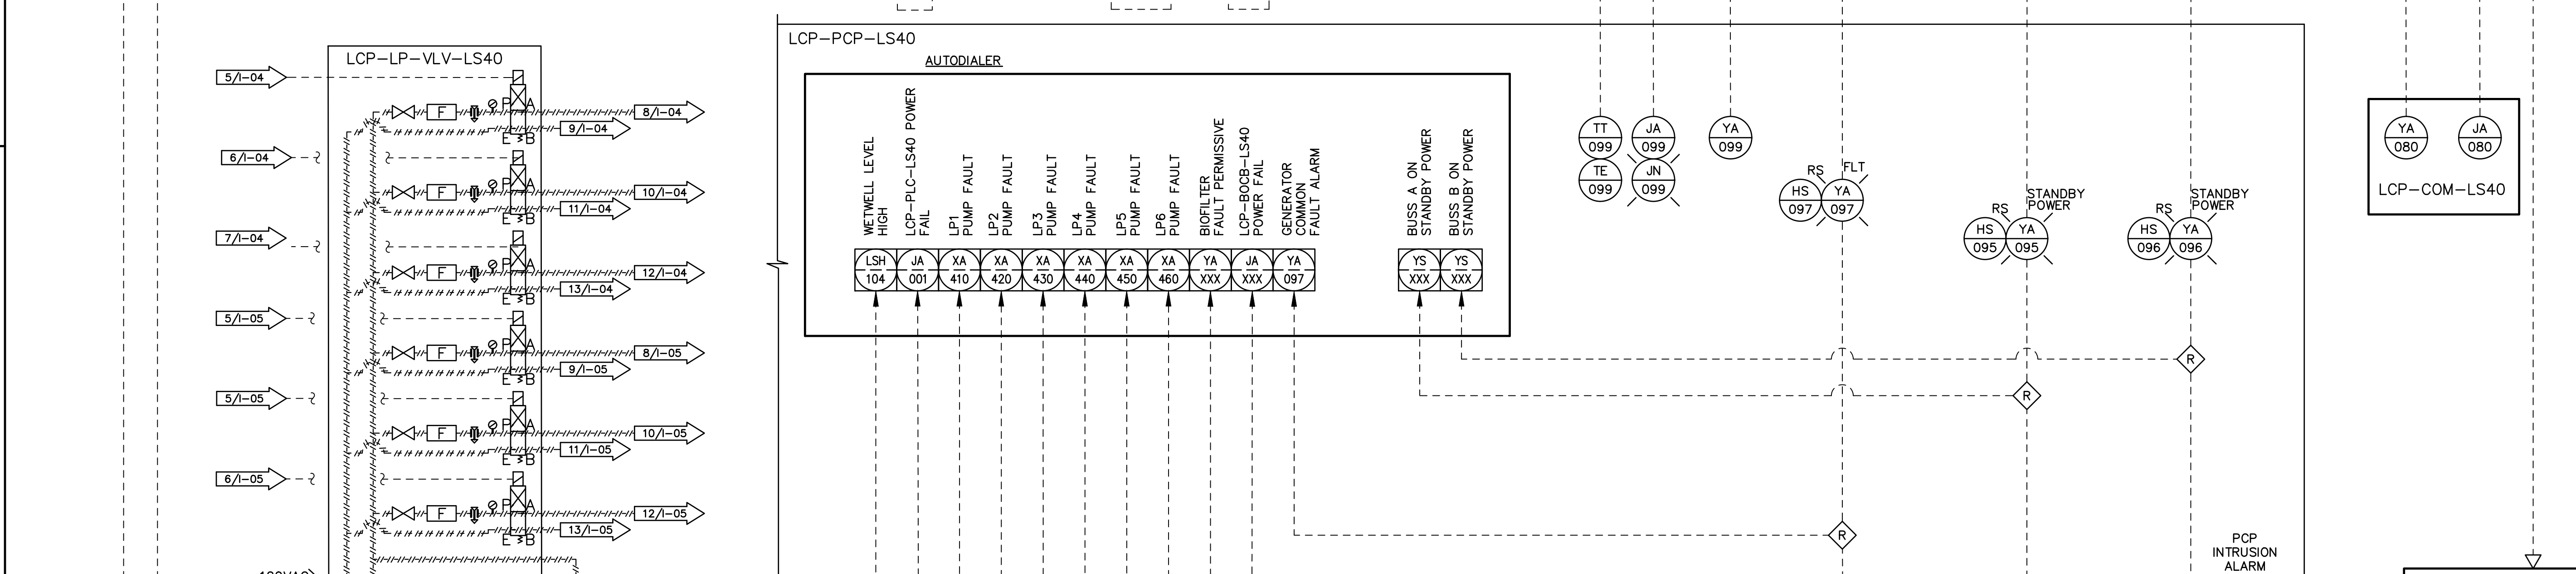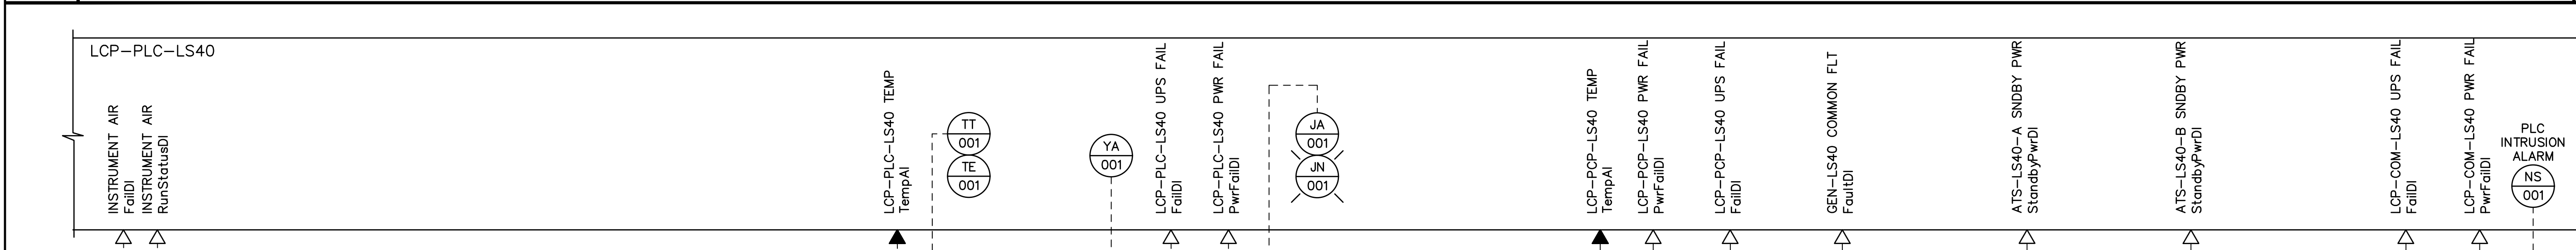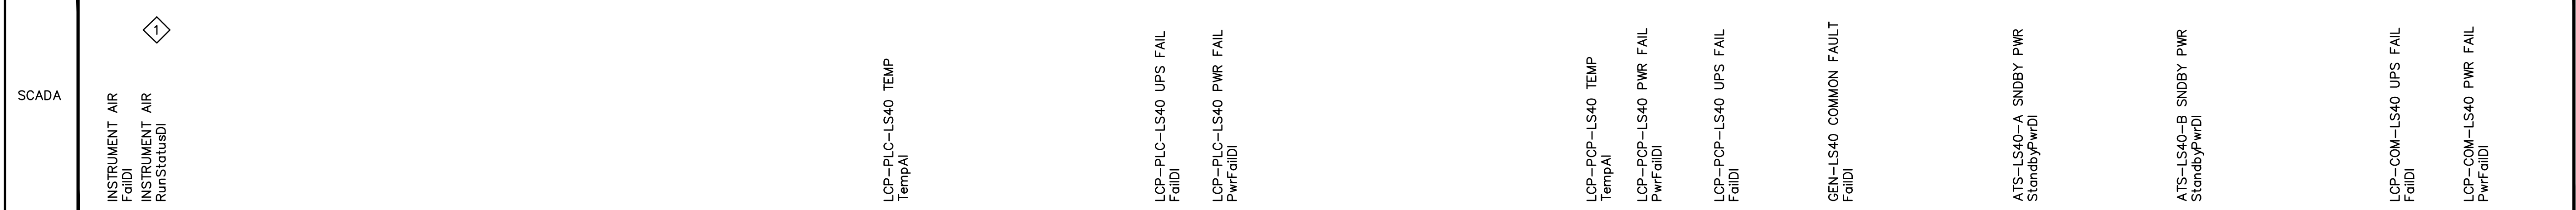

**GENERAL NOTES:**

1. THIS DRAWING DOES NOT INDICATE ALL THE PROJECT REQUIREMENTS. THE PROJECT REQUIREMENTS ARE INDICATED IN VARIOUS ELECTRICAL AND INSTRUMENTATION DRAWINGS, OTHER P&ID DRAWINGS, AND SPECIFICATIONS. ALL DOCUMENTS MUST BE CAREFULLY INSPECTED AND GATHERED TOGETHER IN ORDER TO INCLUDE THE COLLECTIVE REQUIREMENTS FOR THIS PROJECT.
2. WHERE DISCREPANCIES EXIST AMONG VARIOUS DRAWINGS AND/OR SPECIFICATIONS, THE CONTRACTOR SHALL INCLUDE THE ITEM WITH THE MOST STRINGENT REQUIREMENT. FOR EXAMPLE, THE MOST LABORIOUS INSTALLATION, THE LARGER CONDUCTOR AND CONDUIT, THE FURTHER DISTANCE, THE LARGER INSTRUMENT, THE HIGHER QUANTITY OF INSTRUMENTS, THE HIGHER NUMBER OF INPUTS AND OUTPUTS, ETC...
3. REFER TO CONTROL SCHEMATICS AND CONTROL STRATEGIES FOR ADDITIONAL REQUIREMENTS THAT ARE NOT INDICATED ON THIS DRAWING.
4. REFER TO THE DIVISION 17 (INSTRUMENTATION) SPECIFICATIONS FOR ADDITIONAL REQUIREMENTS THAT ARE NOT INDICATED ON THIS DRAWING.

**KEYED NOTES:**

- 1 SEE I/O LIST FOR POWER DATA POINTS.

			REVISIONS				DES RB		CITY OF PHOENIX WATER SERVICES DEPARTMENT  LIFT STATION 40 REFURBISHMENT	INSTRUMENTATION  P&ID SHEET 3	COPYRIGHT © 2007-JANUARY CITY PROJECT NO. WS90400085 DATE: 08/2024 1-06 SHEET 130 OF 134 CAD FILE: CSLS40IN03.dwg	
			NO.	BY	DATE	CKD						REMARKS

FACILITY DRAWINGS  
This drawing was supplied by a Consultant Engineer from a past construction project. The original construction drawing was modified based on information provided by the Contractor to provide the Record Drawing. The City does not warrant the accuracy and reliability of the information and portrayal of facilities as they exist in the field.

REVISION	DATE	CAD FILE NAME	DWG NUMBER	REMARKS

FOR CONSTRUCTION

\*PER CITY OF PHOENIX CODE CHAPTER 2, SECTION 2-28, THESE PLANS ARE FOR OFFICIAL USE ONLY AND MAY NOT BE SHARED WITH OTHERS EXCEPT AS REQUIRED TO FULFILL THE OBLIGATIONS OF THE CONTRACTOR'S CONTRACT WITH THE CITY OF PHOENIX. THIS DOCUMENT MUST BE KEPT SECURE AT ALL TIMES.


THIS DRAWING MUST BE FIELD VERIFIED BEFORE USE DRAWING NOT TO SCALE UNLESS SCALE BAR IS PRESENT

SCADA		SCADA
-------	--	-------

**GENERAL NOTES:**

1. THIS DRAWING DOES NOT INDICATE ALL THE PROJECT REQUIREMENTS. THE PROJECT REQUIREMENTS ARE INDICATED IN VARIOUS ELECTRICAL AND INSTRUMENTATION DRAWINGS, OTHER P&ID DRAWINGS, AND SPECIFICATIONS. ALL DOCUMENTS MUST BE CAREFULLY INSPECTED AND GATHERED TOGETHER IN ORDER TO INCLUDE THE COLLECTIVE REQUIREMENTS FOR THIS PROJECT.
2. WHERE DISCREPANCIES EXIST AMONG VARIOUS DRAWINGS AND/OR SPECIFICATIONS, THE CONTRACTOR SHALL INCLUDE THE ITEM WITH THE MOST STRINGENT REQUIREMENT. FOR EXAMPLE, THE MOST LABORIOUS INSTALLATION, THE LARGER CONDUCTOR AND CONDUIT, THE FURTHER DISTANCE, THE LARGER INSTRUMENT, THE HIGHER QUANTITY OF INSTRUMENTS, THE HIGHER NUMBER OF INPUTS AND OUTPUTS, ETC...
3. REFER TO CONTROL SCHEMATICS AND CONTROL STRATEGIES FOR ADDITIONAL REQUIREMENTS THAT ARE NOT INDICATED ON THIS DRAWING.
4. REFER TO THE DIVISION 17 (INSTRUMENTATION) SPECIFICATIONS FOR ADDITIONAL REQUIREMENTS THAT ARE NOT INDICATED ON THIS DRAWING.

FACILITY DRAWINGS  
This drawing was supplied by a Consultant Engineer from a past construction project. The original construction drawing was modified based on information provided by the Contractor to provide the Record Drawing. The City does not warrant the accuracy and reliability of the information and accuracy of any data or information provided by the Contractor to provide the Record Drawing. The City does not warrant the accuracy and reliability of the information and accuracy of any data or information provided by the Contractor to provide the Record Drawing.

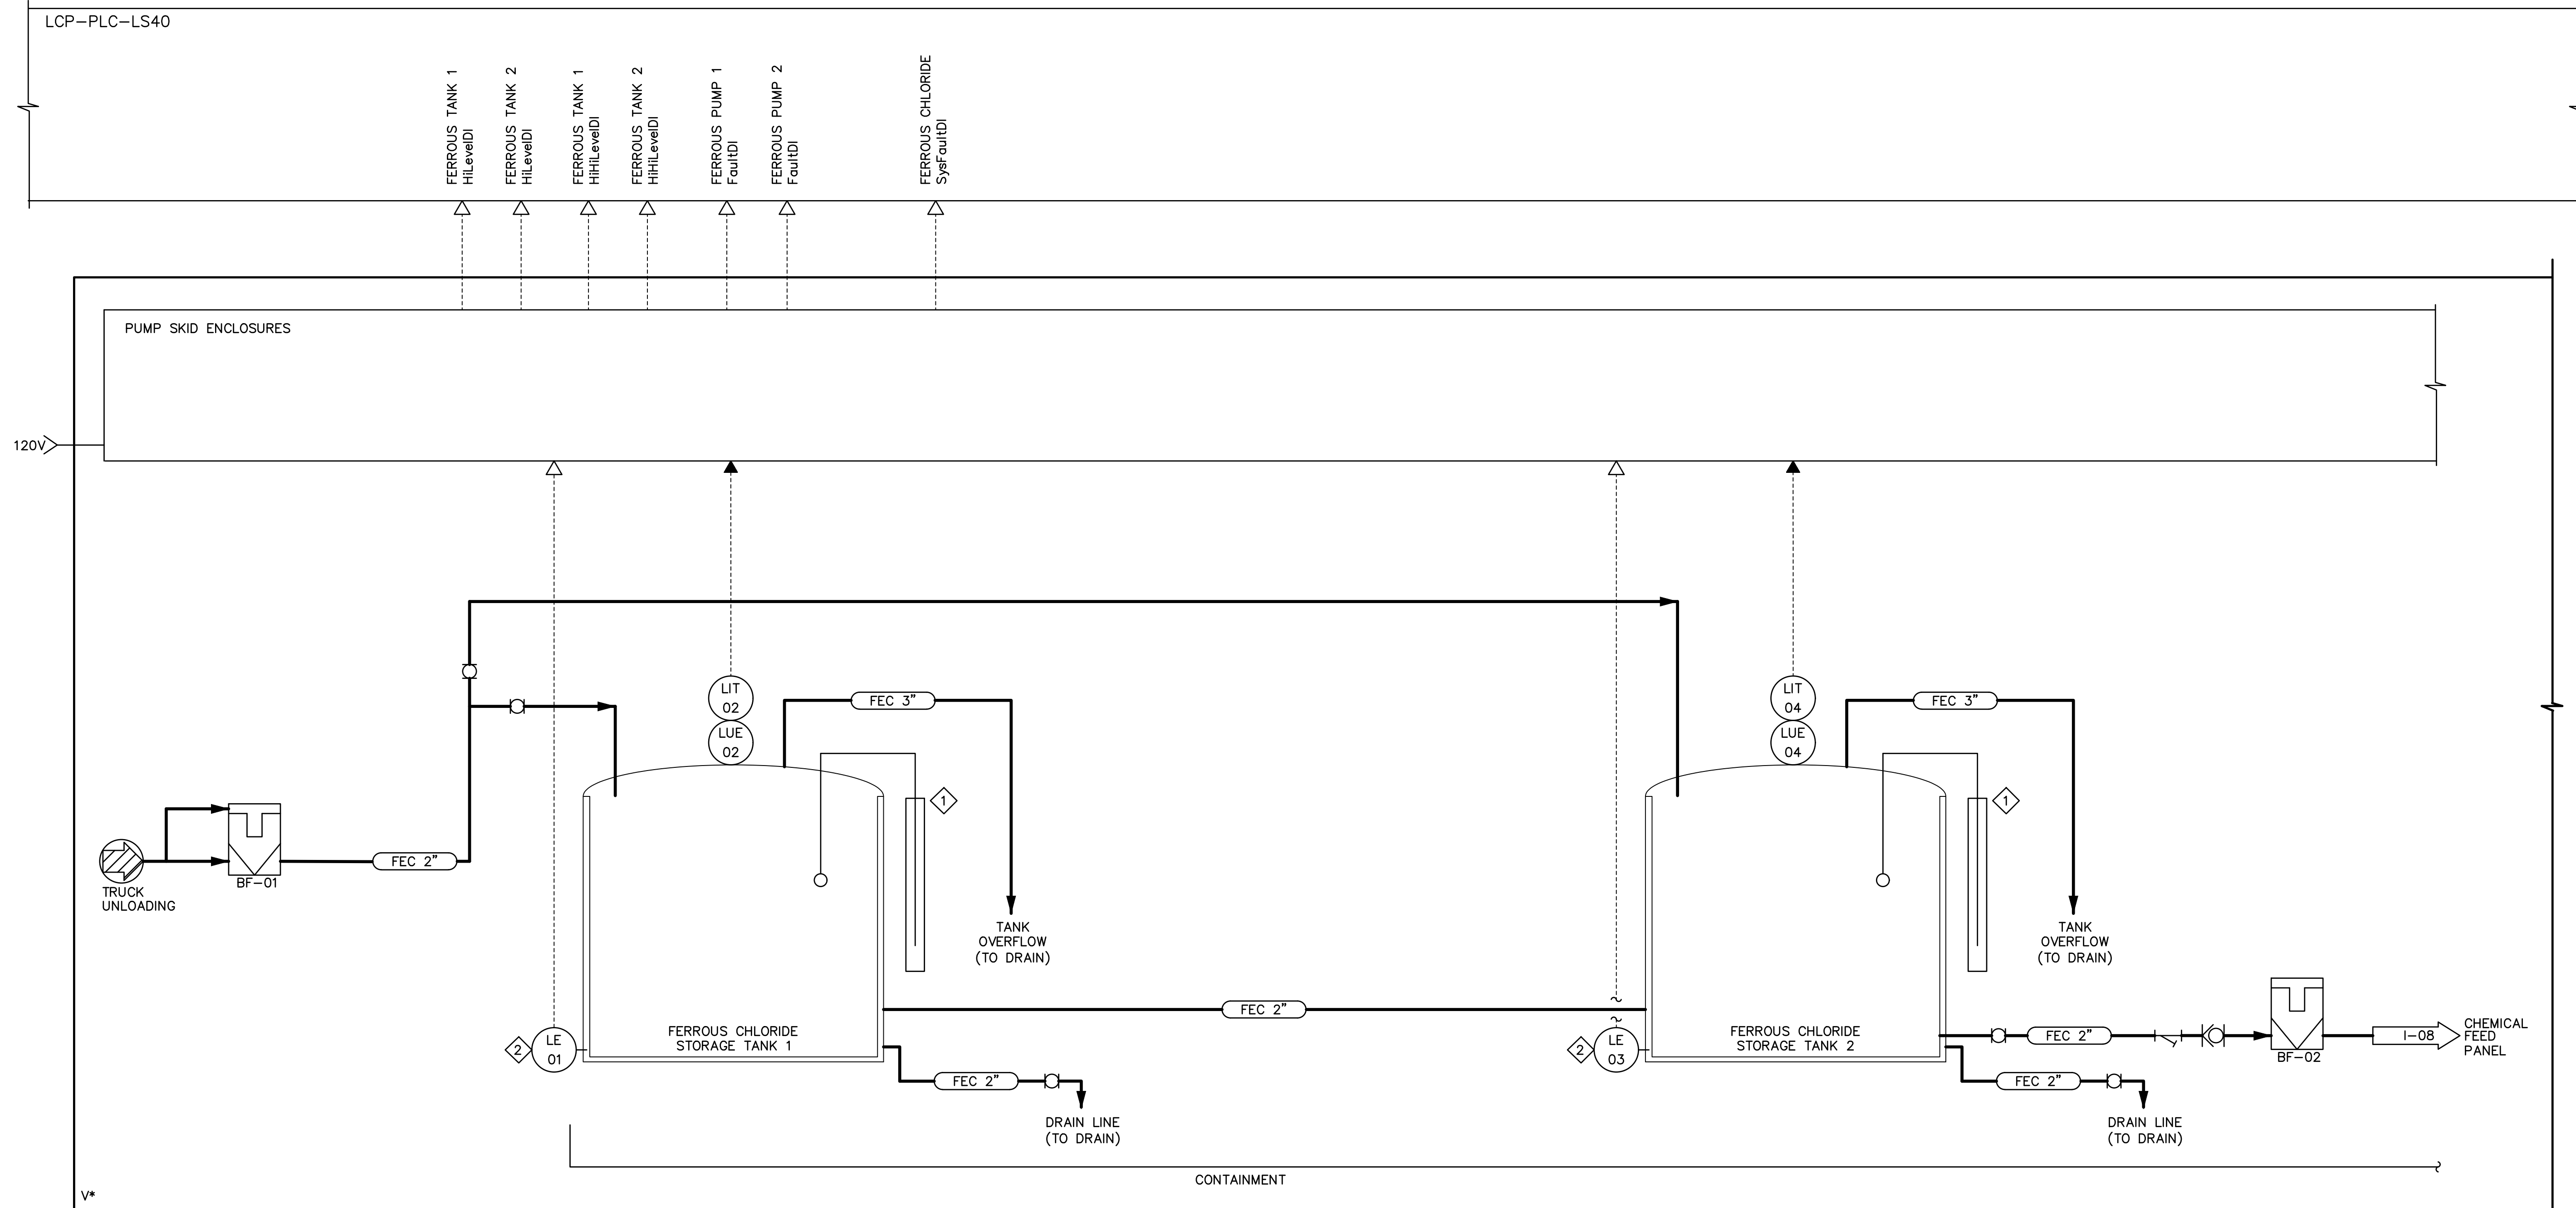

**GENERAL NOTES:**

1. STORAGE TANK IS DOUBLE CONTAINED.

**INTERLOCKS:**

- 1 REVERSE LEVEL INDICATOR
- 2 TANK CONTAINMENT LEAK DETECTOR

REVISION	ENGINEERING COMPANY	PROJECT NO.	PROJECT NAME	DATE	CAD FILE NAME	DWG NUMBER	REMARKS

			<table border="1" style="width: 100%; border-collapse: collapse;"> <thead> <tr> <th colspan="5">REVISIONS</th> </tr> <tr> <th>NO.</th> <th>BY</th> <th>DATE</th> <th>CKD</th> <th>REMARKS</th> </tr> </thead> <tbody> <tr><td> </td><td> </td><td> </td><td> </td><td> </td></tr> <tr><td> </td><td> </td><td> </td><td> </td><td> </td></tr> <tr><td> </td><td> </td><td> </td><td> </td><td> </td></tr> <tr><td> </td><td> </td><td> </td><td> </td><td> </td></tr> <tr><td> </td><td> </td><td> </td><td> </td><td> </td></tr> <tr><td> </td><td> </td><td> </td><td> </td><td> </td></tr> </tbody> </table>	REVISIONS					NO.	BY	DATE	CKD	REMARKS																																<p>CITY OF PHOENIX WATER SERVICES DEPARTMENT</p> <p>LIFT STATION 40 REFURBISHMENT</p>	<p>INSTRUMENTATION</p> <p>P&amp;ID SHEET 4</p>	<p>COPYRIGHT © 2007-JANUARY</p> <p>CITY PROJECT NO. WS90400085</p> <p>DATE: 08/2024</p> <p>1-07 SHEET 131 OF 134</p> <p>CAD FILE: CSILS40IA04.dwg</p>
REVISIONS																																															
NO.	BY	DATE	CKD	REMARKS																																											

FOR CONSTRUCTION

THIS DRAWING MUST BE FIELD VERIFIED BEFORE USE  
DRAWING NOT TO SCALE UNLESS SCALE BAR IS PRESENT

THIS DOCUMENT MUST BE KEPT SECURE AT ALL TIMES.

**GENERAL NOTES:**

1. THIS DRAWING DOES NOT INDICATE ALL THE PROJECT REQUIREMENTS. THE PROJECT REQUIREMENTS ARE INDICATED IN VARIOUS ELECTRICAL AND INSTRUMENTATION DRAWINGS, OTHER P&ID DRAWINGS, AND SPECIFICATIONS. ALL DOCUMENTS MUST BE CAREFULLY INSPECTED AND GATHERED TOGETHER IN ORDER TO INCLUDE THE COLLECTIVE REQUIREMENTS FOR THIS PROJECT.
2. WHERE DISCREPANCIES EXIST AMONG VARIOUS DRAWINGS AND/OR SPECIFICATIONS, THE CONTRACTOR SHALL INCLUDE THE ITEM WITH THE MOST STRINGENT REQUIREMENT. FOR EXAMPLE, THE MOST LABORIOUS INSTALLATION, THE LARGER CONDUCTOR AND CONDUIT, THE FURTHER DISTANCE, THE LARGER INSTRUMENT, THE HIGHER QUANTITY OF INSTRUMENTS, THE HIGHER NUMBER OF INPUTS AND OUTPUTS, ETC...
3. REFER TO CONTROL SCHEMATICS AND CONTROL STRATEGIES FOR ADDITIONAL REQUIREMENTS THAT ARE NOT INDICATED ON THIS DRAWING.
4. REFER TO THE DIVISION 17 (INSTRUMENTATION) SPECIFICATIONS FOR ADDITIONAL REQUIREMENTS THAT ARE NOT INDICATED ON THIS DRAWING.


**KEY NOTES:**

1. FLOW METER MUST BE RATED FOR FERROUS CHLORIDE.
2. SEE MECHANICAL DRAWINGS FOR ADDITIONAL DETAILS. M04, DETAILS 9, AND 10.

LCP-PLC-LS40



FERROUS CHLORIDE Sys-Fault

SCADA

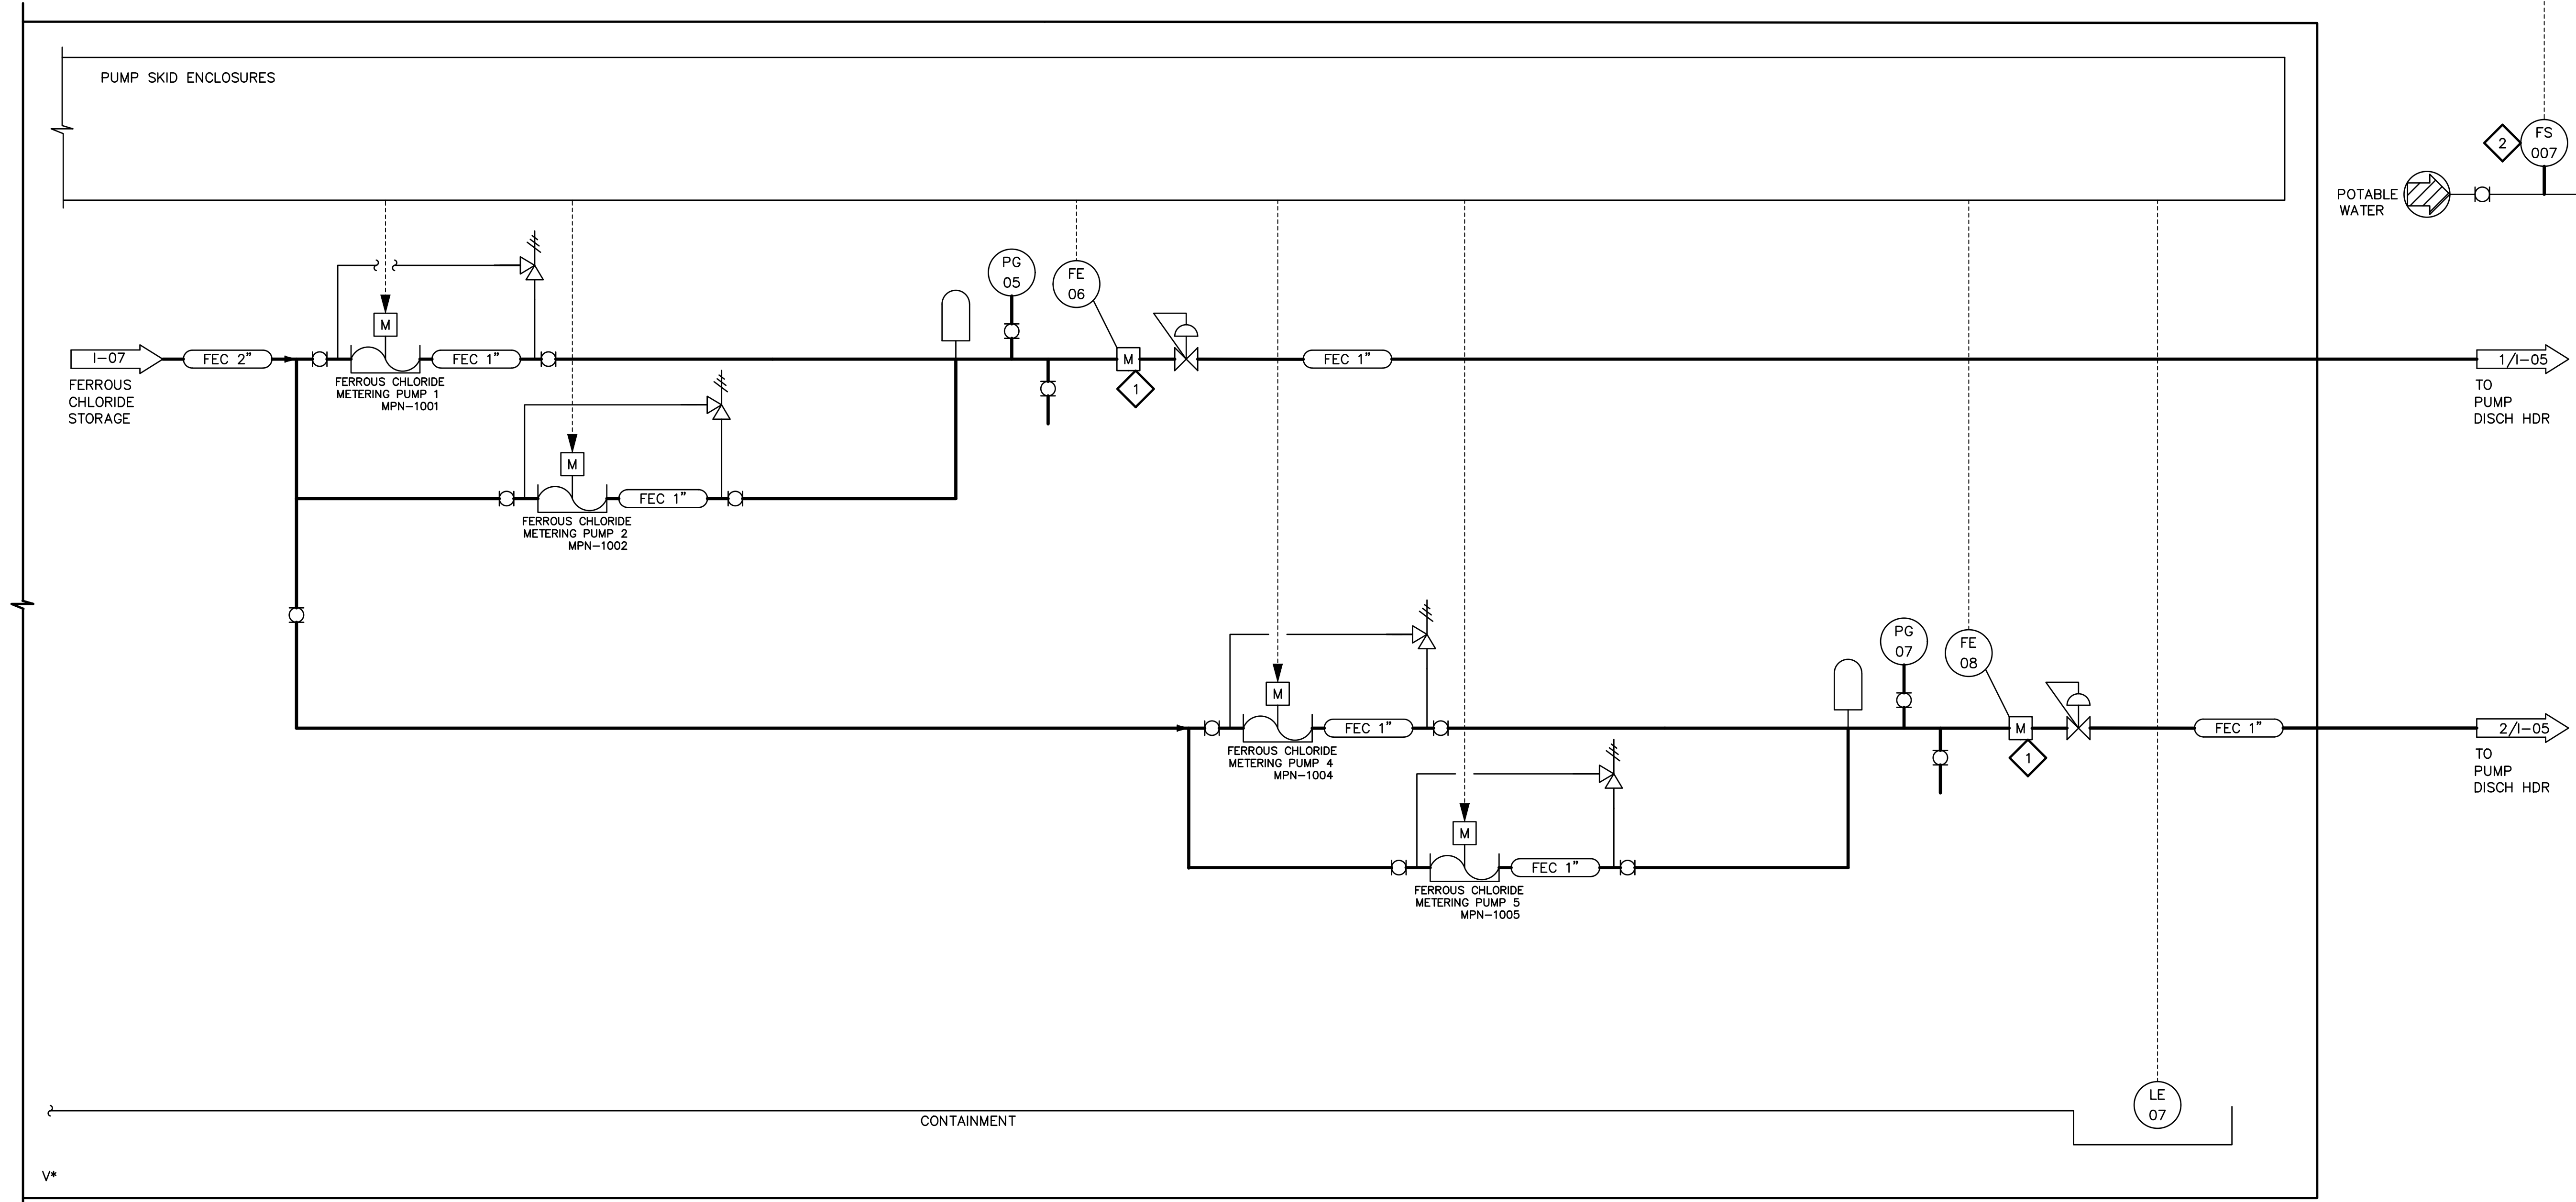


FACILITY DRAWINGS  
This drawing was supplied by a Consultant Engineer from a past construction project. The original contractor drawing was modified based on information provided by the Contractor to provide the Record Drawing. The City does not warrant the accuracy and reliability of the information and accuracy of the data provided in the field.

REVISION	DWG NUMBER	CAD FILE NAME	DATE	PROJECT NAME	PROJECT NO.	REFERENCE CID NUMBER: #	REMARKS

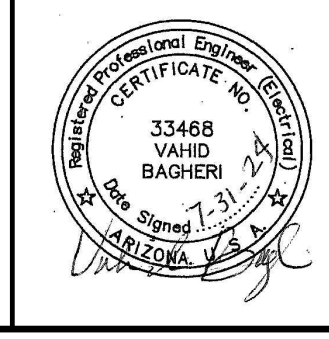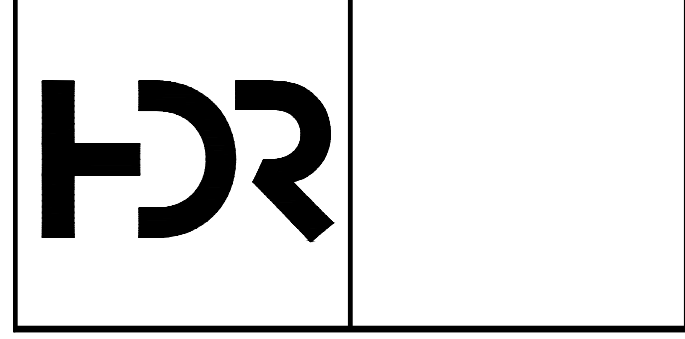

REVISIONS				
NO.	BY	DATE	CKD	REMARKS

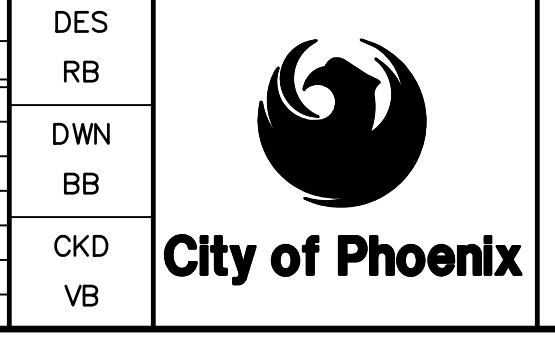

CITY OF PHOENIX  
WATER SERVICES DEPARTMENT  
  
LIFT STATION 40  
REFURBISHMENT





INSTRUMENTATION  
  
P&ID SHEET 5

COPYRIGHT © 2007-JANUARY  
CITY PROJECT NO. WS90400085  
DATE: 08/2024  
1-08 SHEET 132 OF 134  
CAD FILE: CSILS40A05.dwg

THIS DRAWING MUST BE FIELD VERIFIED BEFORE USE  
DRAWING NOT TO SCALE UNLESS SCALE BAR IS PRESENT




FOR CONSTRUCTION

"PER CITY OF PHOENIX CODE CHAPTER 2, SECTION 2-28, THESE PLANS ARE FOR OFFICIAL USE ONLY AND MAY NOT BE SHARED WITH OTHERS EXCEPT AS REQUIRED TO FULFILL THE OBLIGATIONS OF THE CONTRACTOR'S CONTRACT WITH THE CITY OF PHOENIX."  
THIS DOCUMENT MUST BE KEPT SECURE AT ALL TIMES.

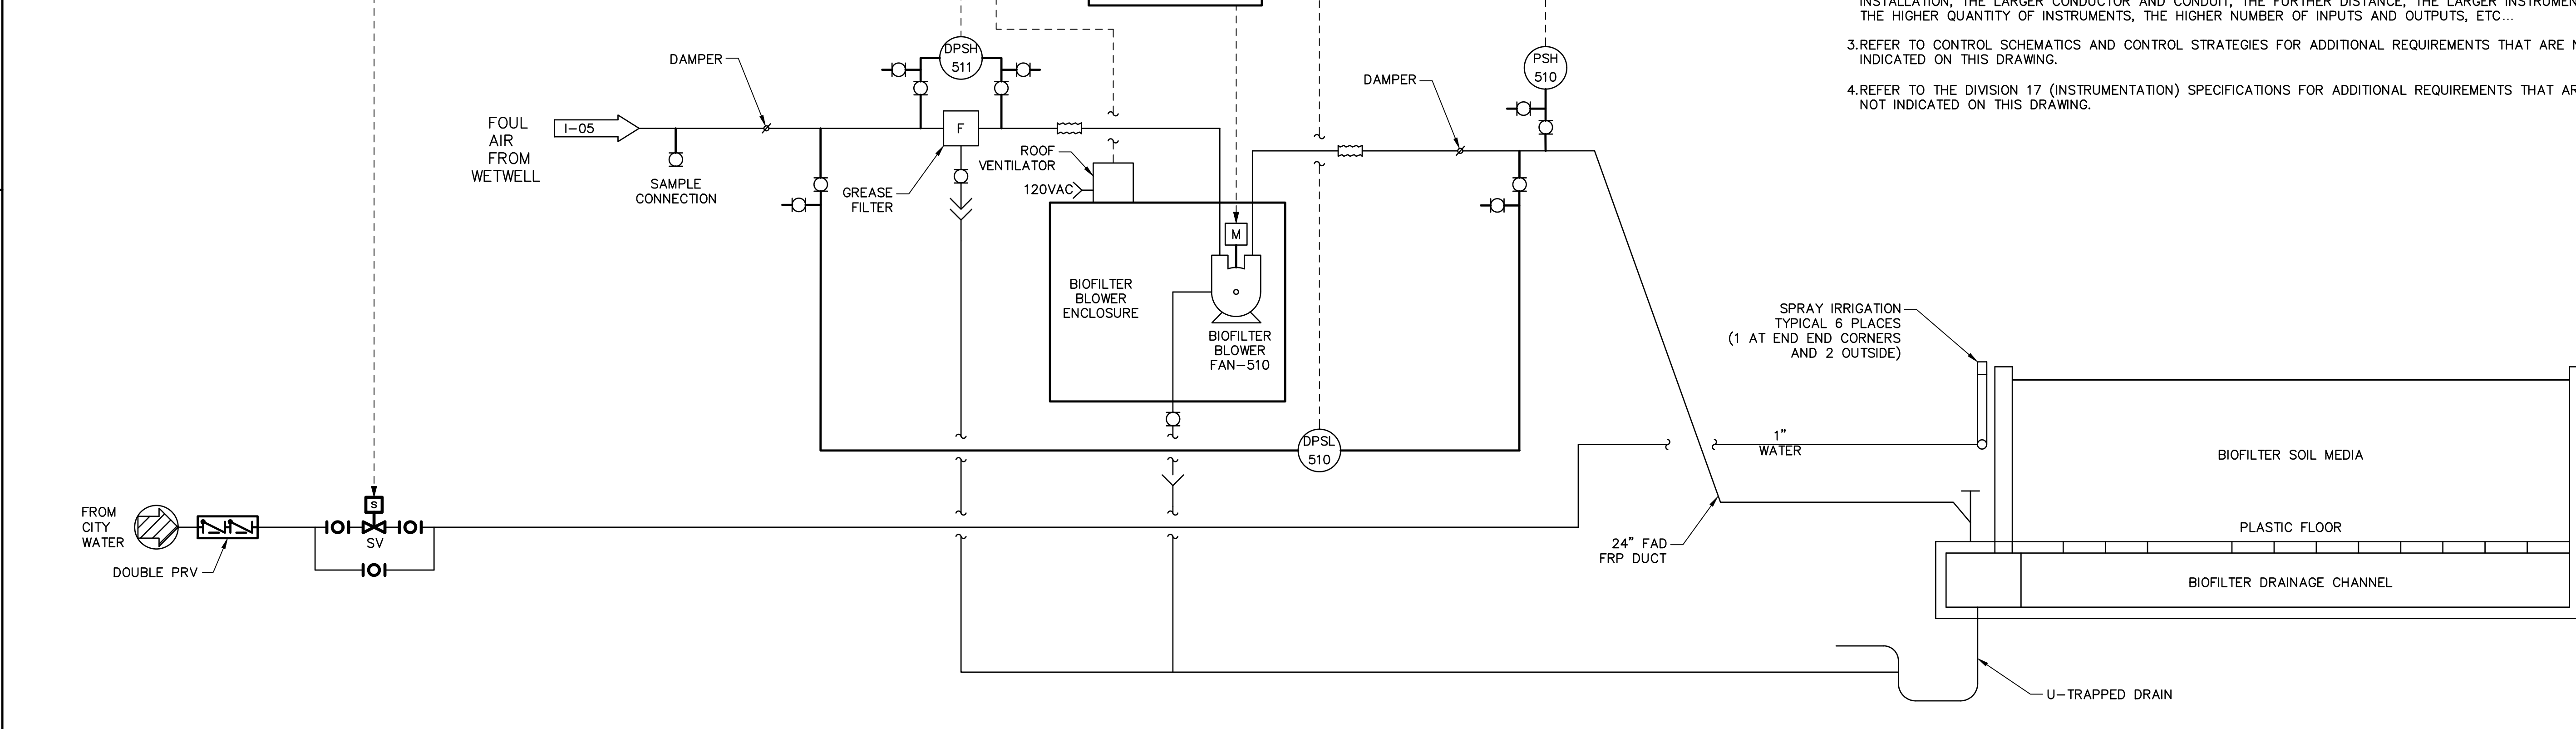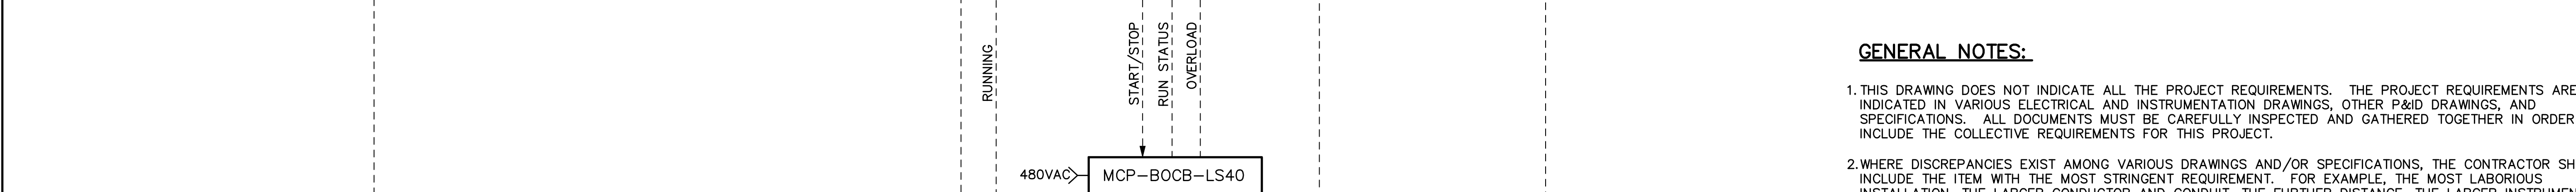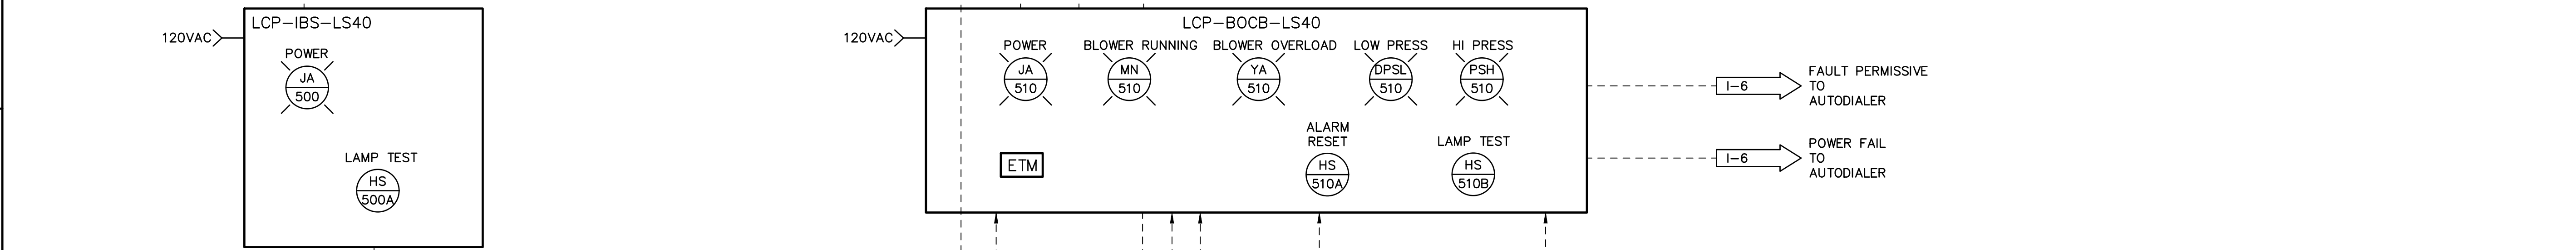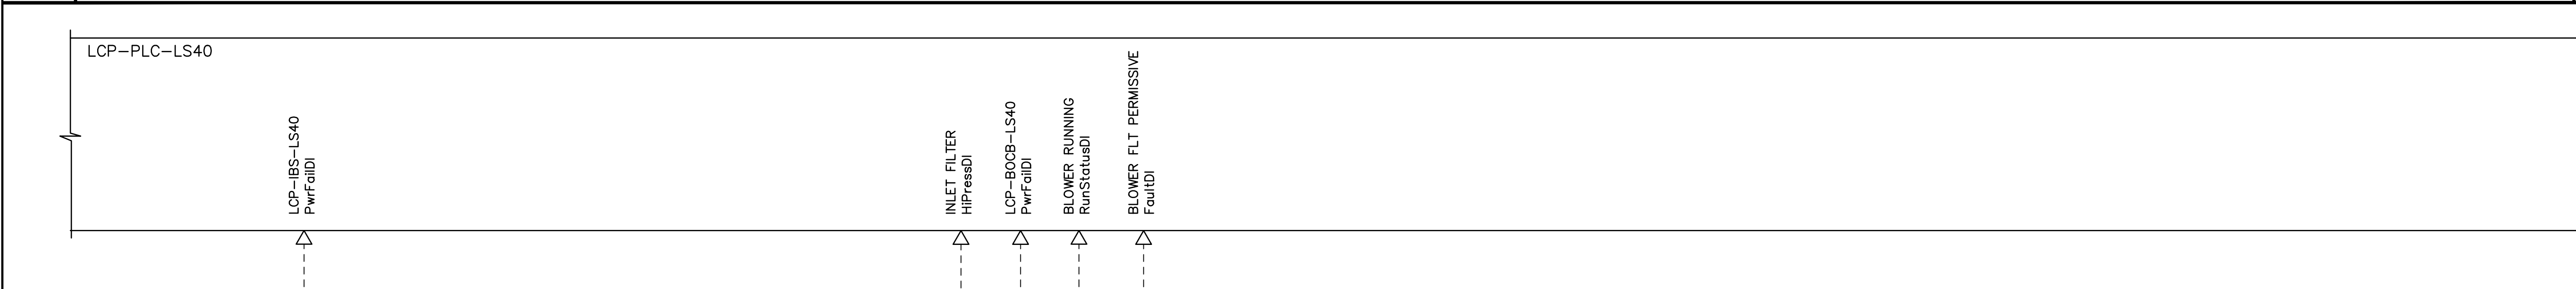

**GENERAL NOTES:**

1. THIS DRAWING DOES NOT INDICATE ALL THE PROJECT REQUIREMENTS. THE PROJECT REQUIREMENTS ARE INDICATED IN VARIOUS ELECTRICAL AND INSTRUMENTATION DRAWINGS, OTHER P&ID DRAWINGS, AND SPECIFICATIONS. ALL DOCUMENTS MUST BE CAREFULLY INSPECTED AND GATHERED TOGETHER IN ORDER TO INCLUDE THE COLLECTIVE REQUIREMENTS FOR THIS PROJECT.
2. WHERE DISCREPANCIES EXIST AMONG VARIOUS DRAWINGS AND/OR SPECIFICATIONS, THE CONTRACTOR SHALL INCLUDE THE ITEM WITH THE MOST STRINGENT REQUIREMENT. FOR EXAMPLE, THE MOST LABORIOUS INSTALLATION, THE LARGER CONDUCTOR AND CONDUIT, THE FURTHER DISTANCE, THE LARGER INSTRUMENT, THE HIGHER QUANTITY OF INSTRUMENTS, THE HIGHER NUMBER OF INPUTS AND OUTPUTS, ETC...
3. REFER TO CONTROL SCHEMATICS AND CONTROL STRATEGIES FOR ADDITIONAL REQUIREMENTS THAT ARE NOT INDICATED ON THIS DRAWING.
4. REFER TO THE DIVISION 17 (INSTRUMENTATION) SPECIFICATIONS FOR ADDITIONAL REQUIREMENTS THAT ARE NOT INDICATED ON THIS DRAWING.

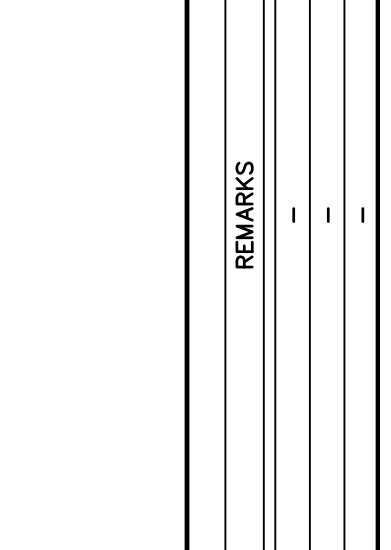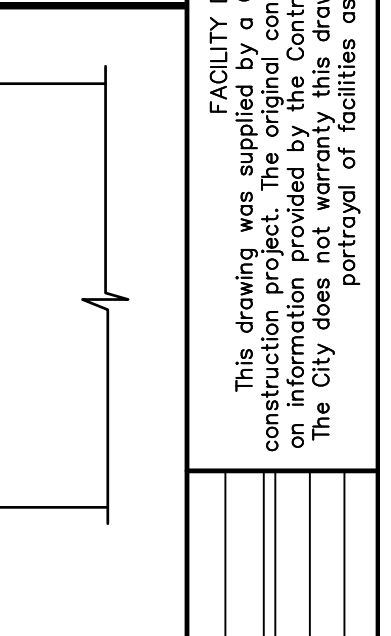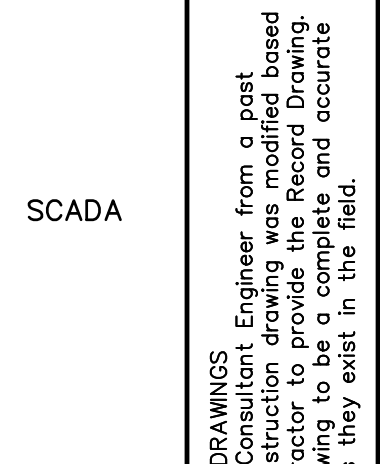

REVISION	ENGINEERING COMPANY	PROJECT NO.	PROJECT NAME	DATE	CAD FILE NAME	DWG NUMBER	REMARKS


			<table border="1"> <thead> <tr> <th colspan="2">REVISIONS</th> </tr> <tr> <th>NO.</th> <th>BY</th> </tr> </thead> <tbody> <tr><td> </td><td> </td></tr> <tr><td> </td><td> </td></tr> <tr><td> </td><td> </td></tr> <tr><td> </td><td> </td></tr> <tr><td> </td><td> </td></tr> <tr><td> </td><td> </td></tr> <tr><td> </td><td> </td></tr> <tr><td> </td><td> </td></tr> </tbody> </table>		REVISIONS		NO.	BY																	DES RB DWN BB CKD VB		CITY OF PHOENIX WATER SERVICES DEPARTMENT  LIFT STATION 40 REFURBISHMENT	INSTRUMENTATION  P&ID SHEET 6	COPYRIGHT © 2007-JANUARY CITY PROJECT NO. WS90400085 DATE: 08/2024 1-09 SHEET 133 OF 134 CAD FILE: CSILS40IN06.dwg
			REVISIONS																										
NO.	BY																												
FROM CITY WATER DOUBLE PRV SV IOI			SPRAY IRRIGATION TYPICAL 6 PLACES (1 AT END END CORNERS AND 2 OUTSIDE)	1" WATER 24" FRP DUCT BIOFILTER SOIL MEDIA PLASTIC FLOOR BIOFILTER DRAINAGE CHANNEL U-TRAPPED DRAIN	BIOFILTER BLOWER ENCLOSURE BIOFILTER BLOWER FAN-510 ROOF VENTILATOR GREASE FILTER DAMPER SAMPLE CONNECTION FOUL AIR FROM WETWELL	LCP-IBS-LS40 LCP-BOCB-LS40 MCP-BOCB-LS40 LCP-PLC-LS40	INLET FILTER INLET FILTER LCP-BOCB-LS40 LCP-BOCB-LS40 BLOWER RUNNING BLOWER RUNNING BLOWER FAULT PERMISSIVE BLOWER FAULT PERMISSIVE	FAULT PERMISSIVE TO AUTODIALER POWER FAIL TO AUTODIALER																					

FACILITY DRAWINGS  
This drawing was supplied by a Consultant Engineer from a past construction project. The original contractor to provide the Record Drawing on information provided by the Contractor to provide the Record Drawing. The City does not warrant the accuracy and reliability of the information and portrayal of facilities as they exist in the field.

THIS DRAWING MUST BE FIELD VERIFIED BEFORE USE  
DRAWING NOT TO SCALE UNLESS SCALE BAR IS PRESENT

**FOR CONSTRUCTION**

"PER CITY OF PHOENIX CODE CHAPTER 2, SECTION 2-28, THESE PLANS ARE FOR OFFICIAL USE ONLY AND MAY NOT BE SHARED WITH OTHERS EXCEPT AS REQUIRED TO FULFILL THE OBLIGATIONS OF THE CONTRACTOR'S CONTRACT WITH THE CITY OF PHOENIX."  
THIS DOCUMENT MUST BE KEPT SECURE AT ALL TIMES.

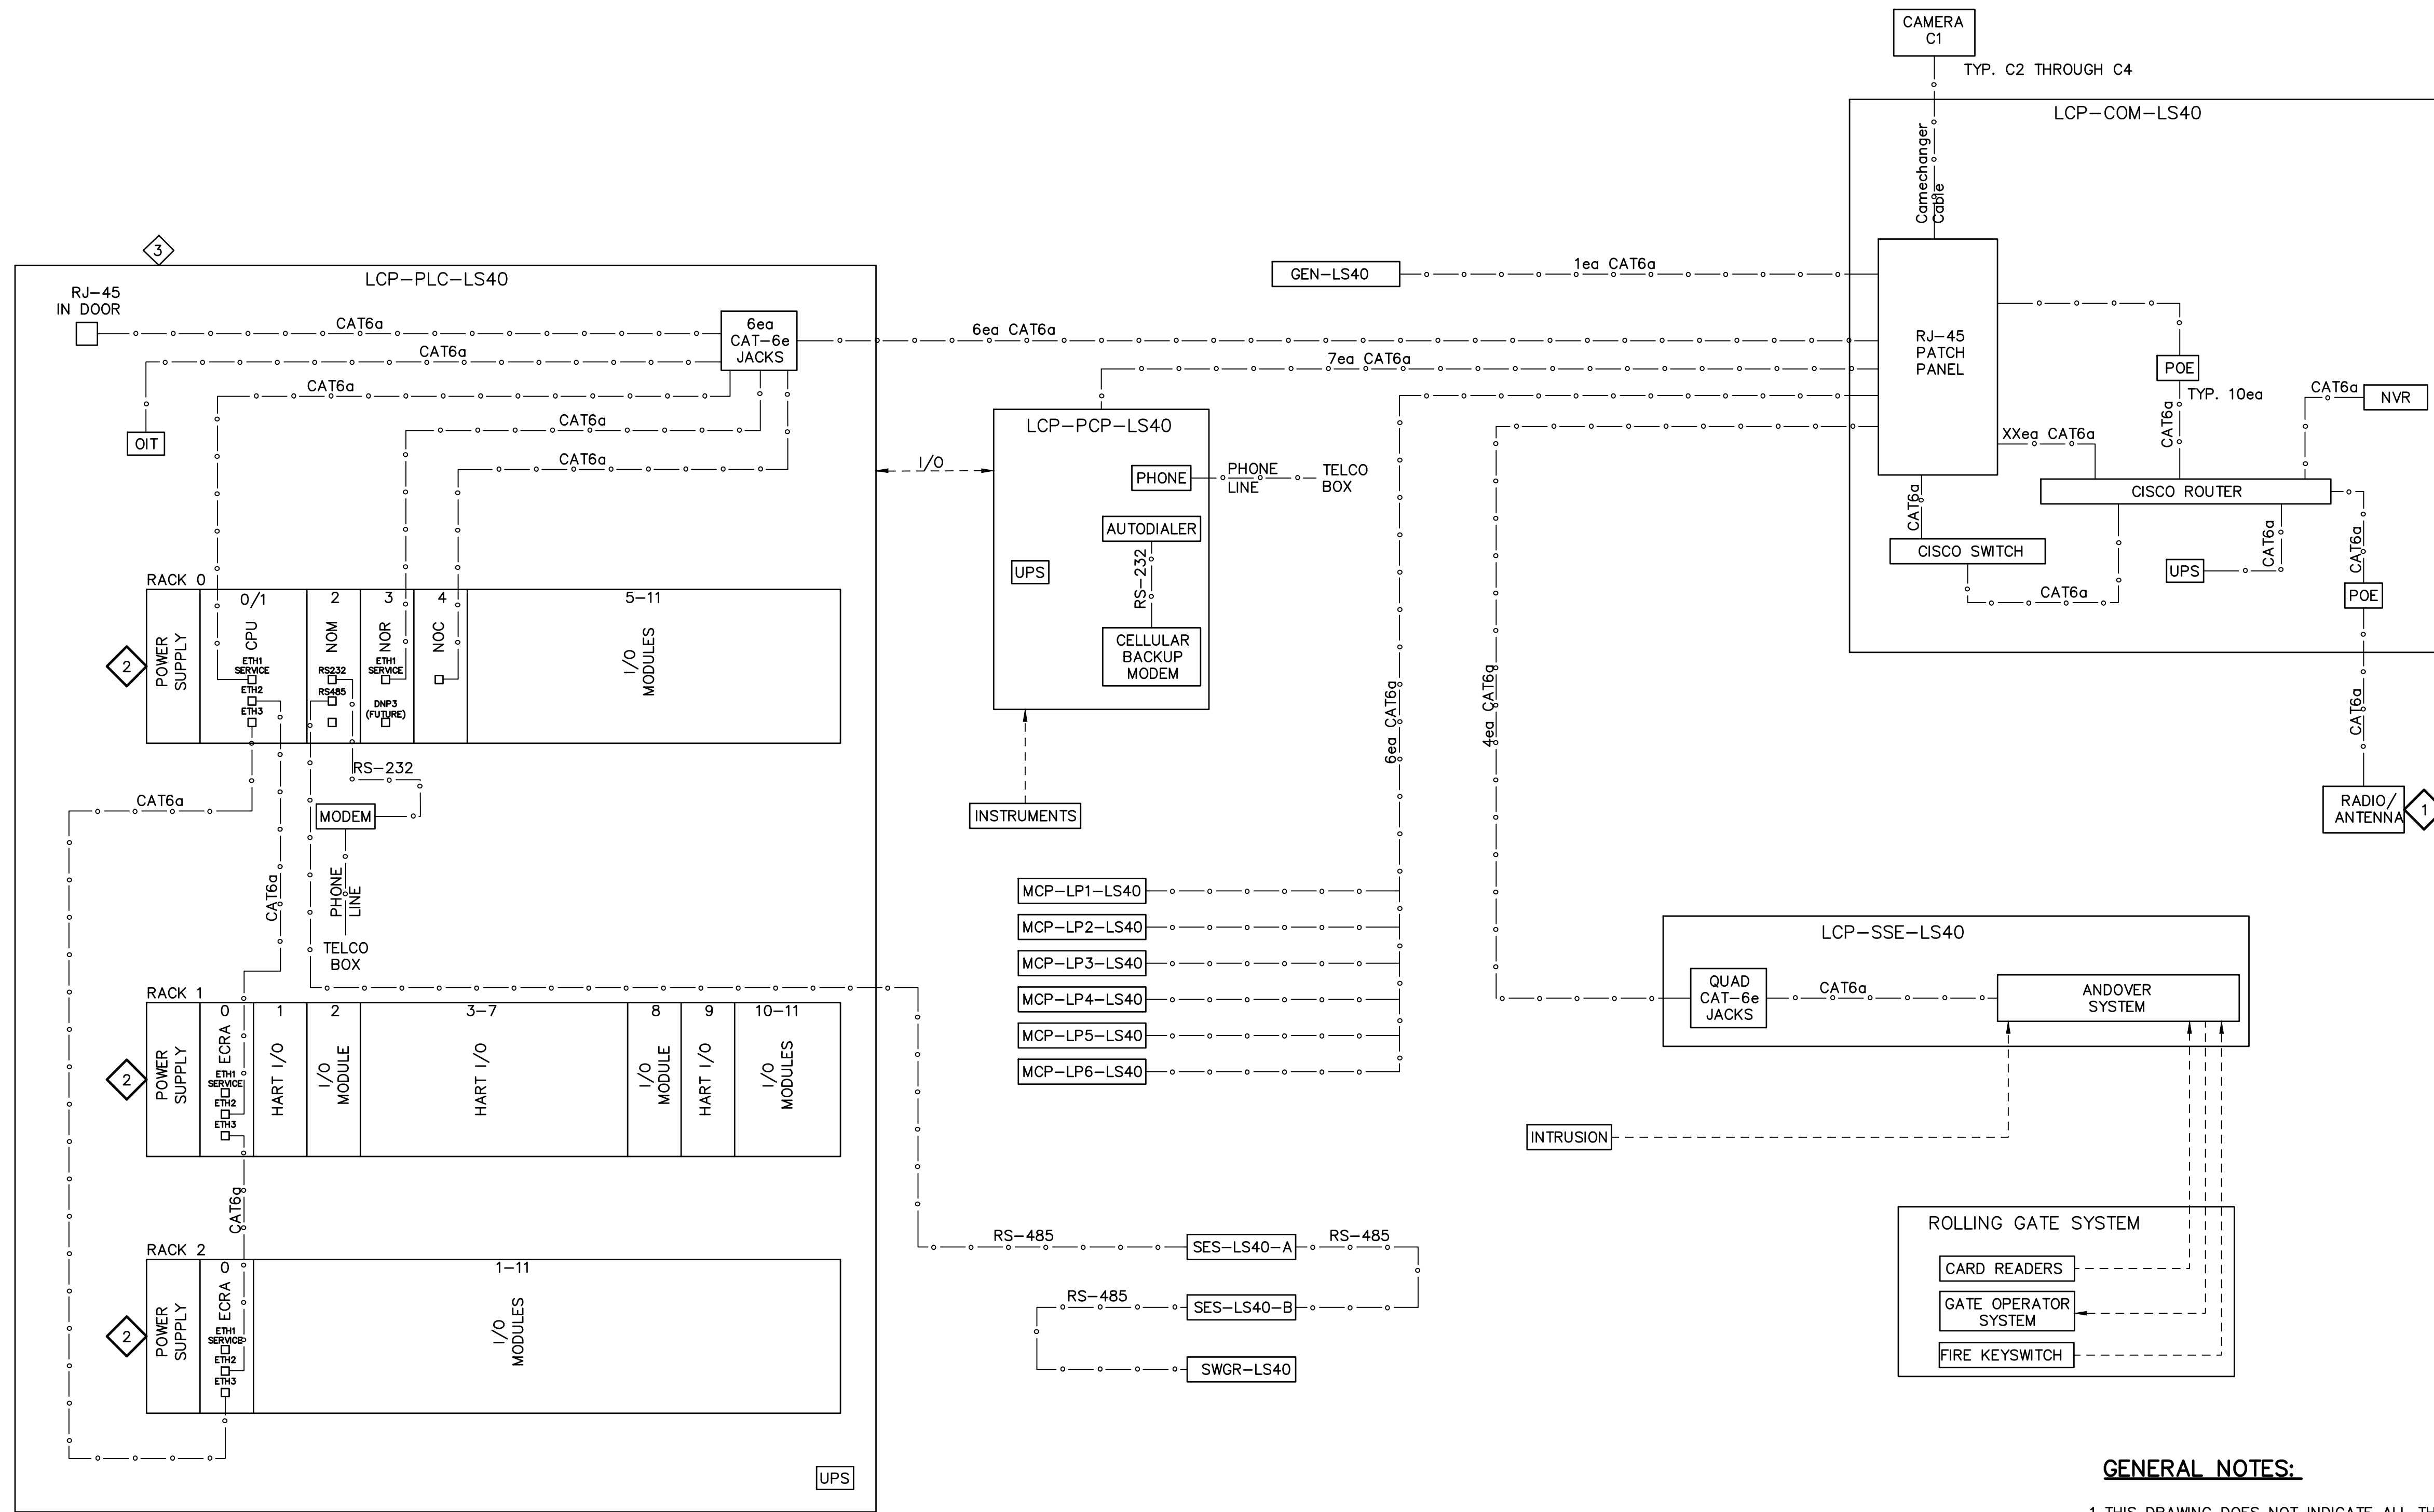

COMMUNICATIONS DIAGRAM

**KEY NOTES:**



- 1 MOUNTED ON ANTENNA POLE. SEE PLAN VIEWS FOR MORE DETAILS. Radwin Model RW-55A0-0150.
- 2 FURNISH ALL PLC RACKS AND PLC MODULES TO MEET THE REQUIREMENTS OF THIS PROJECT. NOT ALL MODULES AND RACKS ARE SHOWN. MODULE PLACEMENT SHALL BE AS INDICATED AND AS REQUIRED BY THE SPECIFICATIONS.

**GENERAL NOTES:**


1. THIS DRAWING DOES NOT INDICATE ALL THE PROJECT REQUIREMENTS. THE PROJECT REQUIREMENTS ARE INDICATED IN VARIOUS ELECTRICAL AND INSTRUMENTATION DRAWINGS, OTHER P&ID DRAWINGS, AND SPECIFICATIONS. ALL DOCUMENTS MUST BE CAREFULLY INSPECTED AND GATHERED TOGETHER IN ORDER TO INCLUDE THE COLLECTIVE REQUIREMENTS FOR THIS PROJECT.
2. WHERE DISCREPANCIES EXIST AMONG VARIOUS DRAWINGS AND/OR SPECIFICATIONS, THE CONTRACTOR SHALL INCLUDE THE ITEM WITH THE MOST STRINGENT REQUIREMENT. FOR EXAMPLE, THE MOST LABORIOUS INSTALLATION, THE LARGER CONDUCTOR AND CONDUIT, THE FURTHER DISTANCE, THE LARGER INSTRUMENT, THE HIGHER QUANTITY OF INSTRUMENTS, THE HIGHER NUMBER OF INPUTS AND OUTPUTS, ETC...
3. REFER TO CONTROL SCHEMATICS AND CONTROL STRATEGIES FOR ADDITIONAL REQUIREMENTS THAT ARE NOT INDICATED ON THIS DRAWING.
4. REFER TO THE DIVISION 17 (INSTRUMENTATION) SPECIFICATIONS FOR ADDITIONAL REQUIREMENTS THAT ARE NOT INDICATED ON THIS DRAWING.

FACILITY DRAWINGS  
This drawing was supplied by a Consultant Engineer from a past construction project. The original construction drawing was modified based on information provided by the Contractor to provide the Record Drawing. The City does not warrant the accuracy of the information and accurate portrayal of facilities as they exist in the field.

REVISION	ENGINEERING COMPANY	PROJECT NO.	PROJECT NAME	DATE	CAD FILE NAME	DWG NUMBER	REMARKS

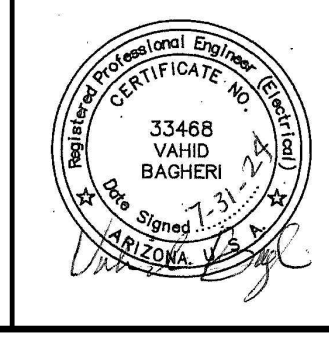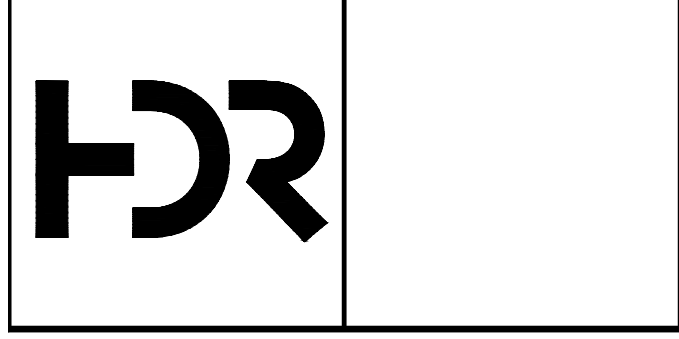

REVISIONS				
NO.	BY	DATE	CKD	REMARKS

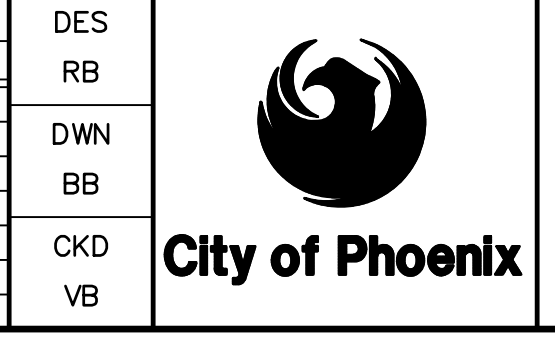

CITY OF PHOENIX  
WATER SERVICES DEPARTMENT  
  
LIFT STATION 40  
REFURBISHMENT

INSTRUMENTATION  
  
P&ID SHEET 7

COPYRIGHT © 2007-JANUARY  
CITY PROJECT NO. WS90400085  
DATE: 08/2024  
1-10 SHEET 134 OF 134  
CAD FILE: CSILS40IN07.dwg